



GENERAL NOTES

1. THE DRAWINGS AND PROJECT MANUAL TOGETHER CONSTITUTE THE CONTRACT DOCUMENTS FOR CONSTRUCTION. ALL GENERAL REQUIREMENTS ARE TO BE MET AND ALL MATERIALS, FINISHES AND SYSTEMS ARE TO BE INSTALLED AND PERFORM PER SPECIFICATIONS UNLESS OTHERWISE NOTED.
2. GENERAL CONTRACTOR SHALL VISIT THE SITE, REVIEW THE BUILDING SHELL DRAWINGS AS SUBMITTED BY THE LANDLORD OR STARBUCKS AND BECOME THOROUGHLY FAMILIAR WITH THE SITE CONDITIONS PRIOR TO CONSTRUCTION.
3. GENERAL CONTRACTOR SHALL CONSULT WITH STARBUCKS CONSTRUCTION MANAGER TO RESOLVE ANY CHANGES, OMISSIONS OR PLAN DISCREPANCIES PRIOR TO CONSTRUCTION.
4. ALL WORK SHALL BE PERFORMED IN STRICT COMPLIANCE WITH LOCAL, COUNTY, STATE AND FEDERAL CODES AND ORDINANCES.
5. GENERAL CONTRACTOR SHALL VERIFY THE LOCATION OF ALL UTILITIES.
6. GENERAL CONTRACTOR TO VERIFY ALL DIMENSIONS, INCLUDING CLEARANCES REQUIRED BY OTHER TRADES AND NOTIFY STARBUCKS CONSTRUCTION MANAGER OF ANY DISCREPANCIES PRIOR TO PROCEEDING WITH THE WORK. ALL DIMENSIONS ARE TO THE FACE OF THE FINISHED SURFACE UNLESS OTHERWISE NOTED. ALL DIMENSIONS TO BE TAKEN FROM DESIGNATED DATUM POINT. DO NOT SCALE DRAWINGS.
7. GENERAL CONTRACTOR SHALL PATCH AND REPAIR ALL EXISTING WALLS, FLOORS, CEILINGS OR OTHER SURFACES IDENTIFIED TO REMAIN THAT MAY BECOME DAMAGED DURING THE COURSE OF THE WORK.
8. THE GENERAL CONTRACTOR IS RESPONSIBLE FOR OBTAINING PERMITS FOR FIRE PROTECTION, PLUMBING, MECHANICAL AND ELECTRICAL SYSTEMS PRIOR TO INSTALLATION OF SUCH SYSTEMS.
9. GENERAL CONTRACTOR SHALL RETAIN ONE SET OF PERMIT PLANS ON-SITE TO DOCUMENT ALL CHANGES MADE DURING CONSTRUCTION. THE RECORD DRAWINGS SHALL BE ISSUED TO THE OWNER AT PROJECT CLOSE-OUT AS DESCRIBED IN THE GENERAL REQUIREMENTS OF THE PROJECT MANUAL.
10. GENERAL CONTRACTOR IS RESPONSIBLE FOR COORDINATING DELIVERY OF MATERIALS FROM STARBUCKS CONSTRUCTION THIRD PARTY LOGISTICS DISTRIBUTION SERVICES AND VENDOR DIRECT SHIPMENTS. SEE THE PROJECT MANUAL FOR ADDITIONAL INFORMATION.
11. RESPONSIBILITY FOR SUPPLY AND DELIVERY OF MATERIALS AND EQUIPMENT IS IDENTIFIED IN THE DRAWING SCHEDULE SHEETS UNDER THE COLUMN LABELED "RESPONSIBILITY".
12. FOR THE PURPOSE OF THE DOCUMENTS, TO "INSTALL," SHALL MEAN TO PROVIDE ALL FASTENERS, MISCELLANEOUS HARDWARE, BLOCKING, ELECTRICAL CONNECTIONS, PLUMBING CONNECTIONS AND OTHER ITEMS REQUIRED FOR A COMPLETE AND OPERATIONAL INSTALLATION, UNLESS OTHERWISE NOTED.
13. ALL ITEM SUBSTITUTIONS MUST BE APPROVED BY THE STARBUCKS CONSTRUCTION MANAGER.

ARCHITECTURAL SYMBOL LEGEND

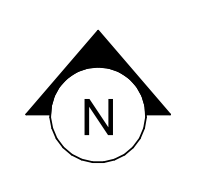


NORTH
ARROW

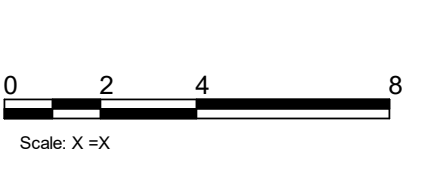


0 2 4 8
Scale: X=x


GRAPHIC
SCALE

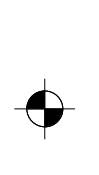


DATUM
POINT

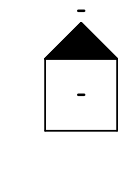


EXTERIOR
ELEVATION
CALL-OUT

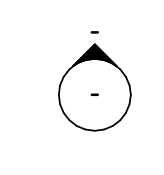


INTERIOR
ELEVATION
CALL-OUT

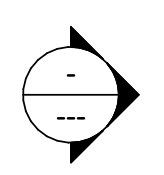


SECTION
CALL-OUT

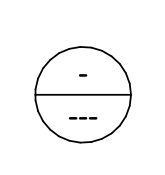


DETAIL
CALL-OUT

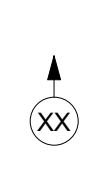


SHEET
NOTE
CALLOUT




XXXX AFF

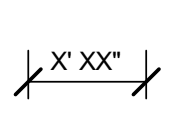


FINISH FACE TO
FINISH FACE
DIMENSION




REVISION
CLOUD




REVISION
TAG

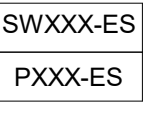


PAINT
TAG

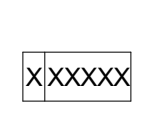


DESIGN ID
TAG

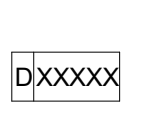

DOOR
TAG



WINDOW
TAG



INTERIOR
WALL TAG

ABBREVIATIONS

A/C	AIR CONDITIONING	FF&E	FURNITURE, FIXTURE AND EQUIPMENT	OC	ON CENTER
ACT	ACOUSTICAL CEILING TILE	FLR	FLOOR	O.D.	OUTSIDE DIAMETER
ADJ	ADJUSTABLE	FOH	FRONT OF HOUSE		
AFF	ABOVE FINISHED FLOOR	FT	FOOT/FEET	PIR	PASSIVE INFRARED SENSOR
AMP	AMPERE			PLC	PLACE
ARCH	ARCHITECT	G	GROUND	R	RADIUS
BOH	BACK OF HOUSE	GC	GENERAL CONTRACTOR	REF	REFERENCE
				REQ'D	REQUIRED
CAB	CABINET	HD	HOLLOW CORE	REV	REVISION
CL	CENTER LINE	HM	HOLLOW METAL	RND	ROUND
CLG	CEILING	HORIZ	HORIZONTAL		
CM	STARBUCKS CONSTRUCTION MANAGER	HR	HOUR	SB	STARBUCKS
CTR	CENTER	HT	HEIGHT	SC	SOLID CORE
CX	COMMISSIONING	HVAC	HEATING, VENTILATING AND AIR CONDITIONING	SF	SQUARE FEET
CXA	COMMISSIONING AGENT			SHT	SHEET
				SIM	SIMILAR
DEG	DEGREE			SPEC	SPECIFICATION
DET	DETAIL	I.D.	INSIDE DIAMETER	SQ	SQUARE
DIA	DIAMETER	LEED	LEADERSHIP IN ENERGY AND ENVIRONMENTAL DESIGN	TEMP	TEMPORARY
DIM	DIMENSION			TYP	TYPICAL
DM	STARBUCKS DESIGN MANAGER				
DN	DOWN			U.O.N	UNLESS OTHERWISE NOTED
		MAX	MAXIMUM		
EA	EACH	MEP	MECHANICAL, ELECTRICAL AND PLUMBING	VERT	VERTICAL
EL	ELEVATION	MFR	MANUFACTURER	VIF	VERIFY IN FIELD
EQ	EQUAL	MIN	MINIMUM		
EXIST	EXISTING				
EXT	EXTERIOR	NIC	NOT IN CONTRACT		
		NL	NIGHT LIGHT		
		NT	NOT TO SCALE		

PROJECT CONTACTS

DESIGNER:	MARTIN PEREZ GENSLER CHAPULTEPEC UNO REFORMA 509 PISO 26, CUAUHTEMOC, CP06500 MEXICO CITY, MEXICO SBUX-SUBMITTALS@GENSLER.COM
DESIGN MANAGER:	ROMINA VIGNOLO 95 MERRICK WAY, SUITE 650 CORAL GABLES, FL 33134 (305) 529-5359 RVIGNOLO@STARBUCKS.COM
SENIOR DESIGN MANAGER:	LUCAS ALVAREZ-TABIO 95 MERRICK WAY, SUITE 650 CORAL GABLES, FL 33134 (786) 769-7966 LALVAREZ@STARBUCKS.COM
CONSTRUCTION MANAGER:	KIM GIBBS STARBUCKS COFFEE COMPANY (404) 703-7811 KGIBBS@STARBUCKS.COM
PROJECT MANAGER:	ANDY MCLOUD CHANGE UP INC. 2056 BYERS RD. MIAMISBURG, OH 45342 (937) 230-0676 SOUTHEASTSBX@CHANGEUPINC.COM
ARCHITECT OF RECORD:	DONALD RETHMAN DESIGN FORUM ARCHITECTS, INC 2056 BYERS RD MIAMISBURG, OH 45342 (937) 853-8247 DON.RETHMAN@CHANGEUPINC.COM
MEP CONSULTANT OF RECORD:	EVAN J. DUFFY MARQUE ENGINEERING, LLC 4850 SMITH RD., SUITE 101 CINCINNATI, OH 45212 (513) 901-0040 EDUFFY@MARQUEENG.COM

FIXTURE CALCULATION

MIN Number of Plumbing Fixtures:

Occupant Load :	53 Indoor Occupancy 24 Outdoor Seating 53 + 24 = 77 Occupant
-----------------	--

Distribution:	Men: 39 Women: 39
---------------	------------------------

8TH ED. 2023 FLORIDA PLUMBING CODE:

	Men	Women
Water Closets	1 Per 75 Occupants	1 Per 75 Occupants
Lavatories	1 Per 200 Occupants	1 Per 200 Occupants
Urinals	0	N/A
Fixture	Men REQ'D Provided	Women REQ'D Provided
Water Closets	1 1	1 1
Urinals	0 0	N/A N/A
Lavatories	1 1	1 1
Drinking Fountains	Not Required	Not Required

INDEX OF SHEETS

LEGEND:	X - SHEET ISSUED R - SHEET ISSUED FOR REFERENCE AND COORDINATION ONLY SEE TITLEBLOCK FOR REVISION ISSUE DATE(S)
---------	---

SHEET	SHEET TITLE	BID SET	PERMIT SET	REVISION 1	REVISION 2	REVISION 3	REVISION 4
GENERAL							
G-001	GENERAL INFORMATION	X	X				
G-002	LIFE SAFETY ACCESSIBILITY PLAN	X	X				
G-002.1	OCCUPANCY LOAD PLAN	X	X				
G-003	ACCESSIBILITY GUIDELINES	X	X				
G-004	FOOD SERVICE PLAN	X	X				
G-005	PRE-APPROVED CONST. MATERIALS	X	X				
G-006	PRE-APPROVED CONST. MATERIALS	X	X				

DEMOLITION							
D-101	DEMOLITION FLOOR PLAN	X	X				
D-102	DEMOLITION CEILING PLAN	X	X				
D-201	DEMOLITION EXTERIOR ELEVATION	X	X				

ARCHITECTURAL							
A-001	ARCHITECTURAL SITE PLAN	X	X				
A-002	ARCHITECTURAL SITE DETAIL	X	X				
A-100	SCOPE OF WORK PLAN	X	X				
A-101	BUILDING FLOOR PLAN	X	X				
A-102	BUILDING FLOOR PENETRATION PLAN	X	X				
A-104	REFLECTED CEILING PLAN	X	X				
A-105	DIMENSIONED CEILING AND LIGHTING PLAN	X	X				
A-201	EXTERIOR ELEVATIONS	X	X				
A-501	BUILDING DETAILS	X	X				
A-502	BUILDING DETAILS	X	X				
A-503	BUILDING DETAILS	X	X				
A-504	WORKROOM DETAILS	X	X				
A-505	RESTROOM AND WORKROOM DETAILS	X	X				
A-506	CONNECTION DETAIL	X	X				
A-601	WINDOW AND DOOR SCHEDULES & DETAILS	X	X				

INTERIORS							
I-101	FF & E PLAN	X	X				
I-101.1	FF & E SCHEDULES	X	X				
I-102	CASEWORK PLAN	X	X				
I-102.1	ADAPTABLE CASEWORK BASE PLAN	X	X				
I-102.2	ADAPTABLE CASEWORK FRAMEWORK PLAN	X	X				
I-102.3	ADAPTABLE CASEWORK CABINET PLAN	X	X				
I-102.3.1	ADAPTABLE CASEWORK CABINET SCHEDULE	X	X				
I-102.4	ADAPTABLE CASEWORK COUNTERTOP PLAN	X	X				
I-103	CASEWORK SCHEDULES	X	X				
I-106	FLOOR FINISH PLAN	X	X				
I-107	WALL FINISH PLAN	X	X				
I-201	INTERIOR FINISH ELEVATIONS	X	X				
I-202	INTERIOR FINISH ELEVATIONS	X	X				
I-203	INTERIOR FINISH ELEVATIONS	X	X				
I-204	INTERIOR FINISH ELEVATIONS	X	X				
I-205	PERSPECTIVE VIEWS	X	X				
I-401	ENLARGED RESTROOM PLAN	X	X				
I-401.1	ENLARGED RESTROOM ELEVATIONS	X	X				
I-501	FLOOR FINISH DETAILS	X	X				
I-502	WALL FINISH DETAILS	X	X				
I-503	INTERIOR DETAILS	X	X				
I-504	INTERIOR DETAILS	X	X				
I-505	INTERIOR DETAILS	X	X				
I-506	INTERIOR DETAILS	X	X				
I-507	INTERIOR DETAILS	X	X				
I-508	INTERIOR DETAILS	X	X				
I-509	INTERIOR DETAILS	X	X				
I-510	INTERIOR DETAILS	X	X				
I-511	INTERIOR DETAILS	X	X				
I-512	INTERIOR DETAILS	X	X				
I-513	INTERIOR DETAILS	X	X				
I-514	INTERIOR DETAILS	X	X				
I-515	INTERIOR DETAILS	X	X				
I-516	INTERIOR DETAILS	X	X				
I-517	ACOUSTICAL PANEL	X	X				
I-518	ACOUSTICAL PANEL	X	X				
I-519	ACOUSTICAL PANEL	X	X				
I-601	SCHEDULES	X	X				
I-602	SCHEDULES	X	X				

PLUMBING							
P-001	PLUMBING NOTES	X	X				
P-111	PLUMBING SUPPLY PLAN	X	X				
P-112	PLUMBING WASTE PLAN	X	X				
P-501	PLUMBING DETAILS	X	X				
P-502	PLUMBING DETAILS	X	X				
P-601	PLUMBING ISOMETRICS	X	X				

MECHANICAL							
M-001	MECHANICAL NOTES	X	X				
M-101	MECHANICAL DESIGN PLAN	X	X				
M-601	MECHANICAL SCHEDULES	X	X				

ELECTRICAL							
E-001	ELECTRICAL NOTES	X	X				
E-004	ELECTRICAL SITE PLAN	X	X				
E-101	ELECTRICAL DESIGN PLAN	X	X				
E-102	LIGHTING DESIGN PLAN	X	X				
E-103	LOW VOLTAGE PLAN	X	X				
E-501	ELECTRICAL DETAILS	X	X				
E-502	ELECTRICAL DETAILS	X	X				
E-503	ELECTRICAL DETAIL	X	X				
E-601	ELECTRICAL PANEL SCHEDULES	X	X				
EN-001	ENERGY CALCULATIONS	X	X				

SITE AND OCCUPANCY

PROJECT DESCRIPTION:	MAJOR RENOVATION
BUILDING HEIGHT:	1 STORY
BUILDING AREA:	1750 SF
BUILDING USE:	COFFEE SHOP
ZONING:	AC-3/AN/SP
TYPE OF USE:	COFFEE SHOP
TYPE OF OCCUPANCY:	A-2 ASSEMBLY
OCCUPANCY LOAD:	BEVERAGE PREP : 481 SF / 200 = 03 BOOTH SEATING : 4 X (5' - 9' LF / 24") = 12 CAFE/SEATING : 430 SF / 15 = 29 STANDING : 35 SF / 5 = 07 WORKROOM : 356 SF / 300 = 02 TOTAL OCCUPANCY: = 53

TOTAL SQUARE FOOTAGE: 1750 SF

TOTAL INTERIOR SEATS: 24

EXTERIOR SEASONAL SEATING:

EXTERIOR SEATING AREA: 338 SF

EXIT CAPACITY:
EXIT 1: 36" WIDE
EXIT 2: 72" WIDE
EXIT 3: 42" WIDE
TOTAL EXIT WIDTH PROVIDED: 150 IN.
0.2 X 53 OCCUPANTS = 10.6 IN. REQUIRED

TRAVEL DISTANCE:
ALLOWED TRAVEL DISTANCE: 200' - 0"
ACTUAL TRAVEL DISTANCE: 52' - 3"
52' - 3" < 200' - 0" THEREFORE COMPLIES

NUMBER OF EXITS:
MIN. NUMBER OF EXITS REQUIRED: 2
NUMBER OF EXITS PROVIDED: 3

APPLICABLE CODES

8TH ED. 2023 FLORIDA BUILDING CODES

8TH ED. 2023 FLORIDA BUILDING CODE :	MECHANICAL
8TH ED. 2023 FLORIDA BUILDING CODE :	PLUMBING
8TH ED. 2023 FLORIDA BUILDING CODE :	ACCESSIBILITY
8TH ED. 2023 FLORIDA BUILDING CODE :	FUEL GAS
8TH ED. FLORIDA FIRE PREVENTION CODE (2023)	
NATIONAL ELECTRICAL CODE NFPA-70 (2020) :	ELECTRICAL
8TH ED. 2023 FLORIDA ENERGY CONSERVATION CODE	

CODE CLASSIFICATION


A. OCCUPANCY GROUP:	A-2 ASSEMBLY
B. CONSTRUCTION CLASSIFICATION TYPE:	IV-B, NON-SPRINKLERED
C. AUTOMATIC FIRE SUPPRESSION SYSTEM INSTALLED:	NO
D. FIRE ALARM:	NO
E. ZONING:	AC-3/AN/SP
F. JURISDICTION/ COUNTY:	CITY OF ORLANDO/ ORANGE COUNTY

SCOPE OF WORK


REFER TO SHEET: A-100



VICINITY PLAN

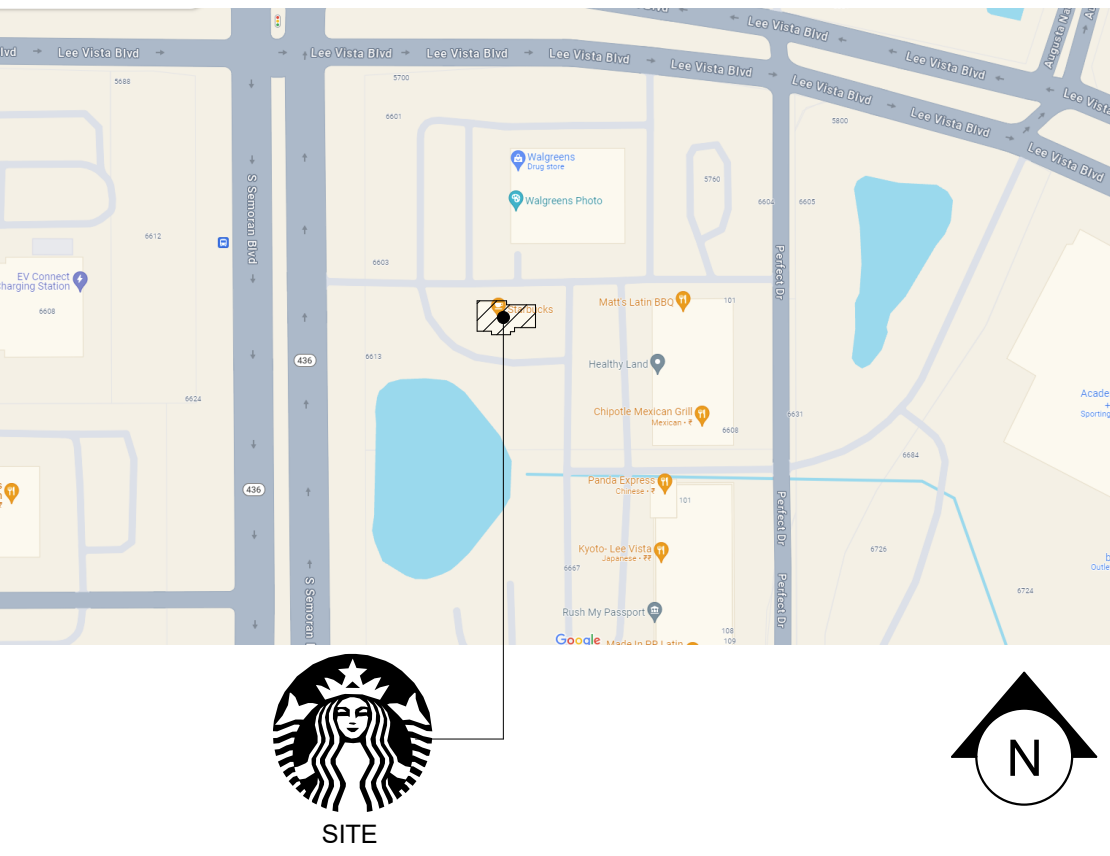

FOR CONSTRUCTION



© 2023 STARBUCKS COFFEE COMPANY

STARBUCKS®
2401 UTAH AVENUE SOUTH
SEATTLE, WASHINGTON 98134
(206) 318-1575

THESE DRAWINGS AND THE PROJECT MANUAL ARE CONFIDENTIAL AND SHALL REMAIN THE SOLE PROPERTY OF STARBUCKS CORPORATION, WHICH IS THE OWNER OF THE COPYRIGHT IN THIS WORK. THEY SHALL NOT BE REPRODUCED IN WHOLE OR IN PART, SHARED WITH THIRD PARTIES OR USED IN ANY MANNER ON OTHER PROJECTS OR EXTENSIONS TO THIS PROJECT WITHOUT THE PRIOR WRITTEN CONSENT OF STARBUCKS CORPORATION. THESE DRAWINGS AND SPECIFICATIONS ARE INTENDED TO EXPRESS DESIGN INTENT FOR A PROTOTYPICAL STARBUCKS STORE (WHICH IS SUBJECT TO CHANGE AT ANYTIME) AND DO NOT REFLECT ACTUAL SITE CONDITIONS. NEITHER PARTY SHALL HAVE ANY OBLIGATION NOR LIABILITY TO THE OTHER (EXCEPT STATED ABOVE) UNTIL A WRITTEN AGREEMENT IS FULLY EXECUTED BY BOTH PARTIES.

STARBUCKS TEMPLATE VERSION: i2023.10.23

Design Forum Architects Inc.
2050 Byers Rd
Miami, OH 45342
Tel: (844) 804-7700
Donald J. Rethman
Architect In Charge
License: AR0017303

MARQUE ENGINEERING
2230 PARK AVE, STE. 100, CINCINNATI, OH 45206
513.457.7131 - WWW.MARQUEENG.COM

PROJECT NAME:
S SEMORAN BLVD & LEE VISTA BLVD

PROJECT ADDRESS:
**6605 S SEMORAN BLVD
ORLANDO, FL 32822**

STORE #: 9875
PROJECT #: 25630-101
ISSUE DATE: 03/04/2024
DESIGN MANAGER: MARTIN PEREZ
PRODUCTION DESIGNER: ANDY MCLOUD
CHECKED BY: DONALD RETHMAN

Revision Schedule			
Rev	Date	By	Description

SHEET TITLE:
GENERAL INFORMATION

SCALE: NO SCALE

SHEET NUMBER:
G-001

\\file-day.ad.changeupinc.com\Client\StarbucksArchitecture\Projects_2023\Florida\S Semoran & Lee Vista -25630-101\25630-101_9875_S Semoran Blvd & Lee Vista Blvd, FL_2023.rvt 3/4/2024 2:38:11 PM

INDOOR SEATING CALCULATIONS			
DESCRIPTION	NUMBER OF ITEMS	SEATS	PER ITEM
TABLE TOP, SQUARE	03	06 SEATS	02
TABLE TOP, ROUND	04	04 SEATS	01
TABLE TOP, OBLONG, ADA	02	02 SEATS	01
BANQUETTE SEATING	04	12 SEATS	03
		24 SEATS X 5% = 02 ADA REQUIRED	02 PROVIDED
		TOTAL	24 SEATS

OUTDOOR SEATING CALCULATIONS			
DESCRIPTION	NUMBER OF ITEMS	SEATS	PER ITEM
TABLE TOP, SQUARE	10	20 SEATS	02
TABLE TOP, RECTANGLE, ADA	02	04 SEATS	02
		24 SEATS X 5% = 02 ADA REQUIRED	02 PROVIDED
		TOTAL	24 SEATS

EGRESS CALCULATION	
EXIT WIDTH REQUIRED - 53 OCC X 0.2	= 10.6 IN.
EXIT WIDTH PROVIDED	= 150 IN.
EXITS	= 36 IN. PRIMARY ENTRY, 72 IN. SECONDARY ENTRY, 42 IN. WORKROOM
EXITS REQUIRED	= 02
EXITS PROVIDED	= 03
MAXIMUM ALLOWABLE TRAVEL DISTANCE	= 200 FT.
MAXIMUM TRAVEL DISTANCE PROVIDED	= 52 FT. 3 IN.
MINIMUM EXIT SEPARATION	= 68 FT. 6 IN.(MAXIMUM DIAGONAL) / 2 = 34 FT. 3 IN.
EXIT SEPARATION PROVIDED	= 35 FT. 4 IN.

PLUMBING FIXTURE CALCULATIONS						
CHAPTER 29-29023 (FOR REFERENCE ONLY)						
OCCUPANCY	MALE	FEMALE	TOTAL			
	39 OCC.	39 OCC.	77 OCC.			
FIXTURES	WATER CLOSETS		URINALS*	LAVATORY		WATER FOUNTAIN**
	1 PER 75			1 PER 200		1 PER 100 OR STATION
	REQUIRED	1 M	1 F	0 M	1 M	1 F
	PROVIDED	1 M	1 F	0 M	1 M	1 F
*IN EACH BATHROOM OR TOILET ROOM, URINALS SHALL NOT BE SUBSTITUTED FOR MORE THAN 67% OF THE REQUIRED WATER CLOSETS IN ASSEMBLY OCCUPANCIES.						
**RETAIL ESTABLISHMENT SERVES WATER UPON REQUEST.						

OCCUPANCY	
BEVERAGE PREP: 481 SQ. FT. / 200 SQ. FT. / OCC	03 OCC
BOOTH SEATING: 4 X (5' - 9" LF / 24") / OCC	12 OCC
CAFE SEATING: 430 SQ. FT. / 15 SQ. FT. / OCC	29 OCC
STANDING: 35 SQ. FT. / 5 SQ. FT. / OCC	07 OCC
WORKROOM: 356 SQ. FT. / 300 SQ. FT. / OCC	02 OCC
TOTAL INTERIOR OCCUPANCY:	53 OCC
TOTAL EXTERIOR OCCUPANCY:	24 OCC
TOTAL OCC LOAD:	77 OCC

ROOM SCHEDULE	
NAME	AREA
BEVERAGE PREP	481 SF
BOOTH SEATING	51 SF
CAFE/SEATING	430 SF
STANDING	35 SF
UNOCCUPIABLE/NONSIMULTANEOUS	397 SF
WORKROOM	356 SF
GRAND TOTAL	1750 SF

OCCUPANCY NOTES	
OCCUPANCY CLASSIFICATION:	A-2 ASSEMBLY
TOTAL OCCUPANTS:	53

- KEYED NOTES
1.

THRESHOLDS TO BE BARRIER FREE COMPLIANT PER ALL APPLICABLE CODES.
2.

BARRIER-FREE PATH OF TRAVEL.
3.

30" (762 MM) X 48" (1220 MM) CLEAR FOR WHEELCHAIR ACCESS.
4.

60" (1525 MM) DIAMETER MINIMUM TURN RADIUS FOR WHEELCHAIR ACCESS.
5.

32" (813 MM) MINIMUM CLEAR AT RESTROOM DOOR.
6.

PROVIDE BARRIER-FREE SIGNAGE AT ADA RESTROOMS PER ALL APPLICABLE CODES.
7.

POS TRANSACTION PLANE, WASTE & RECYLING CART TOP AND HAND-OFF PLANE ARE 34 INCHES (863 MM) ABOVE THE FINISHED FLOOR FOR WHEELCHAIR ACCESSIBILITY.
8.

SEE ENLARGED RESTROOM PLAN AND ELEVATIONS SHEET(S) FOR ADDITIONAL INFORMATION ON ACCESSIBLE RESTROOM CLEARANCES.
9.

PROVIDE TACTILE "EXIT" SIGNAGE.
10.

PROVIDE INTERNATIONAL SYMBOL OF ACCESSIBILITY SIGN.

- MEANS OF EGRESS NOTES
- A.

EVERY ROOM OR SPACE THAT IS ASSEMBLY OCCUPANCY SHALL HAVE THE OCCUPANT LOAD OF THE ROOM OR SPACE POSTED IN A CONSPICUOUS PLACE, NEAR THE MAIN EXIT ACCESS DOORWAY. POSTED SIGNS SHALL BE OF AN APPROVED LEGIBLE PERMANENT DESIGN AND SHALL BE MAINTAINED BY THE OWNER AUTHORIZED AGENT.
- B.

EGRESS SHALL NOT PASS THROUGH KITCHENS, STORAGE ROOMS, CLOSETS OR SIMILAR SPACES.
- C.

PANIC AND FIRE EXIT HARDWARE, WHERE INSTALLED ON DOORS IN THIS BUILDING SHALL SATISFY THE FOLLOWING :

1.

THE ACTUATION PORTION OF THE RELEASING DEVICE SHALL EXTEND AT LEAST ONE-HALF OF THE DOOR LEAF WIDTH.

2.

THE MAXIMUM UNLATCHING FORCE DOES NOT EXCEED 15 POUNDS (6.8 KG).

3.

PIVOTED OR BALANCED DOORS SHALL BE OF THE PUSH-PAD TYPE WHERE PANIC HARDWARE IS REQUIRED AND THE PAD SHALL NOT EXTEND ACROSS MORE THAN ONE-HALF OF THE DOOR WIDTH, MEASURED FROM THE LATCH SIDE.

4.

PANIC HARDWARE LISTED IN ACCORDANCE WITH UL 305.

5.

FIRE EXIT HARDWARE LISTED IN ACCORDANCE WITH UL 10C AND UL 305.
- D.

STRUCTURAL ELEMENTS, FIXTURES OR FURNISHINGS SHALL NOT PROJECT HORIZONTALLY FROM EITHER SIDE MORE THAN 4 INCHES (101 MM) OVER ANY WALKING SURFACE BETWEEN 27 INCHES (685 MM) AND 80 INCHES (2032 MM) ABOVE THE WALKING SURFACE. EXCEPTION: HANDRAILS SERVING STAIRS AND RAMPS ARE PERMITTED TO PROTRUDE 4 1/2 INCHES (115 MM) FROM THE WALL.
- E.

THE PATH OF EGRESS TRAVEL EXITS AND WITHIN EXITS IN THIS BUILDING SHALL BE IDENTIFIED BY EXIT SIGNS CONFORMING TO THE REQUIREMENTS OF SECTION 1011 AND AS NOTED BELOW:

1.

EXIT SIGNS SHALL BE READILY VISIBLE FROM ANY DIRECTION OF EGRESS TRAVEL.

2.

EXIT SIGNS SHALL BE LOCATED AS NECESSARY TO CLEARLY INDICATE THE DIRECTION OF EGRESS TRAVEL.


3.

NO POINT IN A CORRIDOR SHALL BE MORE THAN 100 FT (30.5 M) OR THE LISTED VIEWING DISTANCE FOR THE SIGN, WHICHEVER IS LESS, FROM THE NEAREST VISIBLE EXIT SIGN.
- F.


WHERE KEY OPERATED LOCKING DEVICES ARE USED, POST A SIGN ON OR ADJACENT TO THE REQUIRED MAIN EXIT DOOR WITH 1 INCH (25 MM) LETTERING STATING THAT "THIS DOOR TO REMAIN UNLOCKED WHEN BUILDING IS OCCUPIED".
- G.

EGRESS DOORS OR GATES SHALL BE OPENABLE FROM THE EGRESS SIDE WITHOUT THE USE OF A KEY, SPECIAL KNOWLEDGE OR EFFORT. DOOR HANDLES, PULLS, LATCHES, LOCKS AND OTHER OPERATING DEVICES SHALL BE INSTALLED 34 INCHES (863 MM) TO 48 INCHES (1220 MM) ABOVE FINISHED FLOOR. MANUALLY OPERATED FLUSH BOLTS OR SURFACE BOLTS ARE NOT PERMITTED. THE UNLATCHING OF ANY DOOR OR LEAF SHALL NOT REQUIRE MORE THAN ONE OPERATION.
- H.


LANDINGS SHALL BE PROVIDED ON EACH SIDE OF DOORS AND SUCH LANDING SHALL BE AT THE SAME ELEVATION ON EACH SIDE OF THE DOOR. LANDINGS SHALL HAVE A WIDTH NOT LESS THAN THE WIDTH OF THE DOOR AND LENGTH MEASURED IN THE DIRECTION OF TRAVEL OF NOT LESS THAN 44 INCHES (1118 MM).

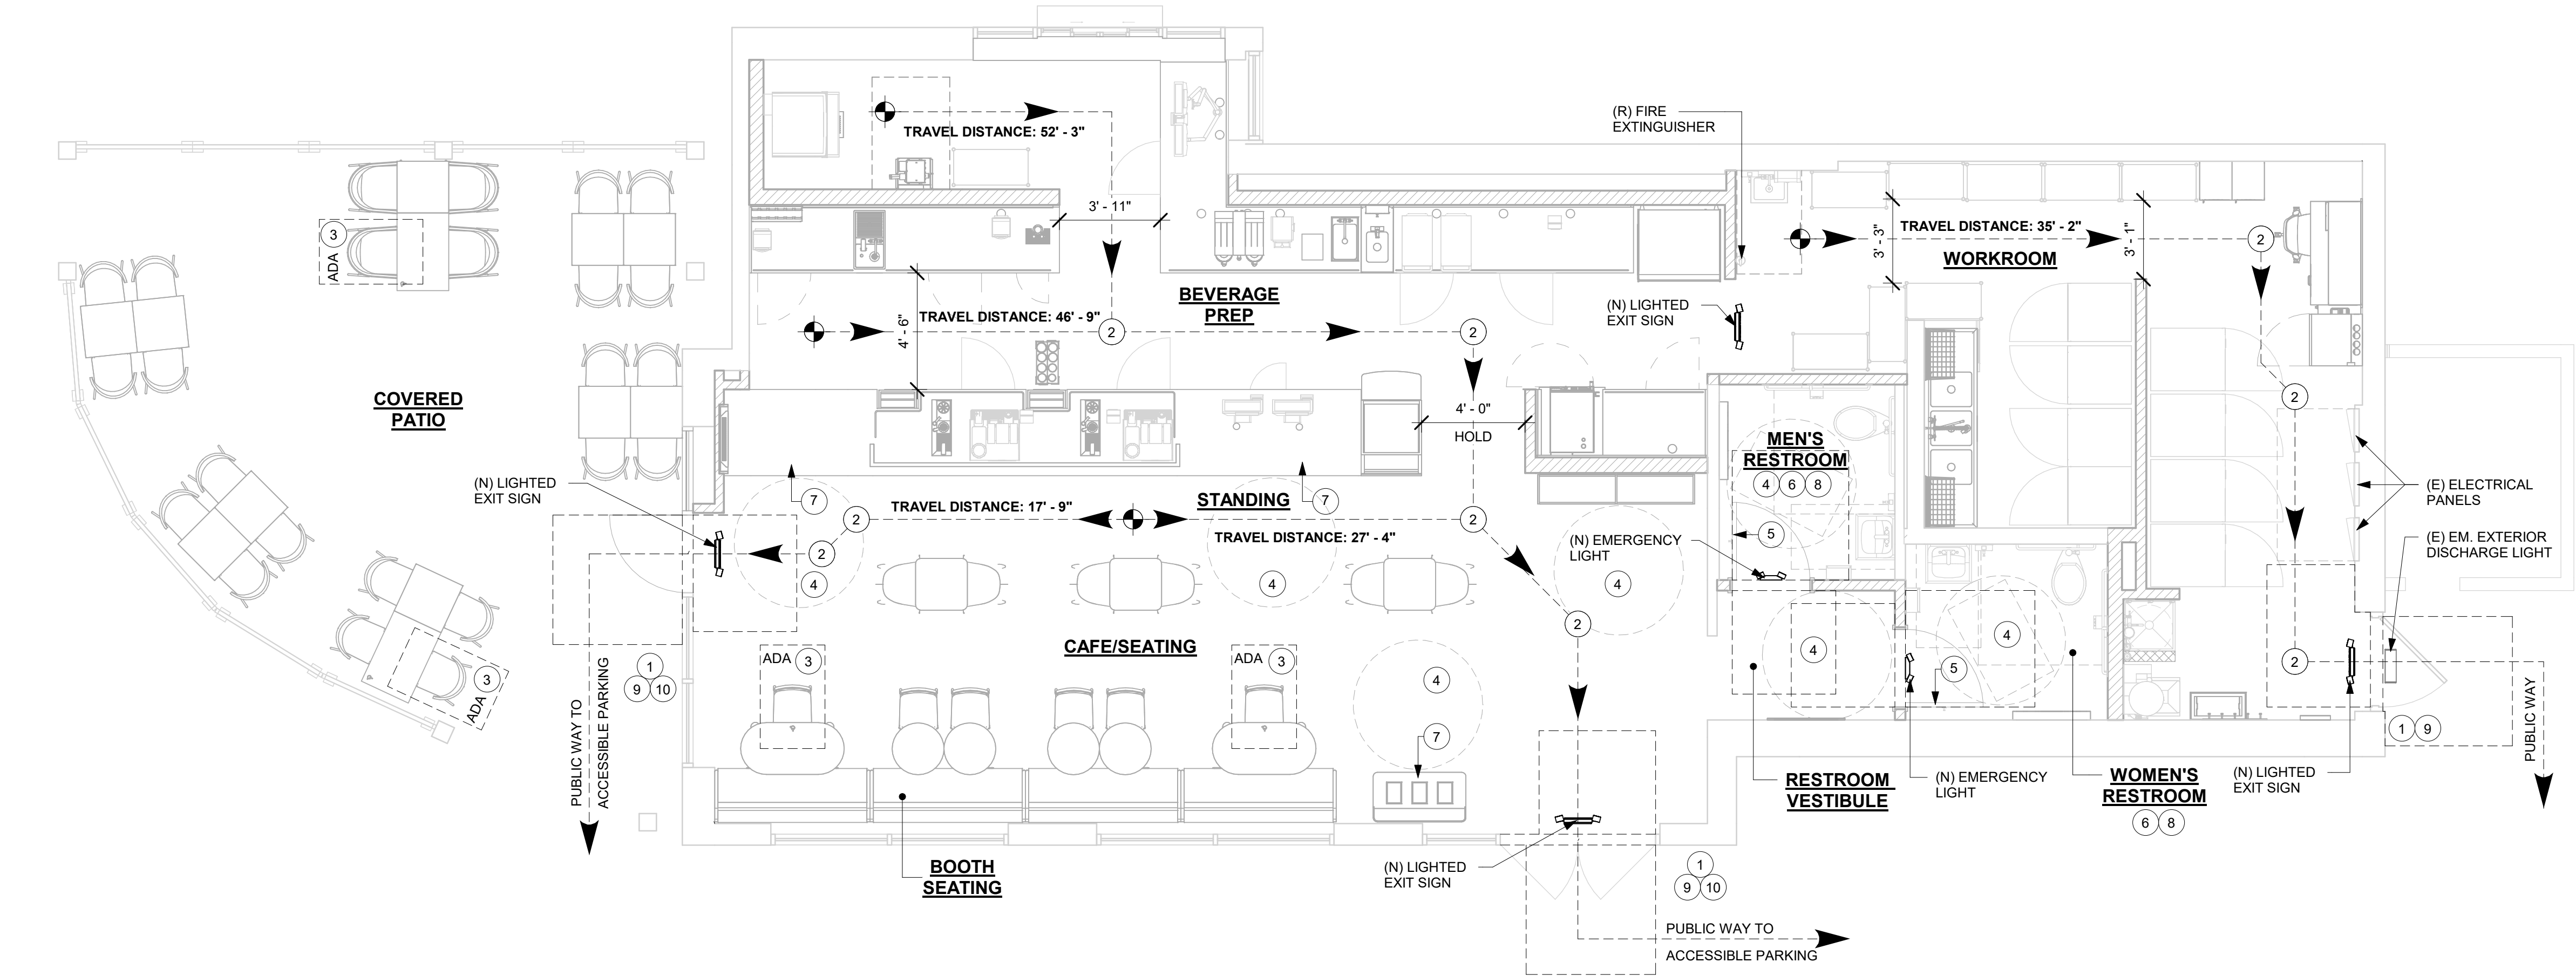

1 LIFE SAFETY ACCESSIBILITY PLAN
Scale: 1/4" = 1'-0"

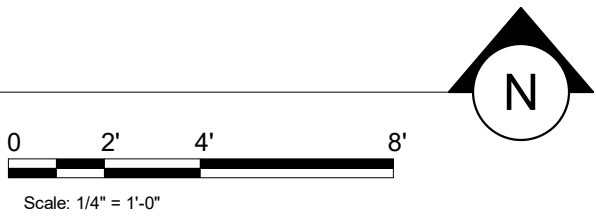

FOR CONSTRUCTION



© 2023 STARBUCKS COFFEE COMPANY

STARBUCKS®
2401 UTAH AVENUE SOUTH
SEATTLE, WASHINGTON 98134
(206) 318-1575

THESE DRAWINGS AND THE PROJECT MANUAL ARE CONFIDENTIAL AND SHALL REMAIN THE SOLE PROPERTY OF STARBUCKS CORPORATION, WHICH IS THE OWNER OF THE COPYRIGHT IN THIS WORK. THEY SHALL NOT BE REPRODUCED IN WHOLE OR IN PART, SHARED WITH THIRD PARTIES OR USED IN ANY MANNER ON OTHER PROJECTS OR EXTENSIONS TO THIS PROJECT WITHOUT THE PRIOR WRITTEN CONSENT OF STARBUCKS CORPORATION. THESE DRAWINGS AND SPECIFICATIONS ARE INTENDED TO EXPRESS DESIGN INTENT FOR A PROTOTYPICAL STARBUCKS STORE (WHICH IS SUBJECT TO CHANGE AT ANYTIME) AND DO NOT REFLECT ACTUAL SITE CONDITIONS. NEITHER PARTY SHALL HAVE ANY OBLIGATION NOR LIABILITY TO THE OTHER (EXCEPT STATED ABOVE) UNTIL A WRITTEN AGREEMENT IS FULLY EXECUTED BY BOTH PARTIES.

STARBUCKS TEMPLATE VERSION: i2023.10.23

Design Forum Architects Inc.
2050 Byers Rd
Miami, OH 45342
Tel: (644) 804-7700

Donald J. Reihman
Architect In Charge
License: AR0017303

MARQUE ENGINEERING
2230 PARK AVE, STE. 100, CINCINNATI, OH 45206
513.457.7131 - WWW.MARQUEENG.COM

PROJECT NAME:
S SEMORAN BLVD & LEE VISTA BLVD

PROJECT ADDRESS:
**6605 S SEMORAN BLVD
ORLANDO, FL 32822**

STORE #:
25630-101

ISSUE DATE:
03/04/2024

DESIGN MANAGER:
MARTIN PEREZ

PRODUCTION DESIGNER:
ANDY MCLOUD

CHECKED BY:
DONALD REHMAN

Revision Schedule			
Rev	Date	By	Description

SHEET TITLE:
LIFE SAFETY ACCESSIBILITY PLAN

SCALE: 1/4" = 1'-0"

SHEET NUMBER:


G-002

\\file-day.ad.changeupinc.com\Client\StarbucksArchitecture\Projects_2023\Florida\Semoran & Lee Vista -25630-101\25630-101_9875_S Semoran Blvd & Lee Vista Blvd, FL_2023.rvt 3/4/2024 2:38:49 PM



AREA COLOR LEGEND

- BEVERAGE PREP.
- BOOTH SEATING
- CAFE/SEATING
- STANDING
- UNOCCUPIABLE/NONSIMULTANEOUS
- WORKROOM


AREA - OCCUPANT LOAD CALCS			
NAME	AREA (SF)	LOAD FACTOR	OCCUPANT LOAD
BEVERAGE PREP	481 SF	200	3
BOOTH SEATING	4 X (6' - 9" LF /24")		12
CAFE/SEATING	430 SF	15	29
STANDING	35 SF	5	7
UNOCCUPIABLE/NONSIMULTANEOUS	397 SF	0	0
WORKROOM	356 SF	300	2
GRAND TOTAL	1750 SF		53

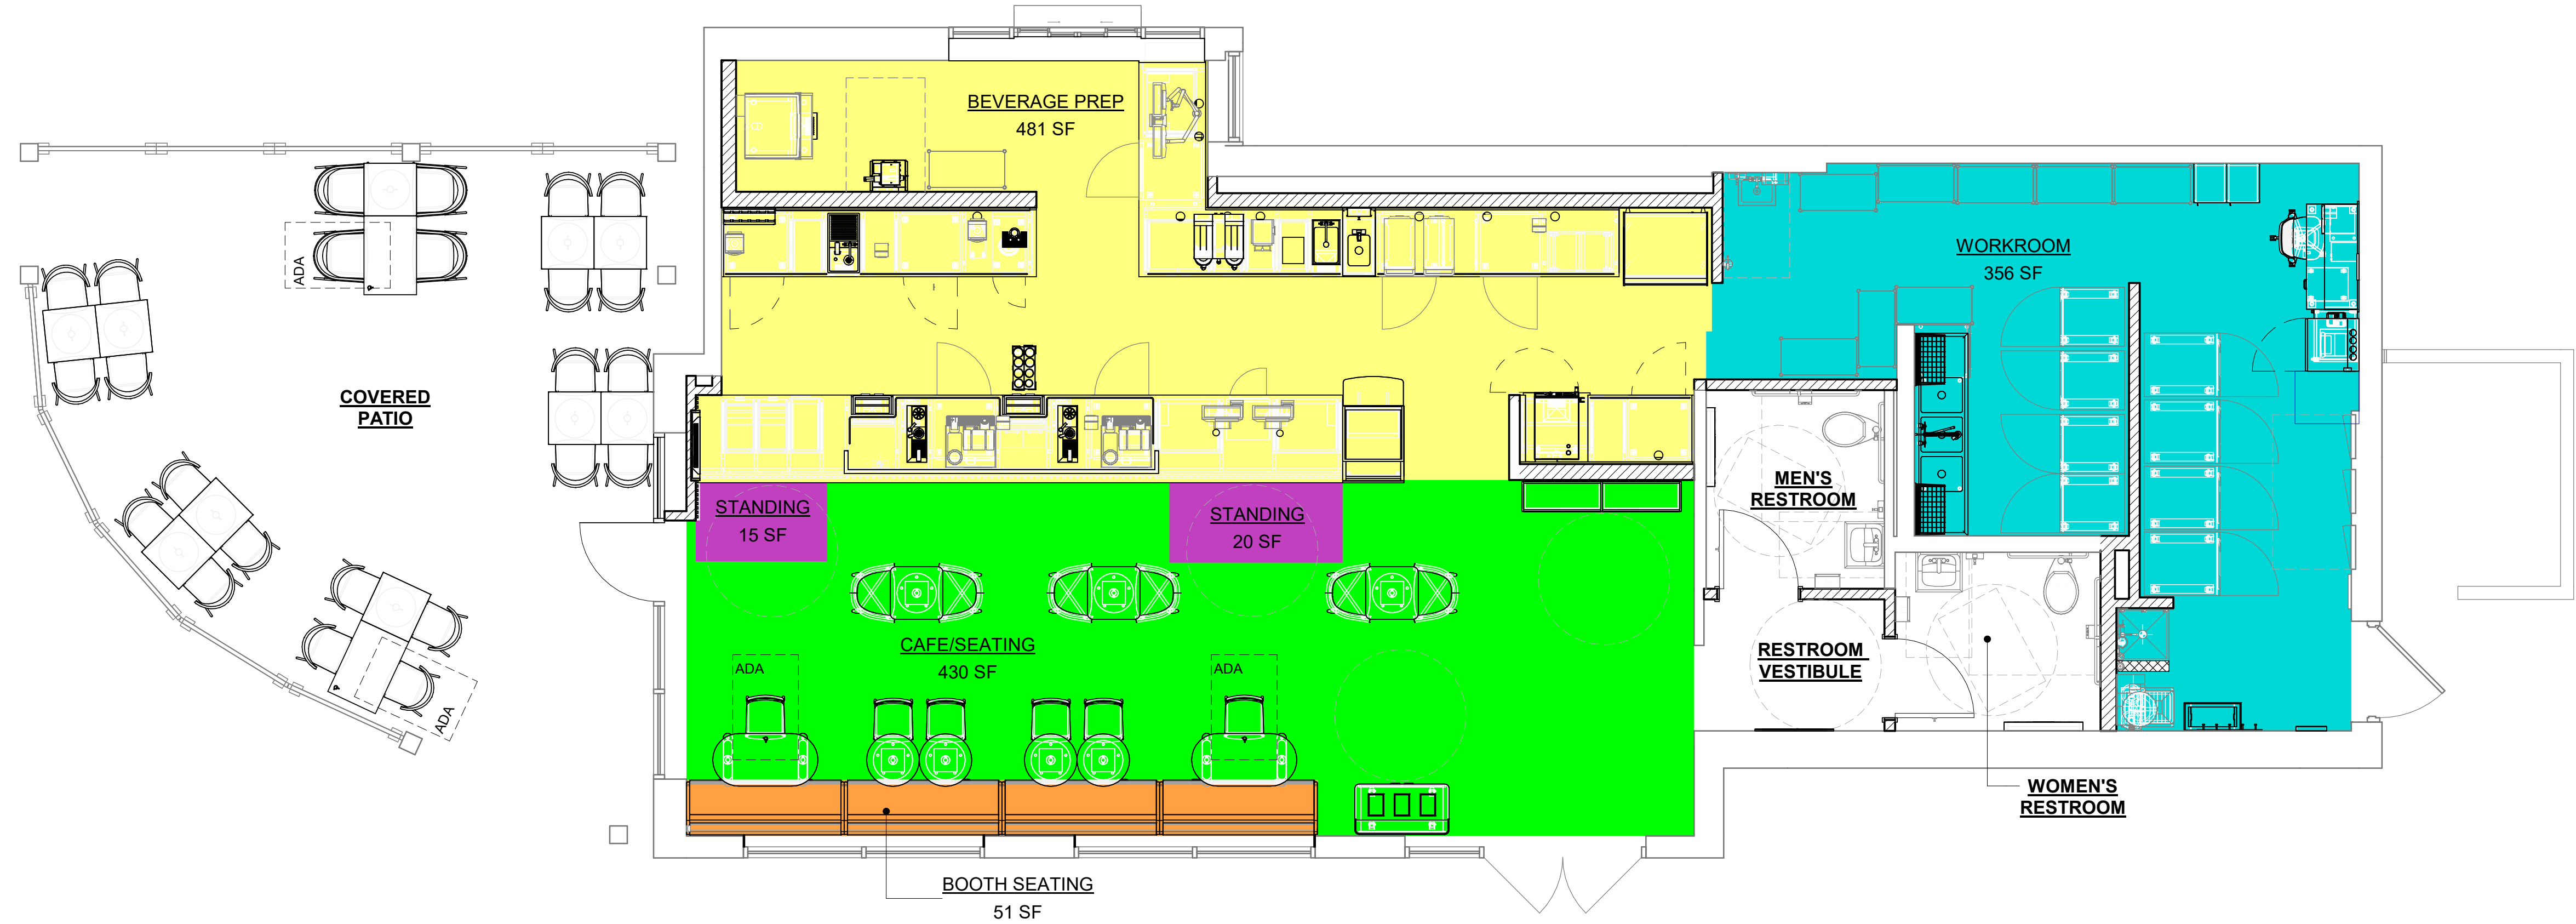

1 OCCUPANCY LOAD PLAN
Scale: 1/4" = 1'-0"

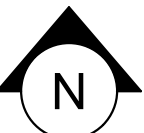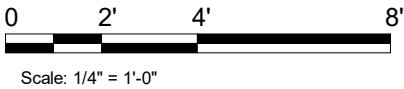

FOR CONSTRUCTION



© 2023 STARBUCKS COFFEE COMPANY

STARBUCKS®
2401 UTAH AVENUE SOUTH
SEATTLE, WASHINGTON 98134
(206) 318-1575

THESE DRAWINGS AND THE PROJECT MANUAL ARE CONFIDENTIAL AND SHALL REMAIN THE SOLE PROPERTY OF STARBUCKS CORPORATION, WHICH IS THE OWNER OF THE COPYRIGHT IN THIS WORK. THEY SHALL NOT BE REPRODUCED IN WHOLE OR IN PART, SHARED WITH THIRD PARTIES OR USED IN ANY MANNER ON OTHER PROJECTS OR EXTENSIONS TO THIS PROJECT WITHOUT THE PRIOR WRITTEN CONSENT OF STARBUCKS CORPORATION. THESE DRAWINGS AND SPECIFICATIONS ARE INTENDED TO EXPRESS DESIGN INTENT FOR A PROTOTYPICAL STARBUCKS STORE (WHICH IS SUBJECT TO CHANGE AT ANYTIME) AND DO NOT REFLECT ACTUAL SITE CONDITIONS. NEITHER PARTY SHALL HAVE ANY OBLIGATION NOR LIABILITY TO THE OTHER (EXCEPT STATED ABOVE) UNTIL A WRITTEN AGREEMENT IS FULLY EXECUTED BY BOTH PARTIES.

STARBUCKS TEMPLATE VERSION: i2023.10.23

Design Forum Architects Inc.
2050 Byers Rd
Miamisburg, OH 45342
Tel: (844) 804-7700
Donald J. Reithman
Architect In Charge
License: AR0017303

MARQUE ENGINEERING
2230 PARK AVE, STE. 100, CINCINNATI, OH 45206
513.457.7131 - WWW.MARQUEENG.COM

PROJECT NAME:
S SEMORAN BLVD & LEE VISTA BLVD

PROJECT ADDRESS:
**6605 S SEMORAN BLVD
ORLANDO, FL 32822**

STORE #: 9875
PROJECT #: 25630-101
ISSUE DATE: 03/04/2024
DESIGN MANAGER: MARTIN PEREZ
PRODUCTION DESIGNER: ANDY MCLOUD
CHECKED BY: DONALD RETHMAN

Revision Schedule			
Rev	Date	By	Description






SHEET TITLE:
OCCUPANCY LOAD PLAN
SCALE: 1/4" = 1'-0"

SHEET NUMBER:
G-002.1

\\file-day.ad.changeupinc.com\Client\StarbucksArchitecture\Projects_2023\Florida\Semoran & Lee Vista -25630-101\25630-101_9875_S Semoran Blvd & Lee Vista Blvd, FL_2023.rvt

3/4/2024 2:38:50 PM

21 SECTION 4.3 ACCESSIBLE ROUTE

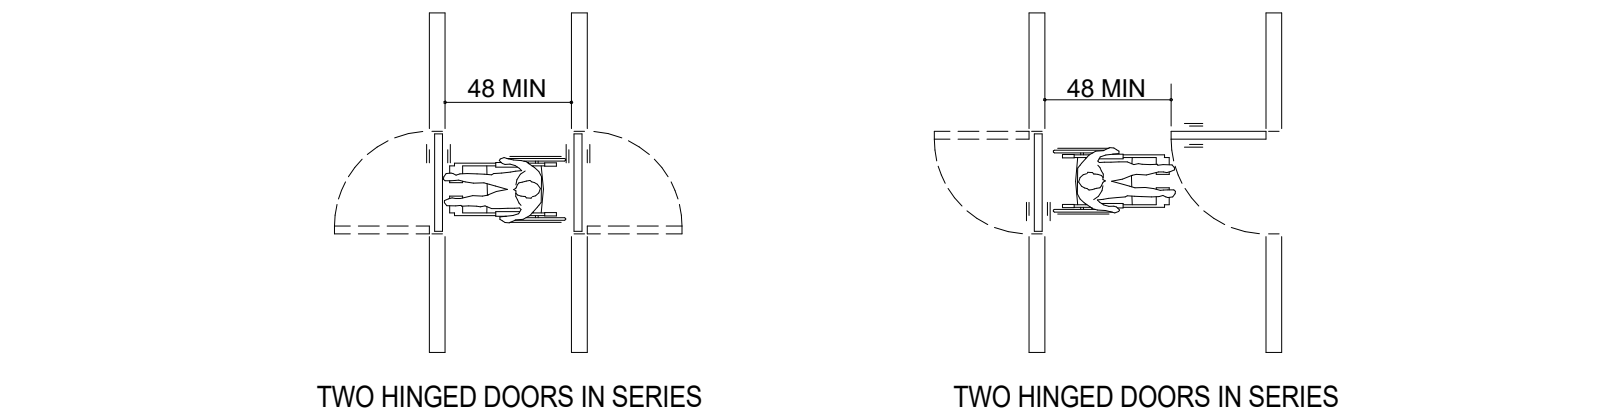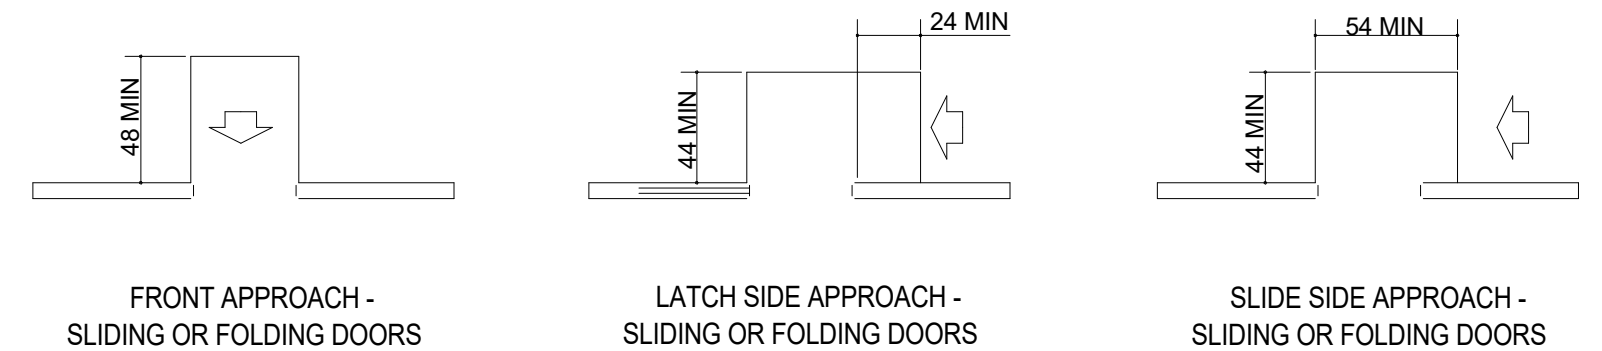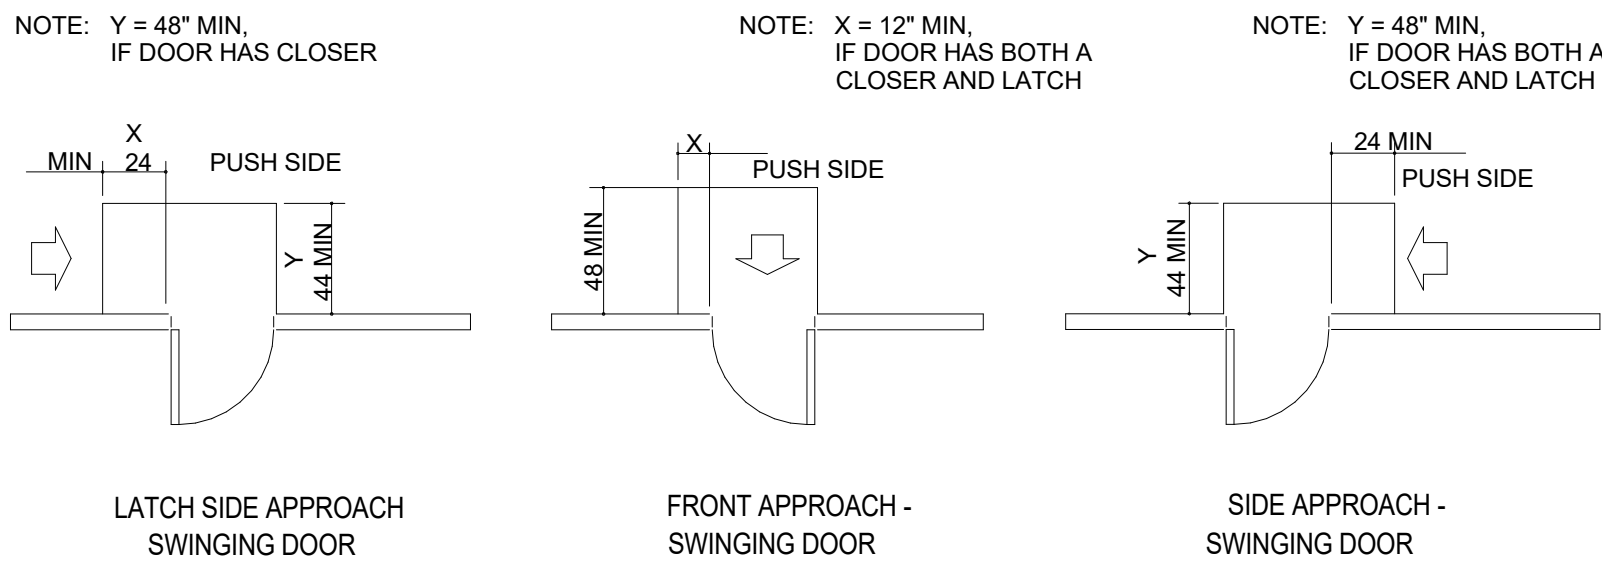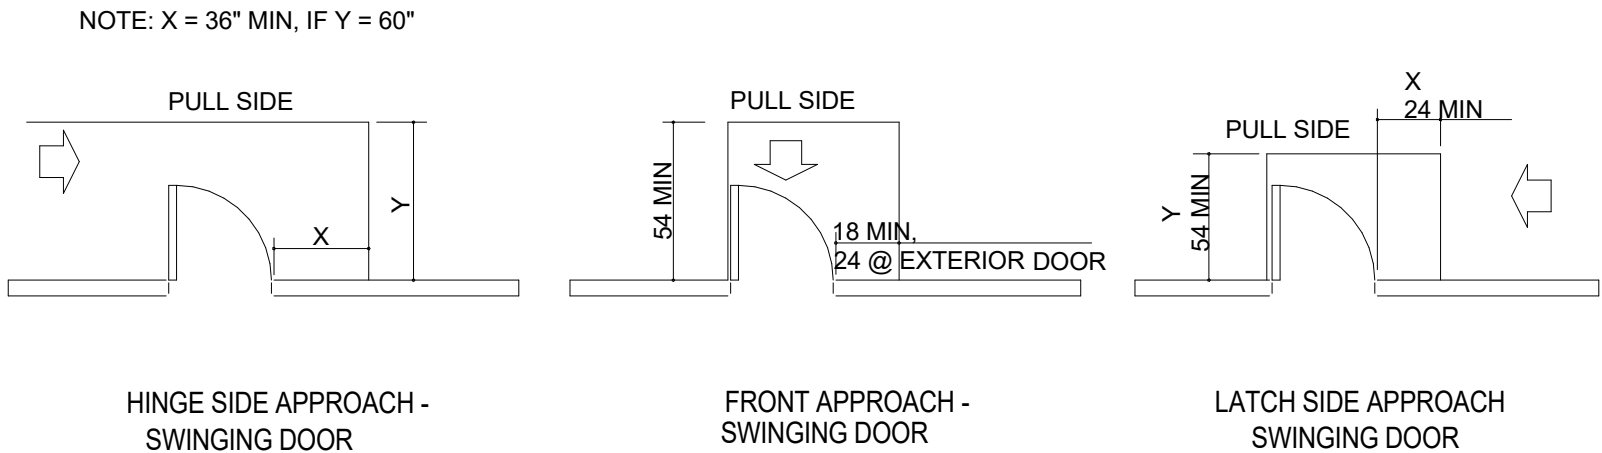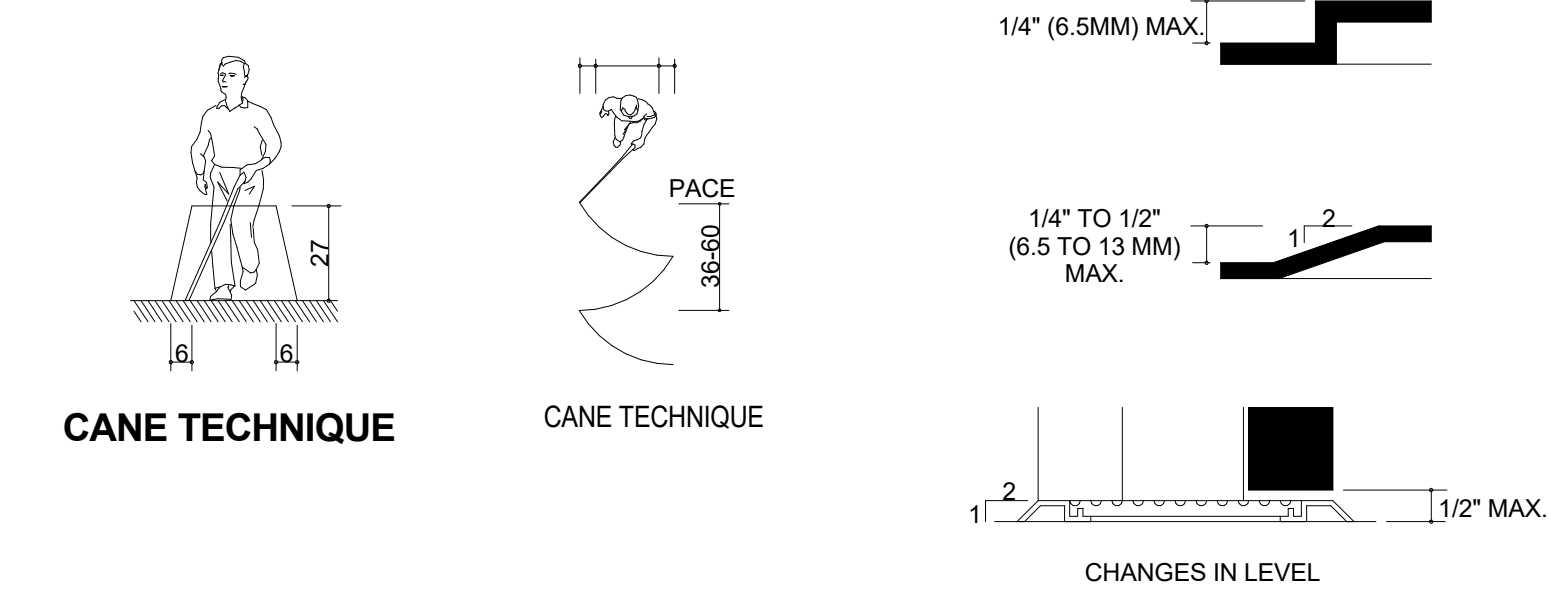


24 SECTION 4.13 DOORS

SCALE: NTS


NOTE:

BOTH HIGH AND LOW FOUNTAINS ARE REQUIRED. NO FEWER THAN 50% WHEELCHAIR ACCESSIBLE. OTHERS ARE TO BE LOCATED AT A STANDERED HEIGHT CONVENIENT TO THOSE WITH DIFFICULTY STOOPING. HIGH-LOW FOUNTAINS ARE REQ. WHEN ONLY ONE FOUNTAIN IS APPROVED.

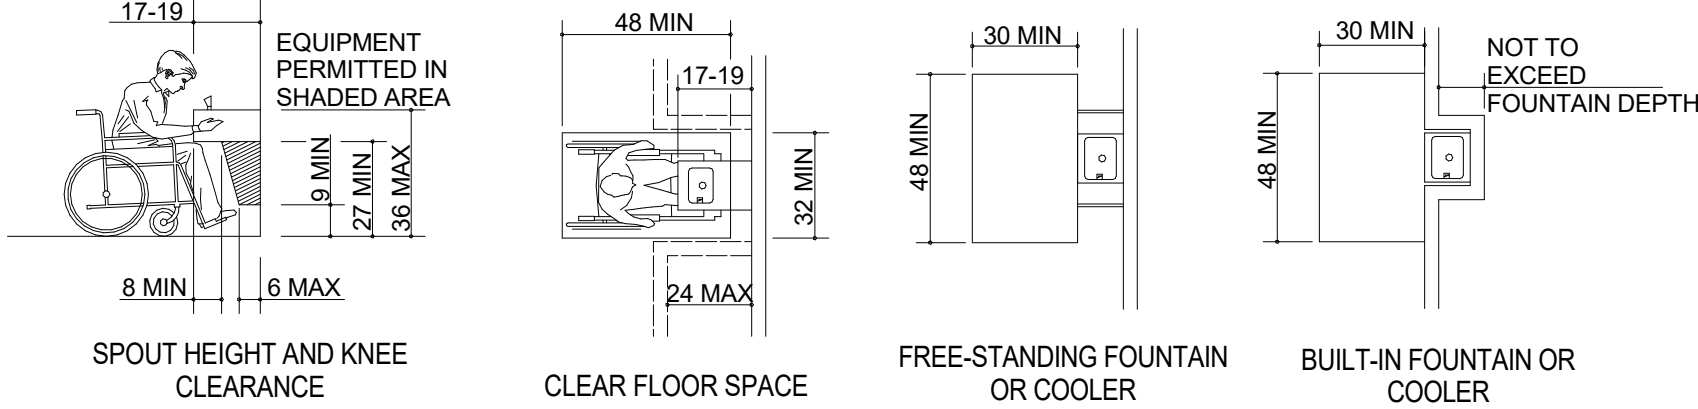

13 SECTION 4.15 DRINKING FOUNTAINS




SCALE: NTS

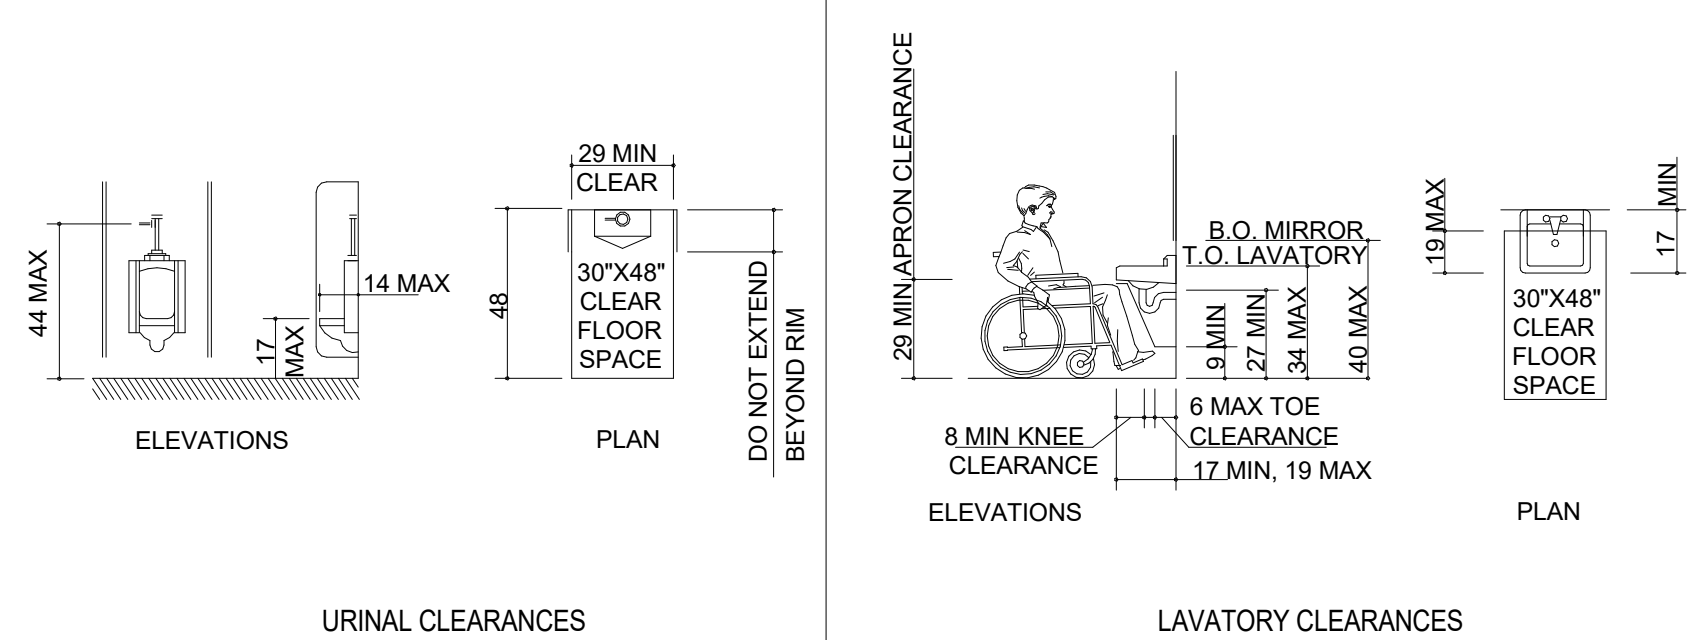

14 SECTION 4.18 URINALS

SCALE: NTS

NOTE: HORIZONTAL GRAB BARS MEASURED FROM FINISHED FLOOR TO TOP OF GRIPPING SURFACE.

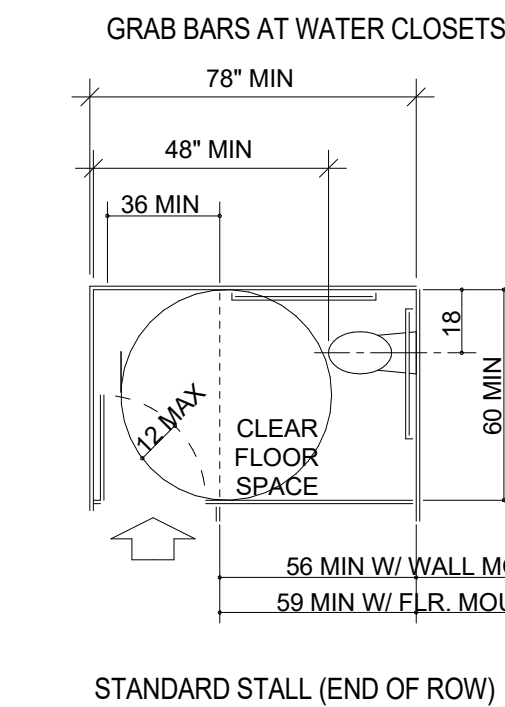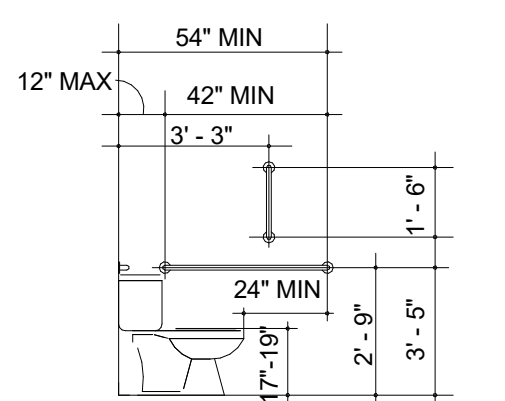
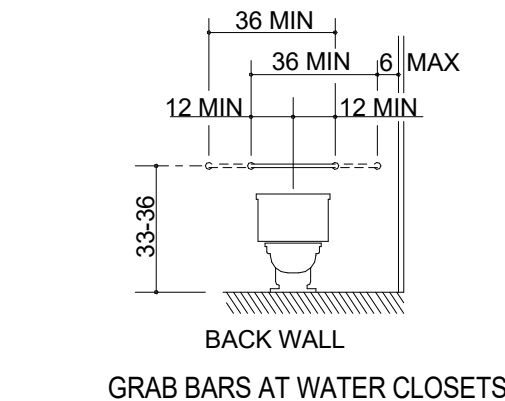


16 SECTION 4.17 TOILET STALLS

SCALE: NTS

10 SEC. 4.19 LAVATORIES & MIRRORS









SCALE: NTS

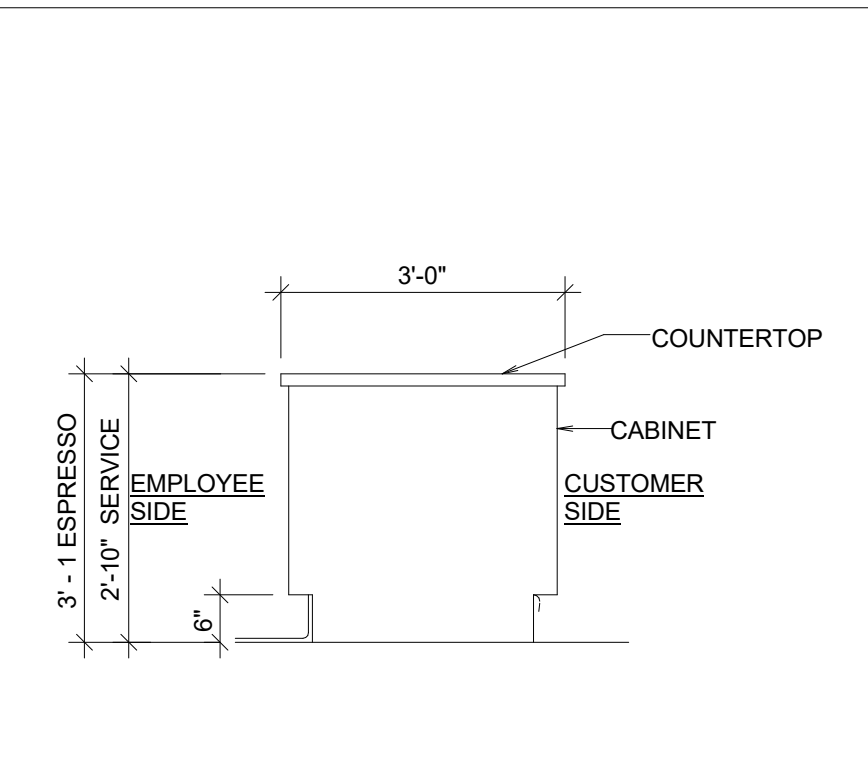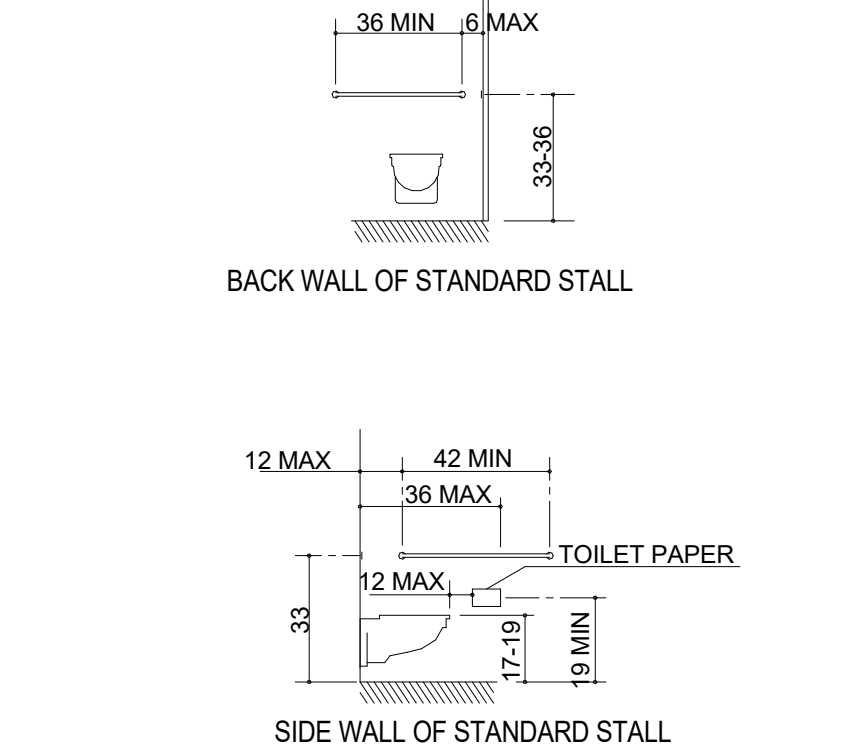

12 TYP SECTION @ COUNTER

SCALE: NTS

8 SECTION 4.2 SPACE ALLOWANCES

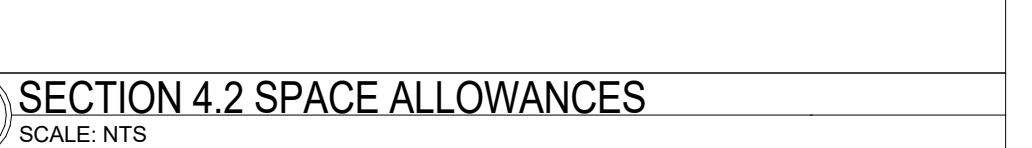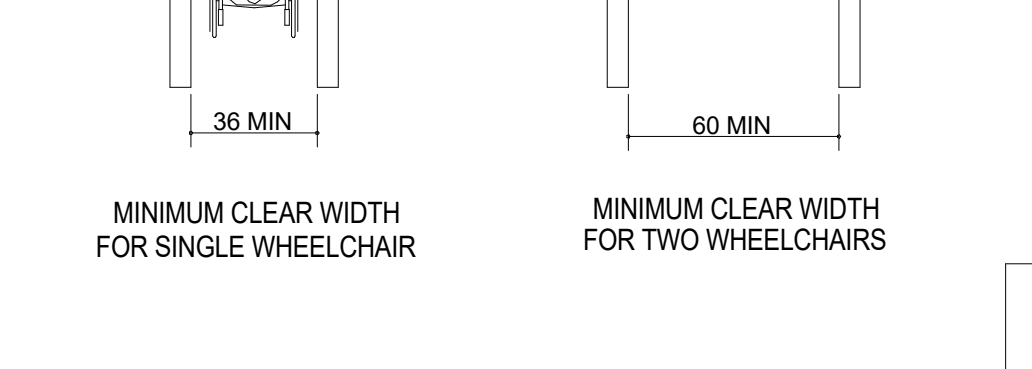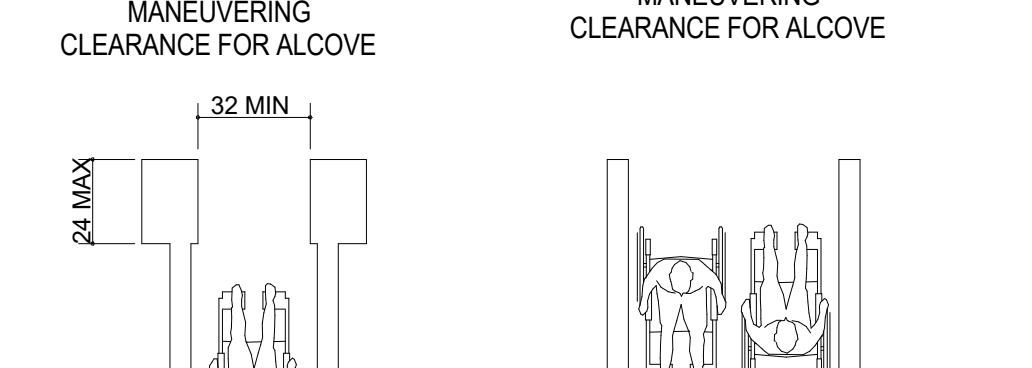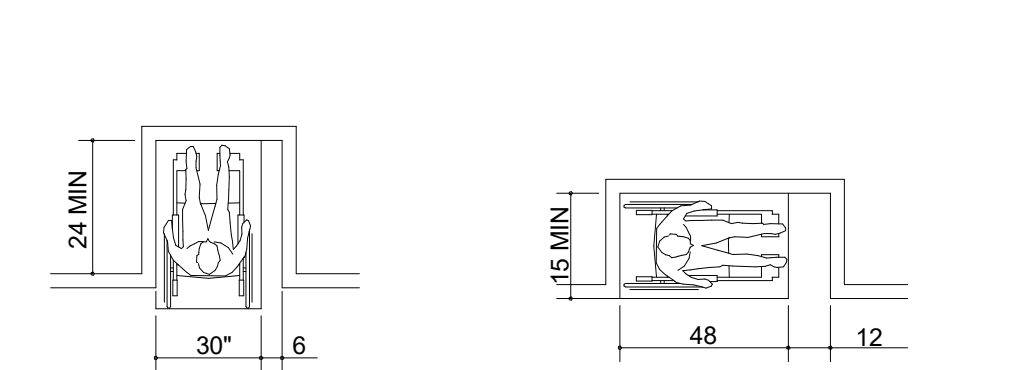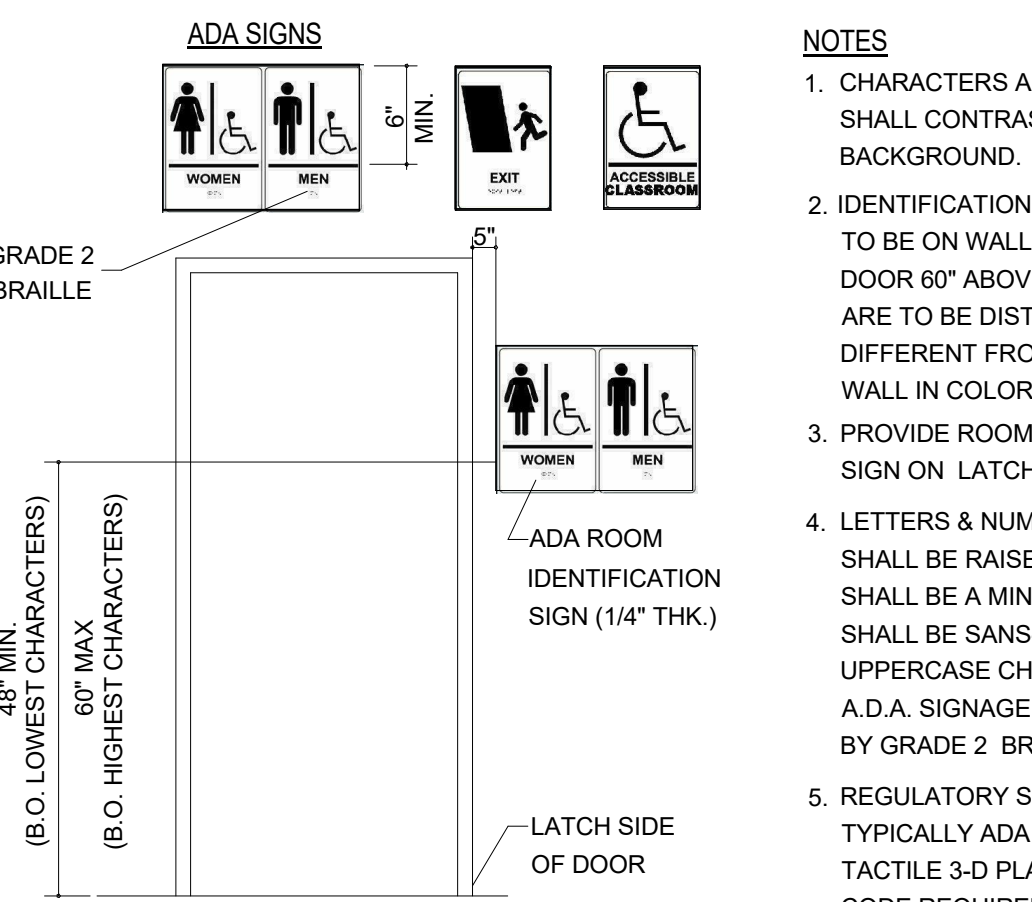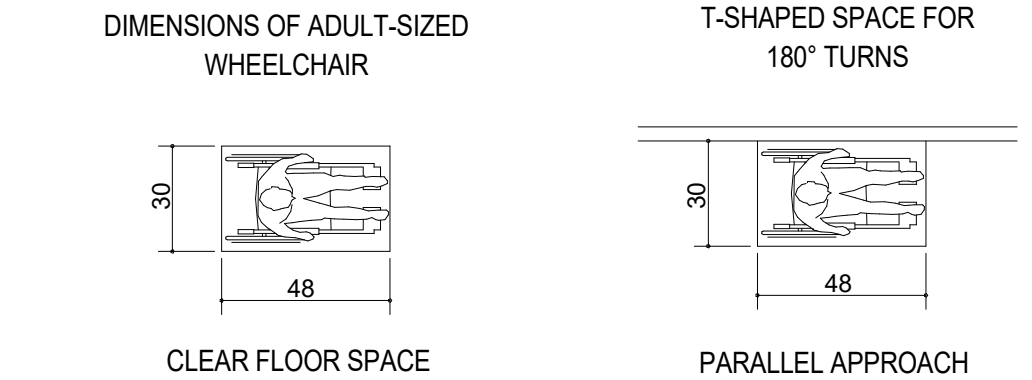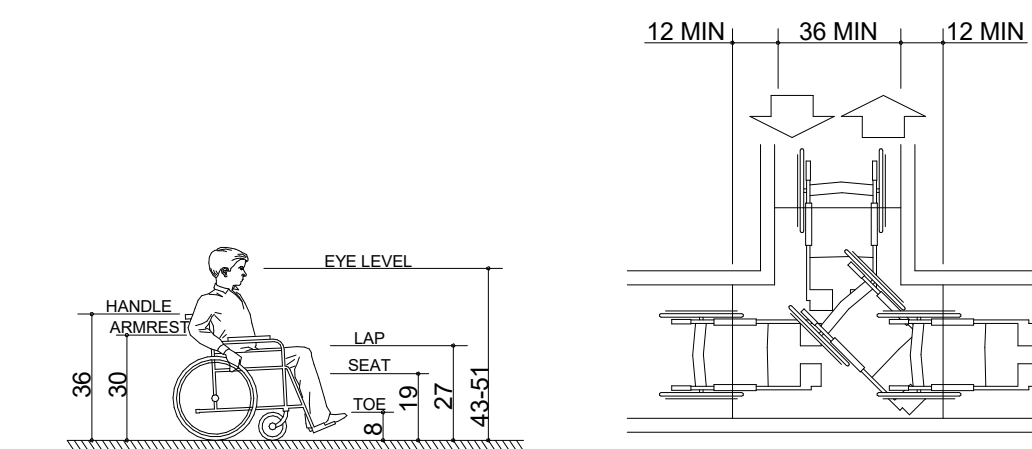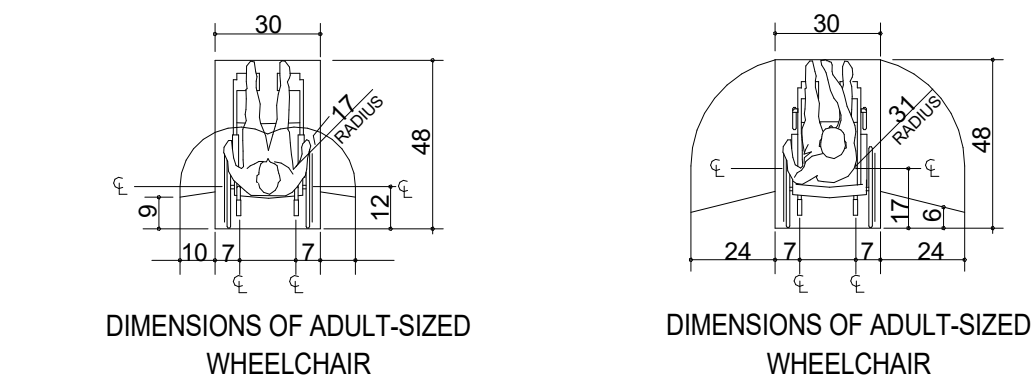

STARBUCKS®
2401 UTAH AVENUE SOUTH
SEATTLE, WASHINGTON 98134
(206) 318-1575

THESE DRAWINGS AND THE PROJECT MANUAL ARE CONFIDENTIAL AND SHALL REMAIN THE SOLE PROPERTY OF STARBUCKS CORPORATION, WHICH IS THE OWNER OF THE COPYRIGHT IN THIS WORK. THEY SHALL NOT BE REPRODUCED IN WHOLE OR IN PART, SHARED WITH THIRD PARTIES OR USED IN ANY MANNER ON OTHER PROJECTS OR EXTENSIONS TO THIS PROJECT WITHOUT THE PRIOR WRITTEN CONSENT OF STARBUCKS CORPORATION. THESE DRAWINGS AND SPECIFICATIONS ARE INTENDED TO EXPRESS DESIGN INTENT FOR A PROTOTYPICAL STARBUCKS STORE (WHICH IS SUBJECT TO CHANGE AT ANYTIME) AND DO NOT REFLECT ACTUAL SITE CONDITIONS. NEITHER PARTY SHALL HAVE ANY OBLIGATION NOR LIABILITY TO THE OTHER (EXCEPT STATED ABOVE) UNTIL A WRITTEN AGREEMENT IS FULLY EXECUTED BY BOTH PARTIES.

STARBUCKS TEMPLATE VERSION: i2023.10.23

Design Forum Architects Inc.

2050 Byers Rd
Miami, FL 33134
Tel: (844) 804-7700

MARQUE ENGINEERING
2230 PARK AVE, STE. 100, CINCINNATI, OH 45206
513.457.7131 - WWW.MARQUEENG.COM

FOR CONSTRUCTION

PROJECT NAME:
S SEMORAN BLVD & LEE VISTA BLVD

PROJECT ADDRESS:
6605 S SEMORAN BLVD ORLANDO, FL 32822

STORE #: 9875
PROJECT #: 25630-101
ISSUE DATE: 03/04/2024
DESIGN MANAGER: MARTIN PEREZ
PRODUCTION DESIGNER: ANDY MCLOUD
CHECKED BY: DONALD RETHMAN

Revision Schedule			
Rev	Date	By	Description

SHEET TITLE:
ACCESSIBILITY GUIDELINES
SCALE: NO SCALE

SHEET NUMBER:
G-003


\\file-day.ad.changeupinc.com\Client\StarbucksArchitecture\Projects_2023\Florida\Semoran & Lee Vista -25630-10\25630-101_9875_S Semoran Blvd & Lee Vista Blvd, FL_2023.rvt 3/4/2024 2:38:52 PM

GENERAL NOTES


1. GENERAL CONTRACTOR SHALL VISIT THE SITE, REVIEW THE BUILDING SHELL DRAWINGS AS SUBMITTED BY THE LANDLORD OR STARBUCKS SITE SURVEYOR AND BECOME THOROUGHLY FAMILIAR WITH THE SITE CONDITIONS PRIOR TO BIDDING OR CONSTRUCTION.
2. GENERAL CONTRACTOR SHALL CONSULT WITH STARBUCKS CONSTRUCTION MANAGER TO RESOLVE ANY CHANGES, OMISSIONS OR PLAN DISCREPANCIES PRIOR TO BIDDING OR CONSTRUCTION.
3. ALL WORK SHALL BE PERFORMED IN STRICT COMPLIANCE WITH LOCAL, COUNTY, STATE AND FEDERAL CODES AND ORDINANCES.
4. GENERAL CONTRACTOR SHALL VERIFY THE LOCATION OF ALL UTILITIES.
5. GENERAL CONTRACTOR TO VERIFY ALL DIMENSIONS, INCLUDING CLEARANCES REQUIRED BY OTHER TRADES AND NOTIFY STARBUCKS CONSTRUCTION MANAGER OF ANY DISCREPANCIES PRIOR TO PROCEEDING WITH THE WORK. ALL DIMENSIONS ARE TO THE FACE OF THE FINISHED SURFACE UNLESS OTHERWISE NOTED. ALL DIMENSIONS TO BE TAKEN FROM DESIGNATED DATUM POINT. DO NOT SCALE DRAWINGS.
6. GENERAL CONTRACTOR SHALL PATCH AND REPAIR ALL EXISTING WALLS, FLOORS, CEILINGS OR OTHER SURFACES IDENTIFIED TO REMAIN THAT MAY BECOME DAMAGED DURING THE COURSE OF THE WORK.
7. THE GENERAL CONTRACTOR IS RESPONSIBLE FOR OBTAINING PERMITS FOR FIRE PROTECTION, PLUMBING, MECHANICAL AND ELECTRICAL SYSTEMS PRIOR TO INSTALLATION OF SUCH SYSTEMS.
8. GENERAL CONTRACTOR SHALL RETAIN ONE SET OF THE PLANS TO NOTE AND DOCUMENT ALL CHANGES DURING CONSTRUCTION. THIS SET SHALL BE A PART OF THE GENERAL CONTRACTOR'S "STORE CLOSE-OUT PACKAGE" AS DESCRIBED IN THE CONSTRUCTION MANAGEMENT AGREEMENT.
9. GENERAL CONTRACTOR IS RESPONSIBLE FOR COORDINATING DELIVERY OF MATERIALS FROM STARBUCKS CONTRACTED THIRD PARTY LOGISTICS DISTRIBUTION SERVICES AND VENDOR DIRECT SHIPMENTS. REFER TO CONSTRUCTION MANAGEMENT AGREEMENT FOR METHODS AND LEAD TIMES.
10. RESPONSIBILITY FOR SUPPLY AND DELIVERY OF MATERIALS AND EQUIPMENT IS IDENTIFIED IN THE DRAWING SCHEDULE SHEETS UNDER THE COLUMN LABELED "RESPONSIBILITY".
11. FOR THE PURPOSE OF THE DOCUMENTS, TO "INSTALL," SHALL MEAN TO PROVIDE ALL FASTENERS, MISCELLANEOUS HARDWARE, BLOCKING, ELECTRICAL CONNECTIONS, PLUMBING CONNECTIONS, AND OTHER ITEMS REQUIRED FOR A COMPLETE AND OPERATION INSTALLATION, UNLESS OTHERWISE NOTED.
12. ALL ITEM SUBSTITUTIONS MUST BE APPROVED BY THE STARBUCKS DESIGN MANAGER.
13. REFER TO ITEM CUTSHEETS FOR ADDITIONAL INFORMATION.

KEYED NOTES

- A1. 30" X 48" CLEAR FOR WHEELCHAIR ACCESS.
- A2. 60" DIAMETER CLEAR FOR WHEELCHAIR ACCESS.
- A3. POS, HAND-OFF PLANE AND WASTE & RECYLING CART COUNTERTOP ARE 2'-10" (MAX.) AFF FOR WHEELCHAIR ACCESSIBILITY.
- A4. ALL THRESHOLDS TO BE ADA COMPLIANT PER ALL APPLICABLE CODES.
- A5. ADA TABLE TOPS SHALL BE 28" MINIMUM AND 34" MAXIMUM IN HEIGHT ABOVE THE FLOOR. KNEE CLEARANCE SHALL BE A MINIMUM OF 27" IN HEIGHT ABOVE THE FLOOR AND 30" MINIMUM IN WIDTH.
- A6. BARRIER FREE PATH OF TRAVEL.
- A7. ADA MANEUVERING CLEARANCE AT DOORS; FRONT APPROACH, PUSH SIDE, DOOR PROVIDED WITH CLOSER: 48"MIN. BY 48" MIN.
- A8. ADA MANEUVERING CLEARANCE AT DOORS; FRONT APPROACH, PULL SIDE, DOOR PROVIDED WITH CLOSER: 54"MIN. BY 60" MIN.
- A9. HAND SINKS AND LAVATORIES TO BE 2'-10" AFF AND 30" X 48" CLEAR FOR WHEELCHAIR ACCESSIBILITY.
- A10. ADA MANEUVERING CLEARANCE AT DOORS; LATCH SIDE APPROACH, PUSH SIDE, DOOR PROVIDED WITH CLOSER: 48"MIN. BY 66" MIN.
- A11. ADA MANEUVERING CLEARANCE AT DOORS; FRONT APPROACH, PULL SIDE, DOOR PROVIDED WITH CLOSER: 60" MIN. BY 60" MIN.

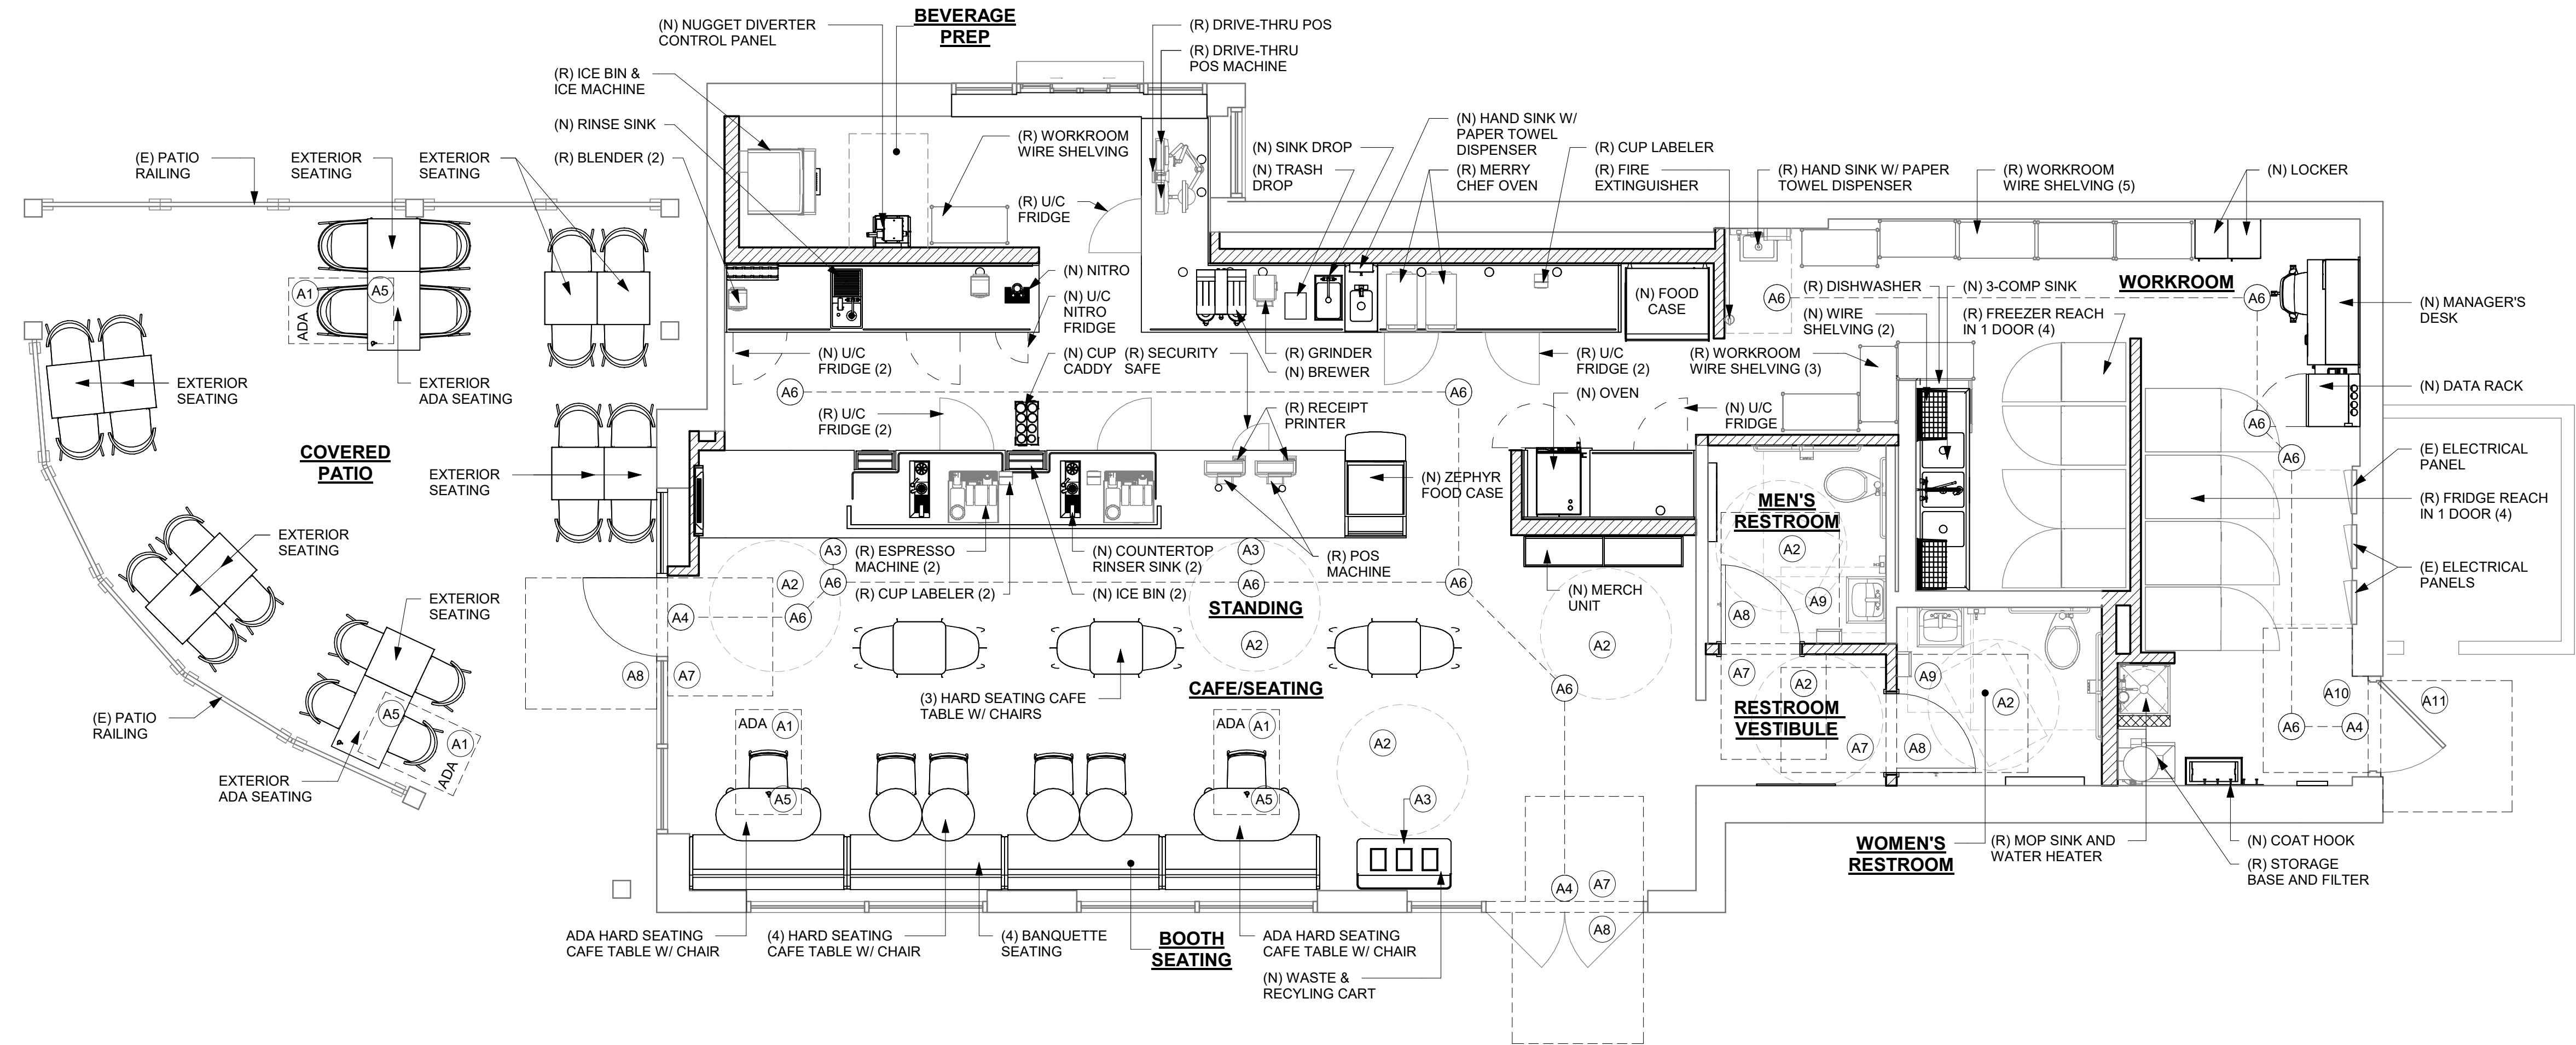

1 FOOD SERVICE PLAN
Scale: 1/4" = 1'-0"

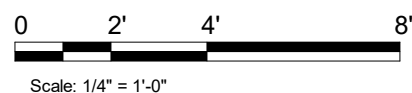

FOR CONSTRUCTION



© 2023 STARBUCKS COFFEE COMPANY

STARBUCKS®
2401 UTAH AVENUE SOUTH
SEATTLE, WASHINGTON 98134
(206) 318-1575

THESE DRAWINGS AND THE PROJECT MANUAL ARE CONFIDENTIAL AND SHALL REMAIN THE SOLE PROPERTY OF STARBUCKS CORPORATION, WHICH IS THE OWNER OF THE COPYRIGHT IN THIS WORK. THEY SHALL NOT BE REPRODUCED IN WHOLE OR IN PART, SHARED WITH THIRD PARTIES OR USED IN ANY MANNER ON OTHER PROJECTS OR EXTENSIONS TO THIS PROJECT WITHOUT THE PRIOR WRITTEN CONSENT OF STARBUCKS CORPORATION. THESE DRAWINGS AND SPECIFICATIONS ARE INTENDED TO EXPRESS DESIGN INTENT FOR A PROTOTYPICAL STARBUCKS STORE (WHICH IS SUBJECT TO CHANGE AT ANYTIME) AND DO NOT REFLECT ACTUAL SITE CONDITIONS. NEITHER PARTY SHALL HAVE ANY OBLIGATION NOR LIABILITY TO THE OTHER (EXCEPT STATED ABOVE) UNTIL A WRITTEN AGREEMENT IS FULLY EXECUTED BY BOTH PARTIES.

STARBUCKS TEMPLATE VERSION: i2023.10.23

Design Forum Architects Inc.

2050 Byers Rd
Miami, OH 45342
Tel: (844) 804-7700

Donald J. Reithman
Architect In Charge
License: AR0017303



2230 PARK AVE, STE. 100, CINCINNATI, OH 45206
513.457.7131 - WWW.MARQUEENG.COM

PROJECT NAME:
S SEMORAN BLVD & LEE VISTA BLVD

PROJECT ADDRESS:
**6605 S SEMORAN BLVD
ORLANDO, FL 32822**

STORE #: 9875
PROJECT #: 25630-101
ISSUE DATE: 03/04/2024
DESIGN MANAGER: MARTIN PEREZ
PRODUCTION DESIGNER: ANDY MCLOUD
CHECKED BY: DONALD RETHMAN

Revision Schedule			
Rev	Date	By	Description

SHEET TITLE:
FOOD SERVICE PLAN

SCALE: 1/4" = 1'-0"

SHEET NUMBER:
G-004

PRE-APPROVED LIST FOR
LOW EMMITING MATERIALS

MANUFACTURER - PRODUCT VOC CONTENT		
WATERPROOFING SEALERS		
LIMIT 250 g/L		
ADVANCED FLOOR PRODUCTS - RETROGUARD	100 g/L	
AMERIPOLISH - PROGUARD STAIN SHIELD	<50 g/L	
DEVOE - WATERBORNE EPOXY	200 g/L	
H&C - CONCRETE SEALER	250 g/L	
MAPEI - MAPELASTIC AQUADefENSE	0 g/L	
SCOFIELD - FORMULA ONE	0 g/L	
SCOFIELD - FORMULA ONE FINISH COAT	0 g/L	
SCOFIELD - FORMULA ONE GUARD-W	<100 g/L	
SCOFIELD - FORUMLA ONE DYE	10.7 g/L	
SCOFIELD - FORUMLA ONE LITHIUM DENSIFIER	0 g/L	
SEALSOURCE - KROMAPOLISH	0 g/L	
STAINS		
LIMIT 250 g/L		
H&C - CONCRETE STAIN	246 g/L	
AMERIPOLISH - COLOR JUICE COATING	0 g/L	
DALYS - WOODBORNE WOOD STAIN	<50 g/L	
CARPET		
INTERFACEFLOR - GLP	CRI GREEN LABEL	
INTERFACEFLOR - SOFTSISAL	CRI GREEN LABEL	
LEES CARPET TILE - GROUND STRATA MODULAR	CRI GREEN LABEL	
SHAW INDUSTRIES - VIBE	CRI GREEN LABEL	


PRE-APPROVED LIST FOR
LOW EMMITING MATERIALS

MANUFACTURER - PRODUCT VOC CONTENT		
HARD SURFACE FLOORING		
NON-ORGANIC GLAZED TILE - GENERIC (ALL NON-ORGANIC, GLAZED TILE COMPLIES)	N/A	
ALTRO LTD - STRONGHOLD 30	FLOORSCORE	
ALTRO LTD - AQUARIUS	FLOORSCORE	
ALTRO LTD - ATLAS 40	FLOORSCORE	
ALTRO LTD - CONTRAX	FLOORSCORE	
ALTRO LTD - DESIGNER 25	FLOORSCORE	
ALTRO LTD - IMPRESSIONIST II	FLOORSCORE	
ALTRO LTD - MARINE 20	FLOORSCORE	
ALTRO LTD - MAXIS 25	FLOORSCORE	
ALTRO LTD - MIRICA	FLOORSCORE	
ALTRO LTD - SUPREMA II	FLOORSCORE	
ALTRO LTD - TIMBERSAFE II	FLOORSCORE	
ALTRO LTD - WALKWAY 20	FLOORSCORE	
ALTRO LTD - WALKWAY 20D	FLOORSCORE	
ALTRO LTD - XPRESSLAY	FLOORSCORE	
CROSSVILLE INC - AMERCANO	FLOORSCORE	
CROSSVILLE INC - BLUESTONE	FLOORSCORE	
CROSSVILLE INC - BUILDING BLOX	FLOORSCORE	
CROSSVILLE INC - CLASSIC MOSAICS	FLOORSCORE	
CROSSVILLE INC - COLOR BLOX EC	FLOORSCORE	
CROSSVILLE INC - COLOR BLOX MOSAICS	FLOORSCORE	
CROSSVILLE INC - COLOR BLOX TOO	FLOORSCORE	
CROSSVILLE INC - COTTO AMERICANA	FLOORSCORE	
CROSSVILLE INC - CROSS COLORS	FLOORSCORE	
CROSSVILLE INC - CROSS COLORS LP	FLOORSCORE	
CROSSVILLE INC - ECOCYCLE	FLOORSCORE	
CROSSVILLE INC - MAIN STREET	FLOORSCORE	
CROSSVILLE INC - PALAIS	FLOORSCORE	
CROSSVILLE INC - POMPEII	FLOORSCORE	
CROSSVILLE INC - RETRO ACTIVE	FLOORSCORE	
CROSSVILLE INC - STRUCTURE	FLOORSCORE	
CROSSVILLE INC - TEXTURES	FLOORSCORE	
CROSSVILLE INC - TUSCAN CLAY	FLOORSCORE	
CROSSVILLE INC - ULTIMETAL	FLOORSCORE	
CROSSVILLE INC - VISTA AMERICANA	FLOORSCORE	
CROSSVILLE INC - WEATHERSTONE	FLOORSCORE	
CROSSVILLE INC - WOOD IMPRESSIONS	FLOORSCORE	

PRE-APPROVED LIST FOR
LOW EMMITING MATERIALS

MANUFACTURER - PRODUCT VOC CONTENT		
COMPOSITE WOOD		
NO ADDED UREA-FORMALDEHYDE		
ANY - APA RATED STRUCTURAL PLYWOOD (EXPOSURE 1 OR EXTERIOR)	YES	
COLUMBIA FOREST PRODUCTS - EUROPLY PLUS	YES	
COLUMBIA FOREST PRODUCTS - PUREBOND	YES	
EGGERS INDUSTRIES - 206 5-PLY	YES	
GLASTEEL - GLASLINER - FRP	YES	
GRAHAM WOOD DOORS - GPD-45 5-PLY AGRIFIBER	YES	
GRAHAM WOOD DOORS - GPD-AP 5-PLY AGRIFIBER	YES	
GRAHAM WOOD DOORS - GPD-EC 5-PLY ENGINEERED COMPOSITE	YES	
GRAHAM WOOD DOORS - GPD-SL 5-PLY STAVE LUMBER	YES	
LYDEN DOORS - CD200 NAUF PARTICLEBOARD CORE	YES	
LYDEN DOORS - CD250 AGFIBER CORE	YES	
LYDEN DOORS - CD300 NAUF STAVE LUMBER CORE	YES	
LYDEN DOORS - CD350 STRUCTURAL COMPOSITE CORE	YES	
MARSHFIELD - ENVIRONMENTAL CLASS	YES	
NAUF - COMPOSITE WOOD DOOR	YES	
ROSEBURG - COMPOSITE WOOD PANTLS	YES	
SIERRA PINE - ARREIS	YES	
SIERRA PINE - MEDEX	YES	
SIERRA PINE - MEDITE FR	YES	
SIERRA PINE - MEDITE II	YES	
SIERRA PINE - PERMACORE	YES	
GYPSUM BOARD		
AMERICAN GYPSUM - FIREBLOCK	GREENGUARD GOLD	
GEORGIA PACIFIC - TOUGHROCK FIREGUARD	GREENGUARD GOLD	
LAFARGE - FIRECHECK	GREENGUARD GOLD	
NATIONAL GYPSUM - GOLD BOND FIRESHIELD	GREENGUARD GOLD	
CERTAINTED - PROROC TYPE X	CHPS	
USG - SHEETROCK FIRECODE	CHPS	
GEORGIA PACIFIC - TOUGHROCK GYPSUM BOARD	GREENGUARD GOLD	
SMDS - DENSARMOR PLUS	GREENGUARD GOLD	
ACOUSTICAL CEILING SYSTEM		
ARMSTRONG - CERAMAGUARD	CHPS	
ARMSTRONG - FINE FISSURED	CHPS	
ARMSTRONG - CLEANROOM VL	CHPS	
ARMSTRONG - CORTEGA	CDPH/EHLB	
ARMSTRONG - CLEANROOM	CDPH/EHLB	
CRANE - SEQUENTIA LAMINATED PANELS	GREENGUARD	
ARMSTRONG - METALWORKS	CHPS	
USG- RADAR	CHPS/CDPH/EHLB	
USG - SHEETROCK	CA/DHS/EHLB	
WALL COVERINGS		
CERTAINTED - DIAMONDBACK TILE BACKER	GREENGUARD GOLD	
COLUMBIA FOREST PRODUCTS - EUROPLY PLUS	NAUF	
COLUMBIA FOREST PRODUCTS - PUREBOND	NAUF	
CRANE COMPOSITES - GLASBORD FRP	GREENGUARD GOLD	
DAL-TILE - CERAMIC WALL TILE	CHPS	
GEORGIA PACIFIC - DENSSHIELD TILE BACKER BOARD	CHPS	
GLASTEEL - GLASLINER FRP	GREENGUARD GOLD	
MARLITE - FRP	GREENGUARD	
NATIONAL GYPSUM - EZXP TILE BACKER	GREENGUARD GOLD	
OMNOVA - ECORE	GREENGUARD GOLD	
PANOLAM INDUSTRIES - PANOLAM FRP	GREENGUARD GOLD	
PARKLAND PLASTICS - PLASTEX NRP	GREENGUARD GOLD	
SEQUENTIA - EMBOSSED TEXTURE	GREENGUARD	

FOR CONSTRUCTION




© 2023 STARBUCKS COFFEE COMPANY

STARBUCKS®
2401 UTAH AVENUE SOUTH
SEATTLE, WASHINGTON 98134
(206) 318-1575

THESE DRAWINGS AND THE PROJECT MANUAL ARE CONFIDENTIAL AND SHALL REMAIN THE SOLE PROPERTY OF STARBUCKS CORPORATION, WHICH IS THE OWNER OF THE COPYRIGHT IN THIS WORK. THEY SHALL NOT BE REPRODUCED IN WHOLE OR IN PART, SHARED WITH THIRD PARTIES OR USED IN ANY MANNER ON OTHER PROJECTS OR EXTENSIONS TO THIS PROJECT WITHOUT THE PRIOR WRITTEN CONSENT OF STARBUCKS CORPORATION. THESE DRAWINGS AND SPECIFICATIONS ARE INTENDED TO EXPRESS DESIGN INTENT FOR A PROTOTYPICAL STARBUCKS STORE (WHICH IS SUBJECT TO CHANGE AT ANYTIME) AND DO NOT REFLECT ACTUAL SITE CONDITIONS. NEITHER PARTY SHALL HAVE ANY OBLIGATION NOR LIABILITY TO THE OTHER (EXCEPT STATED ABOVE) UNTIL A WRITTEN AGREEMENT IS FULLY EXECUTED BY BOTH PARTIES.

STARBUCKS TEMPLATE VERSION: i2023.10.23

Design Forum Architects Inc.
2050 Byers Rd
Miami, FL 33136
Tel: (305) 844-7700
Donald J. Reithman
Architect in Charge
License: AR0017303

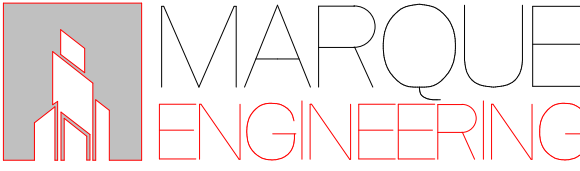
2230 PARK AVE, STE. 100, CINCINNATI, OH 45206
513.457.7131 - WWW.MARQUEENG.COM

PROJECT NAME:
S SEMORAN BLVD & LEE VISTA BLVD

PROJECT ADDRESS:
**6605 S SEMORAN BLVD
ORLANDO, FL 32822**

STORE #: 9875
PROJECT #: 25630-101
ISSUE DATE: 03/04/2024
DESIGN MANAGER: MARTIN PEREZ
PRODUCTION DESIGNER: ANDY MCLOUD
CHECKED BY: DONALD RETHMAN

Revision Schedule			
Rev	Date	By	Description

SHEET TITLE:
PRE-APPROVED CONST. MATERIALS
SCALE: NO SCALE

SHEET NUMBER:
G-006

\\file-day.ad.changeupinc.com\Client\StarbucksArchitecture\Projects_2023\Florida\Semorran & Lee Vista -25630-10\125630-101_9875_S Semoran Blvd & Lee Vista Blvd, FL_2023.rvt 3/4/2024 2:39:00 PM

ITEMS TO DEMOLISH

- FRONT BAR

- COUNTERTOPS

- UNDERCOUNTER CABINETS

- DIEWALL

- FINISH PANELS

- PASTRY CASE

- PASTRY TRAY CART

- TILE BASE

- FLOORING

- TRASH CAN / BIN (3)
- BACKBAR

- UNDERCOUNTER CABINETS

- COUNTERTOPS

- MENU BOARDS

- UPPER CUBBIES

- WALL FINISH

- TILE BASE

- FLOORING

- SHUTTLES (2)

- BREWER

- CUP DISPENSER (1)
- SIDELINE

- COUNTERTOPS

- UNDERCOUNTER CABINETS

- NITRO EQUIPMENT

- TILE BASE

- FLOORING

- DIEWALL

- FINISH PANELS

- 2-DOOR UNDERCOUNTER REFRIGERATOR (1)
- CAFE

- MERCH BAYS (2)

- FURNITURE

- WALK-OFF MAT (2)

- ARTWORKS

- CHAIR RAIL AND WAINSCOT

- WALL FINISH

- FLOORING

- TILE BASE

- CONDIMENT CART (1)
- WORKROOM

- FLOORING

- TILE BASE

- DATA RACK AND DATA DEVICES

- MANAGERS DESK AND SHELVING

- MANAGER'S CHAIR

- TRASH CAN / BIN (1)

- FURNITURE

- THAW RACK

- 3-COMP SINK
- PATIO

- FURNITURE
- RESTROOMS

- TRASH BIN (2)

- WALL FINISH

- WALL SCONCE (2)

- MIRROR (2)

- DOOR (2)
- RESTROOMS VESTIBULE

- CHAIR RAIL AND WAINSCOT

- RESTROOM SIGNAGE

- TILE BASE

- WALL FINISH

- FLOORING

- RESTROOM SIGNAGE

- ARTWORK

ITEMS TO PRESERVE

- FRONT BAR

- POS EQUIPMENT

- CUP LABELER (2)

- ESPRESSO MACHINE (MASTRENA) (2)

- SECURITY SAFE WITH BASE
- BACKBAR

- 1-DOOR UNDERCOUNTER REFRIGERATOR (3)

- GRINDER

- CUP LABELER (1)

- WARMING OVENS (2)

- DT POS EQUIPMENT
- SIDELINE

- BLENDER (2)

- CUP LABELER (1)
- WORKROOM

- METRO RACK (9)

- METRO RACK (1-RELOCATED TO ANOTHER STORE)

- 1-DOOR REFRIGERATOR (4)

- 1-DOOR FREEZER (4)

- 1-DOOR FREEZER (1-RELOCATED TO ANOTHER STORE)

- FIRE EXTINGUISHER (1)

- DISHWASHER

- WATER FILTRATION SYSTEM

- MOP SINK

- WATER HEATER

- ELECTRICAL PANEL (3)

- HAND SINK

- ICE-MACHINE (RELOCATED TO ANOTHER STORE)

- STOREFRONT DOOR (RELOCATED)
- BOH SERVICE DOOR

- TRASH BIN/CAN (3)
- RESTROOMS

- TOILETS (2)

- HORIZONTAL GRAB BARS (4)

- VERTICAL GRAB BARS (2)

- TOILET PAPER HOLDERS (2)

- SEAT COVER DISPENSER (2)

- WALL MOUNTED SINK (2)

- SOAP DISPENSER (2)

- WALL MOUNTED SOAP DISPENSER (2)

- MIRROR (2)

- HAND DRYER (2)

- COAT HOOKS (2)
- PATIO

- RAILING

KEYED NOTES

1. EXISTING OUTDOOR FURNITURE TO BE REMOVED. UON. COORDINATE WITH STARBUCKS CM FOR DISPOSAL OF FURNITURE FROM SITE.

2. EXISTING PATIO RAILING TO REMAIN.

3. EXISTING STOREFRONT DOOR / WINDOW TO REMAIN. GC TO CLEAN AND REPLACE SEALS AS REQUIRED.

4. EXISTING STOREFRONT DOOR / WINDOW TO BE REMOVED. INFILL OPENING TO RECEIVE NEW STOREFRONT DOOR / WINDOW SYSTEM. GC TO CLEAN AND REPLACE SEALS AS REQUIRED.

5. ALL EXISTING CAFE FURNITURE AND FIXTURES TO BE REMOVED, UON. COORDINATE WITH STARBUCKS CM FOR DISPOSAL OF FURNITURE FROM SITE.

6. EXISTING CHAIR RAIL AND WAINSCOT TO BE REMOVED AS PER NEW SCOPE OF WORK. REPAIR AREA TO RECEIVE NEW FINISH.

7. EXISTING ARTWORK, COMMUNITY BOARD AND ANY MURAL GRAPHICS TO BE REMOVED.

8. REMOVE INTERIOR WALL FINISH AS SHOWN. PATCH, REPAIR AND PREP. SUBSTRATE TO RECEIVE NEW FINISH.

9. EXISTING FLOORING AND TILE BASE TO BE REMOVED. PATCH, REPAIR AND PREP. SUBSTRATE TO RECEIVE NEW FINISH.

10. EXISTING WALK-OFF MAT TO BE REMOVED. PREPARE SUBSTRATE FOR NEW WORK.

11. EXISTING CONDIMENT CART TO BE REMOVED. COORDINATE WITH STARBUCKS CM FOR DISPOSAL.

12. REMOVE INTERIOR PARTITION WALL FROM FLOOR TO UNDERSIDE OF STRUCTURE. PATCH AND REPAIR ADJACENT WALLS AS REQUIRED.

13. EXISTING TRASH BIN / TRASH CAN TO BE REMOVED.

14. EXISTING MERCH BAYS TO BE REMOVED.

15. EXISTING MENU BOARDS AND UPPER CUBBIES TO BE REMOVED.

16. GC TO SAWCUT FLOOR AS REQUIRED FOR INSTALLATION OF NEW PLUMBING. COORDINATE WITH PLUMBING DRAWINGS.

17. REMOVE EXISTING CASEWORK, HANGING DEVICES, FASTENERS AND BASE CABINETS BELOW AS SHOWN. REMOVE ASSOCIATED ELECTRICAL AND DATA LINES, CAP EXISTING PLUMBING, UON.

18. EXISTING PASTRY CASE AND PASTRY TRAY CART TO BE REMOVED.

19. EXISTING POS EQUIPMENT TO BE RELOCATED PER FF&E PLAN.

20. EXISTING UNDERCOUNTER SECURITY SAFE AND BASE TO BE RELOCATED PER FF&E PLAN.

21. EXISTING MASTRENAS TO BE RELOCATED PER FF&E PLAN.

22. EXISTING CUP LABELERS TO BE RELOCATED PER FF&E PLAN.

23. EXISTING 1-DOOR UNDERCOUNTER REFRIGERATOR TO BE RELOCATED PER FF&E PLAN.

24. EXISTING 2-DOOR UNDERCOUNTER REFRIGERATOR TO BE REMOVED.

25. EXISTING FLOOR SINK / DRAIN / CLEAN OUT TO BE REMOVED AND CAPPED. PATCH AND REPAIR FLOOR TO RECEIVE SCHEDULED FINISHES.

26. EXISTING BLENDERS TO BE RELOCATED PER FF&E PLAN.

27. EXISTING NITRO EQUIPMENT TO BE REMOVED.

28. EXISTING INTERIOR DOOR AND FRAME TO BE REMOVED.

29. EXISTING CUP DISPENSERS TO BE REMOVED.

30. EXISTING DT WINDOW TO REMAIN.

31. EXISTING DT POS EQUIPMENT TO BE RELOCATED PER FF&E PLAN.

32. EXISTING BREWER AND SHUTTLES TO BE REMOVED.

33. EXISTING GRINDER TO BE RELOCATED PER FF&E PLAN.

34. EXISTING WARMING OVENS TO BE RELOCATED PER FF&E PLAN.

35. EXISTING FIRE EXTINGUISHER TO BE RELOCATED PER FF&E PLAN.

36. EXISTING LOCATION OF ALL SWITCHING AND THERMOSTAT TO BE RELOCATED PER FF&E PLAN.

37. EXISTING 1-DOOR REFRIGERATOR TO BE RELOCATED PER FF&E PLAN.

38. EXISTING METRO RACKS TO BE RELOCATED PER FF&E PLAN.

39. EXISTING 1-DOOR FREEZER AND METRO RACK TO BE RELOCATED TO ANOTHER STORE. GC TO COORDINATE WITH CONSTRUCTION MANAGER/ FACILITIES.

40. EXISTING THAW RACK TO BE REMOVED.

41. EXISTING ICE MACHINE TO BE RELOCATED PER FF&E PLAN. GC TO VERIFY THE EXISTING ICE MACHINE, BIN, BIN ADAPTTER AND ASSOCIATED EQUIPMENT PRIOR CONSTRUCTION AND COORDINATE WITH STARBUCKS CONSTRUCTION MANAGER AND PROJECT SPECIALIST TO VERIFY PROPER ICE MACHINE COMPONENTS ARE BEING PROVIDED.

42. EXISTING WALL FINISH TO REMAIN. PATCH AND REPAIR AS REQUIRED.

43. EXISTING 1-DOOR FREEZERS TO BE RELOCATED PER FF&E PLAN.

44. EXISTING ROOF LADDER TO REMAIN.

45. EXISTING MANAGER'S DESK, DATA DEVICES, DATA RACK AND CHAIR TO BE REMOVED.

46. EXISTING 3-COMP SINK TO BE REMOVED.

47. EXISTING DISHWASHER TO BE RELOCATED PER FF&E PLAN.

48. EXISTING SERVICE DOOR AND KEYPAD LOCK TO REMAIN.

49. EXISTING ELECTRICAL PANELS TO REMAIN.

50. EXISTING WORKROOM FURNITURE TO BE REMOVED.

51. EXISTING WORKROOM HAND SINK TO BE RELOCATED PER FF&E PLAN.

52. EXISTING WATER FILTRATION SYSTEM AND MOP SINK TO BE RELOCATED PER FF&E PLAN.

53. EXISTING RESTROOM PLUMBING FIXTURES / ACCESSORIES TO BE RELOCATED PER FF&E PLAN.

54. EXISTING RESTROOM SIGNAGE TO BE RELOCATED PER FF&E PLAN.

55. EXISTING COAT HOOK TO BE RELOCATED TO NEW DOOR PER FF&E PLAN.

56. EXISTING TRASH BIN / TRASH CAN TO REMAIN.

57. EXISTING FOLDABLE LADDER TO BE REMOVED.

58. EXISTING RESTROOM MIRROR TO BE REMOVED.

59. EXISTING PARTIAL HEIGHT UTILITY SCREEN TO REMAIN.

GENERAL NOTES

- A. IF DURING DEMOLITION CONDITIONS ARE REVEALED THAT MAY JEOPARDIZE INTEGRITY OF STRUCTURE OR PRECLUDE FOLLOWING DESIGN INTENT, GENERAL CONTRACTOR TO NOTIFY STARBUCKS CONSTRUCTION MANAGER IMMEDIATELY.

B. GENERAL CONTRACTOR IS RESPONSIBLE FOR SITE INVESTIGATION PRIOR TO DEMOLITION TO REVEAL FULL SCOPE OF WORK. NOTIFY STARBUCKS CONSTRUCTION MANAGER IF EXISTING CONDITIONS DEVIATE FROM CONSTRUCTION DOCUMENTS.

C. REMOVE WALL COVERINGS ON EXISTING WALLS TO REMAIN THAT FACE AREAS OF DEMOLITION. REMOVAL SHALL INCLUDE ANY RESIDUAL MATERIAL AFTER DEMOLITION, I.E. PIECES OF WALL COVERING OR BAKING. REMOVAL OF ALL COVERINGS IS TO BE DONE W/O DAMAGING THE EXISTING WALL SURFACE TO REMAIN. ALSO REMOVE WALL DEVICES AND ITEMS MOUNTED TO WALLS.

D. REMOVE ALL FLOOR MATERIALS INCLUSIVE OF SETTING BEDS, SUBFLOOR MATERIAL ETC. REMOVE MASTIC TO PROVIDE A CLEAN FLOOR THAT IS ACCEPTABLE TO THE SUBCONTRACTOR INSTALLING NEW FINISH MATERIAL.

E. DEMOLITION PLANS REPRESENT APPROXIMATE LOCATION OF EXISTING WALLS TO BE DEMOLISHED. FIELD VERIFY TYPE OF CONSTRUCTION AND HEIGHT OF WALLS. PLANS DO NOT NECESSARILY INDICATE ALL DEMO WALLS, COUNTERS, HANDRAILS, WALL PROTECTION, CLOSETS, SINKS ETC. PRIOR TO DEMOLITION, FIELD VERIFY THAT WALLS TO BE REMOVED DO NOT PROVIDE SUPPORT FOR EXISTING BUILDING ELEMENTS AND EXISTING CONSTRUCTION TO REMAIN. NOTIFY STARBUCKS CONSTRUCTION MANAGER IF DEMOLITION WALLS SUPPORT EXISTING BUILDING ELEMENTS.

F. DEMOLISH AND REMOVE DOORS, VINYL BASE, CONDUIT, WIRING, DUPLEXES, DATA OUTLETS, CABLES, SHELVING, METAL STUD AND GYPSUM BOARD WALLS, CLOSETS, CABINETS, ETC. COUNTERS, WOOD MOLDING, SHELVES AND ENCLOSURES WHERE APPLICABLE.

G. VERIFY WITH STARBUCKS CONSTRUCTION MANAGER ACCESS TO THE DEMOLITION AREA, INGRESS AND EGRESS ROUTES FOR MATERIAL AND EQUIPMENT.

H. PROTECT EXISTING FLOORS, WALLS AND CORNERS TO REMAIN ALONG WORK ACCESS ROUTES.

I. CONTAIN DUST AND DEBRIS WITHIN THE DEMOLITION AREA.

J. THE GENERAL CONTRACTOR SHALL PERFORM WORK IN A MANNER THAT DOES NOT DAMAGE THE EXISTING STRUCTURE. DEMOLITION SHALL NOT COMPROMISE THE STRUCTURAL INTEGRITY OF ANY WALLS, FLOORS, CEILINGS, SUPPORTS, STRUCTURE, ETC. TO REMAIN.

K. ALL DEMOLITION MATERIALS AND DEBRIS SHALL BE DISPOSED OF ACCORDING TO FEDERAL, STATE AND LOCAL REGULATIONS.

L. AT LOCATIONS WHERE EXISTING WALLS ARE TO BE REMOVED NEAR EXISTING WALLS TO REMAIN, PERFORM DEMOLITION WITHOUT DISTURBING EXISTING ELEMENTS TO REMAIN. WALLS TO REMAIN SHALL BE INTACT AND HAVE A NEAT SURFACE.

M. REFER TO "ITEMS TO BE PRESERVED" LIST FOR ITEMS THAT SHALL BE SALVAGED FOR RELOCATION. VERIFY WITH OWNER FOR ON SITE STORAGE LOCATION OF SALVAGED ITEMS.

N. DAMAGED FIREPROOFING SHALL BE REPAIRED/ REPLACED TO MATCH EXISTING.


O. THE GENERAL CONTRACTOR SHALL DEMOLISH ANY EXISTING ABANDONED VOICE/DATA CABLING AND DEAD OR NON-USE ELECTRICAL BACK TO PANEL. ALL RECEPTACLES NOT REUSED ARE TO BE REMOVED, PATCHED AND PAINTED.

P. REMOVAL OF LOW VOLTAGE EQUIPMENT, PERTAINING TO DATA/COMMUNICATIONS AND TELEPHONE SHALL BE VERIFIED BY THE STARBUCKS CONSTRUCTION MANAGER PRIOR TO REMOVAL. SALVAGED EQUIPMENT SHALL BE STORED IN A CLIMATE CONTROLLED ENVIRONMENT FOR FUTURE INSTALLATION.

Q. LABEL ALL ITEMS AND PROPERLY STORE FOR RE-INSTALL.


LEGEND

- ITEMS TO BE DEMOLISHED
- ITEMS TO BE RELOCATED WITHIN THE SAME SITE
- EXISTING WALL / ITEMS TO REMAIN

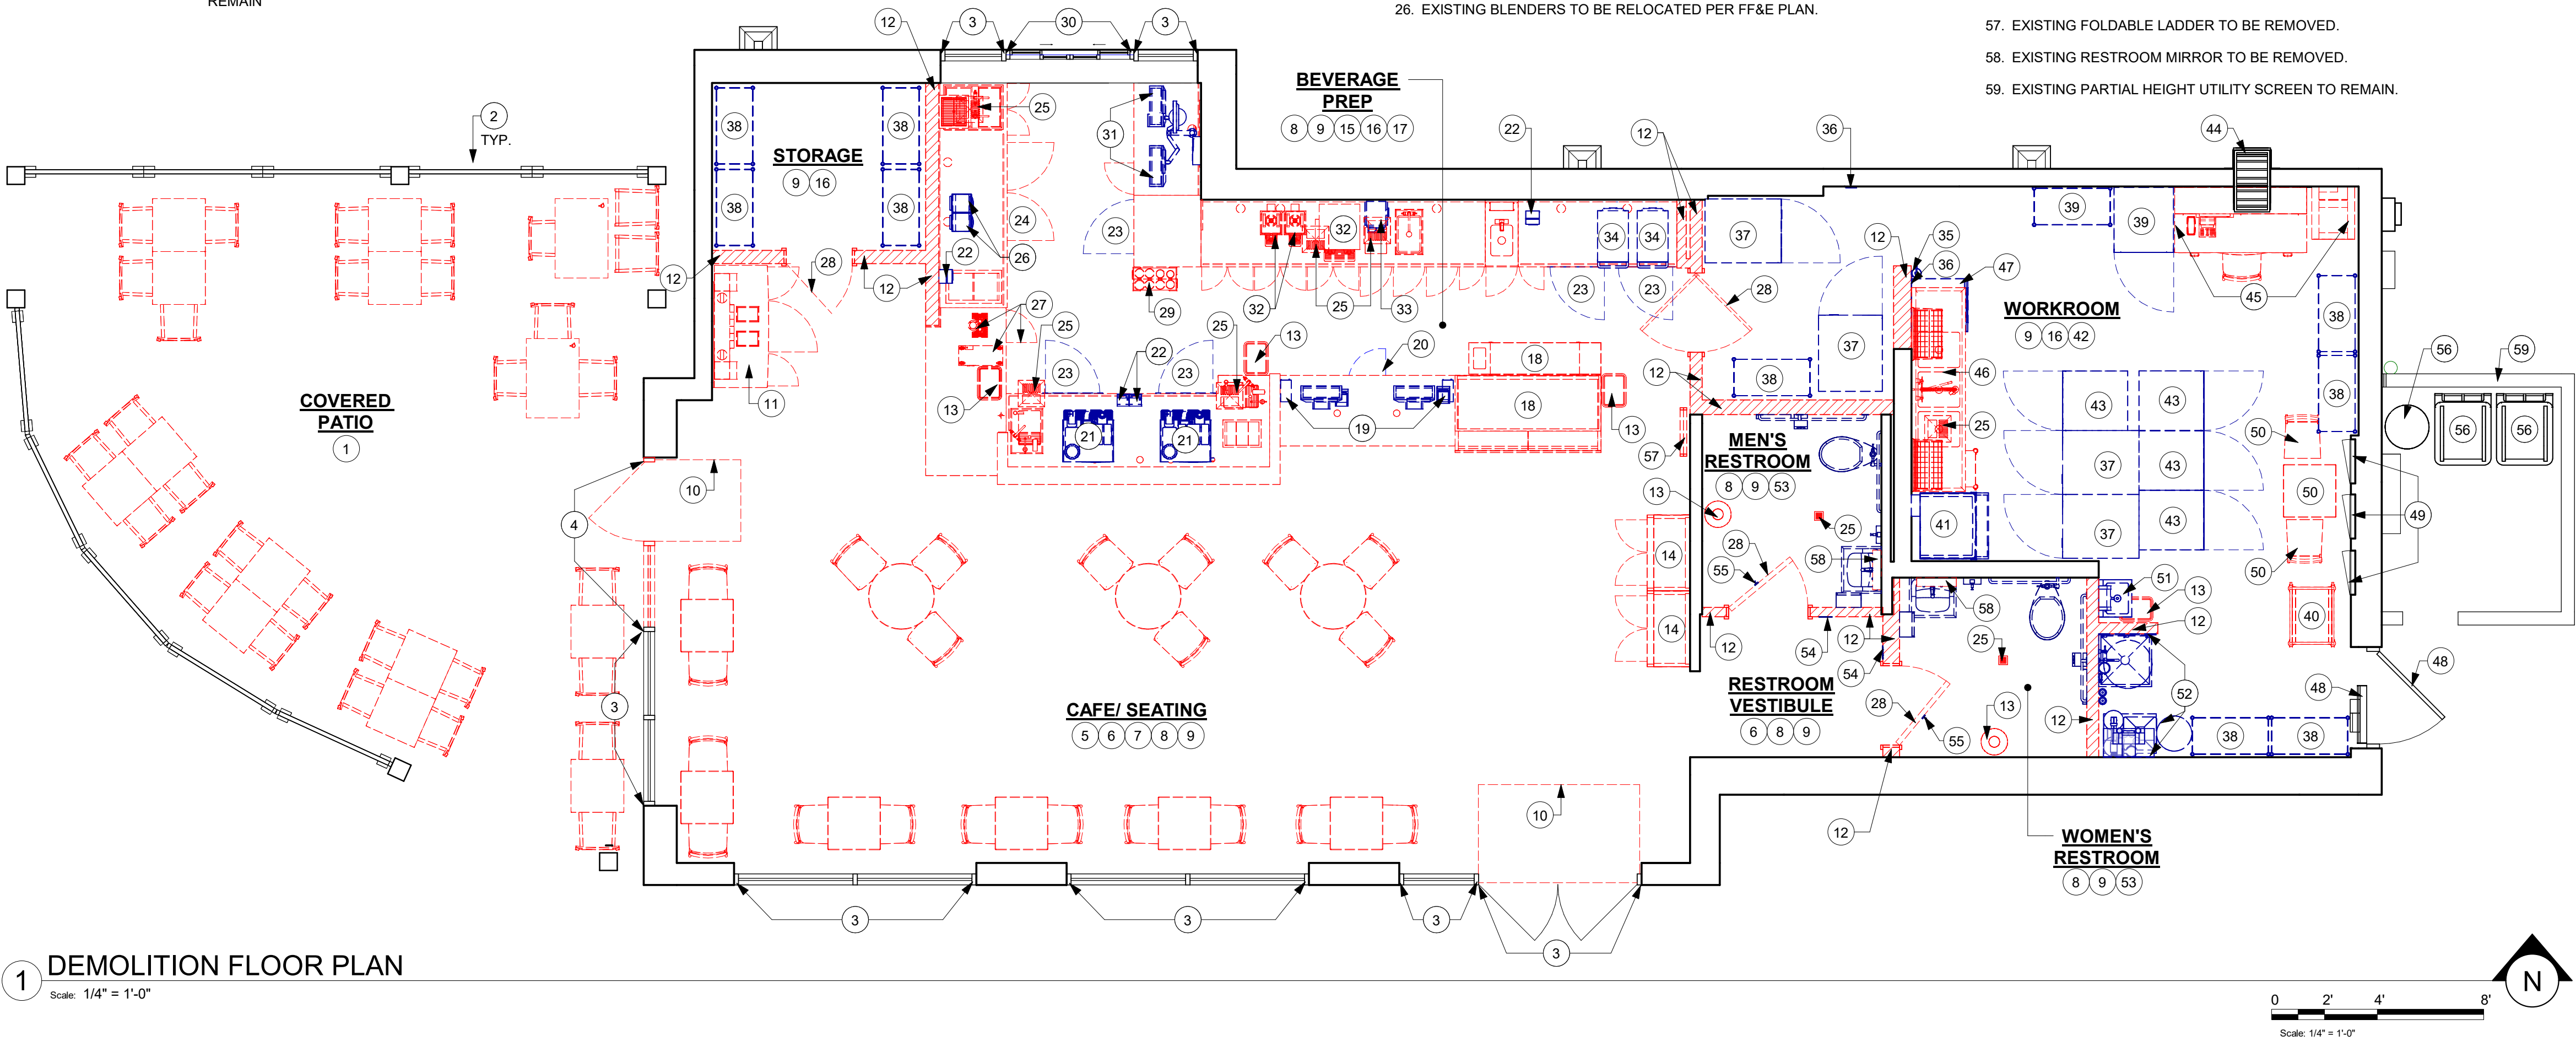

1 DEMOLITION FLOOR PLAN

FOR CONSTRUCTION



© 2023 STARBUCKS COFFEE COMPANY

STARBUCKS®

2401 UTAH AVENUE SOUTH
SEATTLE, WASHINGTON 98134
(206) 318-1575


THESE DRAWINGS AND THE PROJECT MANUAL ARE CONFIDENTIAL AND SHALL REMAIN THE SOLE PROPERTY OF STARBUCKS CORPORATION, WHICH IS THE OWNER OF THE COPYRIGHT IN THIS WORK. THEY SHALL NOT BE REPRODUCED IN WHOLE OR IN PART, SHARED WITH THIRD PARTIES OR USED IN ANY MANNER ON OTHER PROJECTS OR EXTENSIONS TO THIS PROJECT WITHOUT THE PRIOR WRITTEN CONSENT OF STARBUCKS CORPORATION. THESE DRAWINGS AND SPECIFICATIONS ARE INTENDED TO EXPRESS DESIGN INTENT FOR A PROTOTYPICAL STARBUCKS STORE (WHICH IS SUBJECT TO CHANGE AT ANYTIME) AND DO NOT REFLECT ACTUAL SITE CONDITIONS. NEITHER PARTY SHALL HAVE ANY OBLIGATION NOR LIABILITY TO THE OTHER (EXCEPT STATED ABOVE) UNTIL A WRITTEN AGREEMENT IS FULLY EXECUTED BY BOTH PARTIES.

STARBUCKS TEMPLATE VERSION: i2023.10.23

Design Forum
Architects Inc.

2050 Byers Rd
Miamiburg, OH 45342
Tel: (844) 804-7700

Donald J. Rethman
Architect In Charge
License: AR0017303



2230 PARK AVE, STE. 100, CINCINNATI, OH 45206
513.457.7131 - WWW.MARQUEENG.COM

PROJECT NAME:
S SEMORAN BLVD &
LEE VISTA BLVD

PROJECT ADDRESS:
6605 S SEMORAN BLVD
ORLANDO, FL 32822

STORE #: 9875

PROJECT #: 25630-101

ISSUE DATE: 03/04/2024

DESIGN MANAGER: MARTIN PEREZ

PRODUCTION DESIGNER: ANDY MCLOUD

CHECKED BY: DONALD RETHMAN

Revision Schedule

Rev	Date	By	Description

SHEET TITLE:
DEMOLITION FLOOR
PLAN

SCALE: 1/4" = 1'-0"

SHEET NUMBER:
D-101

\\file-day.ad.changeupinc.com\Client\StarbucksArchitecture\Projects_2023\Florida\Semoran & Lee Vista -25630-101\25630-101_9875_S Semoran Blvd & Lee Vista Blvd, FL_2023.rvt 3/4/2024 2:39:02 PM

CEILING DEMOLITION LEGEND


- EXISTING MATERIAL TO BE DEMOLISHED
- EXISTING MATERIALS TO BE RELOCATED WITH IN THE SAME SITE
- EXISTING MATERIALS TO REMAIN
- PORTION OF EXISTING ACT CEILING TO BE REMOVED

GENERAL NOTES

- IF DURING DEMOLITION CONDITIONS ARE REVEALED THAT MAY JEOPARDIZE INTEGRITY OF STRUCTURE OR PRECLUDE FOLLOWING DESIGN INTENT, GENERAL CONTRACTOR TO NOTIFY STARBUCKS CONSTRUCTION MANAGER IMMEDIATELY.
- REMOVE EXTRANEIOUS EQUIPMENT AS NECESSARY.
- DEMOLISH AND REMOVE SUSPENDED ACOUSTIC LAY-IN, SPLINE OR GYPSUM/ PLASTER CEILING INCLUSIVE OF HANGERS AND CARRYING CHANNELS, WIRES, CABLES, CONDUIT, ADHERED CEILING TILES, FLEX CONDUIT, ELECTRICAL BOXES, SMOKE DETECTORS, LIGHT FIXTURES AND WIRING, DUCT WORK, PIPING AND SUPPORT HANGERS, CUT HANGERS FLUSH. SPACES RECEIVING WALL DEMOLITION WILL ALSO HAVE CEILING DEMOLITION UNLESS OTHERWISE NOTED.
- REMOVAL OF LOW VOLTAGE EQUIPMENT, PERTAINING TO DATA/ COMMUNICATIONS AND TELEPHONE SHALL BE VERIFIED BY STARBUCKS CONSTRUCTION MANAGER PRIOR TO REMOVAL. SALVAGED EQUIPMENT SHALL BE STORED IN A CLIMATE CONTROLLED ENVIRONMENT FOR FUTURE INSTALLATION.
- EXISTING SPRINKLERS TO REMAIN OPERATIONAL DURING CONSTRUCTION.


KEYED NOTES

- EXISTING DT AIR CURTAIN TO REMAIN.
- EXISTING 2' X 2' ACT CEILING TO BE REMOVED. PATCH AND REPAIR CEILING AS REQUIRED FOR NEW WORK.
- EXISTING GYPSUM BOARD CEILING TO REMAIN, U.O.N. PATCH AND REPAIR CEILING AS REQUIRED FOR NEW WORK.
- EXISTING 2' X 4' ACT CEILING TO BE REMOVED. PATCH AND REPAIR CEILING AS REQUIRED FOR NEW WORK.
- EXISTING GYPSUM BOARD SOFFIT / CEILING TO BE REMOVED, U.O.N. PATCH AND REPAIR CEILING AS REQUIRED FOR NEW WORK.
- EXISTING WATER HEATER PLATFORM TO BE REMOVED.
- EXISTING ACOUSTICAL PANEL TO BE RELOCATED.
- EXISTING HEADER TO BE REMOVED.
- EXISTING RECESSED CAN LIGHTS TO BE REMOVED.
- EXISTING TRACK LIGHTING TO BE REMOVED.
- EXISTING RECESSED TROFFER LIGHTS TO BE REMOVED.
- EXISTING RECESSED CAN LIGHTS TO REMAIN.
- EXISTING LARGE PENDANT LIGHTS TO BE REMOVED.
- EXISTING CAN PENDANT LIGHTS TO BE REMOVED.
- EXISTING EMERGENCY / EXIT LIGHTS TO BE REMOVED.
- EXISTING CEILING MOUNTED MOP SIGNAGE TO BE REMOVED.
- EXISTING HVAC DUCTWORK / SUPPLY / RETURN DIFFUSER GRILLES TO REMAIN, U.O.N.
- EXISTING HVAC SUPPLY / RETURN DIFFUSER GRILLES TO BE RELOCATED.
- EXISTING INTERIOR SECURITY CAMERA TO BE RELOCATED.
- EXISTING WIFI TO BE RELOCATED.
- EXISTING FIRE ALARM / STROBE TO BE RELOCATED.
- EXISTING FIRE ALARM / STROBE TO REMAIN.
- EXISTING ROLLER SHADES TO BE REMOVED.
- EXISTING INTERIOR WALL MOUNTED SPEAKERS TO BE REMOVED.
- EXISTING RESTROOM WALL SCONCES TO BE REMOVED.
- EXISTING HEADER TO REMAIN.
- EXISTING EXTERIOR WALL MOUNTED SPEAKER TO REMAIN.
- EXISTING EXTERIOR WALL MOUNTED SECURITY CAMERA TO REMAIN.
- EXISTING EXTERIOR SECURITY LIGHT TO REMAIN.
- EXISTING EXTERIOR BUILDING SIGNAGE TO REMAIN.
- EXISTING EXTERIOR WALL SCONCE TO REMAIN.
- EXISTING EXTERIOR AWNING TO REMAIN.
- EXISTING PATIO WOOD TRELIS TO REMAIN.
- EXISTING WALL MOUNTED HVAC GRILLE TO BE REMOVED.

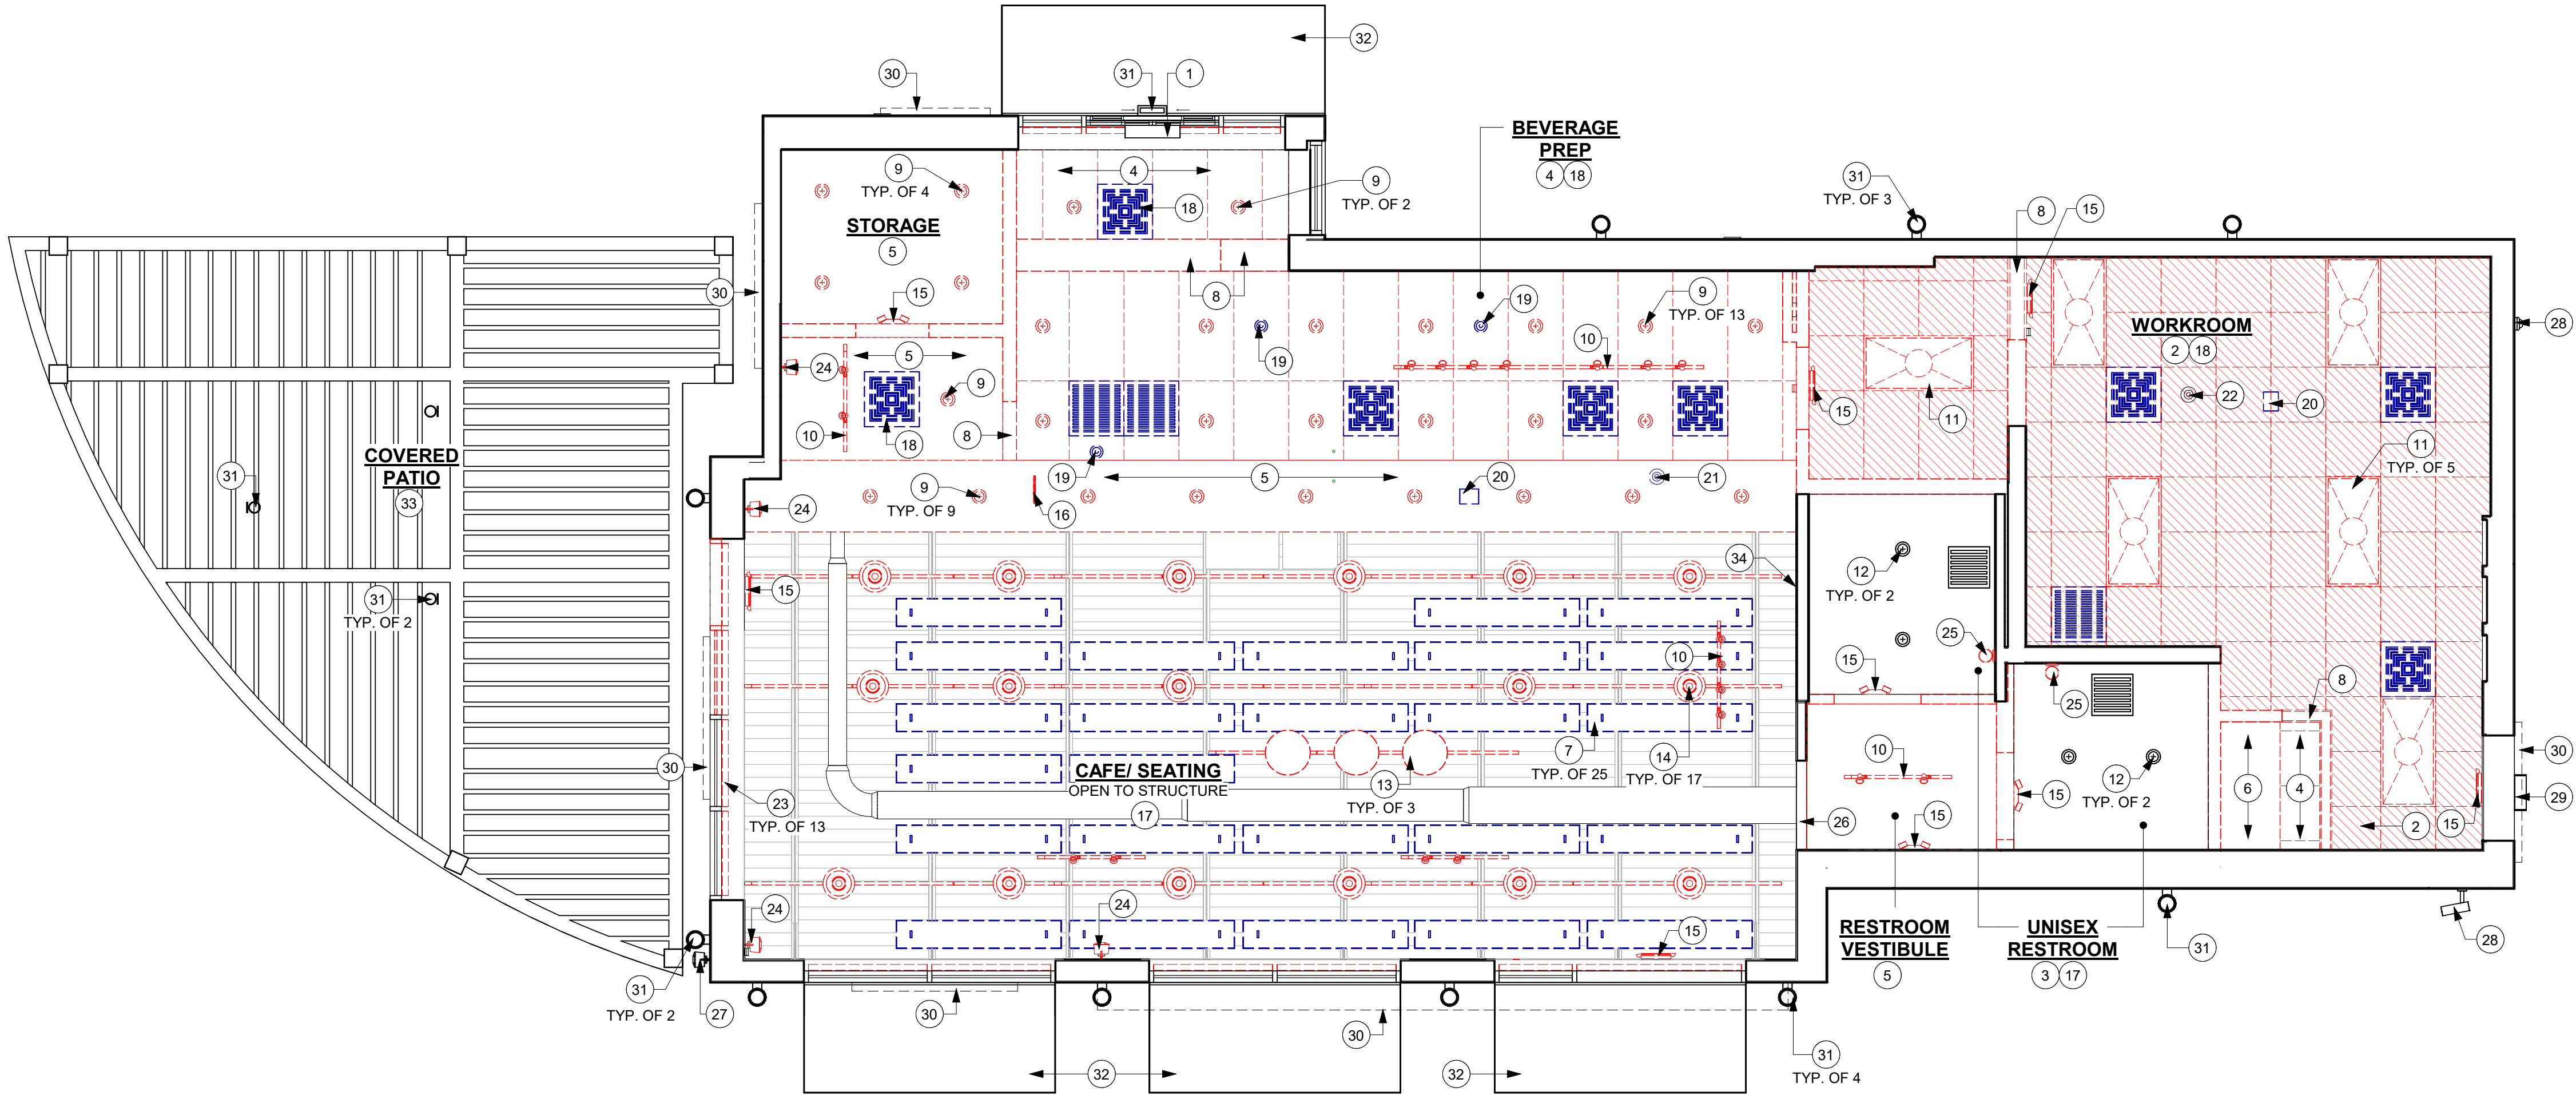


1 DEMOLITION CEILING PLAN

Scale: 1/4" = 1'-0"

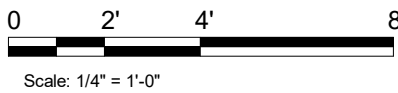

FOR CONSTRUCTION



© 2023 STARBUCKS COFFEE COMPANY

STARBUCKS®
2401 UTAH AVENUE SOUTH
SEATTLE, WASHINGTON 98134
(206) 318-1575

THESE DRAWINGS AND THE PROJECT MANUAL ARE CONFIDENTIAL AND SHALL REMAIN THE SOLE PROPERTY OF STARBUCKS CORPORATION, WHICH IS THE OWNER OF THE COPYRIGHT IN THIS WORK. THEY SHALL NOT BE REPRODUCED IN WHOLE OR IN PART, SHARED WITH THIRD PARTIES OR USED IN ANY MANNER ON OTHER PROJECTS OR EXTENSIONS TO THIS PROJECT WITHOUT THE PRIOR WRITTEN CONSENT OF STARBUCKS CORPORATION. THESE DRAWINGS AND SPECIFICATIONS ARE INTENDED TO EXPRESS DESIGN INTENT FOR A PROTOTYPICAL STARBUCKS STORE (WHICH IS SUBJECT TO CHANGE AT ANYTIME) AND DO NOT REFLECT ACTUAL SITE CONDITIONS. NEITHER PARTY SHALL HAVE ANY OBLIGATION NOR LIABILITY TO THE OTHER (EXCEPT STATED ABOVE) UNTIL A WRITTEN AGREEMENT IS FULLY EXECUTED BY BOTH PARTIES.

STARBUCKS TEMPLATE VERSION: i2023.10.23

Design Forum Architects Inc.
2050 Byers Rd
Miamisburg, OH 45342
Tel: (844) 804-7700
Donald J. Reithman
Architect In Charge
License: AR0017303

MARQUE ENGINEERING
2230 PARK AVE, STE. 100, CINCINNATI, OH 45206
513.457.7131 - WWW.MARQUEENG.COM

PROJECT NAME:
S SEMORAN BLVD & LEE VISTA BLVD


PROJECT ADDRESS:
**6605 S SEMORAN BLVD
ORLANDO, FL 32822**

STORE #: 9875
PROJECT #: 25630-101
ISSUE DATE: 03/04/2024
DESIGN MANAGER: MARTIN PEREZ
PRODUCTION DESIGNER: ANDY MCLOUD
CHECKED BY: DONALD REITHMAN

Revision Schedule			
Rev	Date	By	Description

SHEET TITLE:
DEMOLITION CEILING PLAN
SCALE: 1/4" = 1'-0"

SHEET NUMBER:
D-102

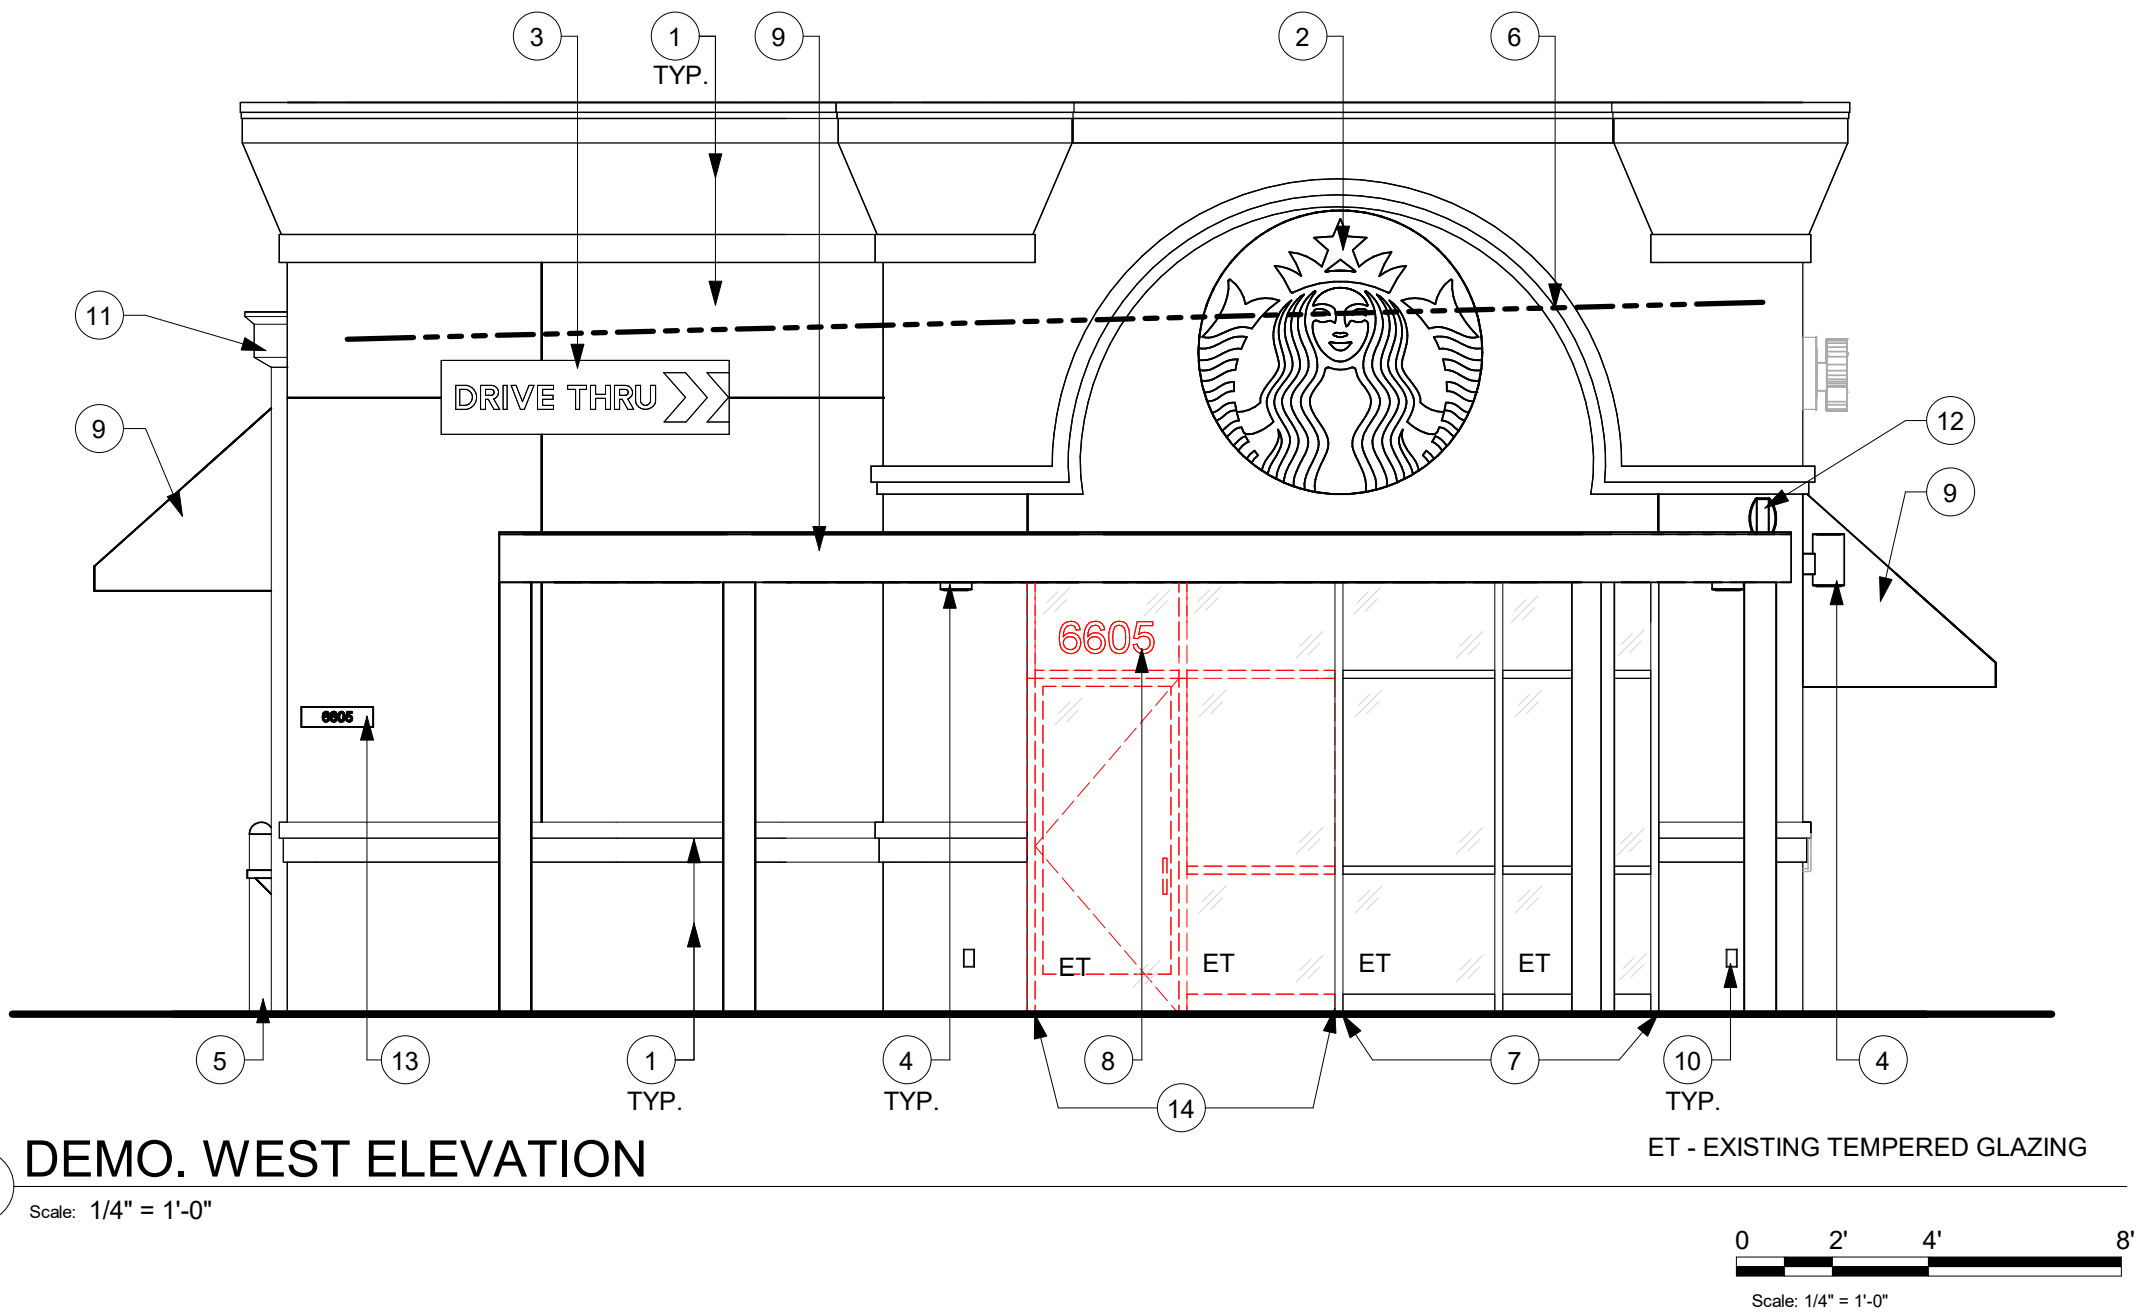


EXTERIOR ELEVATION NOTES

A. GENERAL CONTRACTOR TO CLEAN, PATCH AND REPAIR EXISTING EXTERIOR AS REQUIRED.

KEYED NOTES

1. EXISTING EXTERIOR FINISH TO REMAIN.
2. EXISTING LOGO DISK TO REMAIN.
3. EXISTING DT CABINET BOX TO REMAIN.
4. EXISTING WALL MOUNTED SCONES TO REMAIN.
5. EXISTING BOLLARD TO REMAIN.
6. TOP OF ROOF DECK.
7. EXISTING STOREFRONT WINDOW SYSTEM TO REMAIN.
8. EXISTING STORE ADDRESS ON STOREFRONT GLAZING TO BE REMOVED.
9. EXISTING AWNING / PERGOLA TO REMAIN.
10. EXISTING ELECTRICAL GFCI OUTLET TO REMAIN.
11. EXISTING DOWNSPOUT TO REMAIN.
12. EXISTING WALL MOUNTED SPEAKER TO REMAIN.
13. EXISTING STORE ADDRESS ON BUILDING TO REMAIN.
14. EXISTING STOREFRONT WINDOW / DOOR SYSTEM TO BE REMOVED.

FOR CONSTRUCTION



© 2023 STARBUCKS COFFEE COMPANY

STARBUCKS®
2401 UTAH AVENUE SOUTH
SEATTLE, WASHINGTON 98134
(206) 318-1575

THESE DRAWINGS AND THE PROJECT MANUAL ARE CONFIDENTIAL AND SHALL REMAIN THE SOLE PROPERTY OF STARBUCKS CORPORATION, WHICH IS THE OWNER OF THE COPYRIGHT IN THIS WORK. THEY SHALL NOT BE REPRODUCED IN WHOLE OR IN PART, SHARED WITH THIRD PARTIES OR USED IN ANY MANNER ON OTHER PROJECTS OR EXTENSIONS TO THIS PROJECT WITHOUT THE PRIOR WRITTEN CONSENT OF STARBUCKS CORPORATION. THESE DRAWINGS AND SPECIFICATIONS ARE INTENDED TO EXPRESS DESIGN INTENT FOR A PROTOTYPICAL STARBUCKS STORE (WHICH IS SUBJECT TO CHANGE AT ANYTIME) AND DO NOT REFLECT ACTUAL SITE CONDITIONS. NEITHER PARTY SHALL HAVE ANY OBLIGATION NOR LIABILITY TO THE OTHER (EXCEPT STATED ABOVE) UNTIL A WRITTEN AGREEMENT IS FULLY EXECUTED BY BOTH PARTIES.

STARBUCKS TEMPLATE VERSION: i2023.10.23

Design Forum Architects Inc.
2050 Byers Rd
Miamisburg, OH 45342
Tel: (844) 804-7700

Donald J. Reihman
Architect In Charge
License: AR0017303

MARQUE ENGINEERING
2230 PARK AVE, STE. 100, CINCINNATI, OH 45206
513.457.7131 - WWW.MARQUEENG.COM

PROJECT NAME:
S SEMORAN BLVD & LEE VISTA BLVD

PROJECT ADDRESS:
**6605 S SEMORAN BLVD
ORLANDO, FL 32822**

STORE #: 9875
PROJECT #: 25630-101
ISSUE DATE: 03/04/2024
DESIGN MANAGER: MARTIN PEREZ
PRODUCTION DESIGNER: ANDY MCLOUD
CHECKED BY: DONALD RETHMAN

Revision Schedule			
Rev	Date	By	Description

SHEET TITLE:
DEMOLITION EXTERIOR ELEVATION
SCALE: 1/4" = 1'-0"

SHEET NUMBER:
D-201

\\file-day.ad.changeupinc.com\Client\StarbucksArchitecture\Projects_2023\Florida\Semoran & Lee Vista -25630-10\125630-101_9875_S Semoran Blvd & Lee Vista Blvd, FL_2023.rvt 3/4/2024 2:39:04 PM

SIGNAGE SCHEDULE - "S"					
DESIGN ID	COUNT	DESCRIPTION	FURN. BY	INST. BY	COMMENTS
SIGNAGE - DRIVE THRU					
23725	1	SIGN - DIRECTIONAL EXIT ONLY NON-ILLUM DS - NEW FOUNDATION - 44IN 1120MM	SB	VD	SEE DETAIL: 2 & 3/A-002


RESPONSIBILITY LEGEND

FURN. BY	INST. BY
GC - FURNISHED BY GENERAL CONTRACTOR	GC - INSTALLED BY GENERAL CONTRACTOR
SB - FURNISHED BY STARBUCKS	SB - INSTALLED BY STARBUCKS
VD - FURNISHED BY VENDOR	VD - INSTALLED BY VENDOR

NOTE:
ALL RESPONSIBILITIES TO BE CONFIRMED WITH STARBUCKS CONSTRUCTION MANAGER PRIOR TO ORDERING / CONSTRUCTION.

SIGNAGE IS FOR REFERENCE ONLY

SIGNAGE APPROVALS SHALL BE ACQUIRED UNDER SEPARATE SIGN PERMIT SUBMITTALS. SIGNAGE IS NOT INCLUDED IN THE SCOPE OF THE BUILDING PERMIT.

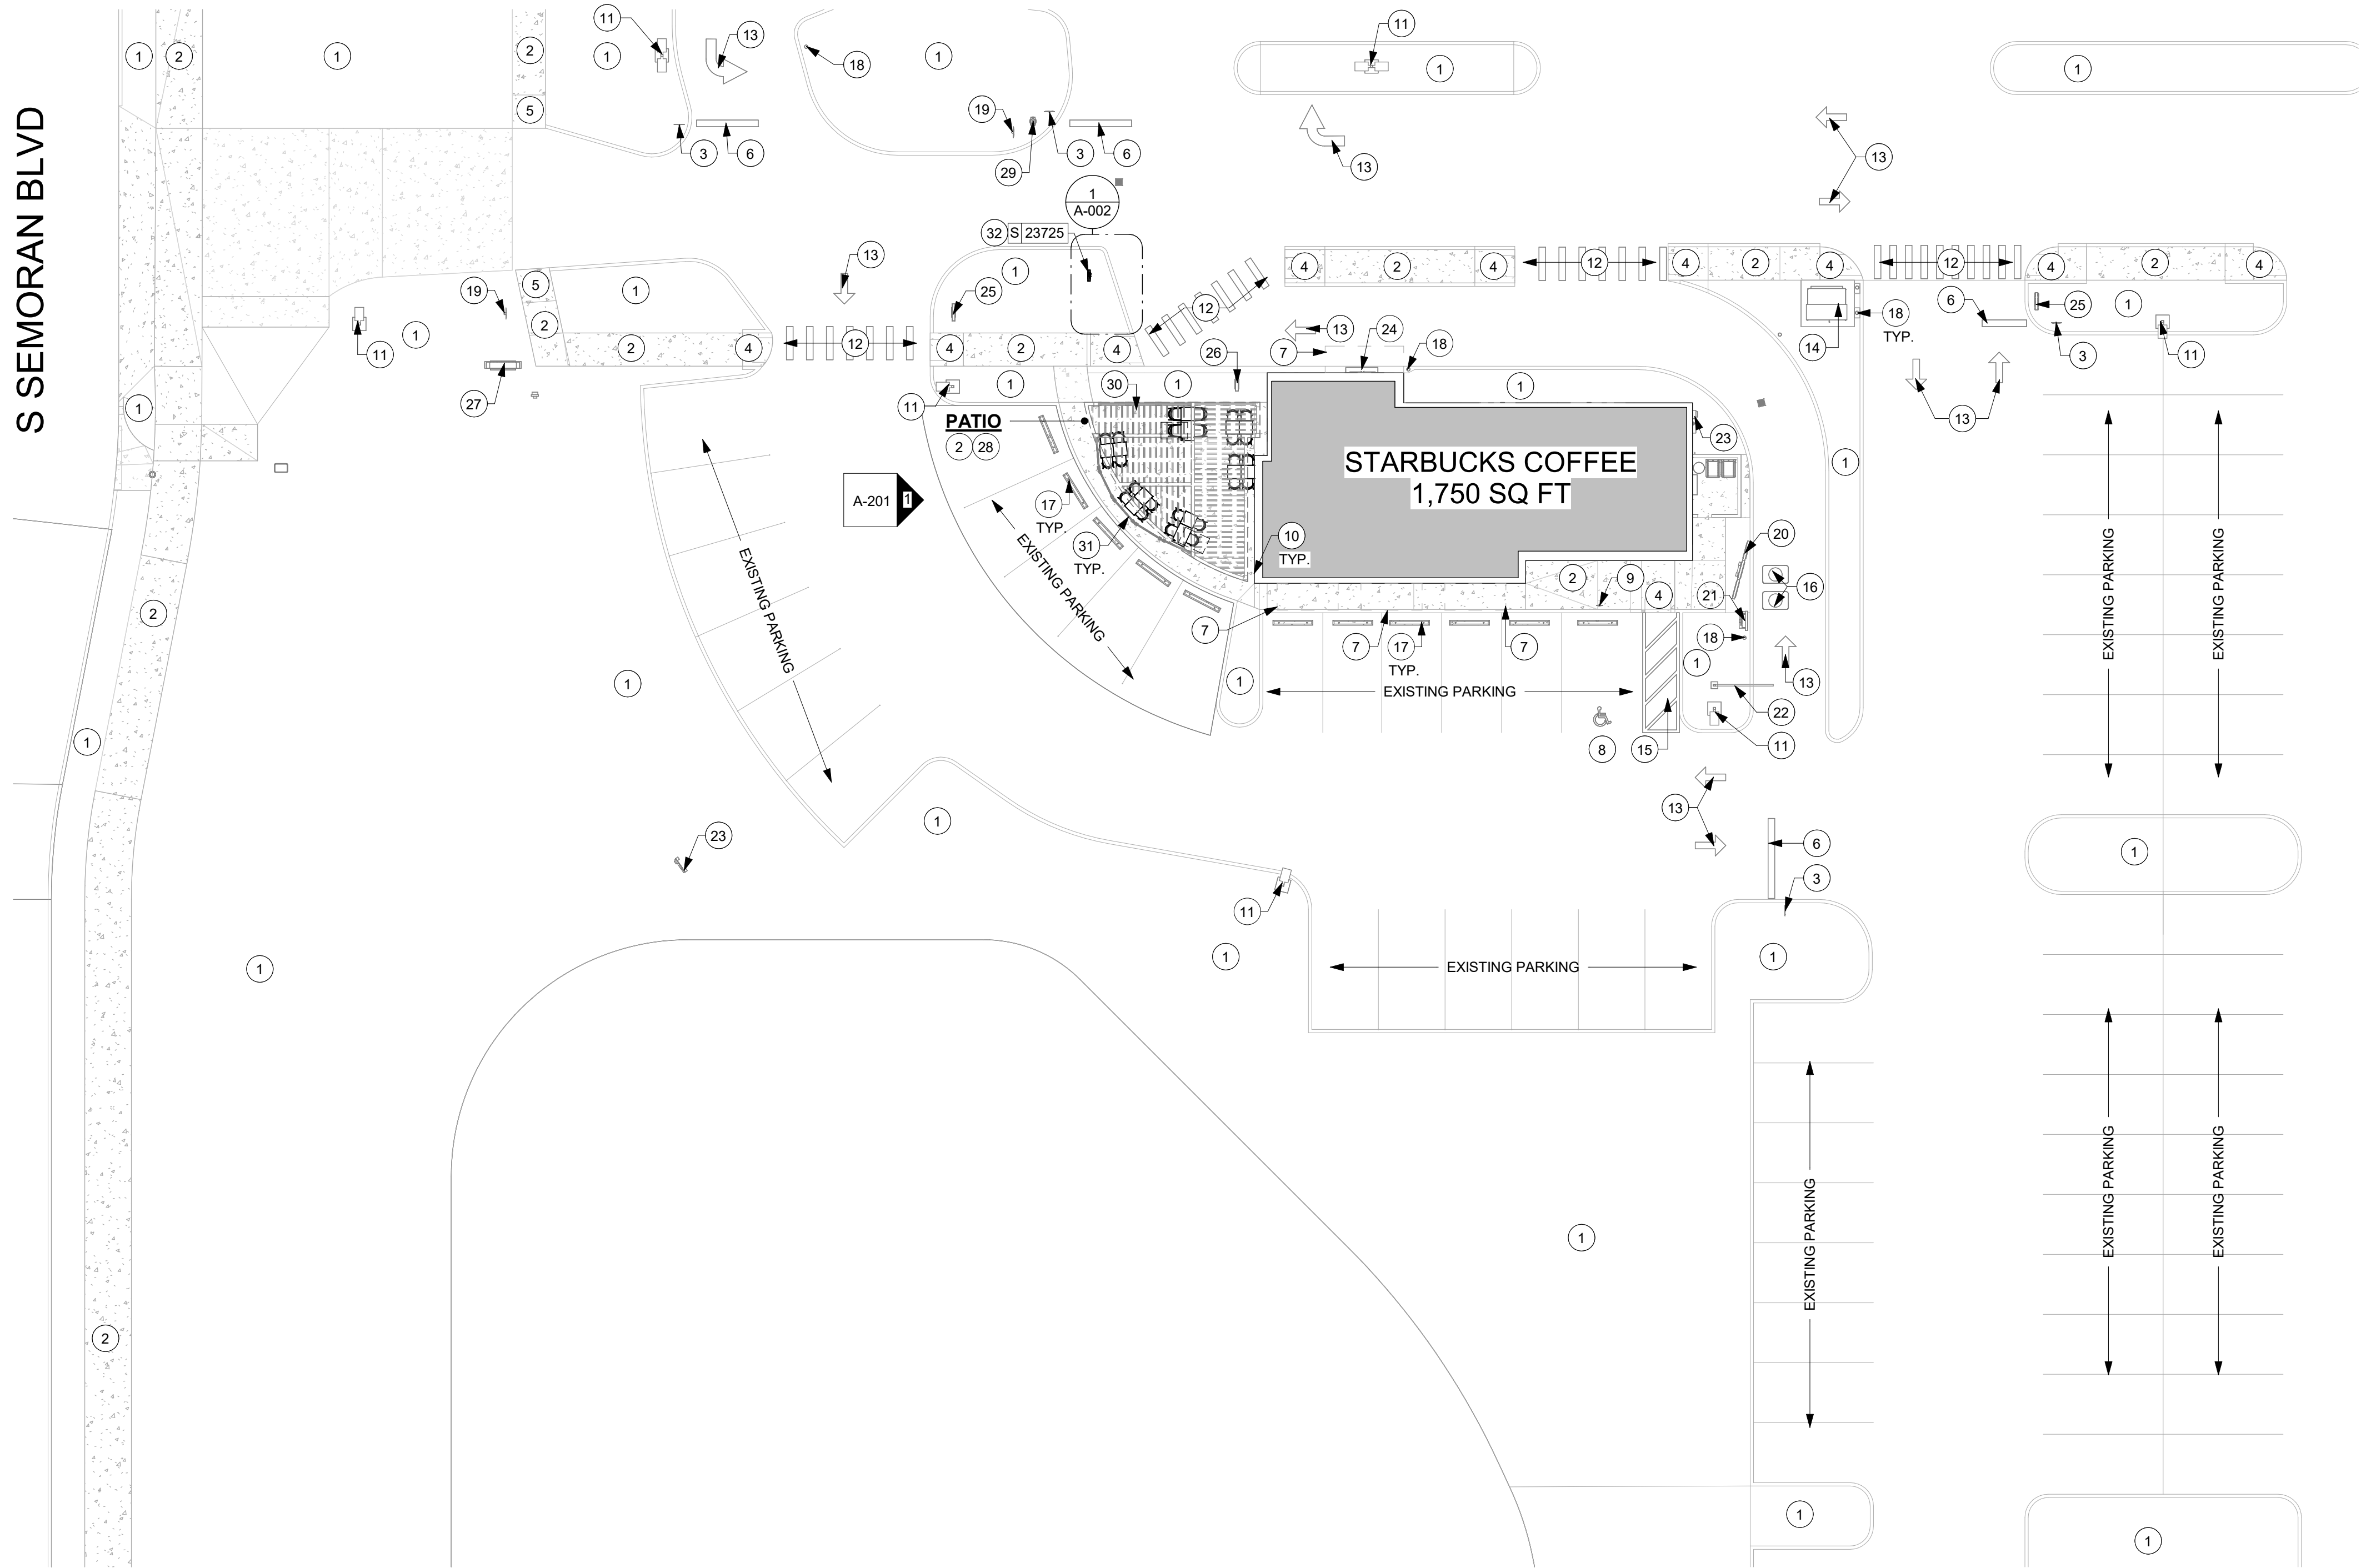

GENERAL NOTES

- A. GENERAL CONTRACTOR TO VERIFY ALL EXISTING ELEVATIONS AND BUILDING CONDITIONS IN FIELD PRIOR TO START OF CONSTRUCTION.

KEYED NOTES

- EXISTING LANDSCAPING TO REMAIN.
- EXISTING SIDEWALK/ PAVERS TO REMAIN.
- EXISTING "STOP" SIGN TO REMAIN.
- EXISTING ADA RAMP AND TRUNCATED DOME TO REMAIN.
- EXISTING ACCESSIBLE RAMP TO REMAIN.
- EXISTING STOP BAR TO REMAIN.
- LINE OF CANOPY/ ROOF PROJECTION ABOVE.
- EXISTING ADA PARKING AND PARKING SYMBOL TO REMAIN.
- EXISTING ADA PARKING SIGN ON BOLLARD TO REMAIN.
- EXISTING GFCI OUTLET TO REMAIN.
- EXISTING LIGHT POLE TO REMAIN.
- EXISTING CROSSWALK STRIPING TO REMAIN.
- EXISTING DIRECTIONAL ARROWS TO REMAIN.
- EXISTING TRANSFORMER ON CONCRETE PAD TO REMAIN.
- EXISTING ADA STRIPING TO REMAIN.
- EXISTING GREASE TRAP TO REMAIN.
- EXISTING WHEEL STOPS TO REMAIN.
- EXISTING CIRCULAR BOLLARD TO REMAIN.
- EXISTING "DO NOT ENTER" SIGN TO REMAIN.
- EXISTING 5-PANEL MENU BOARD TO REMAIN.
- EXISTING DIGITAL ORDER SCREEN TO REMAIN.
- EXISTING CLEARANCE BAR TO REMAIN.
- EXISTING ELECTRICAL EQUIPMENT TO REMAIN.
- EXISTING DT SHELF TO REMAIN.
- EXISTING DRIVE-THRU ENTRY DIRECTIONAL SIGNAGE TO REMAIN.
- EXISTING DRIVE-THRU THANK YOU/ EXIT ONLY SIGNAGE TO REMAIN.
- EXISTING MONUMENT SIGN TO REMAIN.
- INSTALL NEW OUTDOOR FURNITURE AS SHOWN IN FF&E PLAN.
- EXISTING FIRE HYDRANT TO REMAIN.
- EXISTING PERGOLA TO REMAIN.
- EXISTING PATIO RAILING TO REMAIN.
- EXISTING "DO NOT ENTER" SIGN TO BE REPLACED WITH DIRECTIONAL EXIT ONLY SIGNAGE AS INDICATE. CONCRETE FOOTING AND CONDUIT BY VD.



© 2023 STARBUCKS COFFEE COMPANY

STARBUCKS®

2401 UTAH AVENUE SOUTH
SEATTLE, WASHINGTON 98134
(206) 318-1575

THESE DRAWINGS AND THE PROJECT MANUAL ARE CONFIDENTIAL AND SHALL REMAIN THE SOLE PROPERTY OF STARBUCKS CORPORATION, WHICH IS THE OWNER OF THE COPYRIGHT IN THIS WORK. THEY SHALL NOT BE REPRODUCED IN WHOLE OR IN PART, SHARED WITH THIRD PARTIES OR USED IN ANY MANNER ON OTHER PROJECTS OR EXTENSIONS TO THIS PROJECT WITHOUT THE PRIOR WRITTEN CONSENT OF STARBUCKS CORPORATION. THESE DRAWINGS AND SPECIFICATIONS ARE INTENDED TO EXPRESS DESIGN INTENT FOR A PROTOTYPICAL STARBUCKS STORE (WHICH IS SUBJECT TO CHANGE AT ANYTIME) AND DO NOT REFLECT ACTUAL SITE CONDITIONS. NEITHER PARTY SHALL HAVE ANY OBLIGATION NOR LIABILITY TO THE OTHER (EXCEPT STATED ABOVE) UNTIL A WRITTEN AGREEMENT IS FULLY EXECUTED BY BOTH PARTIES.

STARBUCKS TEMPLATE VERSION: i2023.10.23

Design Forum Architects Inc.

2050 Byers Rd
Miami, FL 33134
Tel: (844) 804-7700

Donald J. Rehman
Architect In Charge
License: AR0017303



2230 PARK AVE, STE. 100, CINCINNATI, OH 45206
513.457.7131 - WWW.MARQUEENG.COM

FOR CONSTRUCTION

PROJECT NAME:
S SEMORAN BLVD &
LEE VISTA BLVD


PROJECT ADDRESS:
6605 S SEMORAN BLVD
ORLANDO, FL 32822

STORE #: 9875
PROJECT #: 25630-101
ISSUE DATE: 03/04/2024
DESIGN MANAGER: MARTIN PEREZ
PRODUCTION DESIGNER: ANDY MCLOUD
CHECKED BY: DONALD REHMAN

Revision Schedule			
Rev	Date	By	Description


SHEET TITLE:
ARCHITECTURAL SITE PLAN
SCALE: 1/16" = 1'-0"

SHEET NUMBER:
A-001

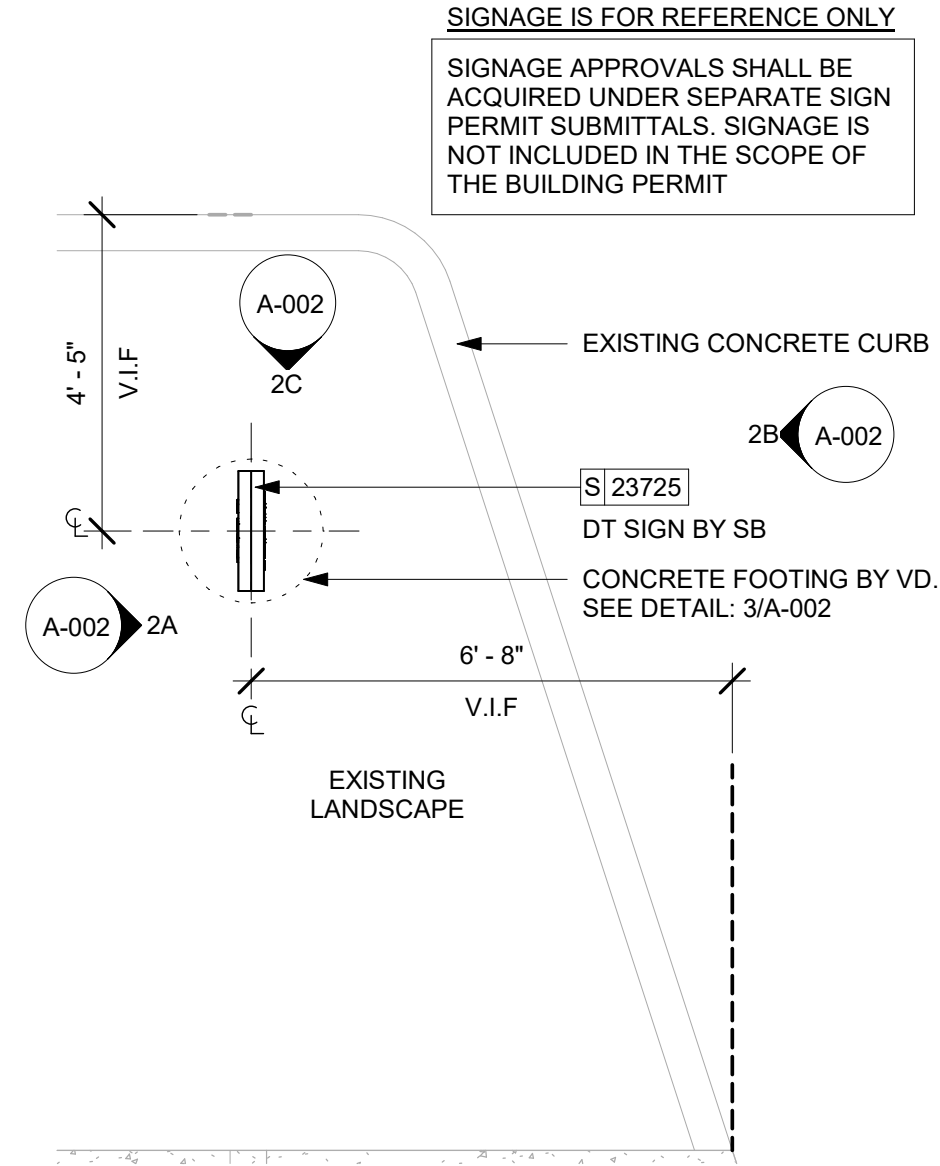


1 ILLUMINATED DIRECTIONAL SIGNAGE LOCATION- EXIT ONLY

Scale: 3/8" = 1'-0"

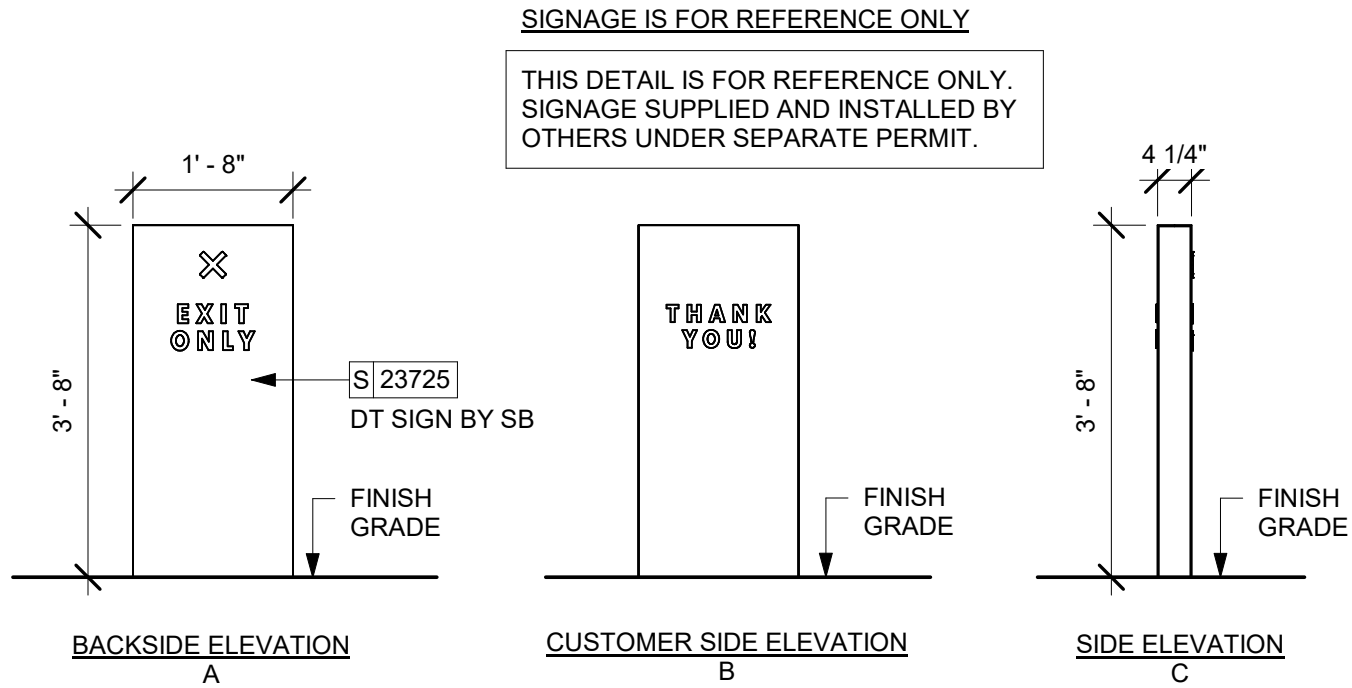


2 ILLUMINATED SIGN - DRIVE-THRU EXIT ONLY - ELEVATIONS

Scale: 1/2" = 1'-0"

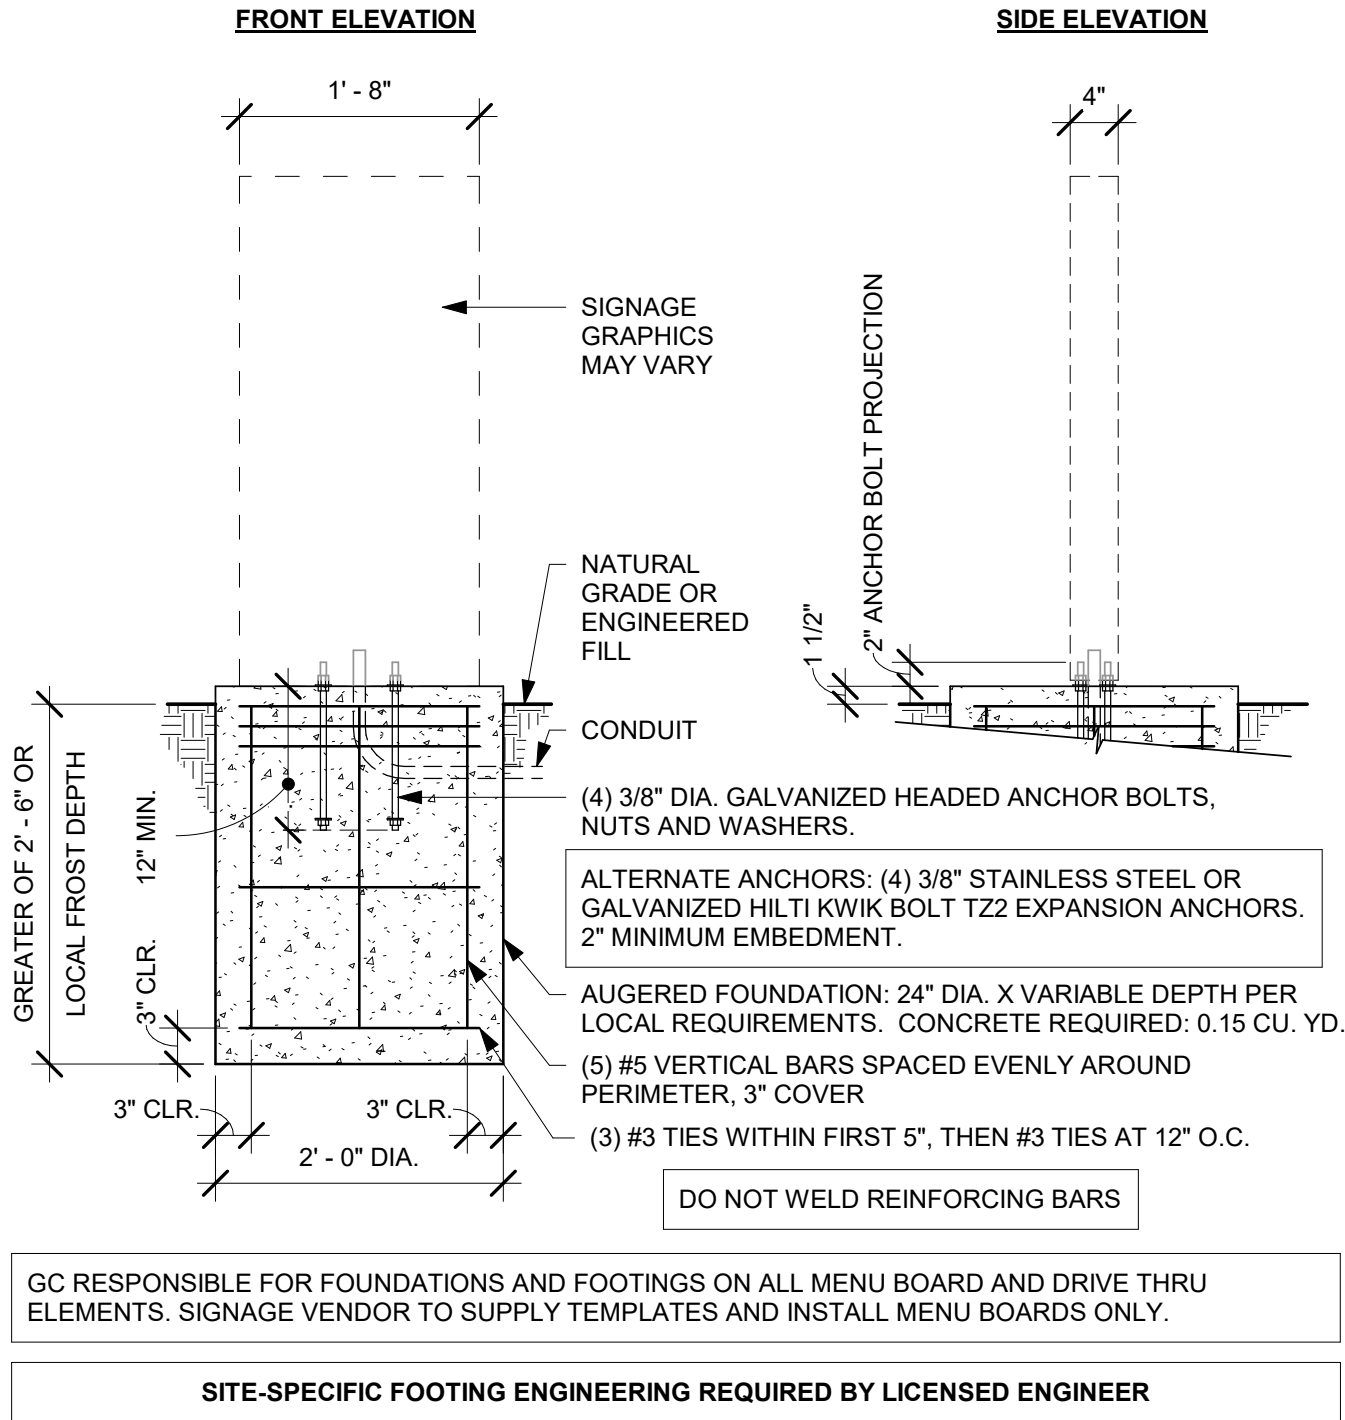


3 DTE DIRECTIONAL SIGNAGE GROUND FOOTING

Scale: 3/4" = 1'-0"

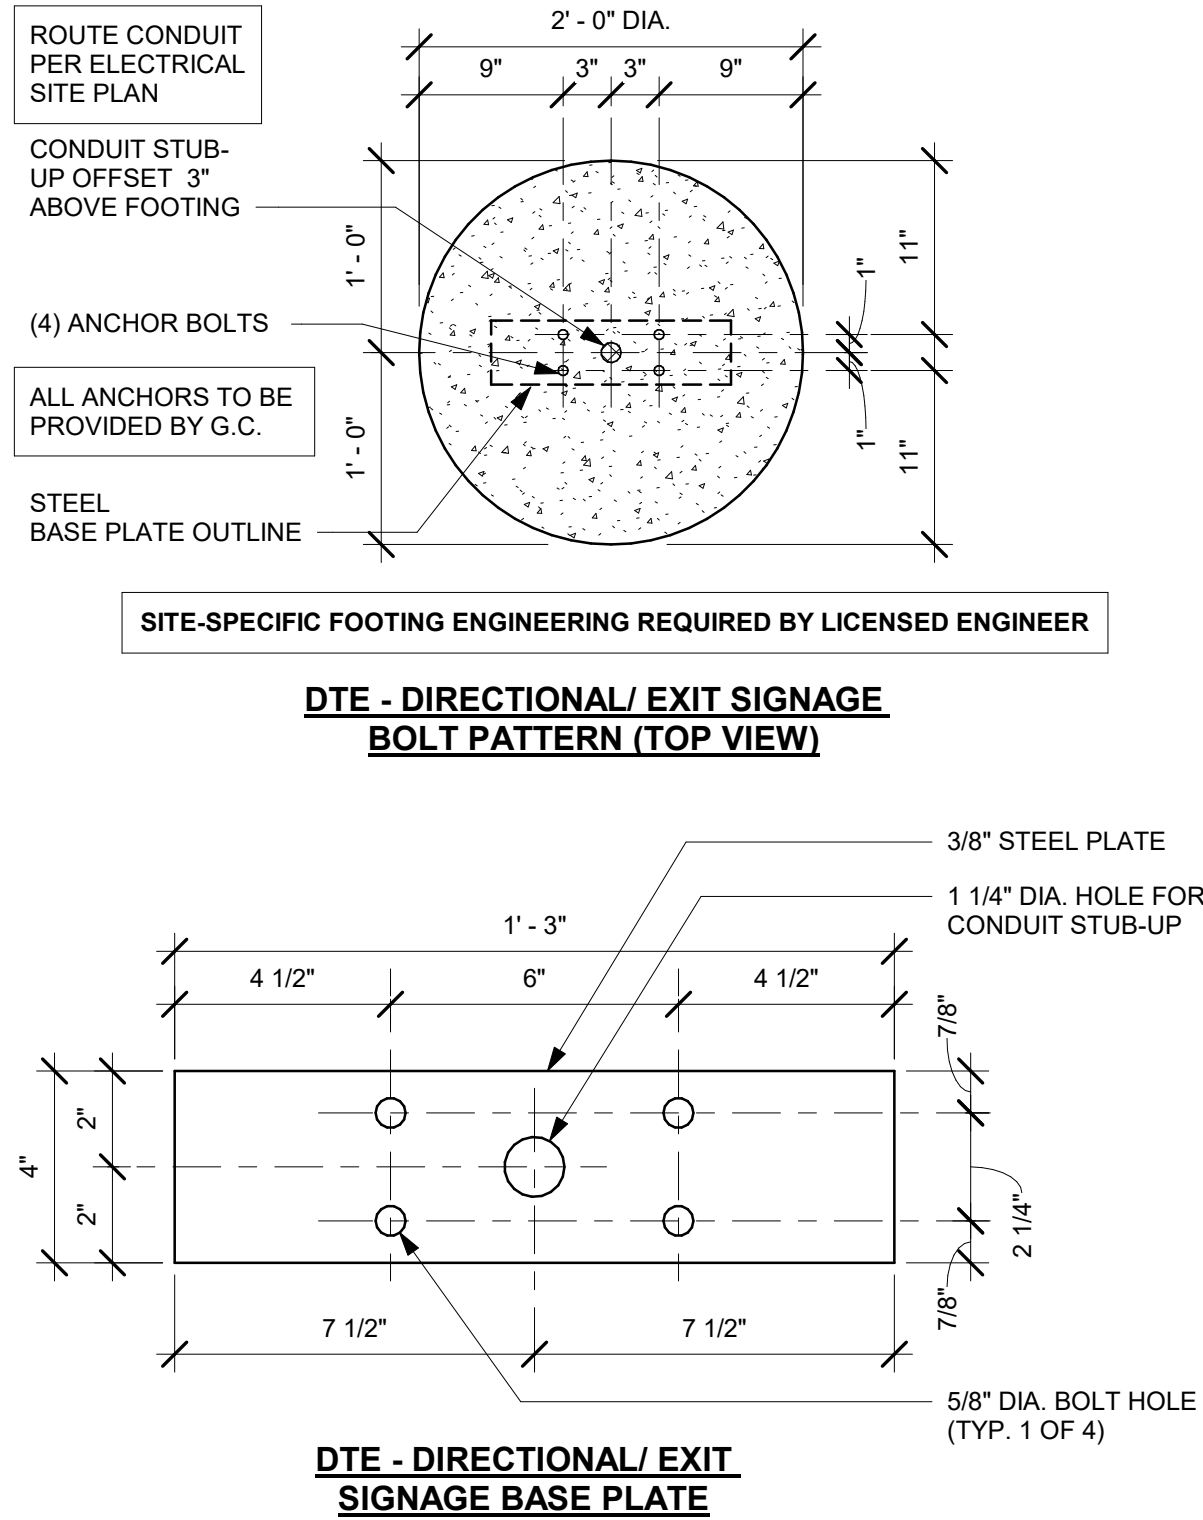

FOR CONSTRUCTION



© 2023 STARBUCKS COFFEE COMPANY

STARBUCKS®
2401 UTAH AVENUE SOUTH
SEATTLE, WASHINGTON 98134
(206) 318-1575

THESE DRAWINGS AND THE PROJECT MANUAL ARE CONFIDENTIAL AND SHALL REMAIN THE SOLE PROPERTY OF STARBUCKS CORPORATION, WHICH IS THE OWNER OF THE COPYRIGHT IN THIS WORK. THEY SHALL NOT BE REPRODUCED IN WHOLE OR IN PART, SHARED WITH THIRD PARTIES OR USED IN ANY MANNER ON OTHER PROJECTS OR EXTENSIONS TO THIS PROJECT WITHOUT THE PRIOR WRITTEN CONSENT OF STARBUCKS CORPORATION. THESE DRAWINGS AND SPECIFICATIONS ARE INTENDED TO EXPRESS DESIGN INTENT FOR A PROTOTYPICAL STARBUCKS STORE (WHICH IS SUBJECT TO CHANGE AT ANYTIME) AND DO NOT REFLECT ACTUAL SITE CONDITIONS. NEITHER PARTY SHALL HAVE ANY OBLIGATION NOR LIABILITY TO THE OTHER (EXCEPT STATED ABOVE) UNTIL A WRITTEN AGREEMENT IS FULLY EXECUTED BY BOTH PARTIES.

STARBUCKS TEMPLATE VERSION: i2023.10.23

Design Forum Architects Inc.
2050 Byers Rd
Miami, OH 45342
Tel: (844) 804-7700

Donald J. Reihman
Architect In Charge
License: AR0017303

MARQUE ENGINEERING
2230 PARK AVE, STE. 100, CINCINNATI, OH 45206
513.457.7131 - WWW.MARQUEENG.COM

PROJECT NAME:
S SEMORAN BLVD & LEE VISTA BLVD

PROJECT ADDRESS:
**6605 S SEMORAN BLVD
ORLANDO, FL 32822**

STORE #:
9875

PROJECT #:
25630-101

ISSUE DATE:
03/04/2024

DESIGN MANAGER:
MARTIN PEREZ

PRODUCTION DESIGNER:
ANDY MLCLOUD

CHECKED BY:
DONALD RETHMAN

Revision Schedule			
Rev	Date	By	Description

SHEET TITLE:
ARCHITECTURAL SITE DETAIL

SCALE: AS SHOWN

SHEET NUMBER:
A-002


\\file-day.ad.changeupinc.com\Client\StarbucksArchitecture\Projects_2023\Florida\Semoran & Lee Vista -25630-101\25630-101_9875_S Semoran Blvd & Lee Vista Blvd, FL_2023.rvt 3/4/2024 2:39:07 PM

GENERAL NOTES

- A. THE DRAWINGS AND PROJECT MANUAL TOGETHER CONSTITUTE THE CONTRACT DOCUMENTS FOR CONSTRUCTION. ALL GENERAL REQUIREMENTS ARE TO BE MET AND ALL MATERIALS, FINISHES AND SYSTEMS ARE TO BE INSTALLED AND PERFORM PER SPECIFICATIONS UNLESS OTHERWISE NOTED.
- B. GENERAL CONTRACTOR SHALL VISIT THE SITE, REVIEW THE BUILDING SHELL DRAWINGS AS SUBMITTED BY THE LANDLORD OR STARBUCKS AND BECOME THOROUGHLY FAMILIAR WITH THE SITE CONDITIONS PRIOR TO CONSTRUCTION.
- C. GENERAL CONTRACTOR SHALL CONSULT WITH STARBUCKS CONSTRUCTION MANAGER TO RESOLVE ANY CHANGES, OMISSIONS OR PLAN DISCREPANCIES PRIOR TO CONSTRUCTION.
- D. ALL WORK SHALL BE PERFORMED IN STRICT COMPLIANCE WITH LOCAL, COUNTY, STATE AND FEDERAL CODES AND ORDINANCES.
- E. GENERAL CONTRACTOR SHALL VERIFY THE LOCATION OF ALL UTILITIES.
- F. GENERAL CONTRACTOR TO VERIFY ALL DIMENSIONS, INCLUDING CLEARANCES REQUIRED BY OTHER TRADES AND NOTIFY STARBUCKS CONSTRUCTION MANAGER OF ANY DISCREPANCIES PRIOR TO PROCEEDING WITH THE WORK. ALL DIMENSIONS ARE TO THE FACE OF THE FINISHED SURFACE UNLESS OTHERWISE NOTED. ALL DIMENSIONS TO BE TAKEN FROM DESIGNATED DATUM POINT. DO NOT SCALE DRAWINGS.
- G. GENERAL CONTRACTOR SHALL PATCH AND REPAIR ALL EXISTING WALLS, FLOORS, CEILINGS OR OTHER SURFACES IDENTIFIED TO REMAIN THAT MAY BECOME DAMAGED DURING THE COURSE OF THE WORK.
- H. THE GENERAL CONTRACTOR IS RESPONSIBLE FOR OBTAINING PERMITS FOR FIRE PROTECTION, PLUMBING, MECHANICAL AND ELECTRICAL SYSTEMS PRIOR TO INSTALLATION OF SUCH SYSTEMS.
- I. GENERAL CONTRACTOR SHALL RETAIN ONE SET OF PERMIT PLANS ON-SITE TO DOCUMENT ALL CHANGES MADE DURING CONSTRUCTION. THE RECORD DRAWINGS SHALL BE ISSUED TO THE OWNER AT PROJECT CLOSE-OUT AS DESCRIBED IN THE GENERAL REQUIREMENTS OF THE PROJECT MANUAL.
- J. GENERAL CONTRACTOR IS RESPONSIBLE FOR COORDINATING DELIVERY OF MATERIALS FROM STARBUCKS CONTRACTED THIRD PARTY LOGISTICS DISTRIBUTION SERVICES AND VENDOR DIRECT SHIPMENTS. SEE THE PROJECT MANUAL FOR ADDITIONAL INFORMATION.
- K. RESPONSIBILITY FOR SUPPLY AND DELIVERY OF MATERIALS AND EQUIPMENT IS IDENTIFIED IN THE DRAWING SCHEDULE SHEETS UNDER THE COLUMN LABELED "RESPONSIBILITY".
- L. FOR THE PURPOSE OF THE DOCUMENTS, TO "INSTALL", SHALL MEAN TO PROVIDE ALL FASTENERS, MISCELLANEOUS HARDWARE, BLOCKING, ELECTRICAL CONNECTIONS, PLUMBING CONNECTIONS AND OTHER ITEMS REQUIRED FOR A COMPLETE AND OPERATIONAL INSTALLATION, UNLESS OTHERWISE NOTED.
- M. ALL ITEM SUBSTITUTIONS MUST BE APPROVED BY THE STARBUCKS CONSTRUCTION MANAGER.

KEYED NOTES

1. EXISTING ELECTRICAL PANELS AS INDICATED ON ELECTRICAL DRAWINGS.
2. INSTALL CASEWORK ITEMS AS INDICATED ON CASEWORK PLAN.
3. INSTALL WASTE & RECYLING CART AS INDICATED ON CASEWORK PLAN.
4. INSTALL PLUMBING ITEMS AS INDICATED ON FF&E PLAN.
5. INSTALL EQUIPMENT AS INDICATED ON FF&E PLAN.
6. INSTALL NEW PATIO FURNITURE, UMBRELLAS AND UMBRELLA BASES AS INDICATED ON FF&E PLAN.
7. INSTALL FURNITURE AS INDICATED ON FF&E PLAN.
8. PATCH, PRIME AND PAINT WALL, CEILING AND/ OR SOFFIT AS INDICATED ON REFLECTED CEILING PLAN AND INTERIOR ELEVATIONS.
9. INSTALL GRAPHICS AS INDICATED ON INTERIOR ELEVATIONS.
10. INSTALL NEW WALL FINISHES THROUGHOUT AS INDICATED ON INTERIOR ELEVATIONS AND WALL FINISH PLAN.
11. INSTALL NEW FLOOR FINISHES AS INDICATED ON FLOOR FINISH PLAN.
12. INSTALL LIGHT FIXTURES AS INDICATED ON REFLECTED CEILING AND DIMENSIONED LIGHTING PLANS.
13. INSTALL CEILING FINISHES AS INDICATED ON REFLECTED CEILING AND DIMENSIONED CEILING PLANS.
14. PRIME AND PAINT WALLS AS INDICATED ON WALL FINISH PLAN AND INTERIOR ELEVATIONS.
15. EXISTING BUILDING SHELL.
16. INSTALL WALK-OFF MAT AS INDICATED ON FLOOR FINISH PLAN.
17. CONSTRUCT NEW INTERIOR WALLS AS INDICATED ON FLOOR PLAN.
18. INSTALL ESPRESSO BAR AS INDICATED ON CASEWORK PLAN.
19. INSTALL ELECTRICAL OUTLETS AS INDICATED ON PENETRATION PLAN AND ELECTRICAL DRAWINGS.
20. EXISTING/ RELOCATED EQUIPMENT AS INDICATED ON FF&E PLAN.
21. EXISTING/ RELOCATED PLUMBING EQUIPMENT AS INDICATED ON FF&E PLAN.
22. INSTALL BLACKOUT WINDOW FILM ON EXTERIOR FACE OF GLAZING AS INDICATED.
23. INSTALL NEW INTERIOR DOOR AS INDICATED ON BUILDING FLOOR PLAN.
24. EXISTING PATIO RAILING.
25. NEW STOREFRONT DOOR AS INDICATED ON BUILDING FLOOR PLAN.
26. INSTALL NEW EXHAUST FAN AND CONDENSER ON EXISTING LOCATION.

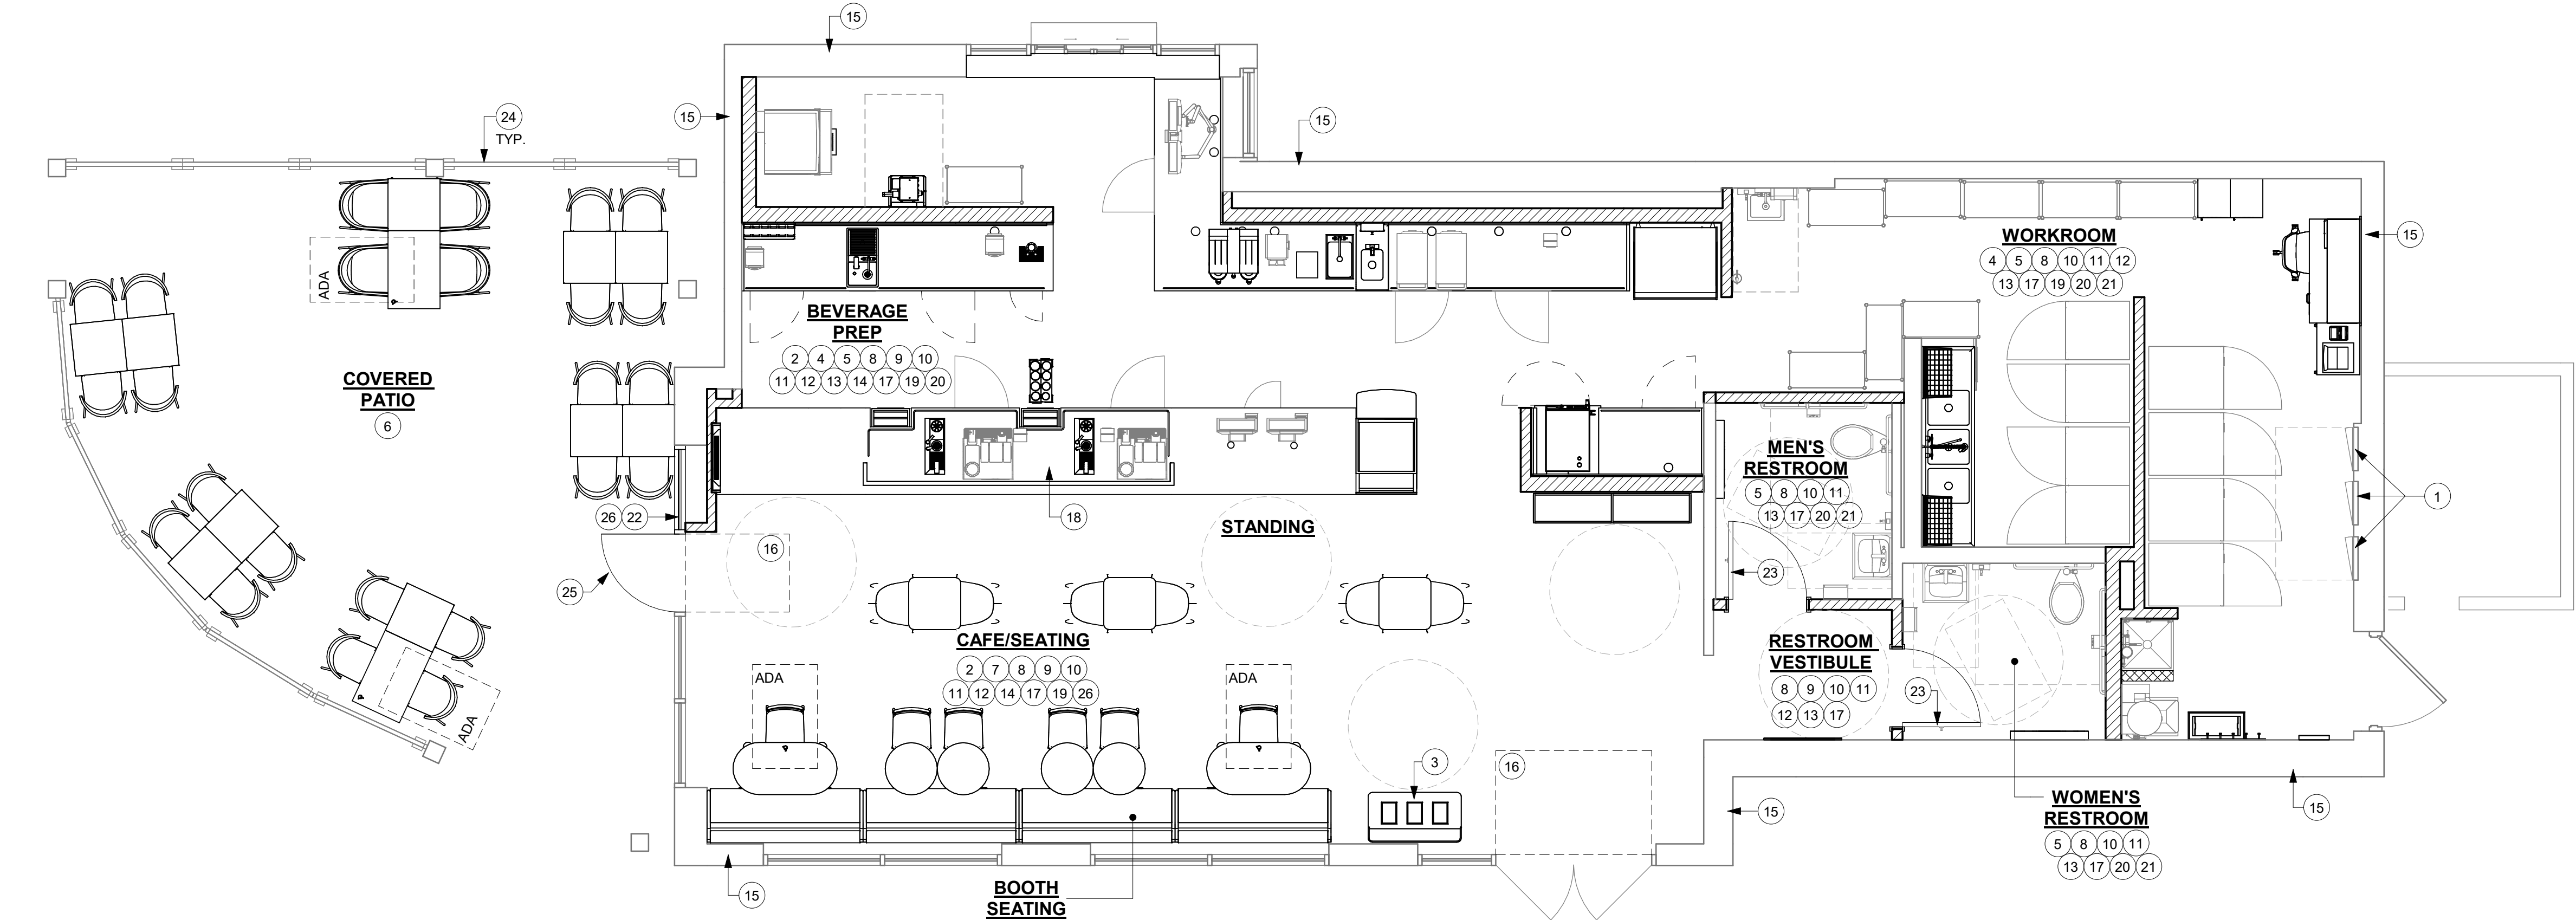


1 SCOPE OF WORK PLAN

Scale: 1/4" = 1'-0"

0 2' 4' 8'
Scale: 1/4" = 1'-0"

FOR CONSTRUCTION



© 2023 STARBUCKS COFFEE COMPANY

STARBUCKS®
2401 UTAH AVENUE SOUTH
SEATTLE, WASHINGTON 98134
(206) 318-1575

THESE DRAWINGS AND THE PROJECT MANUAL ARE CONFIDENTIAL AND SHALL REMAIN THE SOLE PROPERTY OF STARBUCKS CORPORATION, WHICH IS THE OWNER OF THE COPYRIGHT IN THIS WORK. THEY SHALL NOT BE REPRODUCED IN WHOLE OR IN PART, SHARED WITH THIRD PARTIES OR USED IN ANY MANNER ON OTHER PROJECTS OR EXTENSIONS TO THIS PROJECT WITHOUT THE PRIOR WRITTEN CONSENT OF STARBUCKS CORPORATION. THESE DRAWINGS AND SPECIFICATIONS ARE INTENDED TO EXPRESS DESIGN INTENT FOR A PROTOTYPICAL STARBUCKS STORE (WHICH IS SUBJECT TO CHANGE AT ANYTIME) AND DO NOT REFLECT ACTUAL SITE CONDITIONS. NEITHER PARTY SHALL HAVE ANY OBLIGATION NOR LIABILITY TO THE OTHER (EXCEPT STATED ABOVE) UNTIL A WRITTEN AGREEMENT IS FULLY EXECUTED BY BOTH PARTIES.

STARBUCKS TEMPLATE VERSION: i2023.10.23

Design Forum Architects Inc.
2050 Byers Rd
Miami, OH 45342
Tel: (844) 804-7700
Donald J. Reithman
Architect In Charge
License: AR0017303

MARQUE ENGINEERING
2230 PARK AVE, STE. 100, CINCINNATI, OH 45206
513.457.7131 - WWW.MARQUEENG.COM

PROJECT NAME:
S SEMORAN BLVD & LEE VISTA BLVD

PROJECT ADDRESS:
**6605 S SEMORAN BLVD
ORLANDO, FL 32822**

STORE #: 9875
PROJECT #: 25630-101
ISSUE DATE: 03/04/2024
DESIGN MANAGER: MARTIN PEREZ
PRODUCTION DESIGNER: ANDY MCLOUD
CHECKED BY: DONALD REITHMAN

Revision Schedule			
Rev	Date	By	Description

SHEET TITLE:
SCOPE OF WORK PLAN

SCALE: 1/4" = 1'-0"

SHEET NUMBER:
A-100

\\file-day.ad.changeupinc.com\Client\StarbucksArchitecture\Projects_2023\Florida\Semoran & Lee Vista -25630-10\25630-101_9875_S Semoran Blvd & Lee Vista Blvd, FL_2023.rvt 3/4/2024 2:39:08 PM


WALL CONSTRUCTION SCHEDULE	
WALL LABELING KEY:	INTERIOR SHEATHING WALL STUD INTERIOR MODIFIER
WALL STUD	
4a	3 5/8" 20 GA STUDS AT 16" O.C. (FULL HEIGHT)
4b	3 5/8" 20 GA STUDS AT 16" O.C. (TERMINATE 6" ABOVE CEILING). PROVIDE 45 DEGREE METAL STUD BRACING AT 48" O.C. FROM TOP OF STUD WALL TO STRUCTURE ABOVE.
4c	3 5/8" 16 GA STUDS AT 16" O.C. (PARTIAL HEIGHT). DRYWALL SCREWS AT 12" O.C.
6a	6" 20 GA STUDS AT 16" O.C. (FULL HEIGHT)
6b	6" 20 GA STUDS AT 16" O.C. (TERMINATE 6" ABOVE CEILING). PROVIDE 45 DEGREE METAL STUD BRACING AT 48" O.C. FROM STUD WALL TO STRUCTURE ABOVE.
INTERIOR SHEATHING	
A	ONE SIDE 5/8" MOISTURE RESISTANT GYP. BOARD (TERMINATE 6" ABOVE ACT CEILING)
B	BOTH SIDES 5/8" MOISTURE RESISTANT GYP. BOARD (ONE SIDE UNDERSIDE OF GYPSUM BOARD CEILING AND OTHER SIDE TERMINATE 6" ABOVE ACT CEILING)
C	BOTH SIDES 5/8" MOISTURE RESISTANT GYP. BOARD (BOTH SIDES TERMINATE 6" ABOVE ACT CEILING)
D	ONE SIDE 5/8" MOISTURE RESISTANT GYP. BOARD (UNDERSIDE OF GYPSUM BOARD CEILING)
E	ONE SIDE 5/8" TYPE "X" GYP. BOARD (UPTO STRUCTURE)
F	ONE SIDE 5/8" MOISTURE RESISTANT GYP. BOARD AND OTHER SIDE 5/8" TYPE "X" GYP. BOARD (BOTH SIDES UNDERSIDE OF GYPSUM BOARD CEILING)
G	BOTH SIDES 5/8" MOISTURE RESISTANT GYP. BOARD (ONE SIDE UNDERSIDE OF GYPSUM BOARD CEILING AND OTHER SIDE UPTO STRUCTURE)
H	BOTH SIDES 5/8" MOISTURE RESISTANT GYP. BOARD (ONE SIDE TERMINATE 6" ABOVE ACT CEILING AND OTHER SIDE UPTO STRUCTURE)
I	BOTH SIDES 5/8" MOISTURE RESISTANT GYP. BOARD (UP TO 4' - 0" AFF)
J	ONE SIDE 5/8" PLYWOOD SUBSTRATE BOARD AND OTHER SIDE 48" 5/8" FT PLYWOOD FROM FLOOR TO 48" THEN 5/8" MOISTURE RESISTANT GYP. BOARD (BOTH SIDES UNDERSIDE OF GYPSUM BOARD CEILING)
K	ONE SIDE 5/8" TYPE "X" GYP. BOARD (UNDERSIDE OF GYPSUM BOARD CEILING)
L	ONE SIDE 5/8" PLYWOOD SUBSTRATE BOARD (UNDERSIDE OF GYPSUM BOARD CEILING)
M	48" 5/8" FT PLYWOOD FROM FLOOR TO 48" THEN 5/8" MOISTURE RESISTANT GYP. BOARD (TERMINATE 6" ABOVE ACT CEILING)
N	ONE SIDES 48" 5/8" FT PLYWOOD FROM FLOOR TO 48" THEN 5/8" MOISTURE RESISTANT GYP. BOARD AND OTHER SIDE 5/8" MOISTURE RESISTANT GYP. BOARD (ONE SIDE UNDERSIDE OF GYPSUM BOARD CEILING AND OTHER SIDE TERMINATE 6" ABOVE ACT CEILING)
O	48" 5/8" FT PLYWOOD FROM FLOOR TO 48" THEN 5/8" MOISTURE RESISTANT GYP. BOARD (UNDERSIDE OF GYPSUM BOARD CEILING)
P	ONE SIDE 5/8" MOISTURE RESISTANT GYP. BOARD (UPTO STRUCTURE)
INTERIOR MODIFIERS	
ai	ACOUSTIC INSULATION (FULL HEIGHT)
48	PARTIAL HEIGHT WALL. 16 GA METAL STUDS AT 16" O.C. W/ RCKW RIGID CONNECTORS AT FLOOR (MODIFIER = HEIGHT IN INCHES OR MILLIMETERS A.F.F.).

SYMBOL	ITEM	WEIGHT	HEIGHT A.F.F.	APPROX. WIDTH
A	ICE MACHINE AND DIVERTOR	TBD BY VENDOR (VARIES)	BLOCKING SPECIFICATION FOR ICE MACHINE CONTROL PANEL. REFER TO VENDOR'S SPECIFICATION AND DETAILS.	
B	UPPER CBE SHELVING/ CASEWORK		BLOCKING SPECIFICATION FOR CBE METAL SHELVES. REFER TO VENDOR'S SPECIFICATION AND DETAILS.	
C	RESTROOM GRAB BARS	200 LBS (91 KG)	30" TO 36" (760MM TO 915MM)	60" (1525MM) AROUND WATER CLOSET
D	SHELVES AT MANAGER'S DESK	300 LBS (136 KG)	32" TO 96" (810MM TO 2440MM)	48" (1220MM) 3/4 (19MM) ACX PLYWOOD, CENTERED ON SHELVES
E	EQUIPMENT RACK AT MANAGER'S DESK	300 LBS (136 KG)	44" TO 96" (1120MM TO 2440MM)	28" (710MM) 3/4 (19MM) ACX PLYWOOD, CENTERED ON RACK
F	DIAPER CHANGING STATION	250 LBS (113 KG)	40 1/2" TO 46 1/2" (1030MM TO 1180MM)	32" (810MM) BEHIND STATION
G	RESTROOM HAND SINK	200 LBS (91 KG)	COMMERCIAL INSTALLATION REQUIRES CONCEALED ARM CARRIER. REFER TO MFR'S SPECIFICATION.	
H	RESTROOM HAND DRYER	200LBS	36" TO 48" (915MM TO 1219MM)	24" STARTING 18" FROM WALL CORNER/SEE PLAN
I	MERCH BAY	TBD BY VENDOR (VARIES)	BLOCKING SPECIFICATION FOR MERCH BAY REFER TO VENDOR'S SPECIFICATION AND DETAILS.	
J	MILLWORK BOXES		BLOCKING SPECIFICATION FOR FRENCH CLEATING SYSTEM. REFER TO DETAILS.	
K	MENU BOARDS / ORDER STATUS BOARD HARDWARE	300 LBS (136 KG)	72" TO 112" (1829MM TO 2845MM)	EXTENT OF BACKBAR UPPER CASEWORK
L	ADAPTABLE CASEWORK	TBD BY VENDOR (VARIES)	BLOCKING SPECIFICATION FOR ADAPTABLE CASEWORK. REFER TO VENDOR'S SPECIFICATION AND DETAILS.	
M	ALL ARTWORK, FIXTURES ACCESSORIES AND CASEWORK FABRICATIONS NOT OTHERWISE NOTED	TBD BY VENDOR (VARIES)	GC TO PROVIDE WALL BLOCKING AS REQUIRED FOR ALL ITEMS FOR A COMPLETE AND SECURE INSTALLATION. EXTEND BLOCKING 8" (205MM) BEYOND ON EACH SIDE OF EACH ITEM.	
N	WATER FILTRATION SYSTEM	TBD BY VENDOR	COORDINATE LOCATION AND EXTENT WITH PENTAIR	
O	WORKROOM HAND SINK	128 LBS (58 KG)	36" TO 40" (915MM TO 1015MM)	30" (760MM) BEHIND SINK
P	SHELVES ABOVE COMPARTMENT SINK	200 LBS (91 KG)	48" TO 76" (1220MM TO 1930MM)	96" (2440MM) CENTERED ABOVE COMPARTMENT SINK


LEGEND

- NEW FULL HEIGHT WALL
- NEW PARTIAL HEIGHT WALL
- EXISTING WALL
- XX


WALL BLOCKING CALL OUT

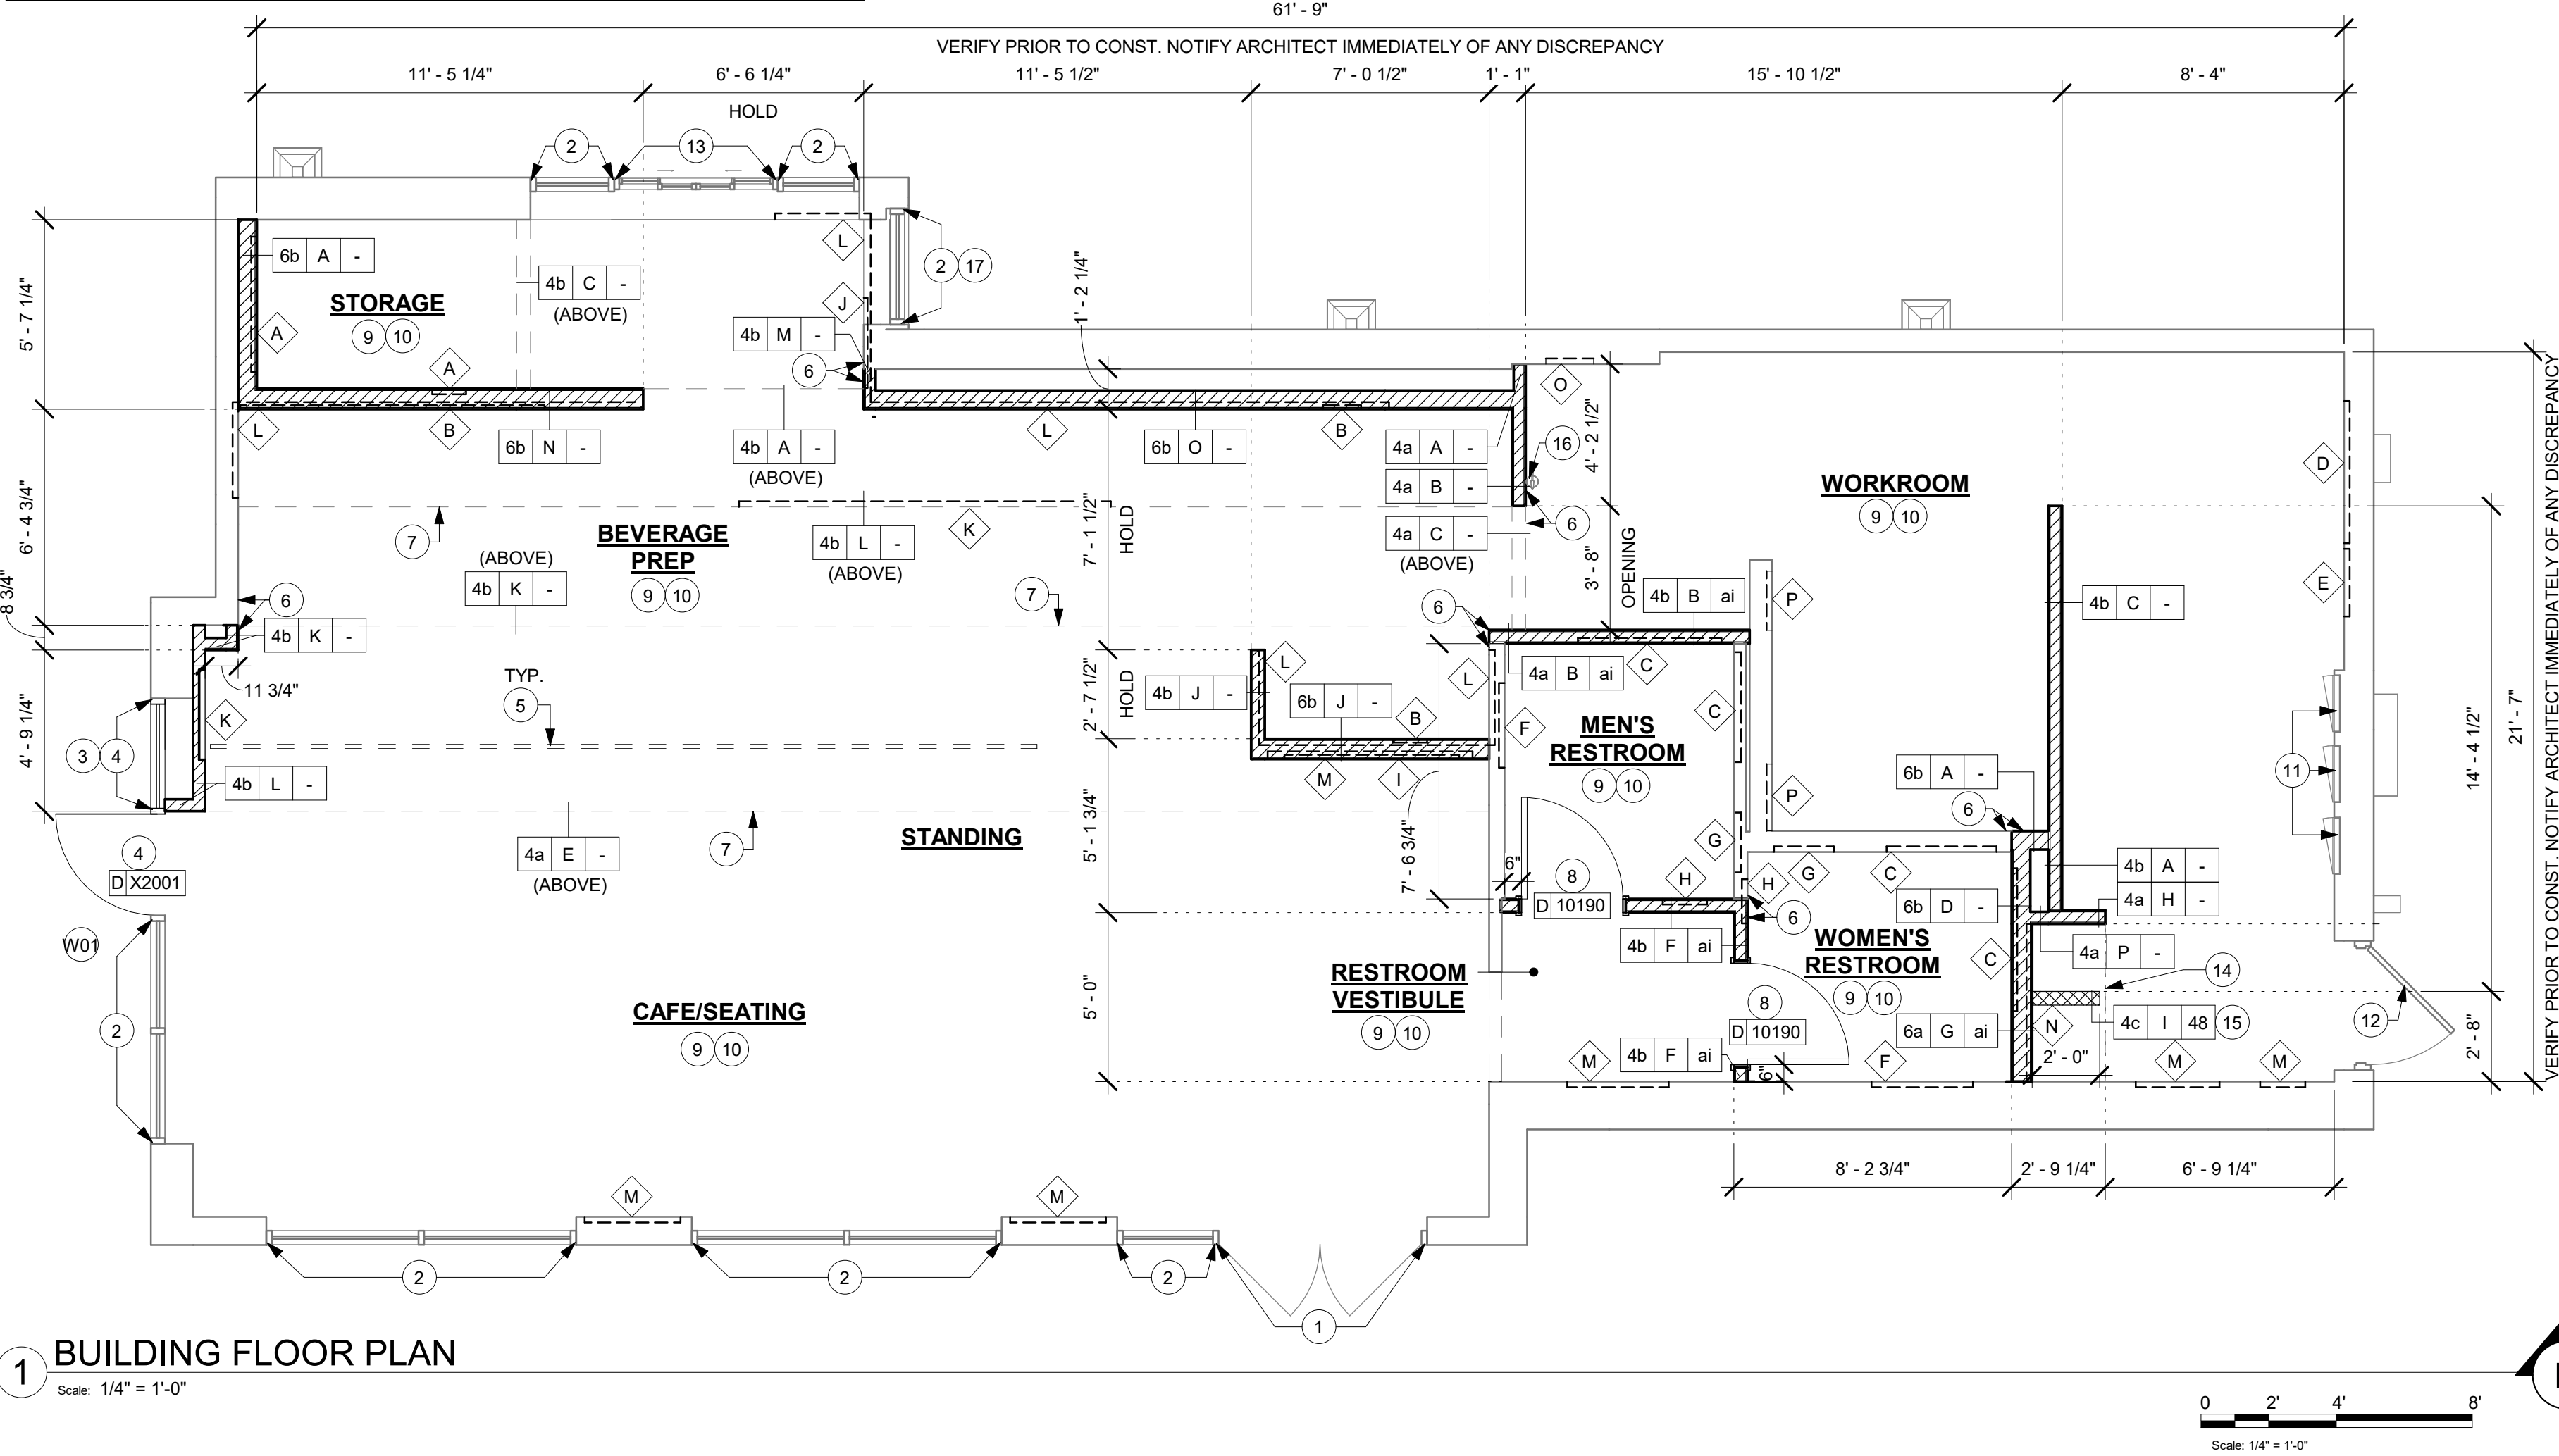


\\file-day.ad.changeupinc.com\Client\StarbucksArchitecture\Projects_2023\Florida\Semoran & Lee Vista - 25630-101\25630-101_9875_S Semoran Blvd & Lee Vista Blvd, FL_2023.rvt 3/4/2024 2:39:09 PM

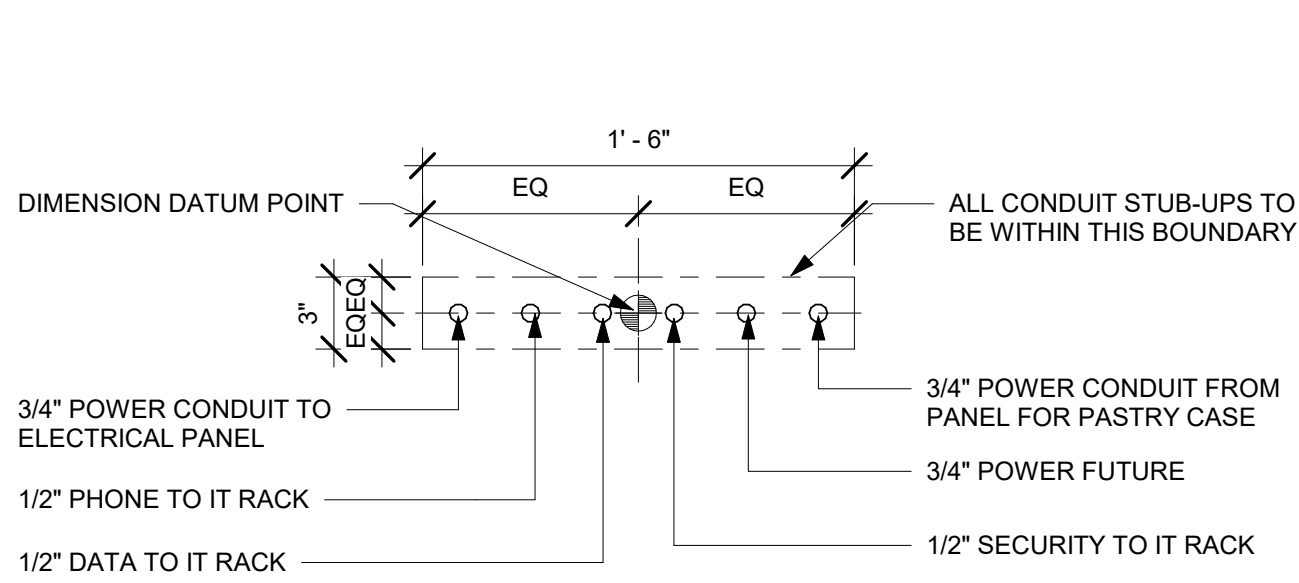

2 STUB UPS - DOUBLE POS/SAFE
Scale: 1 1/2" = 1'-0"

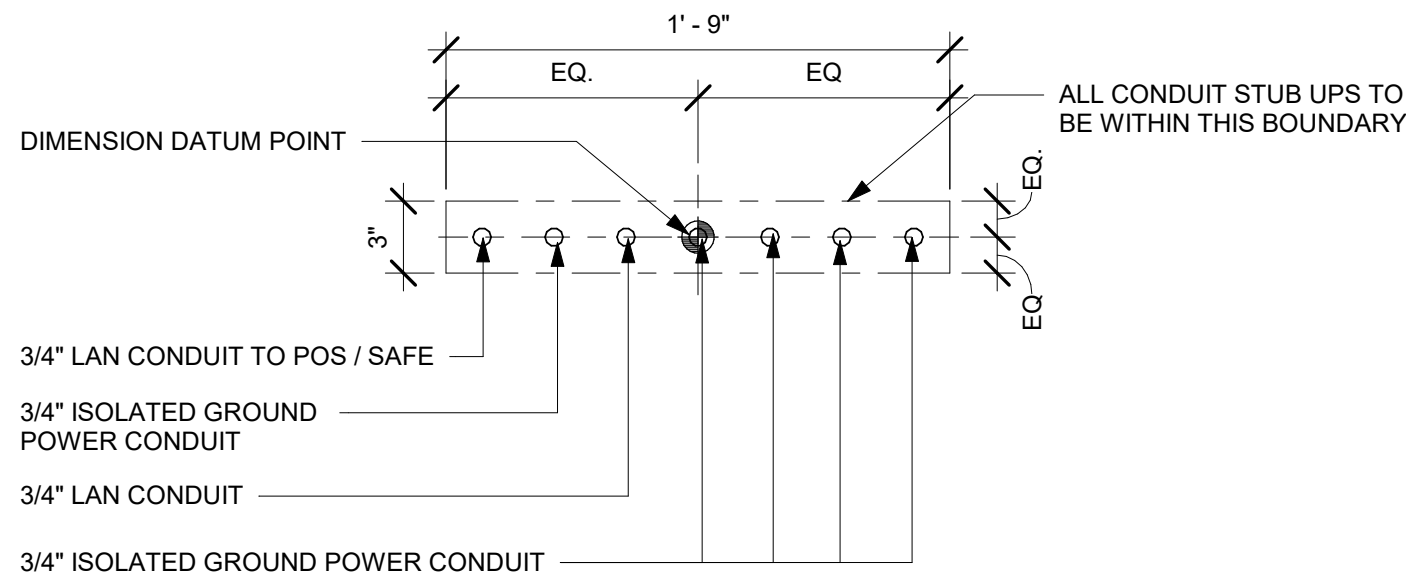

3 STUB UPS - FRONTBAR
Scale: 1 1/2" = 1'-0"

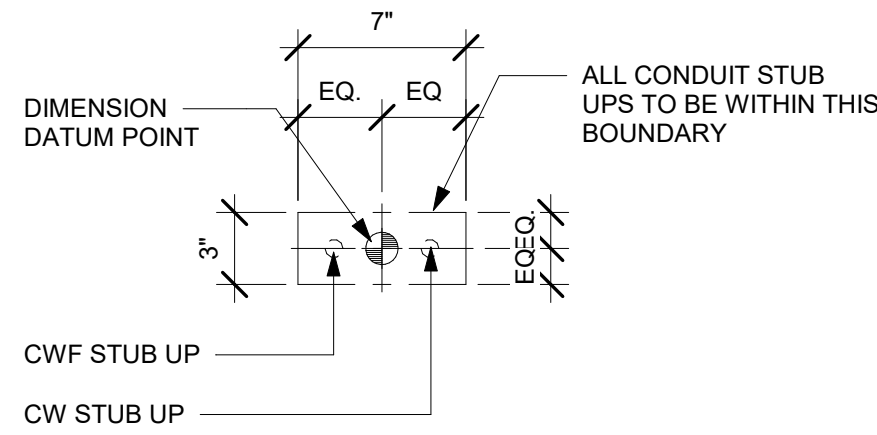

4 STUB UPS - ESPRESSO
Scale: 1 1/2" = 1'-0"


LEGEND

- FLOOR SINK
- FLOOR PENETRATION
- ELECTRICAL PENETRATION AREA
- DATUM POINT
- DRAIN FLOOR SINK (RESTROOMS)
- DATA OUTLET
- J-BOX



NOTE: SEE SHEET I-101.1 FOR PLUMBING FIXTURE SCHEDULE

KEYED NOTES

- ALL STUB-UP DIMENSIONS ARE RELATIVE TO FINISHED WALL LOCATIONS (SHOWN AS OUTLINES ON THIS PLAN). REFER TO FLOOR PLAN FOR WALL PLACEMENT.
- FLOOR SINK/ DRAIN/ CLEANOUT: REFER TO CUT SHEETS FOR COMPONENT SPECIFICATIONS AND CUTOUT REQUIREMENTS.
- NEW WASTE LINE PENETRATIONS: REFER TO PLUMBING PLANS FOR INDIVIDUAL LINE LOCATIONS.
- STUB-UP PENETRATIONS: REFER TO ELECTRICAL AND PLUMBING PLANS FOR INDIVIDUAL STUB-UP LOCATIONS.
- RELOCATED TOILET FLOOR PENETRATION: REFER TO CUT SHEETS FOR STUB-UP LOCATION RELATIVE TO FINISHED WALL.
- RELOCATED FLOOR PENETRATIONS AT MOP SINK.
- PENETRATION TO BE LOCATED ON CENTERLINE OF WALL OR AS REQUIRED PER CONDITIONS.
- LOCATION OF POWER AND DATA OUTLETS BEHIND MENU BOARDS AND ORDER STATUS BOARD. CENTER OUTLETS BEHIND MENU BOARDS AND ORDER STATUS BOARD. REFER TO DETAIL 2/I-511 FOR MORE INFORMATION.
- REFER TO SHEET I-106 FOR FLOOR FINISHES.
- LOCATION OF EXISTING OUTLET.
- LOCATION OF ALL SWITCHING.
- EXISTING WASTE LINE PENETRATIONS: REFER TO PLUMBING PLANS FOR INDIVIDUAL LINE LOCATIONS.
- EXISTING TOILET FLOOR PENETRATION: REFER TO CUT SHEETS FOR STUB-UP LOCATION RELATIVE TO FINISHED WALL.
- LOCATION OF EXISTING GFCI OUTLET.

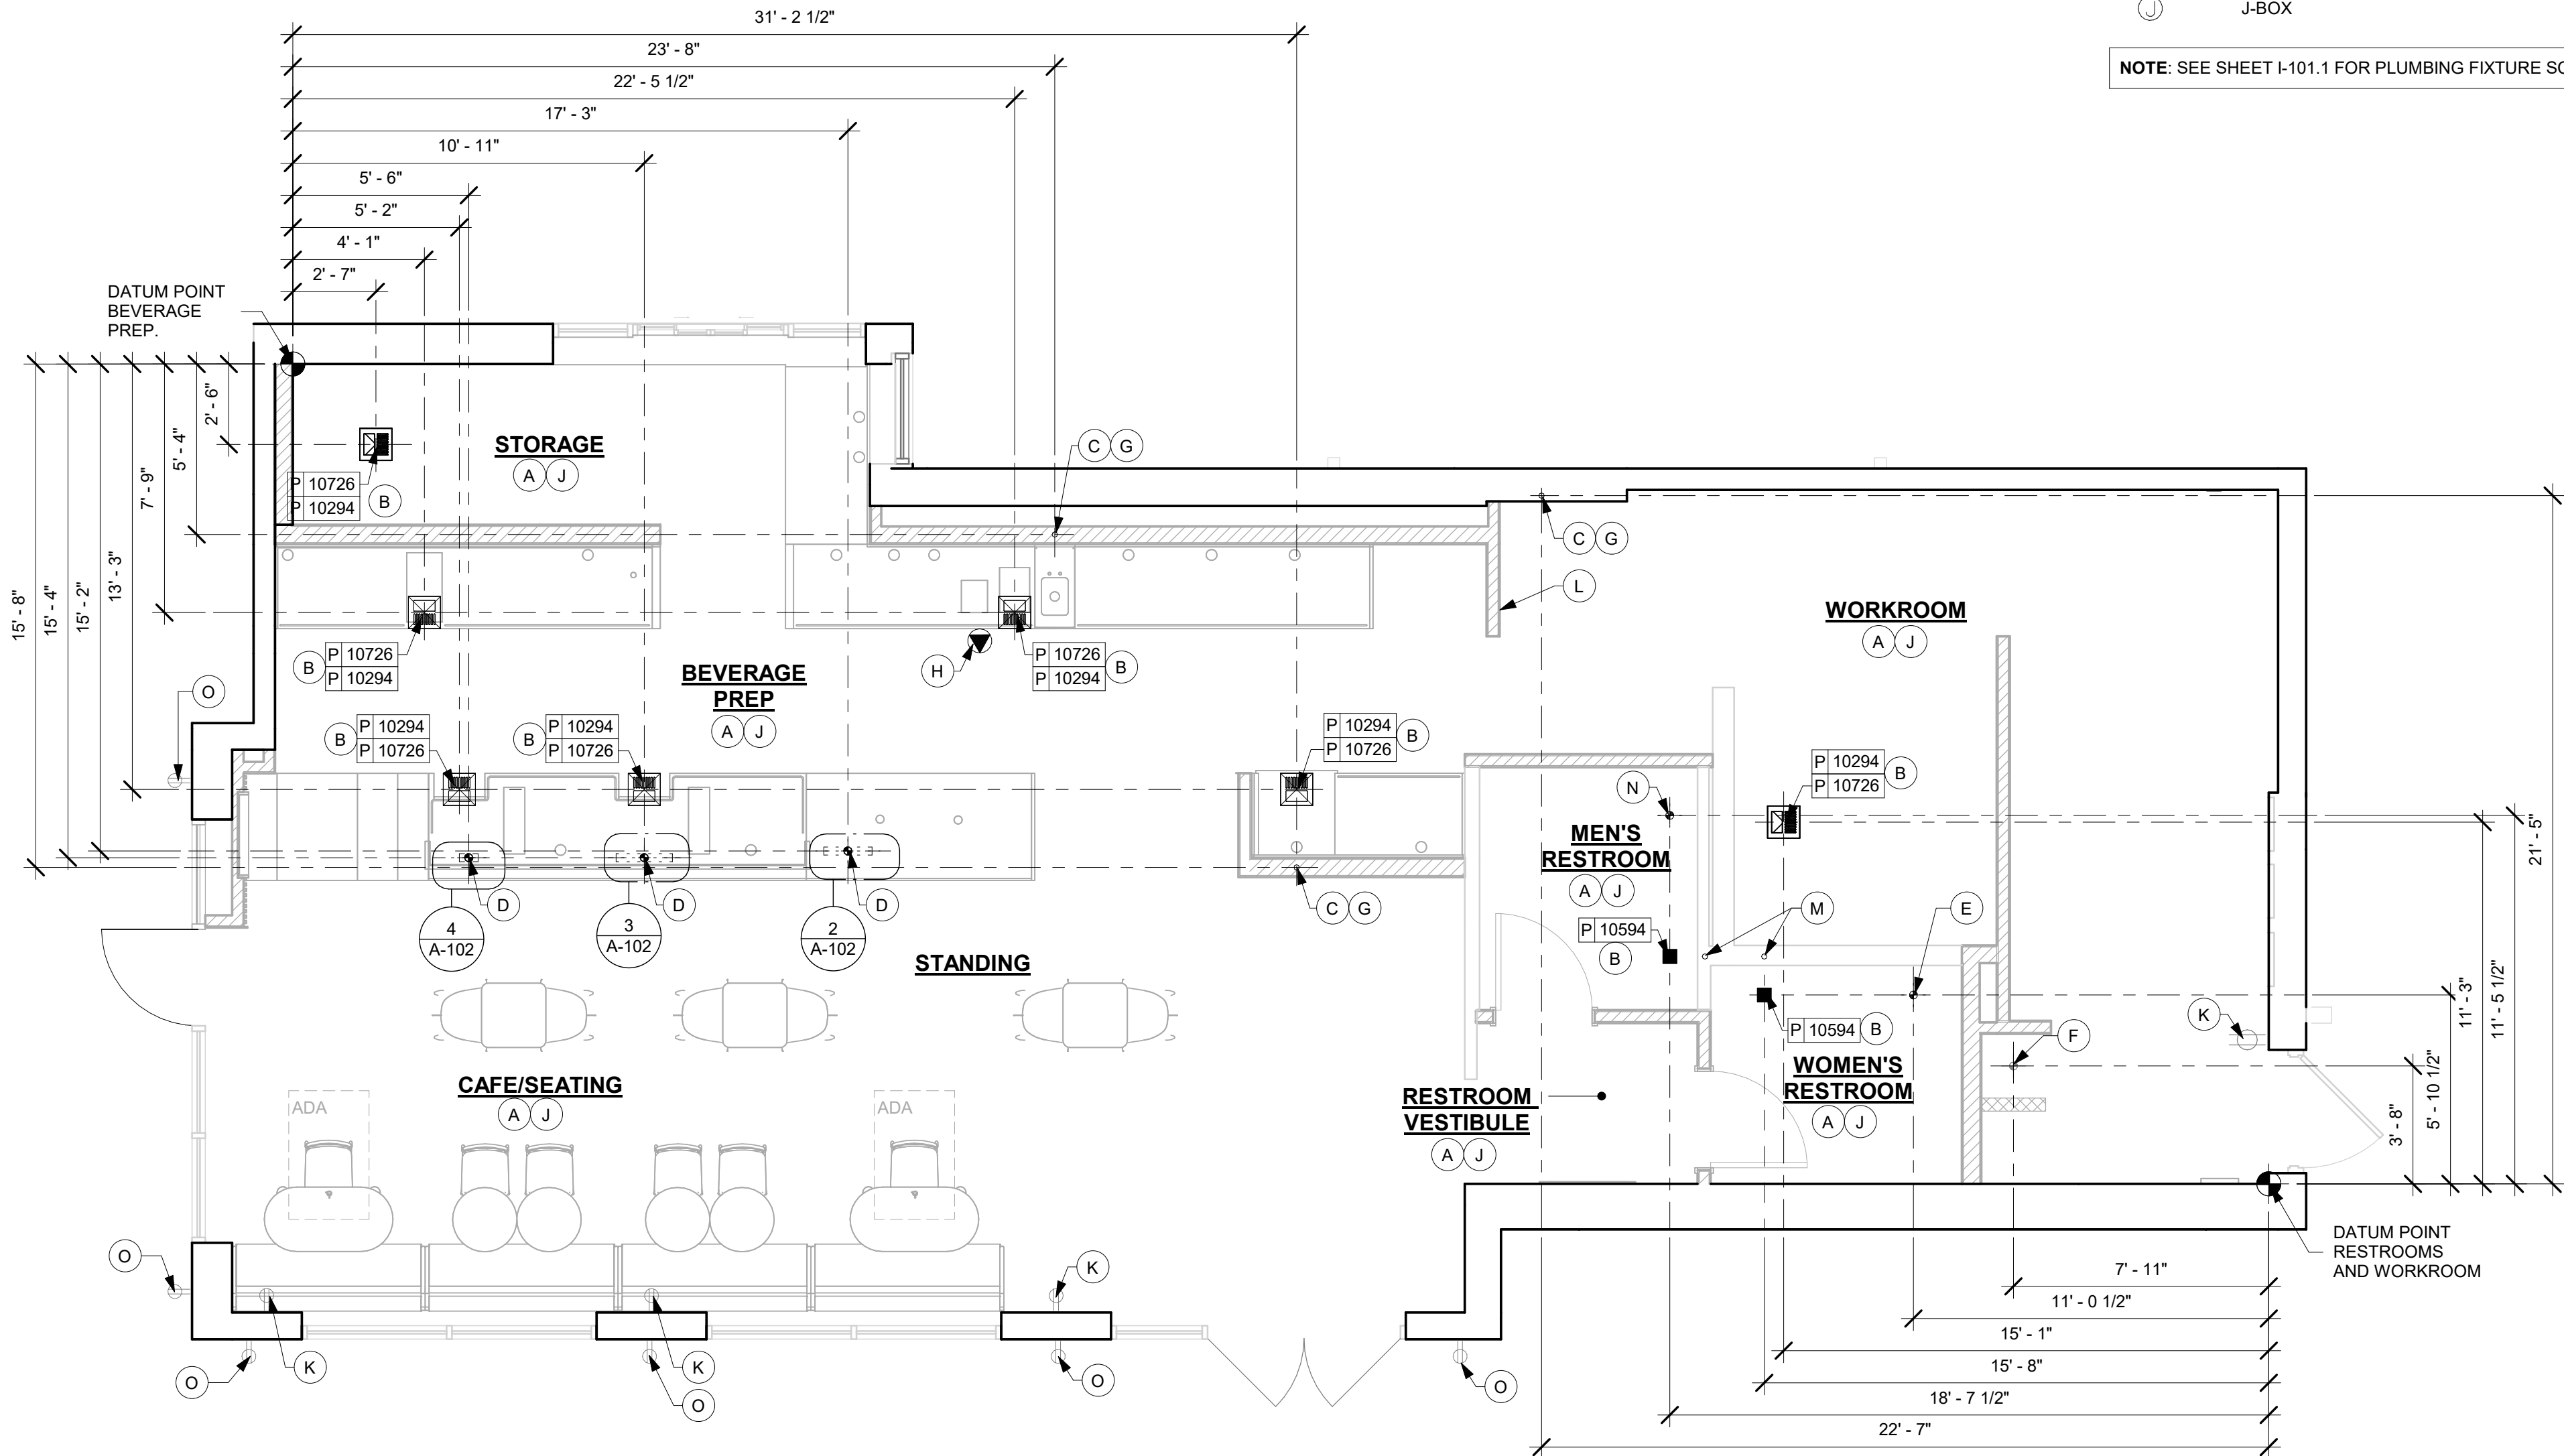

1 BUILDING FLOOR PENETRATION PLAN
Scale: 1/4" = 1'-0"

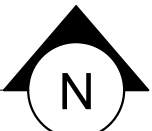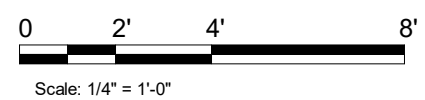

© 2023 STARBUCKS COFFEE COMPANY

STARBUCKS®
2401 UTAH AVENUE SOUTH
SEATTLE, WASHINGTON 98134
(206) 318-1575

THESE DRAWINGS AND THE PROJECT MANUAL ARE CONFIDENTIAL AND SHALL REMAIN THE SOLE PROPERTY OF STARBUCKS CORPORATION, WHICH IS THE OWNER OF THE COPYRIGHT IN THIS WORK. THEY SHALL NOT BE REPRODUCED IN WHOLE OR IN PART, SHARED WITH THIRD PARTIES OR USED IN ANY MANNER ON OTHER PROJECTS OR EXTENSIONS TO THIS PROJECT WITHOUT THE PRIOR WRITTEN CONSENT OF STARBUCKS CORPORATION. THESE DRAWINGS AND SPECIFICATIONS ARE INTENDED TO EXPRESS DESIGN INTENT FOR A PROTOTYPICAL STARBUCKS STORE (WHICH IS SUBJECT TO CHANGE AT ANYTIME) AND DO NOT REFLECT ACTUAL SITE CONDITIONS. NEITHER PARTY SHALL HAVE ANY OBLIGATION NOR LIABILITY TO THE OTHER (EXCEPT STATED ABOVE) UNTIL A WRITTEN AGREEMENT IS FULLY EXECUTED BY BOTH PARTIES.

STARBUCKS TEMPLATE VERSION: i2023.10.23

Design Forum Architects Inc.

2050 Byers Rd
Miami, FL 33134
Tel: (305) 804-7700

Donald J. Rehman
Architect in Charge
License: AR0017303

MARQUE ENGINEERING

2230 PARK AVE, STE. 100, CINCINNATI, OH 45206
513.457.7131 - WWW.MARQUEENG.COM

FOR CONSTRUCTION

PROJECT NAME:
S SEMORAN BLVD & LEE VISTA BLVD

PROJECT ADDRESS:
**6605 S SEMORAN BLVD
ORLANDO, FL 32822**

STORE #: 9875
PROJECT #: 25630-101
ISSUE DATE: 03/04/2024
DESIGN MANAGER: MARTIN PEREZ
PRODUCTION DESIGNER: ANDY MCLOUD
CHECKED BY: DONALD REHMAN

Revision Schedule			
Rev	Date	By	Description


SHEET TITLE:
BUILDING FLOOR PENETRATION PLAN
SCALE: AS SHOWN

SHEET NUMBER:
A-102

\\file-day.ad.changeupinc.com\Client\StarbucksArchitecture\Projects_2023\Florida\Semoran & Lee Vista - 25630-10\25630-101_9875_S Semoran Blvd & Lee Vista Blvd, FL_2023.rvt 3/4/2024 2:39:11 PM


PAINT SCHEDULE					
COLOR CODE	DESCRIPTION	LRV	FURN. BY	INST. BY	COMMENTS
SW6991-SG	SW - BLACK MAGIC - EGGSHELL	3	GC	GC	USE PRIMER CP-1
SW7020-ES	SW - BLACK FOX - EGGSHELL	7	GC	GC	USE PRIMER CP-1
SW7031-ES	SW - MEGA GREIGE - EGGSHELL	37	GC	GC	USE PRIMER CP-1
SW7039-ES	SW - VIRTUAL TAUPE - EGGSHELL	20	GC	GC	USE PRIMER CP-1
SW7631-ES	SW - CITY LOFT - EGGSHELL	70	GC	GC	USE PRIMER CP-1

CEILING TREATMENT SCHEDULE - "U"					
DESIGN ID	AREA	DESCRIPTION	FURN. BY	INST. BY	COMMENTS
OTHER					
19734	174 SF	ACT - ULTIMA - 2X2FT 61X61CM	GC	GC	DESIGN TO SPECIFY WHITE, OR CUSTOM COLOR, FOR ORDERING CONTACT DEB PICKENS AT DPLPICKENS@ARMSTRONGCEILINGS.COM, PH. 480-695-9053, FACTORY FINISHED TO MATCH SW9169 CHATURA GRAY
X11302	31 SF	ACT - WHITE - 2X4FT 61X122CM	GC	GC	VINYL CLAD AT STORAGE
X11303	330 SF	ACT - WHITE - 2X2FT 61X61CM - MATCH TO EXISTING	GC	GC	VINYL CLAD AT BOH

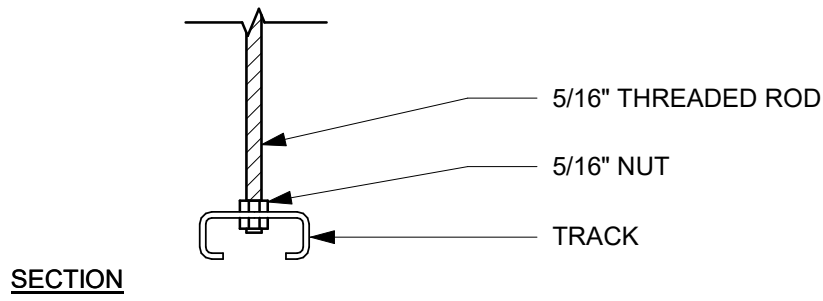

2 TRACK LIGHTING - SUSPENDED MOUNT

Scale: 3" = 1'-0"

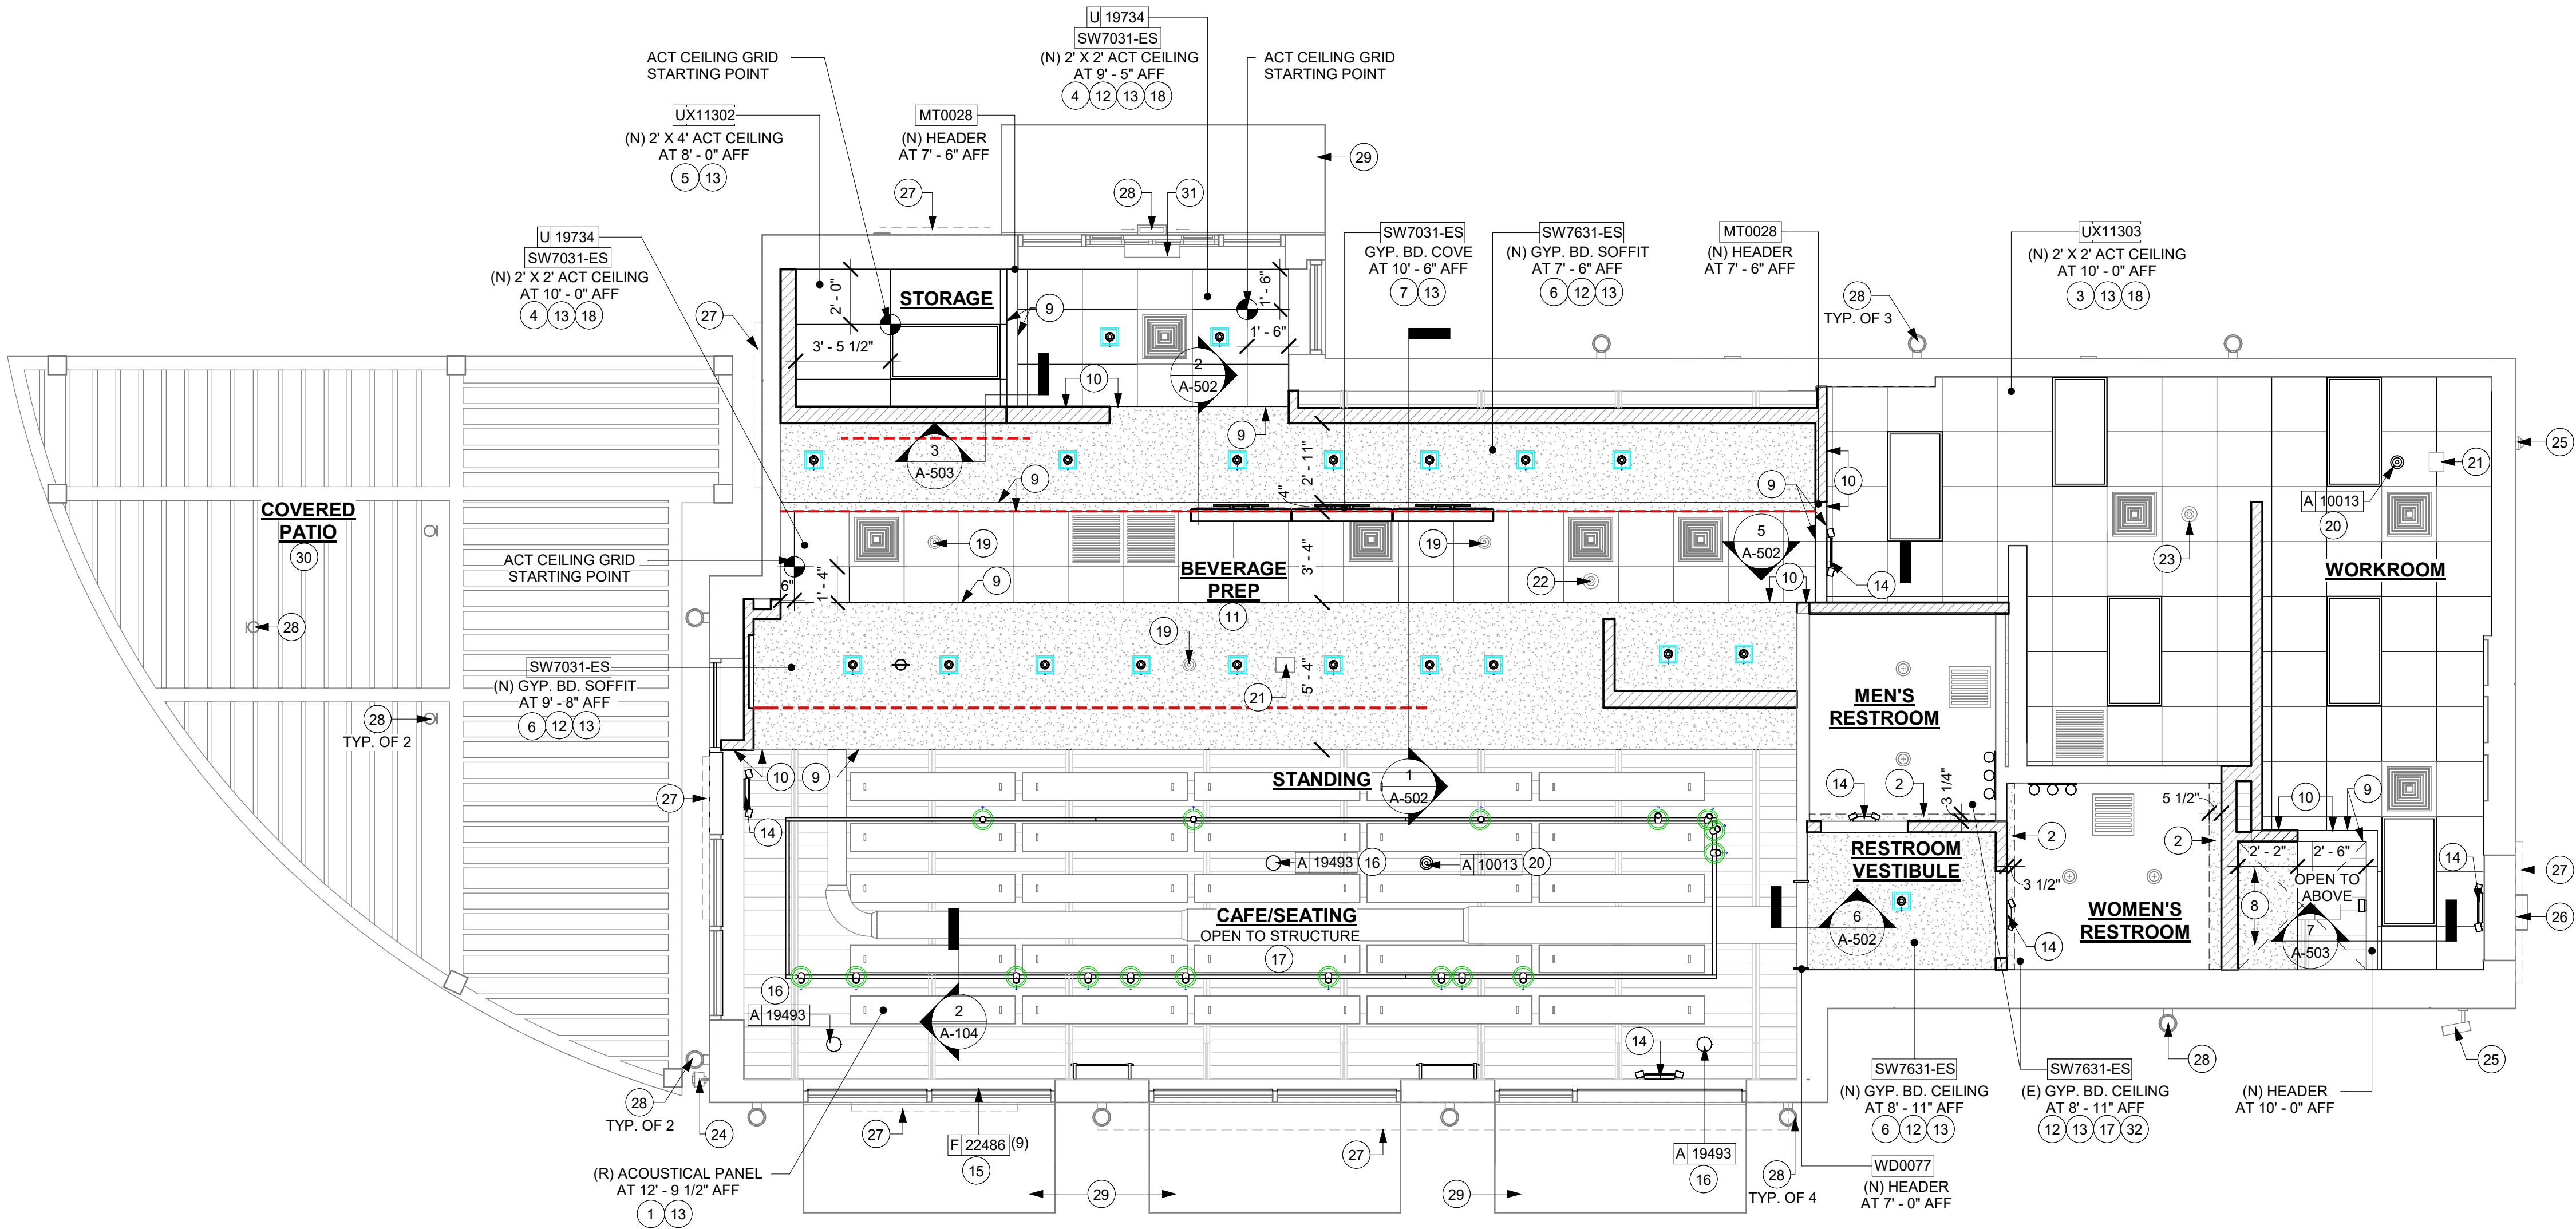

1 REFLECTED CEILING PLAN

Scale: 1/4" = 1'-0"

LIGHTING LEGEND

	CAN - LED ADJUSTABLE RECESSED - 3IN 75MM - BLACK - 1155LM FLOOD	L X7001
	TRACK - LED FIXTURE WITH SNOOT - 3IN 75MM - BLACK - 1100LM FLOOD	L 21779
	STRIP - LED TAPE - VARIABLE LENGTH - 350LM PER FT	L 22217

RESPONSIBILITY LEGEND

FURN. BY	INST. BY
GC - FURNISHED BY GENERAL CONTRACTOR	GC - INSTALLED BY GENERAL CONTRACTOR
SB - FURNISHED BY STARBUCKS	SB - INSTALLED BY STARBUCKS
VD - FURNISHED BY VENDOR	VD - INSTALLED BY VENDOR

NOTE:
ALL RESPONSIBILITIES TO BE CONFIRMED WITH STARBUCKS CONSTRUCTION MANAGER PRIOR TO ORDERING / CONSTRUCTION.

LEGEND

	DUM
	TRACK LIGHTING
	STRIP LIGHTING
	PENDANT LIGHT
	RECESSED CAN LIGHT
	TROFFER
	RESTROOM WALL SCONCE
	CAFE WALL SCONCE
	EXTERIOR WALL SCONCE
	EXIT SECURITY LIGHT
	MUSIC SYSTEM SPEAKER
	MUSIC SYSTEM PENDANT SPEAKER
	WIFI ACCESS POINT (WAP)
	SECURITY CAMERA
	SUPPLY AIR
	RETURN AIR
	WALL SCONCE

GENERAL NOTES

- IF REQUIRED BY LOCAL CODE, GENERAL CONTRACTOR TO PROVIDE SEMI-RECESSED SPRINKLER HEADS WITH POLISHED CHROME ESCUTCHEONS CENTERED IN ACOUSTICAL CEILING TILE. IF PENDANT HEADS ARE REQUIRED IN GWB SOFFIT OVER FRONTBAR, CONCEAL SUPPLY PIPING WITHIN SOFFIT. GENERAL CONTRACTOR TO SUBMIT SPRINKLER LAYOUT TO STARBUCKS' CONSTRUCTION MANAGER FOR APPROVAL PRIOR TO INSTALLATION.
- LEAVE TEN (10) ADDITIONAL RETAIL CEILING TILES TO MATCH RETAIL CEILING PAINT COLOR ABOVE THE WORKROOM CEILING AT MANAGER'S DESK FOR FUTURE USE.
- PROVIDE GROMMET AT ACOUSTIC CEILING PENETRATIONS FOR FIXTURES OF SUPPORTS.
- HEATING, VENTILATING AND AIR CONDITIONING SHOWN ON THIS PLAN PROVIDED FOR REFERENCE ONLY. SEE MECHANICAL DRAWINGS FOR ADDITIONAL INFORMATION.
- DIFFUSERS AND RETURNS IN ACOUSTICAL CEILING TILE TO BE CENTERED IN TILE AND PAINTED TO MATCH ADJACENT FINISHES (TYP.).
- PAINT ALL EXPOSED HVAC DUCTS, HVAC DIFFUSERS, LIGHT TRIM RINGS, PIPING, CONDUIT AND JUNCTION BOXES THE SAME COLOR AS SPECIFIED ON SURROUNDING CEILING OR SOFFIT UNLESS OTHERWISE NOTED. TYPICAL THROUGHOUT RETAIL AREA OF STORE.
- PAINT SUBSTITUTIONS ARE NOT ALLOWED. USE STARBUCKS' NATIONAL ACCOUNT "COLOR CODE" WHEN ORDERING PAINTS.

KEYED NOTES

- RELOCATED ACOUSTICAL PANELS.
- EXTEND OF NEW GYPSUM CEILING. ALIGN NEW CEILING WITH EXISTING (PAINT AS SCHEDULED).
- INSTALL NEW 2' X 2' ACT CEILING AS INDICATED.
- INSTALL 2' X 2' ACT CEILING TILE AS INDICATED (PAINT AS SCHEDULED).
- INSTALL NEW 2' X 4' ACT CEILING LOCATED IN STORAGE AS INDICATED.
- GW.B. CEILING / SOFFIT WITH SMOOTH FINISH (PAINT AS SCHEDULED).
- GW.B. COVE WITH SMOOTH FINISH (PAINT AS SCHEDULED).
- NEW PLATFORM FOR HEATER AND WATER FILTRATION. PROVIDE SOFFIT AND LIFT CEILING THIS AREA ONLY TO ENSURE ADEQUATE CLEARANCE FOR SERVICING. ADJACENT CEILING COLOR.
- LINE OF NEW SOFFIT / HEADER / BULKHEAD.
- ALIGN FINISHED SURFACES.
- REFER TO INTERIOR ELEVATIONS FOR MENU BOARD SPACING.
- PAINT RECESSED LIGHTING TRIM TO MATCH CEILING AS CLOSELY AS POSSIBLE.
- REFER TO SHEET A-105 FOR LIGHTING DIMENSIONS AND INFORMATION.
- LOCATIONS OF ALL EGRESS LIGHTING FOR REFERENCE ONLY. GC TO VERIFY WITH LOCAL FIRE MARSHAL PRIOR TO INSTALLATION.
- INSTALL NEW ROLLER SHADES AS INDICATED.
- INSTALL NEW SUSPENDED SPEAKER AS INDICATED. (REFER INTERIOR ELEVATION FOR MOUNTING HEIGHT).
- EXISTING HVAC DUCTWORK / SUPPLY / RETURN DIFFUSER GRILLES.
- RELOCATED HVAC SUPPLY / RETURN DIFFUSER GRILLES.
- RELOCATED INTERIOR SECURITY CAMERA.
- INSTALL NEW INTERIOR SECURITY CAMERA AS INDICATED.
- RELOCATED WIFI DEVICE.
- RELOCATED FIRE ALARM / STROBE.
- EXISTING FIRE ALARM / STROBE.
- EXISTING EXTERIOR WALL MOUNTED SPEAKER.
- EXISTING EXTERIOR WALL MOUNTED SECURITY CAMERA.
- EXISTING EXTERIOR SECURITY LIGHT.
- INSTALL NEW EXTERIOR BUILDING SIGNAGE.
- EXISTING EXTERIOR WALL SCONCE.
- EXISTING EXTERIOR AWNING.
- EXISTING PATIO WOOD TRELLIS.
- EXISTING DT AIR CURTAIN.
- EXISTING GYPSUM BOARD CEILING. PATCH AND REPAIR CEILING AS REQUIRED FOR NEW WORK (PAINT AS SCHEDULED).



STARBUCKS®
2401 UTAH AVENUE SOUTH
SEATTLE, WASHINGTON 98134
(206) 318-1575

THESE DRAWINGS AND THE PROJECT MANUAL ARE CONFIDENTIAL AND SHALL REMAIN THE SOLE PROPERTY OF STARBUCKS CORPORATION, WHICH IS THE OWNER OF THE COPYRIGHT IN THIS WORK. THEY SHALL NOT BE REPRODUCED IN WHOLE OR IN PART, SHARED WITH THIRD PARTIES OR USED IN ANY MANNER ON OTHER PROJECTS OR EXTENSIONS TO THIS PROJECT WITHOUT THE PRIOR WRITTEN CONSENT OF STARBUCKS CORPORATION. THESE DRAWINGS AND SPECIFICATIONS ARE INTENDED TO EXPRESS DESIGN INTENT FOR A PROTOTYPICAL STARBUCKS STORE (WHICH IS SUBJECT TO CHANGE AT ANYTIME) AND DO NOT REFLECT ACTUAL SITE CONDITIONS. NEITHER PARTY SHALL HAVE ANY OBLIGATION NOR LIABILITY TO THE OTHER (EXCEPT STATED ABOVE) UNTIL A WRITTEN AGREEMENT IS FULLY EXECUTED BY BOTH PARTIES.

STARBUCKS TEMPLATE VERSION: i2023.10.23

Design Forum Architects Inc.
2050 Byers Rd
Miamisburg, OH 45342
Tel: (844) 804-7700

Donald J. Rethman
Architect In Charge
License: AR0017303

MARQUE ENGINEERING
2230 PARK AVE, STE. 100, CINCINNATI, OH 45206
513.457.7131 - WWW.MARQUEENG.COM

FOR CONSTRUCTION

PROJECT NAME:
S SEMORAN BLVD & LEE VISTA BLVD

PROJECT ADDRESS:
**6605 S SEMORAN BLVD
ORLANDO, FL 32822**

STORE #: 9875
PROJECT #: 25630-101
ISSUE DATE: 03/04/2024
DESIGN MANAGER: MARTIN PEREZ
PRODUCTION DESIGNER: ANDY MCLOUD
CHECKED BY: DONALD RETHMAN



Revision Schedule			
Rev	Date	By	Description

SHEET TITLE:
REFLECTED CEILING PLAN

SCALE: AS SHOWN

SHEET NUMBER:

A-104

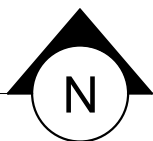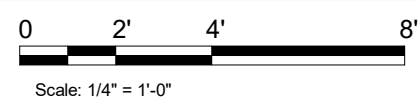

\\file-day.ad.changeupinc.com\Client\StarbucksArchitecture\Projects_2023\Florida\Semoran & Lee Vista - 25630-10\25630-101_9875_S Semoran Blvd & Lee Vista Blvd, FL_2023.rvt 3/4/2024 2:39:19 PM

LIGHTING FIXTURE SCHEDULE - "L"						
DESIGN ID	COUNT	DESCRIPTION	FURN. BY	INST. BY	BULB	COMMENTS
EXIT						
19047	4	LED EXIT SIGN WITH EMERGENCY LIGHT - BLACK AND GREEN	SB	GC	INTEGRATED LED	
19057	2	LED EMERGENCY LIGHT DOUBLE - BLACK	SB	GC	INTEGRATED LED	
PENDANT						
X7002	1	PENDANT - MATTEO ASTRO SKU: C80701BKOP / COLOR: BLACK	SB	GC	(1) 25W E12 BASE	
RECESSED CAN						
21774	20	CAN - LED ADJUSTABLE RECESSED - 3IN 75MM - BLACK - 1155LM FLOOD	SB	GC	INTEGRATED LED	WITH DIMMER.
SCONCE						
20719	2	SCONCE - JUNIPER THIN - 24IN 610MM - BLACK OXIDE	SB	GC	INTEGRATED LED	
20748	2	SCONCE - KUZCO PLUTO TRIPLE - CHROME	SB	GC	INTEGRATED LED	
20778	1	SCONCE - RBW CRISP - FROSTED	SB	GC	INTEGRATED LED	
STRIP						
22215	2	STRIP - LED TAPE IN HOUSING - VARIABLE LENGTH - BLACK - 350LM PER FT	SB	GC	INTEGRATED LED	FIELD TRIMMABLE TO 0.9IN LENGTHS (V.I.F) (1) 24' - 0" (1) 0' - 6"
22217	3	STRIP - LED TAPE - VARIABLE LENGTH - 350LM PER FT	SB	GC	INTEGRATED LED	FIELD TRIMMABLE TO 0.9IN LENGTHS (V.I.F); LENGTH REQUIRED: (1) 24' - 0" (1) 13' - 8" (1) 6' - 10"
TRACK						
12949	6	TRACK - WITH CONNECTORS - 12FT 365CM - BLACK - 1 CIRCUIT	SB	GC		ALL BAR / CAFE TRACK LIGHTING TO BE RUN THROUGH 1A / 2A CURRENT LIMITING DEVICE #RCLF12BL-TCL2BL; SEE ELECTRICAL DRAWINGS FOR ADDITIONA INFORMATION
15058	2	TRACK - WITH CONNECTORS - 6FT 183CM - BLACK - 1 CIRCUIT	SB	GC		ALL BAR / CAFE TRACK LIGHTING TO BE RUN THROUGH 1A / 2A CURRENT LIMITING DEVICE #RCLF12BL-TCL2BL; SEE ELECTRICAL DRAWINGS FOR ADDITIONA INFORMATION
21779	17	TRACK - LED FIXTURE WITH SNOOT - 3IN 75MM - BLACK - 1100LM FLOOD	SB	GC	INTEGRATED LED	
TROFFER						
23055	7	TROFFER - LED RECESSED - 24X48IN 600X1200MM - WHITE - 2700K	SB	GC	INTEGRATED LED	

RESPONSIBILITY LEGEND

FURN. BY	INST. BY
GC - FURNISHED BY GENERAL CONTRACTOR	GC - INSTALLED BY GENERAL CONTRACTOR
SB - FURNISHED BY STARBUCKS	SB - INSTALLED BY STARBUCKS
VD - FURNISHED BY VENDOR	VD - INSTALLED BY VENDOR

NOTE:
ALL RESPONSIBILITIES TO BE CONFIRMED WITH STARBUCKS CONSTRUCTION MANAGER PRIOR TO ORDERING / CONSTRUCTION.

LEGEND

	DATUM
	TRACK LIGHTING
	STRIP LIGHTING
	PENDANT LIGHT
	RECESSED CAN LIGHT
	TROFFER
	RESTROOM WALL SCONCE
	CAFE WALL SCONCE
	EXTERIOR WALL SCONCE
	EXIT SECURITY LIGHT
	MUSIC SYSTEM SPEAKER
	MUSIC SYSTEM PENDANT SPEAKER
	WIFI ACCESS POINT (WAP)
	SECURITY CAMERA
	SUPPLY AIR
	RETURN AIR
	WALL SCONCE

LIGHTING LEGEND


	CAN - LED ADJUSTABLE RECESSED - 3IN 75MM - BLACK - 1155LM FLOOD	L X7001
	TRACK - LED FIXTURE WITH SNOOT - 3IN 75MM - BLACK - 1100LM FLOOD	L 21779
	STRIP - LED TAPE - VARIABLE LENGTH - 350LM PER FT	L 22217

GENERAL NOTES

- WHERE ACOUSTICAL CEILING MEETS WALL, PROVIDE ANGLE WALL MOULDING FOR REVEAL. MATCH CEILING GRID COLOR WHEN APPLICABLE.
- PAINT SUBSTITUTIONS ARE NOT ALLOWED. USE STARBUCKS' NATIONAL ACCOUNT "COLOR CODE" WHEN ORDERING PAINTS. SEE SHEET I-602 FOR PAINT SCHEDULES.
- ALL FIXTURES IN FOOD PREPARATION AREA SHALL HAVE SHATTERPROOF LAMPS IF THE FIXTURE IS NOT LENSED.
- PROVIDE GROMMET AT ALL CEILING PENETRATIONS FOR FIXTURES/SUPPORTS.
- ADJUST FOCUS OF ALL TRACK AND RECESSED DIRECTIONAL LIGHTING TO FULLY ILLUMINATE ALL ARTWORK, MENU BOARDS AND MERCHANDISE BAYS.
- IF PENDANT SUSPENDED LENGTH EXCEEDS 48" (1220MM) FROM CEILING, REPLACE WITH SURFACE-MOUNTED PENDANT AND SUSPEND WITH GC-SUPPLIED CONDUIT AND J-BOX TO DIMENSIONED HEIGHT.
- CENTER EMERGENCY/EXIT LIGHTS ABOVE DOORS, UON.

KEYED NOTES

- INSTALL NEW RECESSED CAN LIGHTS AS INDICATED. (CENTER ON ACT WHERE APPLICABLE).
- INSTALL NEW RECESSED CAN LIGHTS IN GYPSUM CEILING AS INDICATED.
- INSTALL NEW RECESSED TROFFER LIGHT AS INDICATED.
- INSTALL NEW WALL SCONCE AT WATER FILTRATION BULKHEAD AS INDICATED.
- EXISTING RECESSED CAN LIGHTS.
- INSTALL NEW SUSPENDED TRACK LIGHTING AS INDICATED. REFER TO INTERIOR ELEVATION FOR MOUNTING HEIGHT.
- INSTALL NEW LED STRIP LIGHT AT COVE AS INDICATED.
- INSTALL NEW LED STRIP AT B.O. UPPER CBE CABINET WITH METAL ANGLE TRIM AS INDICATED.
- INSTALL NEW LED STRIP LIGHT AT FRONT BAR COUNTER AS INDICATED.
- INSTALL NEW PENDANT LIGHT AT ENGINE AREA AS INDICATED. REFER TO INTERIOR ELEVATION FOR MOUNTING HEIGHT.
- INSTALL NEW WALL SCONCES AT CAFE AREA AS INDICATED. REFER TO INTERIOR ELEVATION FOR MOUNTING HEIGHT.
- INSTALL NEW RESTROOM SCONCE AS INDICATED. REFER TO RR ELEVATIONS FOR MOUNTING HEIGHT.
- EXISTING EXTERIOR WALL SCONCES.
- LOCATIONS OF ALL EGRESS LIGHTING FOR REFERENCE ONLY. GC TO VERIFY WITH LOCAL FIRE MARSHAL PRIOR TO INSTALLATION.
- EXISTING EXTERIOR SECURITY LIGHT.
- INSTALL WITH BATTERY PACK FOR EMERGENCY LIGHTING.

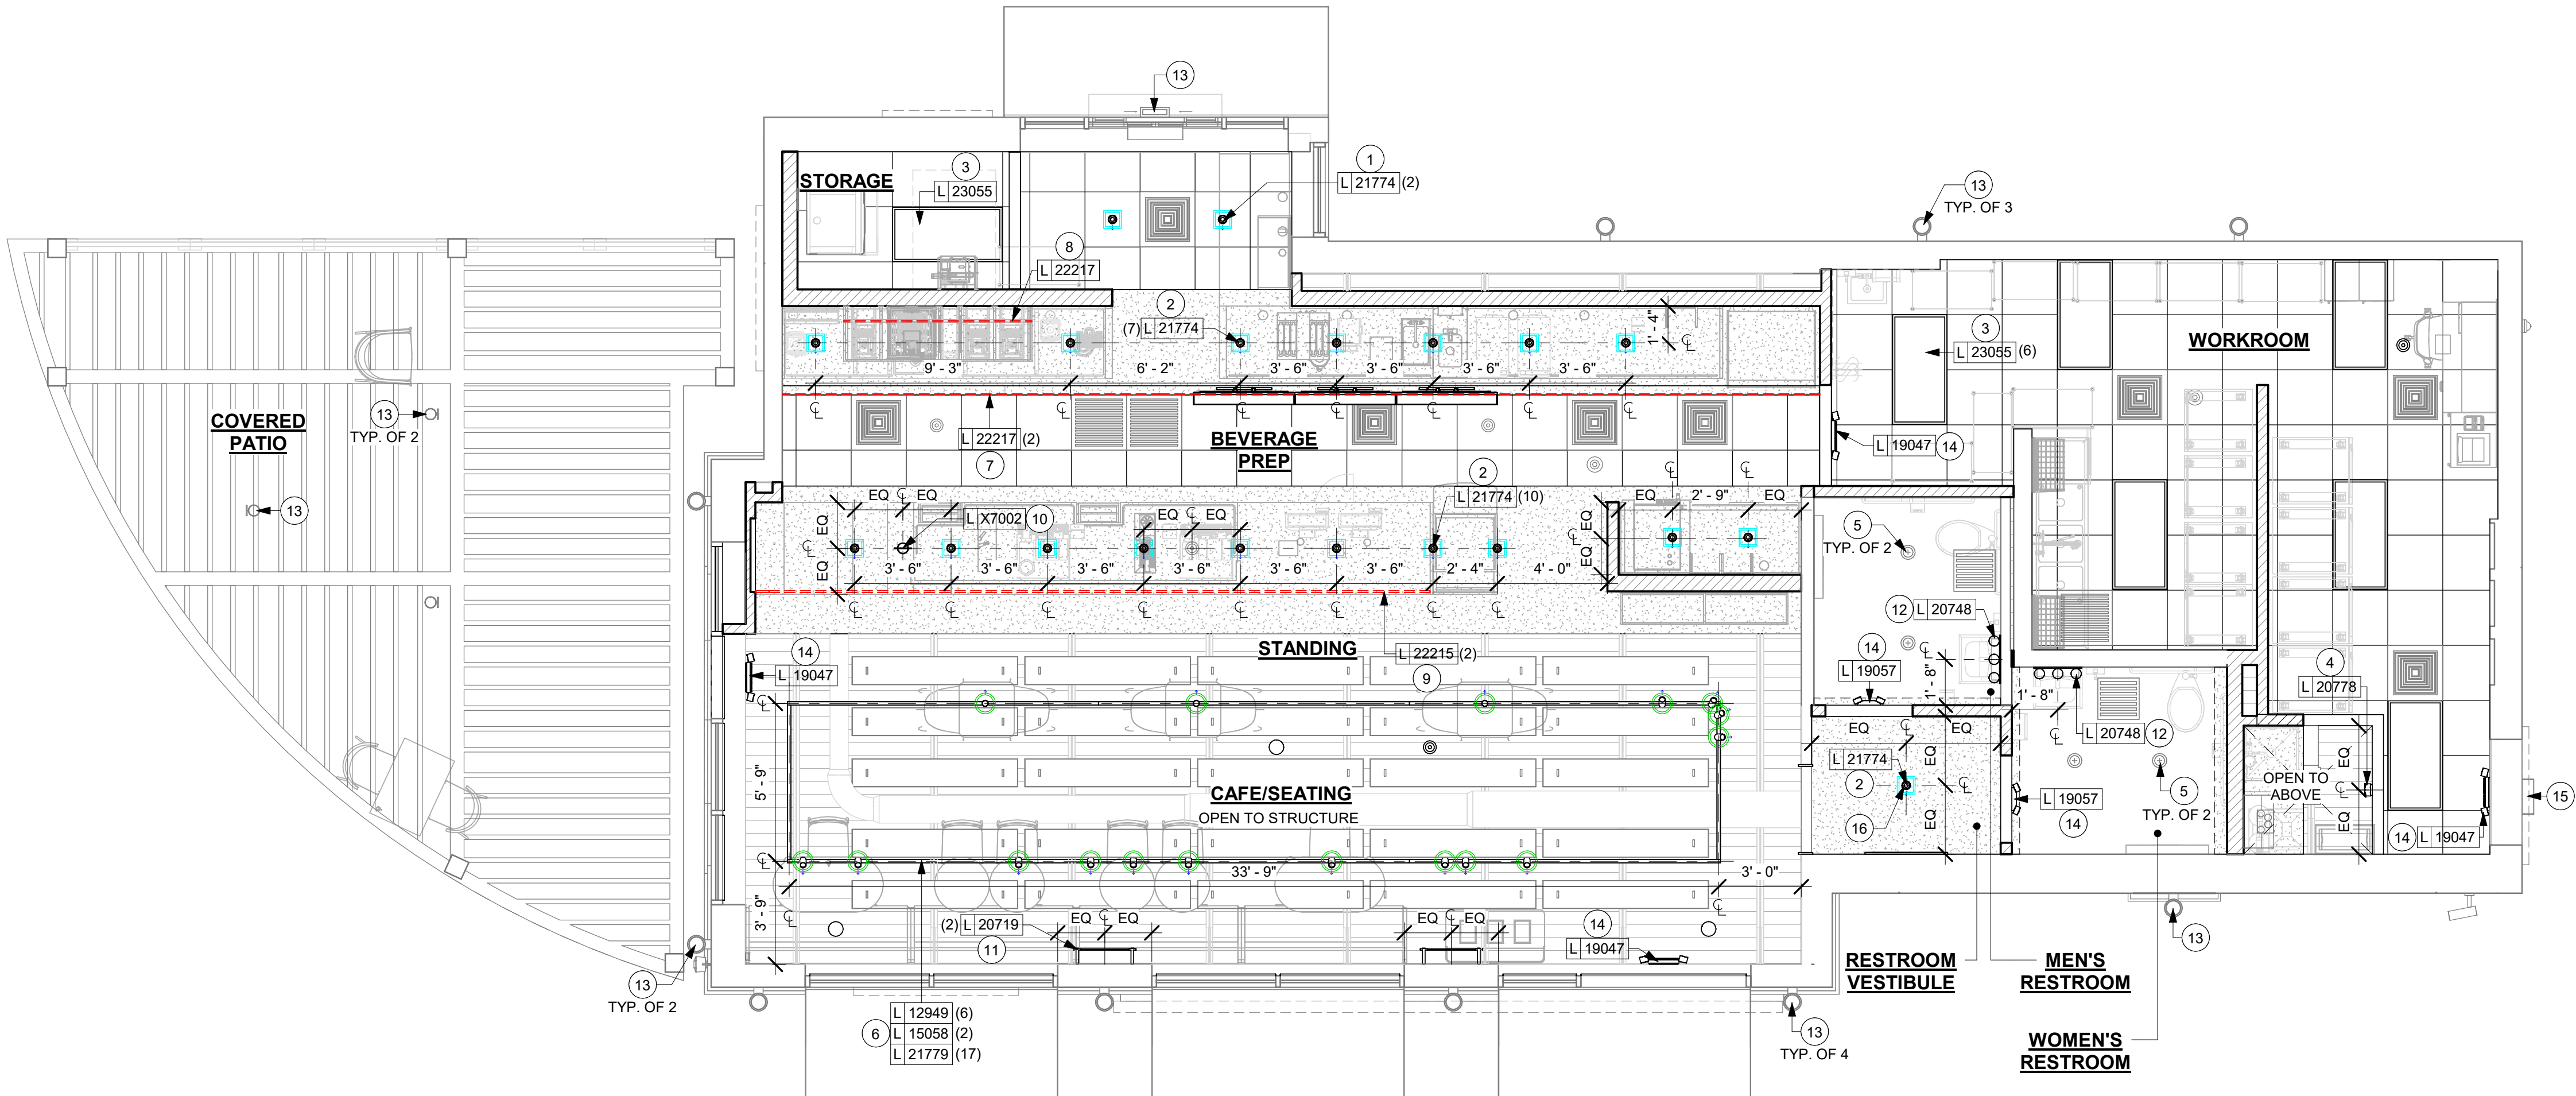


1 DIMENSIONED CEILING AND LIGHTING PLAN

Scale: 1/4" = 1'-0"

0 2' 4' 8'
Scale: 1/4" = 1'-0"

FOR CONSTRUCTION



© 2023 STARBUCKS COFFEE COMPANY

STARBUCKS®
2401 UTAH AVENUE SOUTH
SEATTLE, WASHINGTON 98134
(206) 318-1575

THESE DRAWINGS AND THE PROJECT MANUAL ARE CONFIDENTIAL AND SHALL REMAIN THE SOLE PROPERTY OF STARBUCKS CORPORATION, WHICH IS THE OWNER OF THE COPYRIGHT IN THIS WORK. THEY SHALL NOT BE REPRODUCED IN WHOLE OR IN PART, SHARED WITH THIRD PARTIES OR USED IN ANY MANNER ON OTHER PROJECTS OR EXTENSIONS TO THIS PROJECT WITHOUT THE PRIOR WRITTEN CONSENT OF STARBUCKS CORPORATION. THESE DRAWINGS AND SPECIFICATIONS ARE INTENDED TO EXPRESS DESIGN INTENT FOR A PROTOTYPICAL STARBUCKS STORE (WHICH IS SUBJECT TO CHANGE AT ANYTIME) AND DO NOT REFLECT ACTUAL SITE CONDITIONS. NEITHER PARTY SHALL HAVE ANY OBLIGATION NOR LIABILITY TO THE OTHER (EXCEPT STATED ABOVE) UNTIL A WRITTEN AGREEMENT IS FULLY EXECUTED BY BOTH PARTIES.

STARBUCKS TEMPLATE VERSION: i2023.10.23

Design Forum Architects Inc.
2050 Byers Rd
Miami, OH 45342
Tel: (844) 804-7700
Donald J. Reithman
Architect in Charge
License: AR0017303

MARQUE ENGINEERING
2230 PARK AVE, STE. 100, CINCINNATI, OH 45206
513.457.7131 - WWW.MARQUEENG.COM

PROJECT NAME:
S SEMORAN BLVD & LEE VISTA BLVD


PROJECT ADDRESS:
**6605 S SEMORAN BLVD
ORLANDO, FL 32822**

STORE #: 9875
PROJECT #: 25630-101
ISSUE DATE: 03/04/2024
DESIGN MANAGER: MARTIN PEREZ
PRODUCTION DESIGNER: ANDY MCLOUD
CHECKED BY: DONALD REITHMAN

Revision Schedule			
Rev	Date	By	Description

SHEET TITLE:
DIMENSIONED CEILING AND LIGHTING PLAN
SCALE: 1/4" = 1'-0"

SHEET NUMBER:
A-105

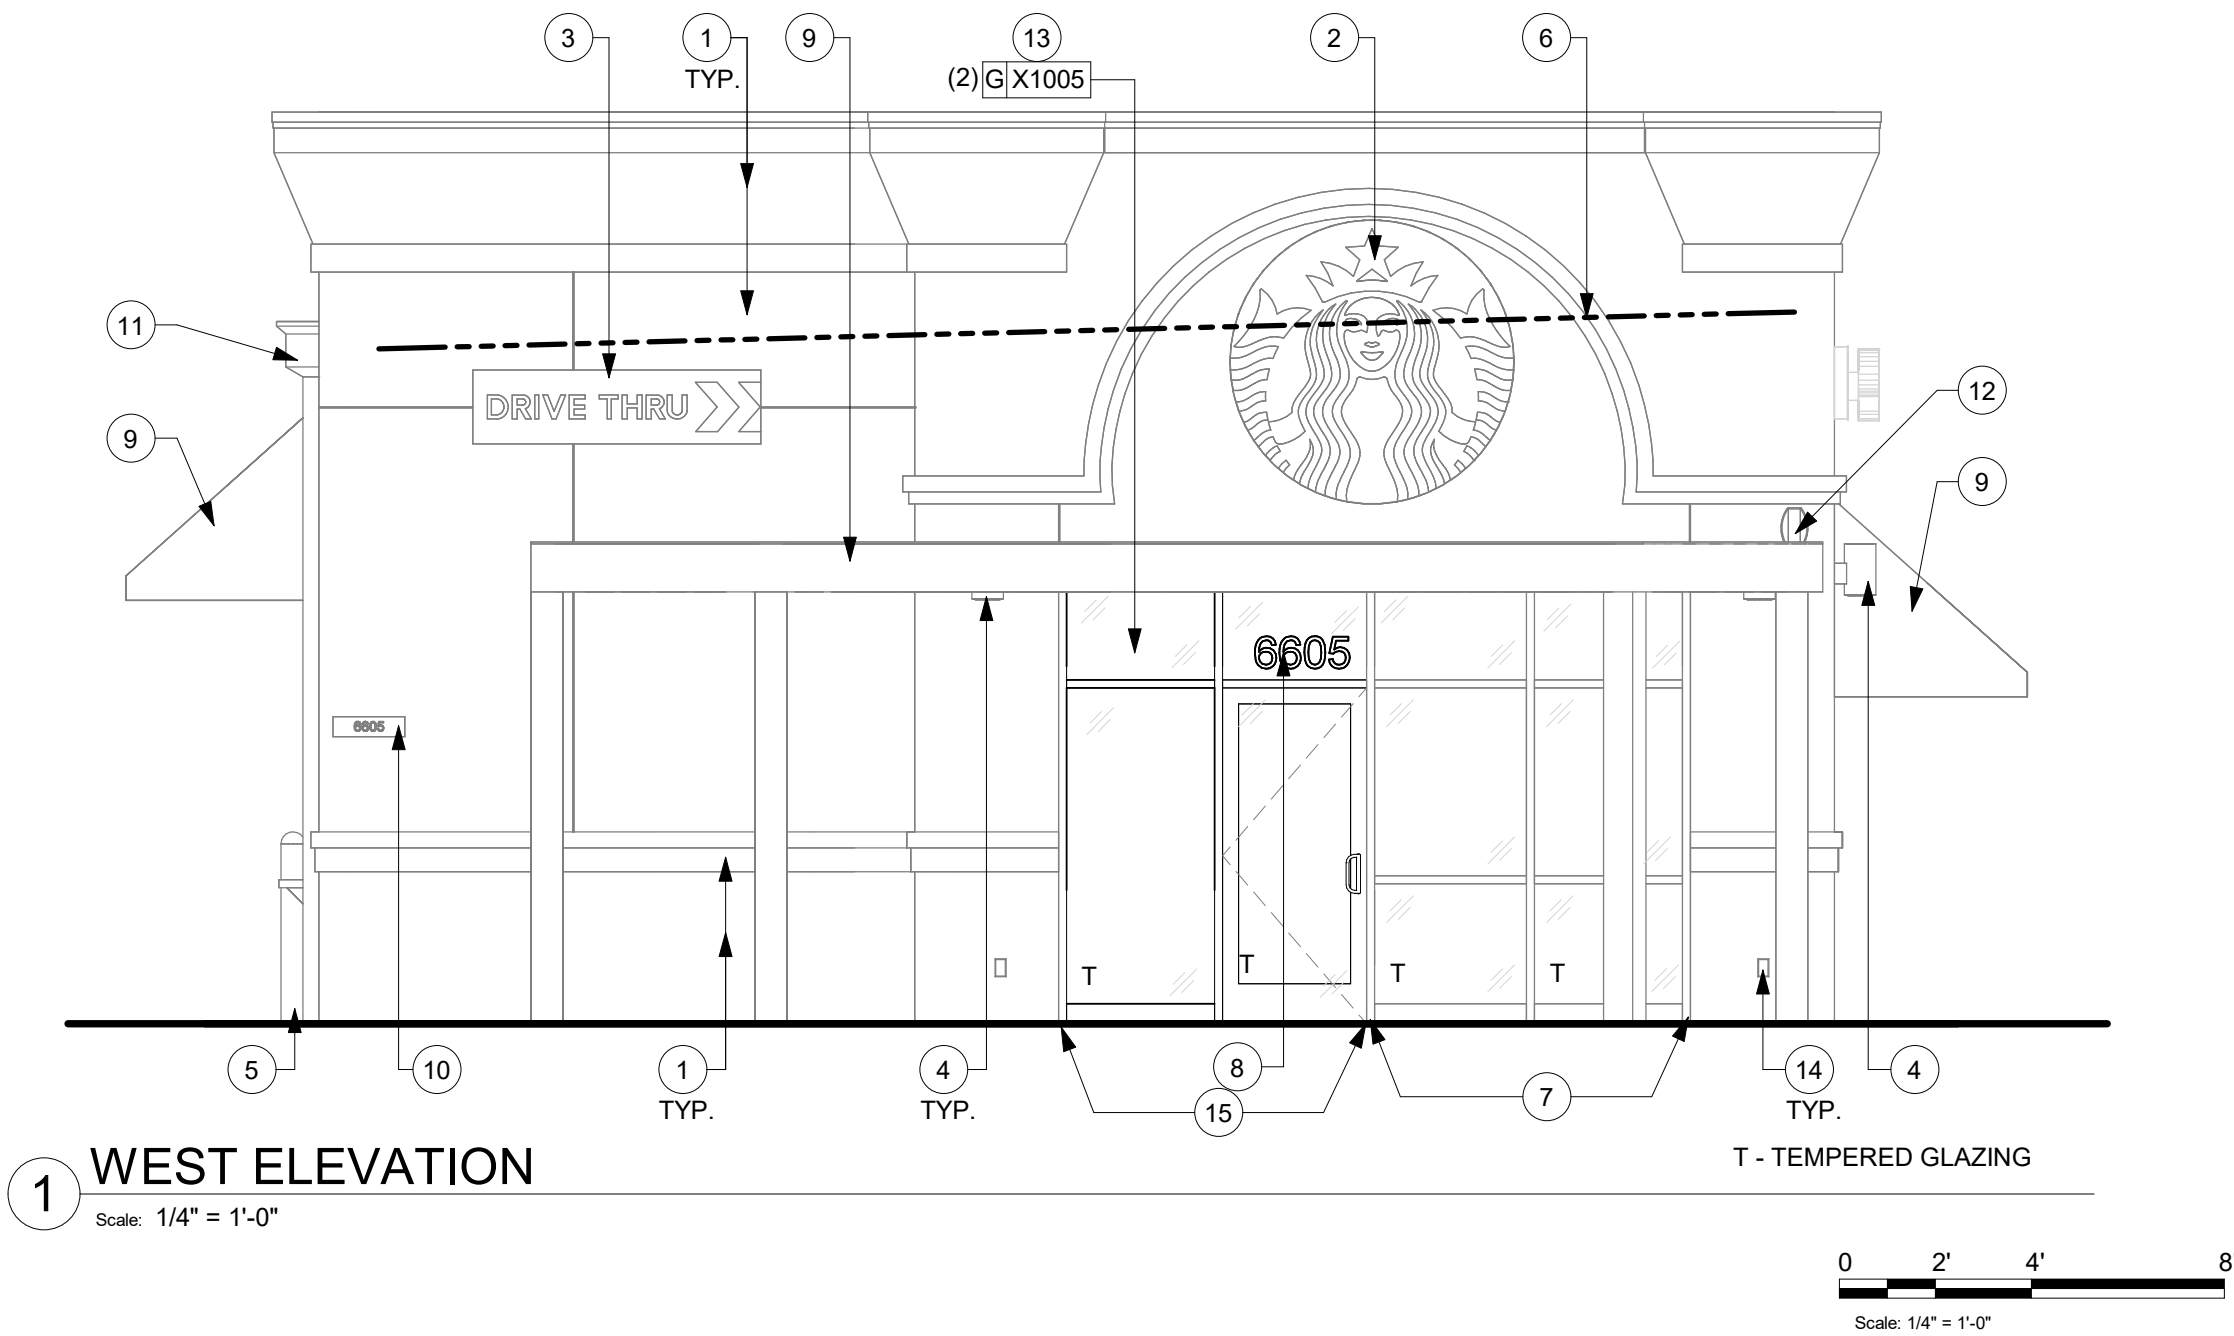


EXTERIOR ELEVATION NOTES

A. GENERAL CONTRACTOR TO CLEAN, PATCH AND REPAIR EXISTING EXTERIOR AS REQUIRED.

KEYED NOTES

- EXISTING EXTERIOR FINISHES TO REMAIN.
- EXISTING LOGO DISK TO REMAIN.
- EXISTING DT CABINET BOX TO REMAIN.
- EXISTING WALL MOUNTED SCONES TO REMAIN.
- EXISTING BOLLARD TO REMAIN.
- TOP OF ROOF DECK.
- EXISTING STOREFRONT WINDOW SYSTEM TO REMAIN.
- INSTALL NEW 6IN (155MM) STORE ADDRESS ON NEW STOREFRONT GLAZING.
- EXISTING AWNING/ PERGOLA TO REMAIN.
- EXISTING STORE ADDRESS ON BUILDING TO REMAIN.
- EXISTING DOWNSPOUT TO REMAIN.
- EXISTING WALL MOUNTED SPEAKER TO REMAIN.
- INSTALL NEW BLACKOUT FILM ON EXTERIOR FACE OF GLAZING AS INDICATED. FINISH: FROST/MATTE RE1SIAR SILVER
- EXISTING GFCI OUTLET TO REMAIN.
- INSTALL NEW STOREFRONT DOOR / WINDOW SYSTEM AS INDICATED ON PAGE A-601/1.

FOR CONSTRUCTION



© 2023 STARBUCKS COFFEE COMPANY

STARBUCKS®
2401 UTAH AVENUE SOUTH
SEATTLE, WASHINGTON 98134
(206) 318-1575

THESE DRAWINGS AND THE PROJECT MANUAL ARE CONFIDENTIAL AND SHALL REMAIN THE SOLE PROPERTY OF STARBUCKS CORPORATION, WHICH IS THE OWNER OF THE COPYRIGHT IN THIS WORK. THEY SHALL NOT BE REPRODUCED IN WHOLE OR IN PART, SHARED WITH THIRD PARTIES OR USED IN ANY MANNER ON OTHER PROJECTS OR EXTENSIONS TO THIS PROJECT WITHOUT THE PRIOR WRITTEN CONSENT OF STARBUCKS CORPORATION. THESE DRAWINGS AND SPECIFICATIONS ARE INTENDED TO EXPRESS DESIGN INTENT FOR A PROTOTYPICAL STARBUCKS STORE (WHICH IS SUBJECT TO CHANGE AT ANYTIME) AND DO NOT REFLECT ACTUAL SITE CONDITIONS. NEITHER PARTY SHALL HAVE ANY OBLIGATION NOR LIABILITY TO THE OTHER (EXCEPT STATED ABOVE) UNTIL A WRITTEN AGREEMENT IS FULLY EXECUTED BY BOTH PARTIES.

STARBUCKS TEMPLATE VERSION: i2023.10.23

Design Forum Architects Inc.
2050 Byers Rd
Miamisburg, OH 45342
Tel: (844) 804-7700
Donald J. Reihman
Architect In Charge
License: AR0017303

MARQUE ENGINEERING
2230 PARK AVE, STE. 100, CINCINNATI, OH 45206
513.457.7131 - WWW.MARQUEENG.COM

PROJECT NAME:
S SEMORAN BLVD & LEE VISTA BLVD

PROJECT ADDRESS:
**6605 S SEMORAN BLVD
ORLANDO, FL 32822**

STORE #: 9875
PROJECT #: 25630-101
ISSUE DATE: 03/04/2024
DESIGN MANAGER: MARTIN PEREZ
PRODUCTION DESIGNER: ANDY MCLOUD
CHECKED BY: DONALD RETHMAN


Revision Schedule			
Rev	Date	By	Description

SHEET TITLE:
EXTERIOR ELEVATIONS


SCALE: 1/4" = 1'-0"

SHEET NUMBER:
A-201


\\file-day.ad.changeupinc.com\Client\StarbucksArchitecture\Projects_2023\Florida\Semoran & Lee Vista - 25630-10\125630-101_9875_S Semoran Blvd & Lee Vista Blvd, FL_2023.rvt 3/4/2024 2:39:20 PM

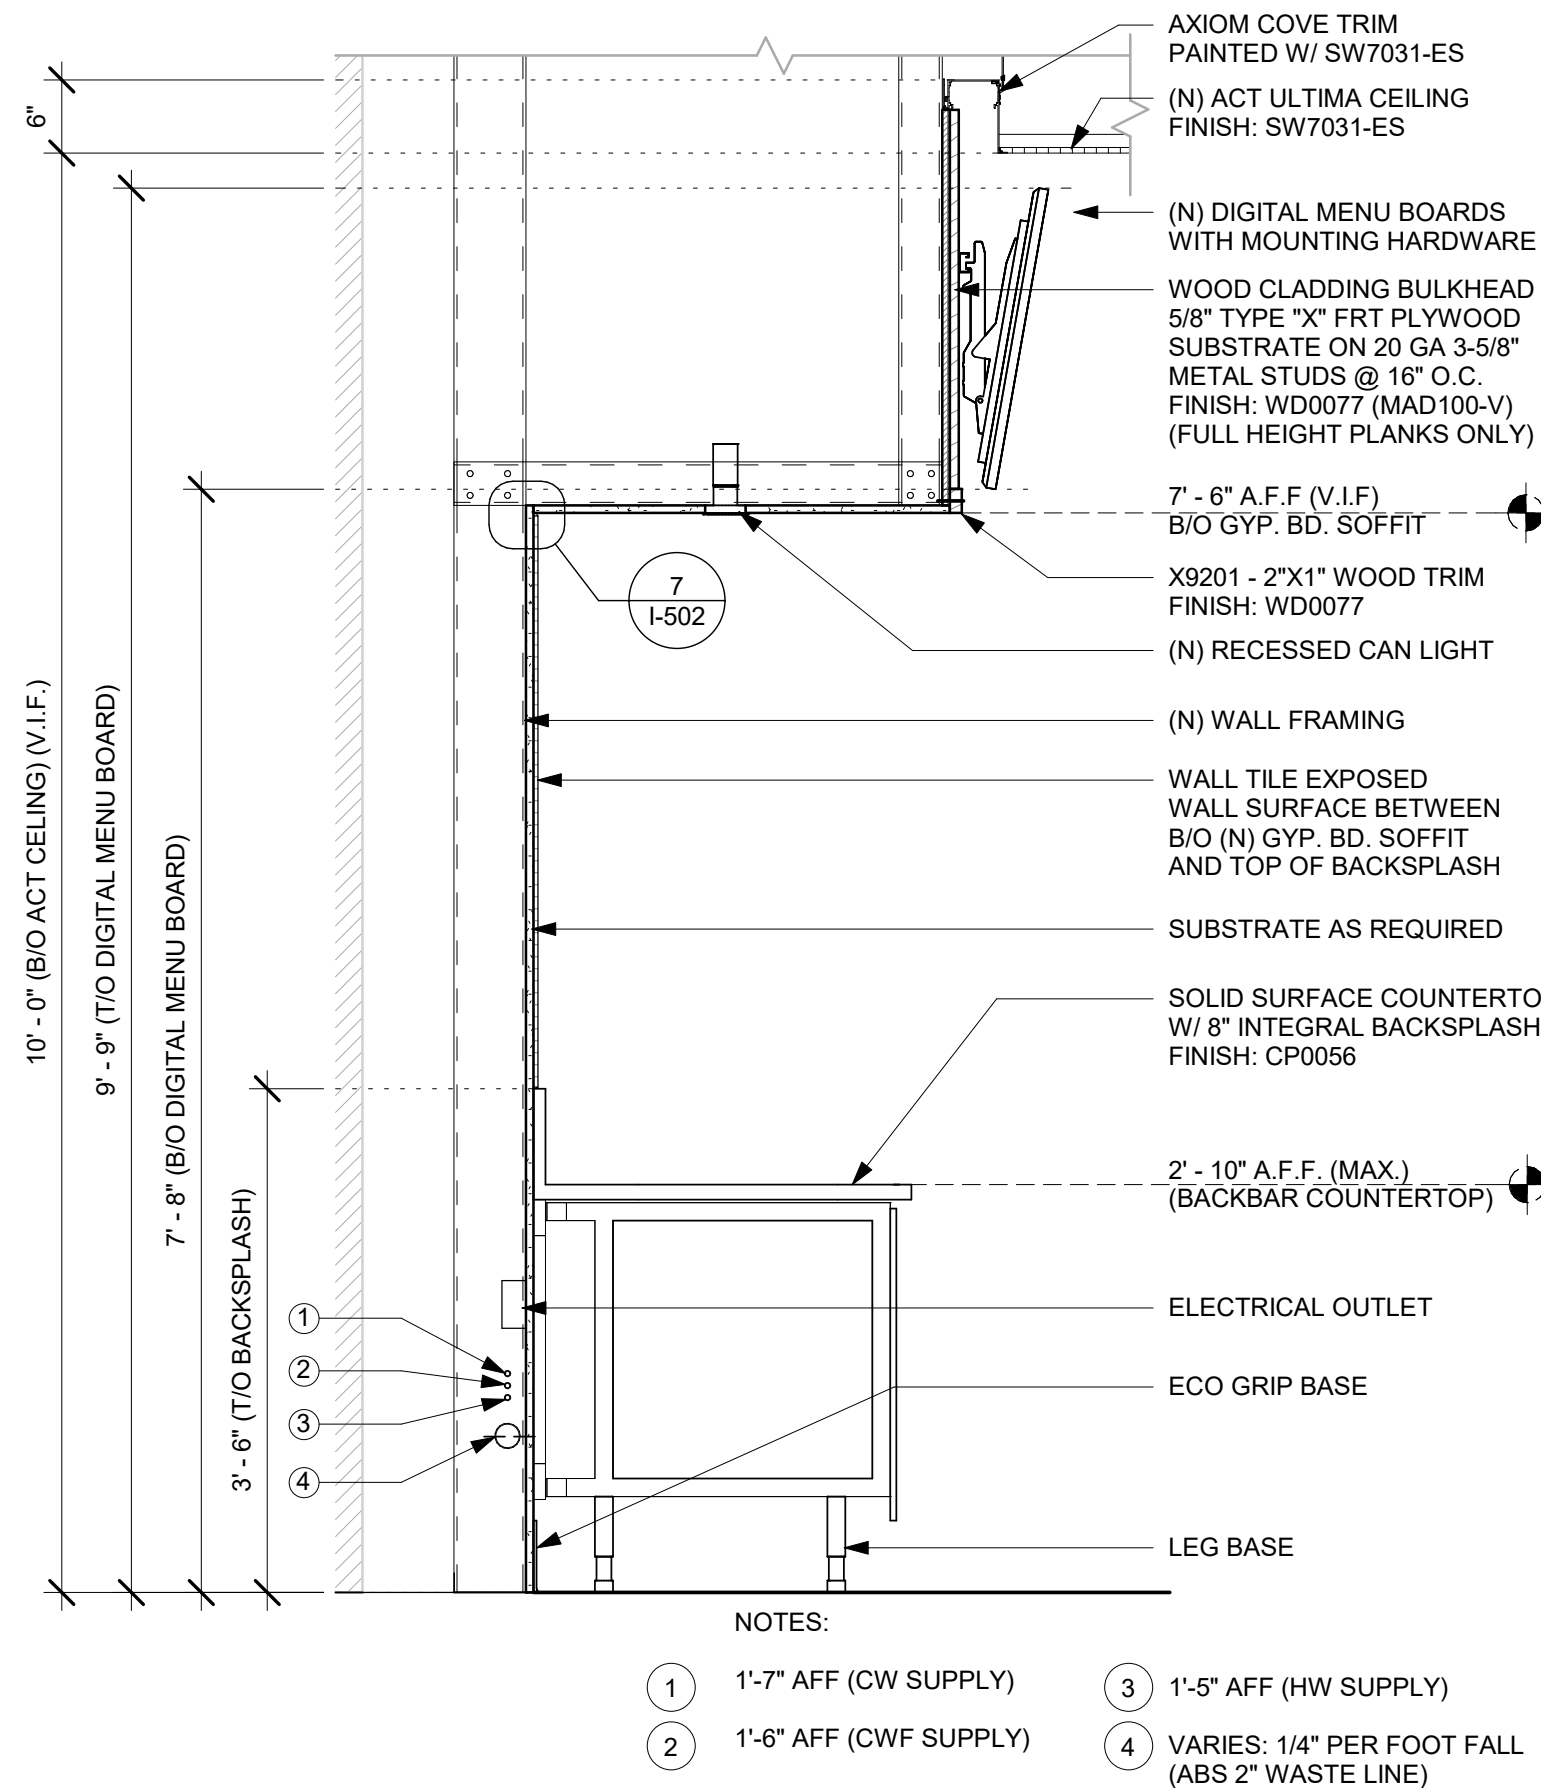


1 WALL SECTION AT BACKBAR
Scale: 3/4" = 1'-0"

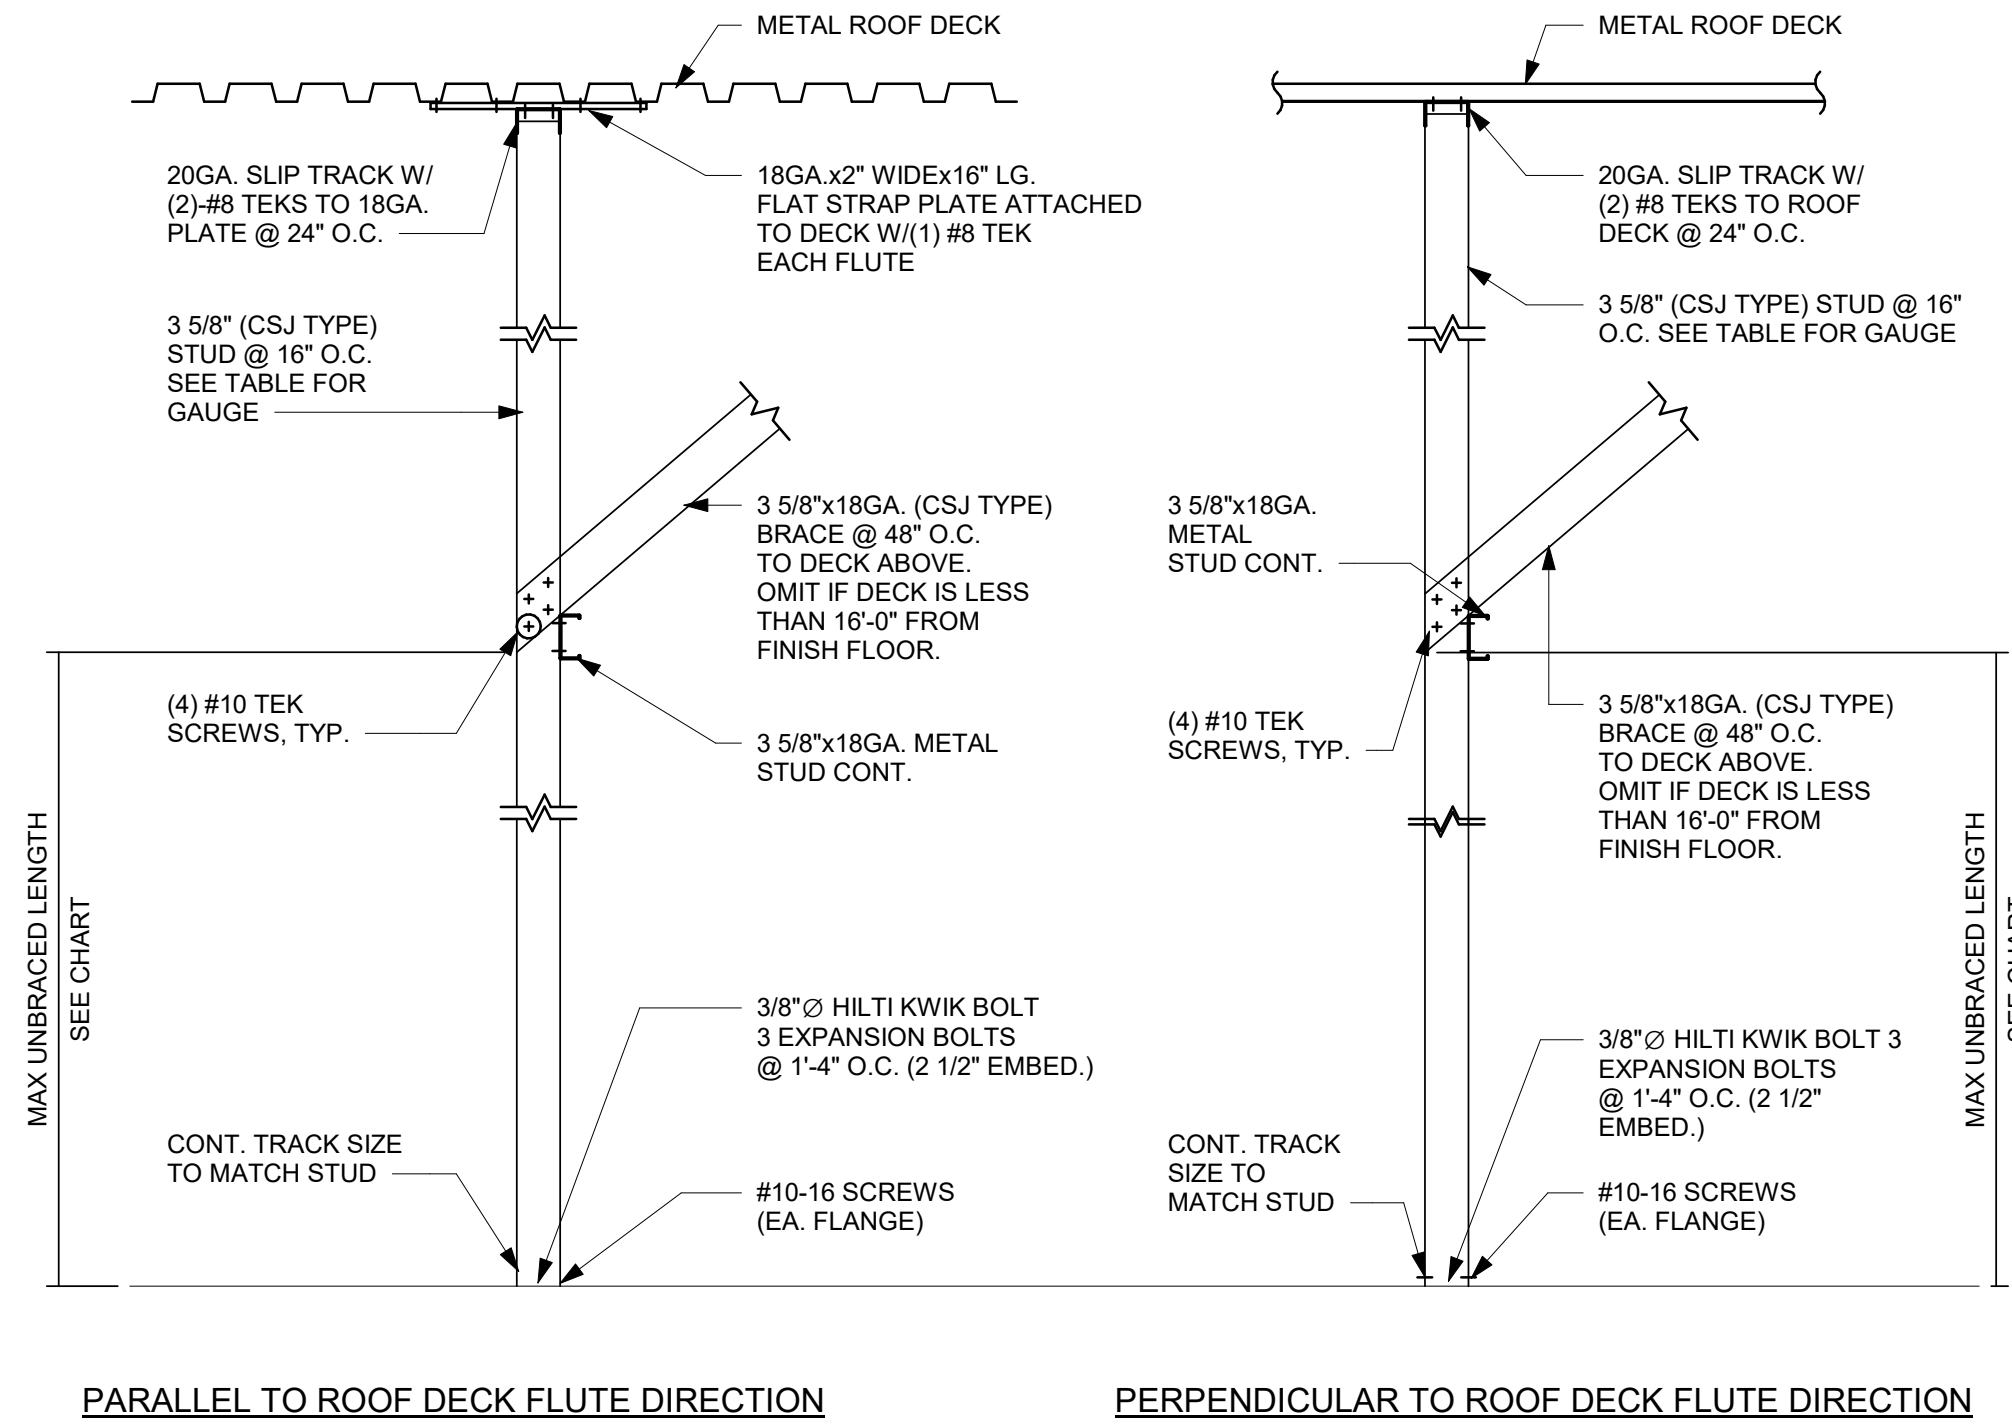

2 NEW PARTITION WALL TO STRUCTURE
Scale: 3/4" = 1'-0"

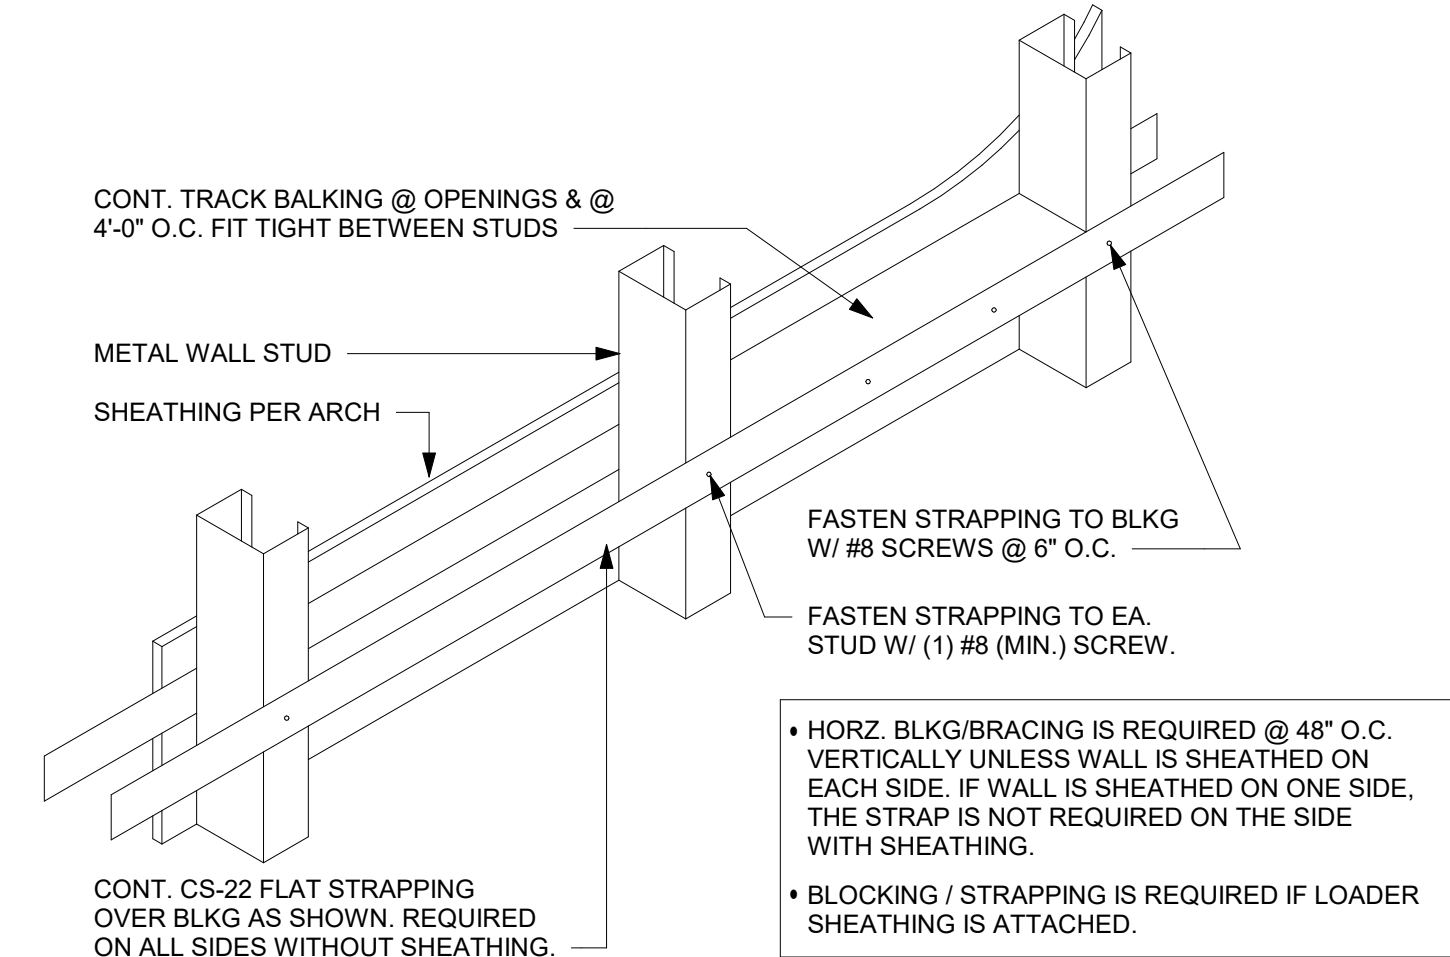


3 TYPICAL WALL BLOCKING BRACING
Scale: 3/4" = 1'-0"

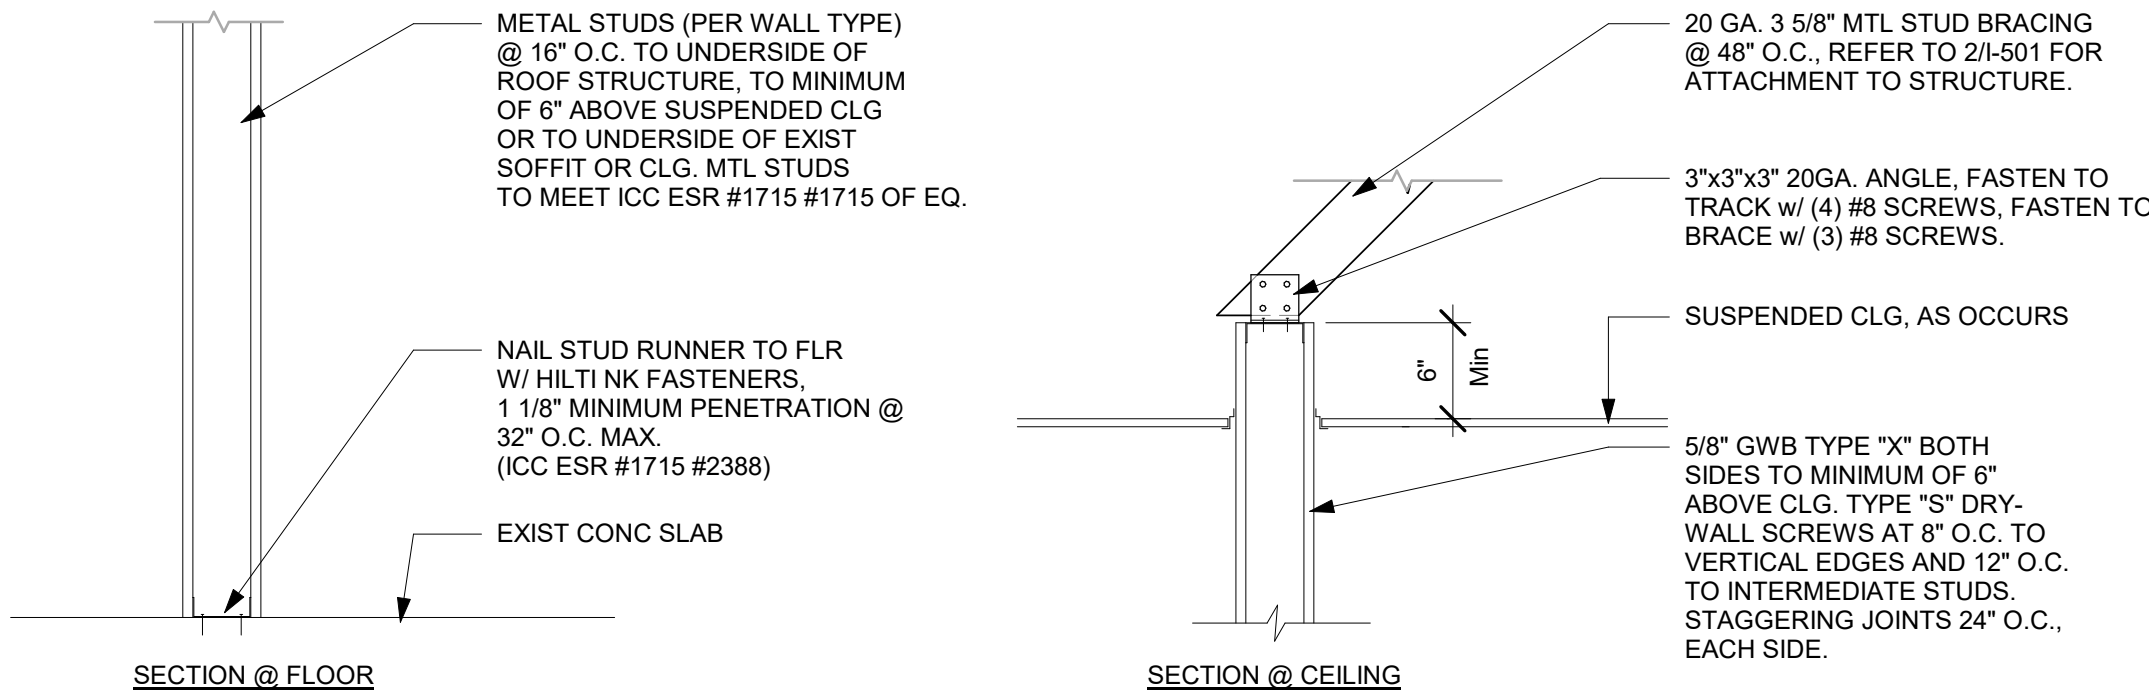

4 NEW PARTITION WALL 6" ABOVE CEILING
Scale: 1" = 1'-0"


WALL TYPE FASTENER SCHEDULE			
WALL TYPE	WALL BLOCKING	FASTENERS	NOTES
WOOD FRAME	X	#8 X3" (75MM) WD OR EQUIVALENT	REFER TO BLOCKING REQUIREMENTS
METAL FRAME	X	#6CT. X1 1/4" (30MM) MTLWD OR EQUIVALENT	REFER TO BLOCKING REQUIREMENTS
CMU		MIN. 5/16"x3" (8MMx75MM) TAPCON OR EQUIVALENT	SPACE PER DETAIL THIS SHEET
CONCRETE		MIN. 1/4"x3" (7MMx75MM) SLEEVE ANCHOR OR EQUIVALENT	SPACE PER DETAIL THIS SHEET
BRICK		MIN. 1/4"x1" (7MMx25MM) WEDGE ANCHOR OR EQUIVALENT	SPACE PER DETAIL THIS SHEET

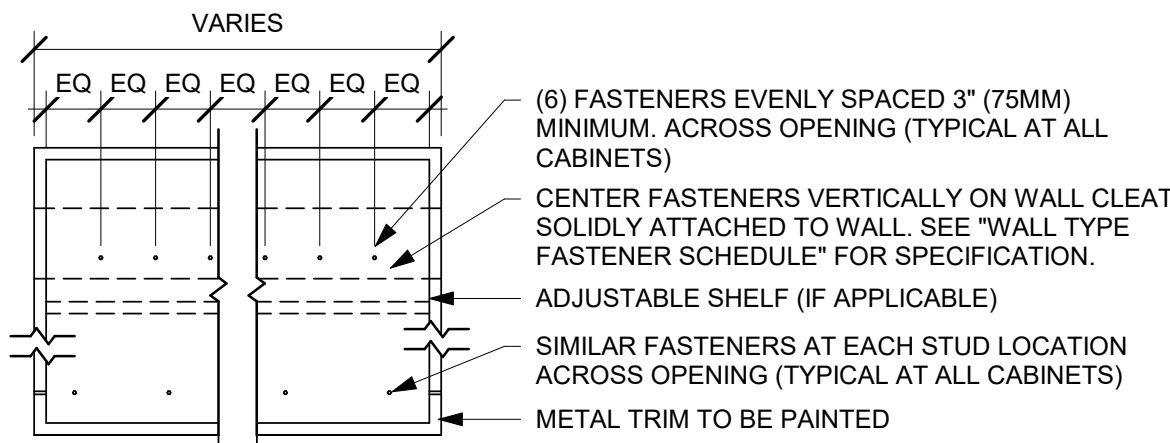

7 UPPER CABINET ATTACHMENT
Scale: 1" = 1'-0"

STUD WALL BLOCKING REQUIREMENTS:
WOOD STUD WALLS REQUIRE MIN. 2"x6" (50MMX150MM) WOOD BLOCKING SECURED FLUSH TO STUD FACE WITH (3) 10D NAILS (OR EQUIVALENT)


METAL STUD WALLS REQUIRE MIN. 2"x6" (50MMX150MM) WOOD BLOCKING SECURED FLUSH TO STUD FACE WITH MIN. (3) #6 CT. 1.25" (30MM) SCREWS (OR EQUIVALENT)

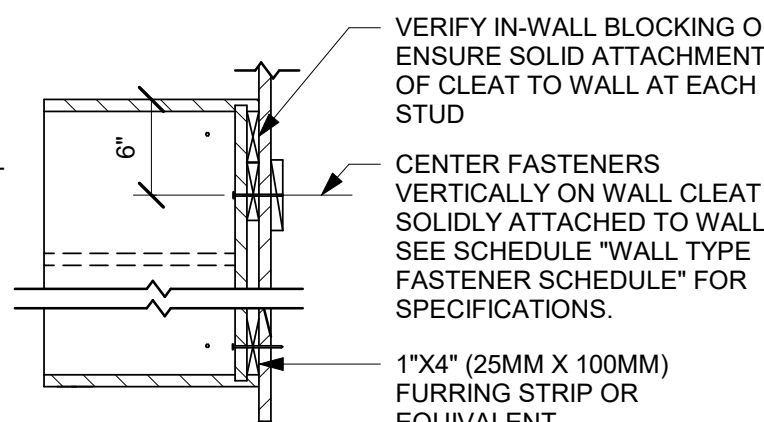

8 DIEWALL SECTION AT FRONT BAR
Scale: 1" = 1'-0"

PARTITION WALL SCHEDULE					
WALL HEIGHT	STUD SIZE	DEF TRACK	DEF TRACK SPANNING BTWN (E) JOISTS		BOT TRACK
15 FEET	362S137-33	33 MIL	JST @ 4' O.C.	54 MIL	33 MIL
			JST @ 6' O.C.	68 MIL	
20 FEET	550S162-33	33 MIL	JST @ 4' O.C.	68 MIL	33 MIL
			JST @ 6' O.C.	97 MIL	
25 FEET	600S200-43	43 MIL	JST @ 4' O.C.	68 MIL	33 MIL
			JST @ 6' O.C.	97 MIL	

5 PARTITION WALL SCHEDULE
Scale: 3/4" = 1'-0"

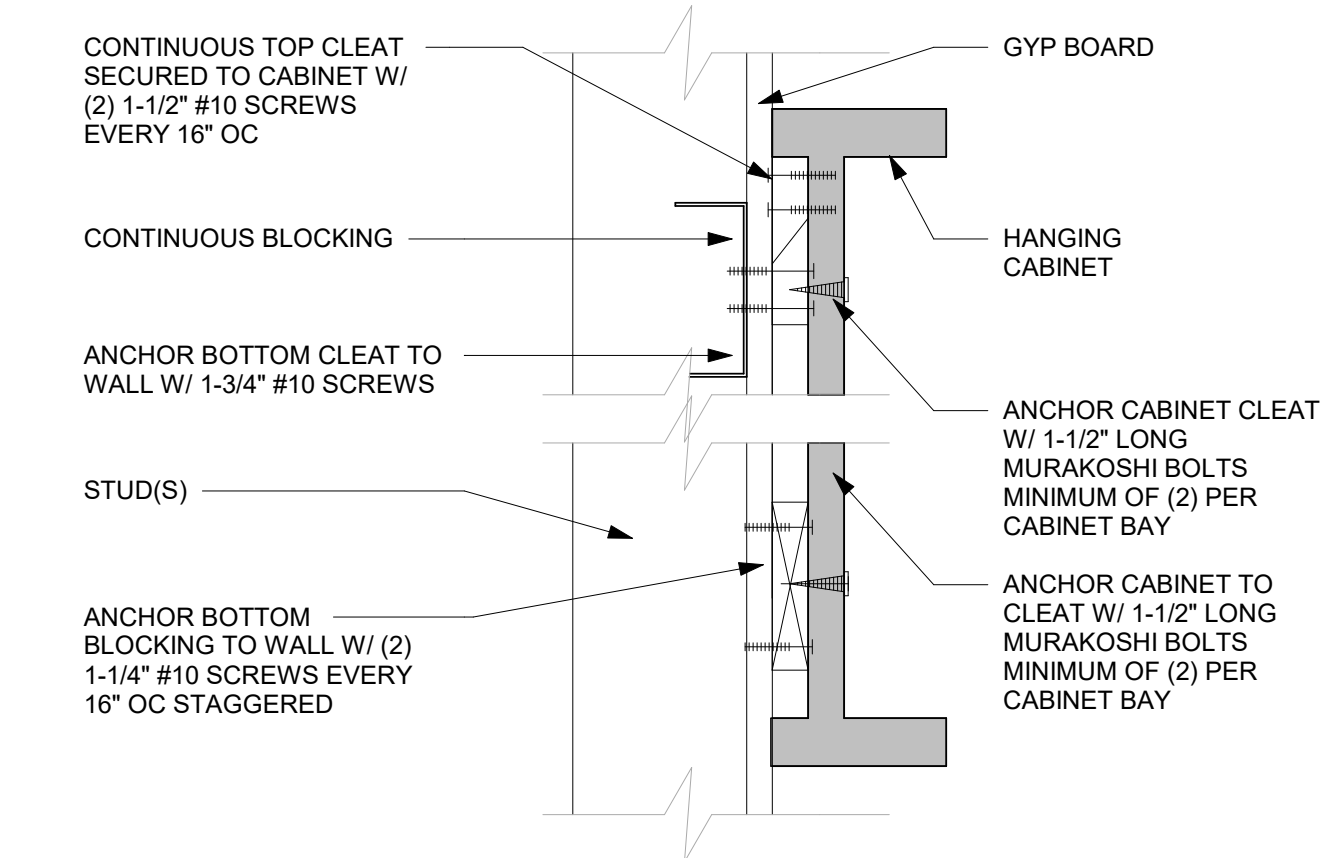

6 ANCHOR DETAIL
Scale: 3" = 1'-0"



STARBUCKS®
2401 UTAH AVENUE SOUTH
SEATTLE, WASHINGTON 98134
(206) 318-1575

THESE DRAWINGS AND THE PROJECT MANUAL ARE CONFIDENTIAL AND SHALL REMAIN THE SOLE PROPERTY OF STARBUCKS CORPORATION, WHICH IS THE OWNER OF THE COPYRIGHT IN THIS WORK. THEY SHALL NOT BE REPRODUCED IN WHOLE OR IN PART, SHARED WITH THIRD PARTIES OR USED IN ANY MANNER ON OTHER PROJECTS OR EXTENSIONS TO THIS PROJECT WITHOUT THE PRIOR WRITTEN CONSENT OF STARBUCKS CORPORATION. THESE DRAWINGS AND SPECIFICATIONS ARE INTENDED TO EXPRESS DESIGN INTENT FOR A PROTOTYPICAL STARBUCKS STORE (WHICH IS SUBJECT TO CHANGE AT ANYTIME) AND DO NOT REFLECT ACTUAL SITE CONDITIONS. NEITHER PARTY SHALL HAVE ANY OBLIGATION NOR LIABILITY TO THE OTHER (EXCEPT STATED ABOVE) UNTIL A WRITTEN AGREEMENT IS FULLY EXECUTED BY BOTH PARTIES.

STARBUCKS TEMPLATE VERSION: i2023.10.23

Design Forum Architects Inc.
2050 Byers Rd
Miami, OH 45342
Tel: (844) 804-7700

Donald J. Reithman
Architect In Charge
License: AR0017303

MARQUE ENGINEERING
2230 PARK AVE, STE. 100, CINCINNATI, OH 45206
513.457.7131 - WWW.MARQUEENG.COM

FOR CONSTRUCTION

PROJECT NAME:
S SEMORAN BLVD & LEE VISTA BLVD

PROJECT ADDRESS:
**6605 S SEMORAN BLVD
ORLANDO, FL 32822**

STORE #: 9875
PROJECT #: 25630-101
ISSUE DATE: 03/04/2024
DESIGN MANAGER: MARTIN PEREZ
PRODUCTION DESIGNER: ANDY MCLOUD
CHECKED BY: DONALD REITHMAN


Revision Schedule			
Rev	Date	By	Description

SHEET TITLE:
BUILDING DETAILS

SCALE: AS SHOWN


SHEET NUMBER:
A-501

\\file-day.ad.changeupinc.com\Client\StarbucksArchitecture\Projects_2023\Florida\Semoran & Lee Vista -25630-10\25630-101_9875_S Semoran Blvd & Lee Vista Blvd, FL_2023.rvt 3/4/2024 2:39:22 PM

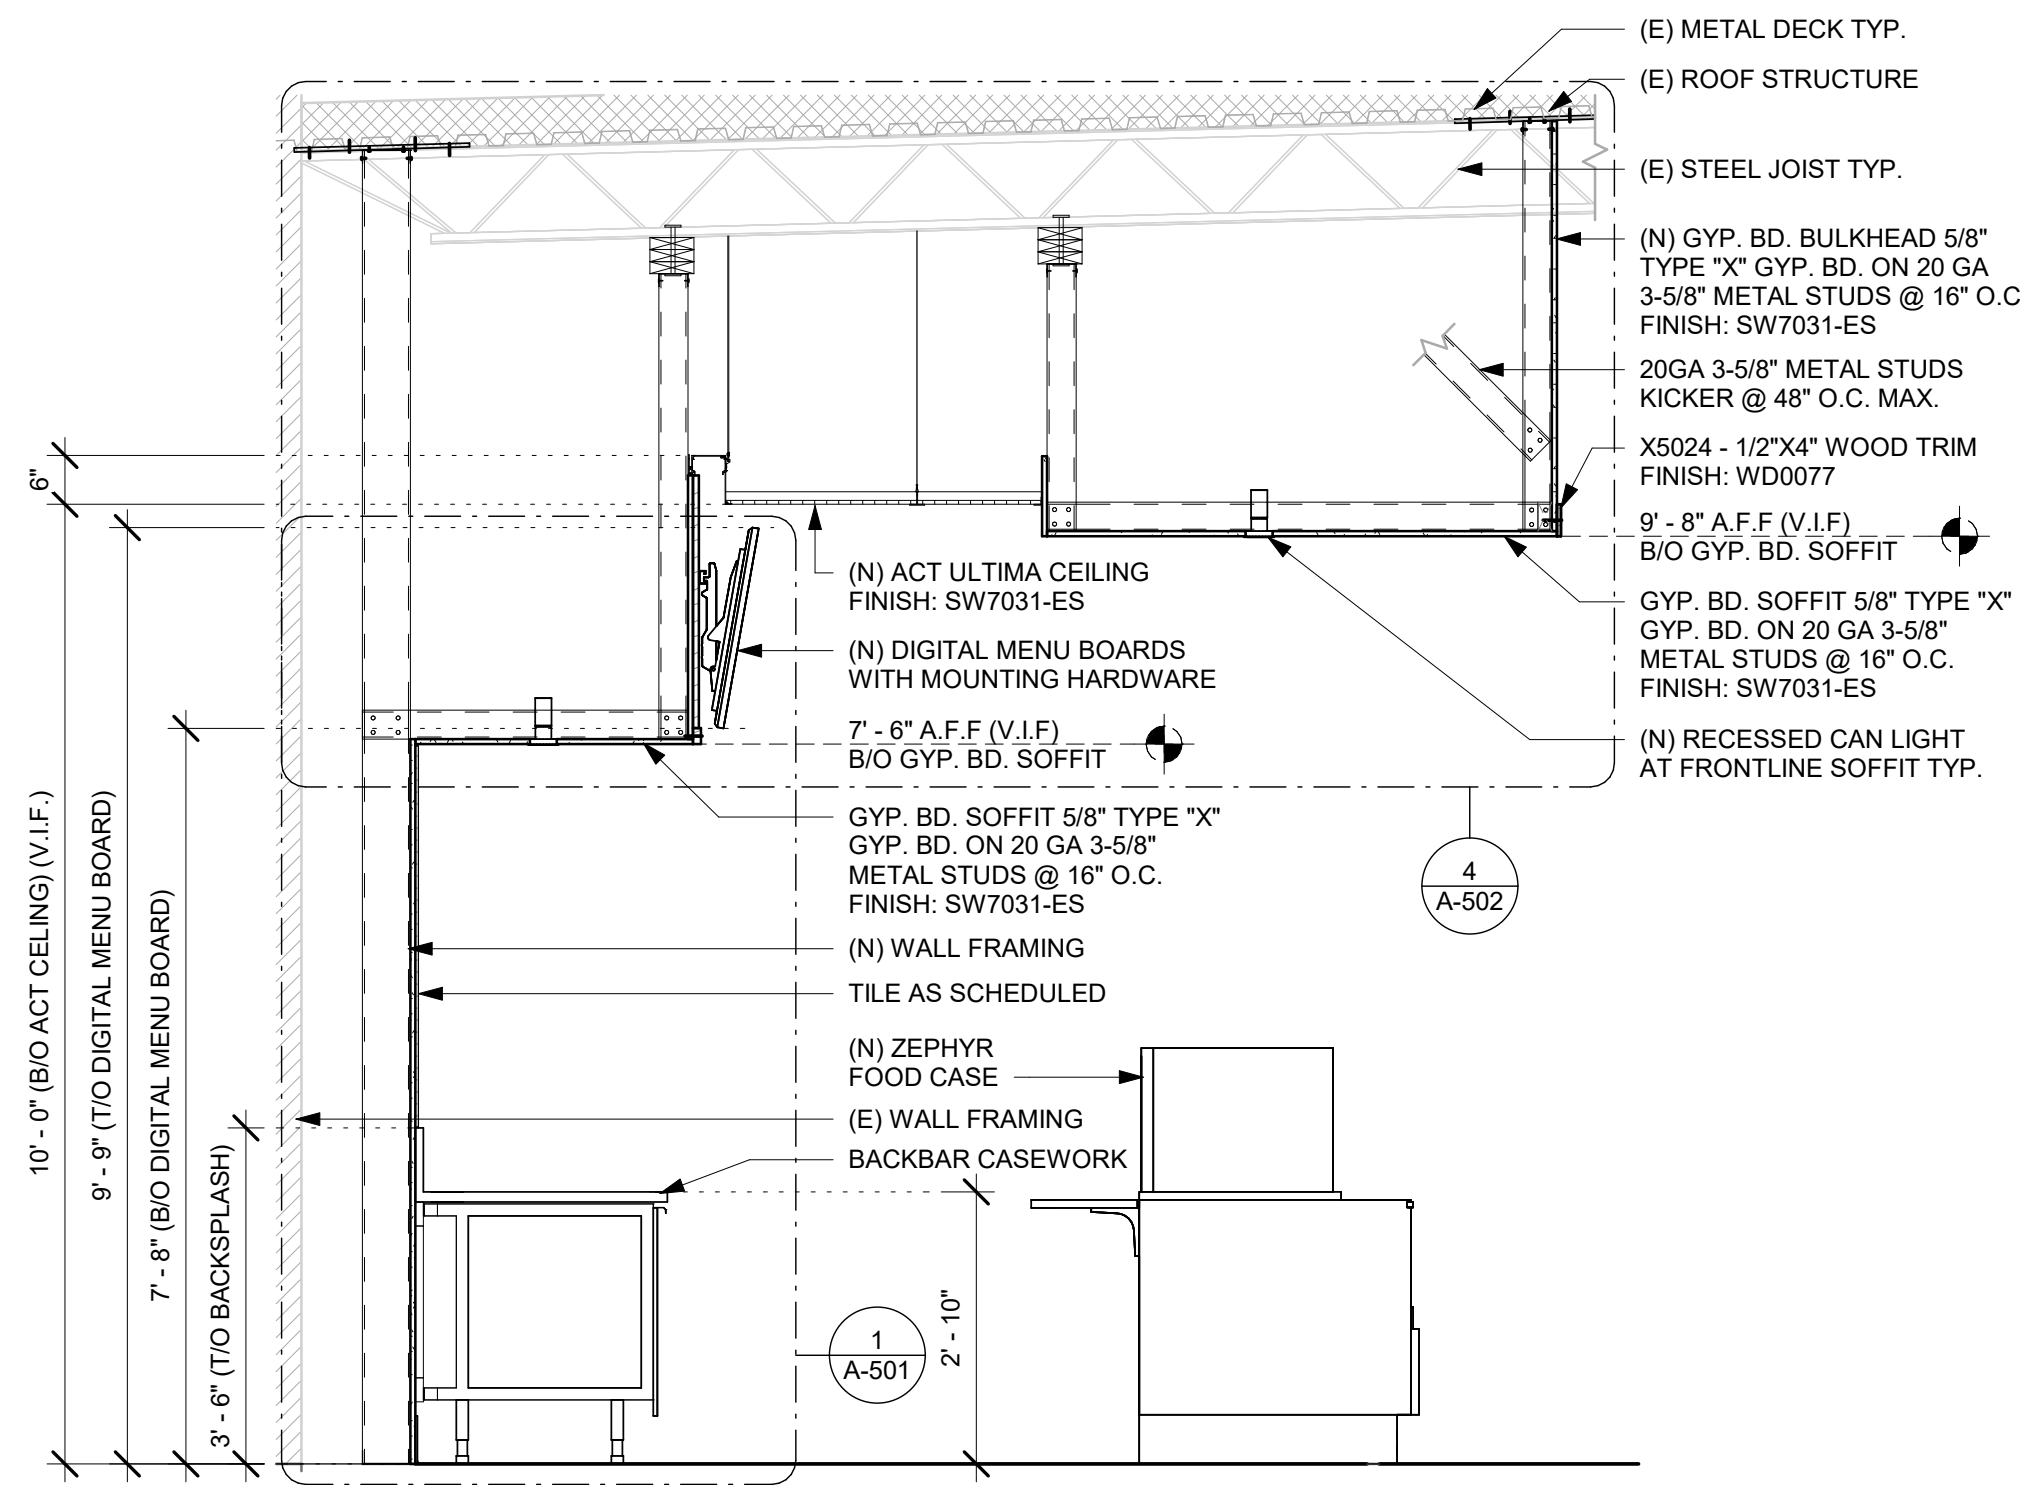


1 BACKBAR SECTION

Scale: 1/2" = 1'-0"

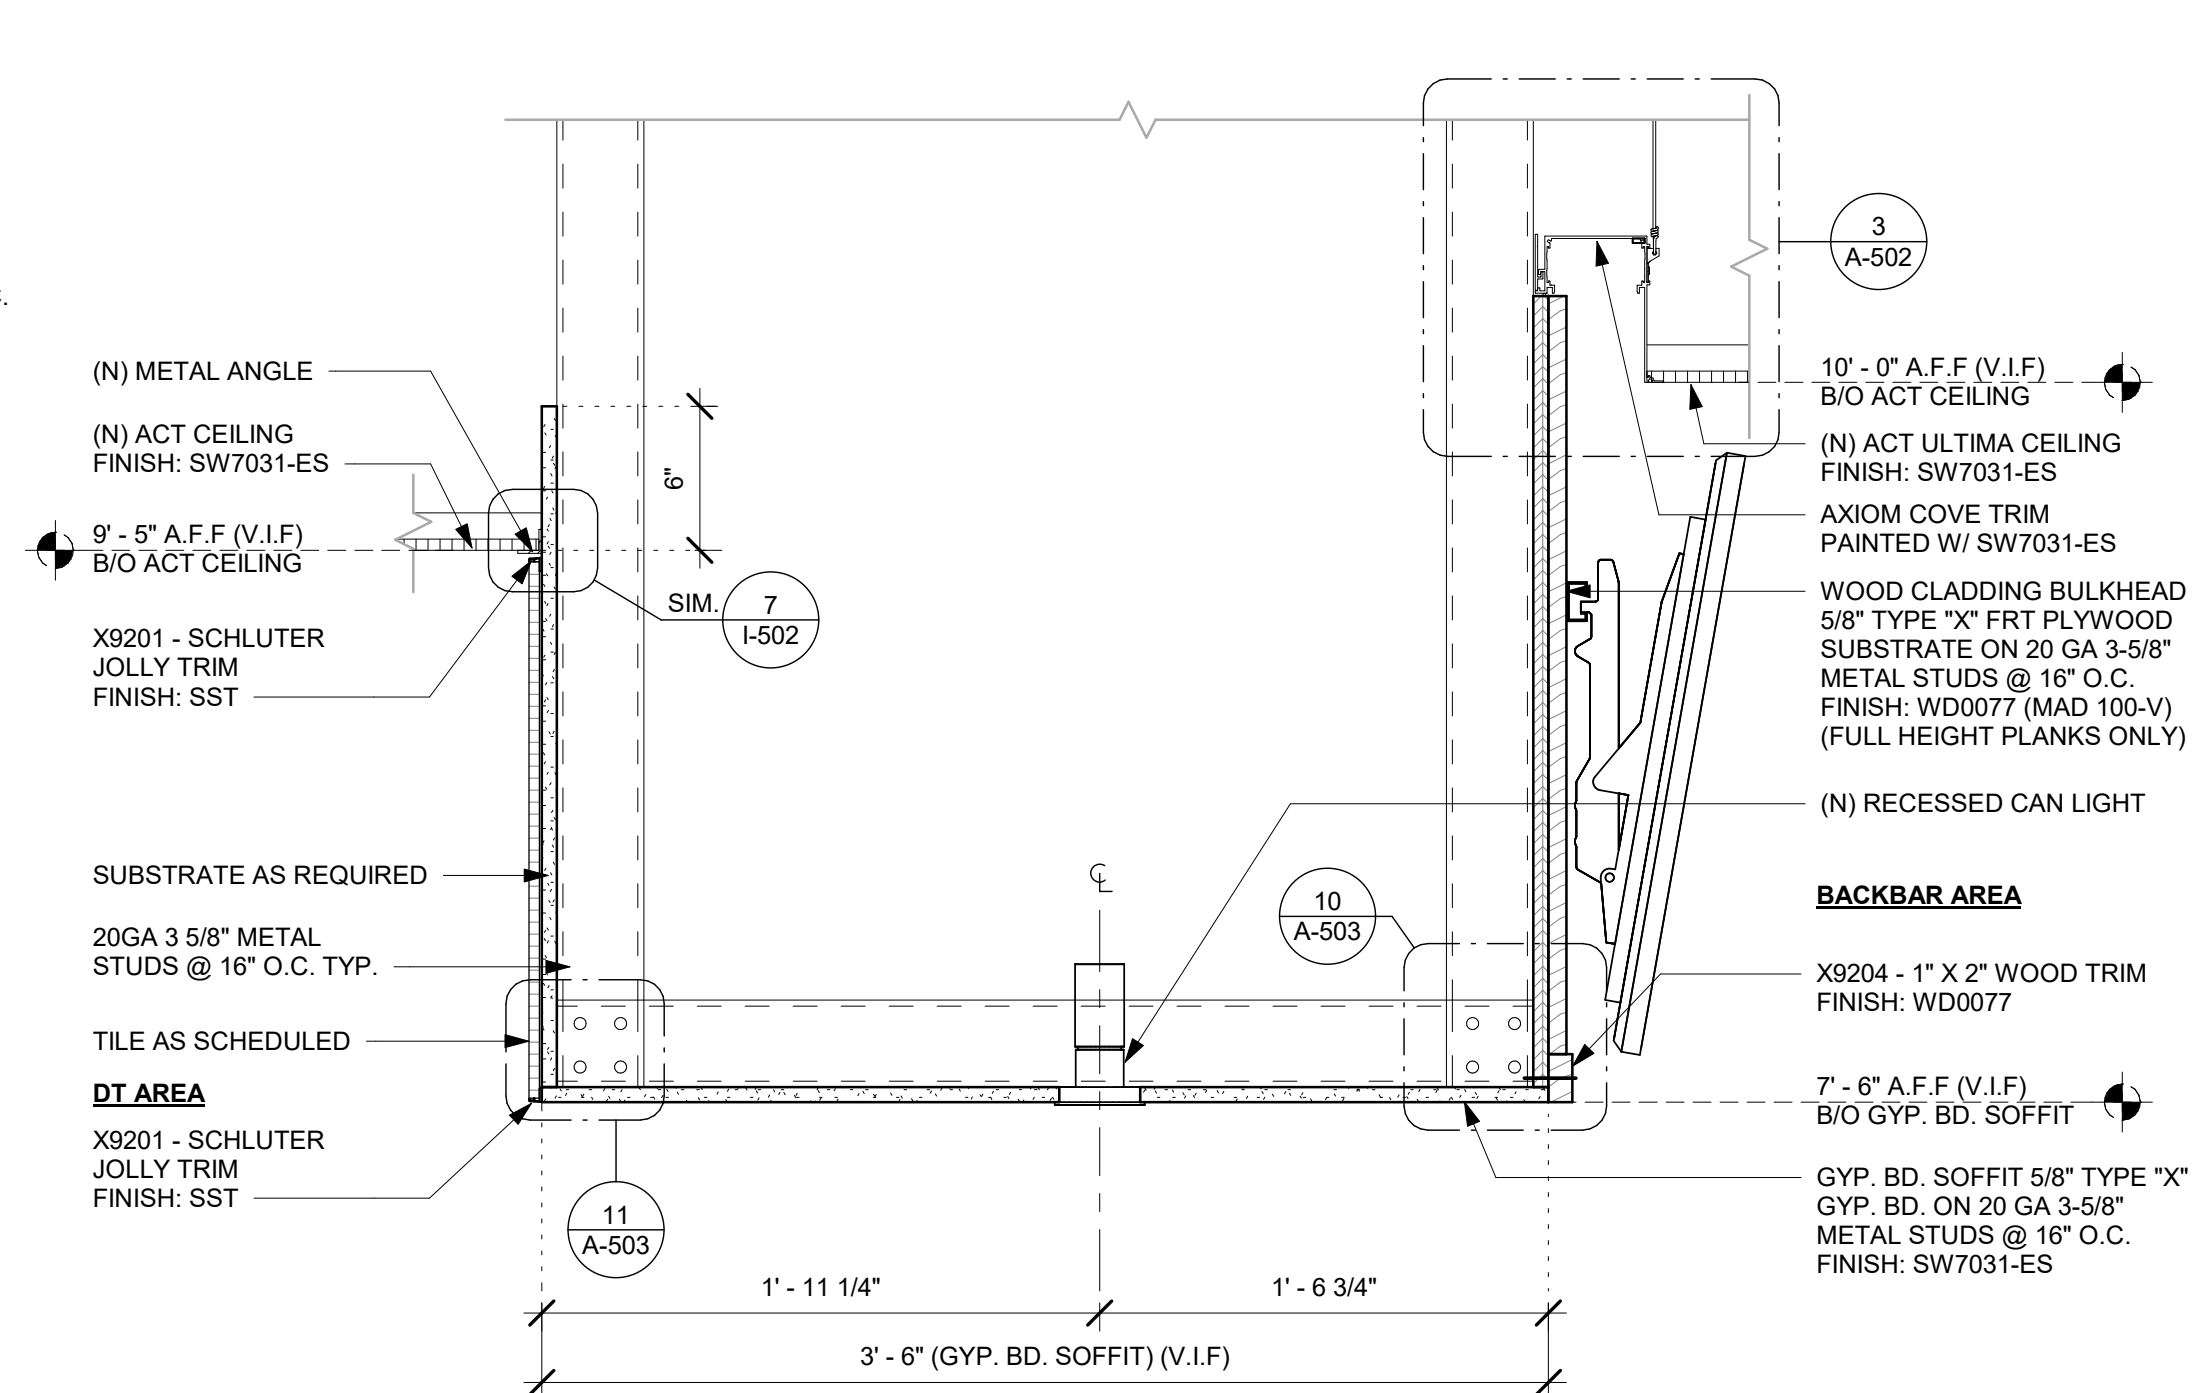


2 HEADER AT DT AREA

Scale: 1 1/2" = 1'-0"

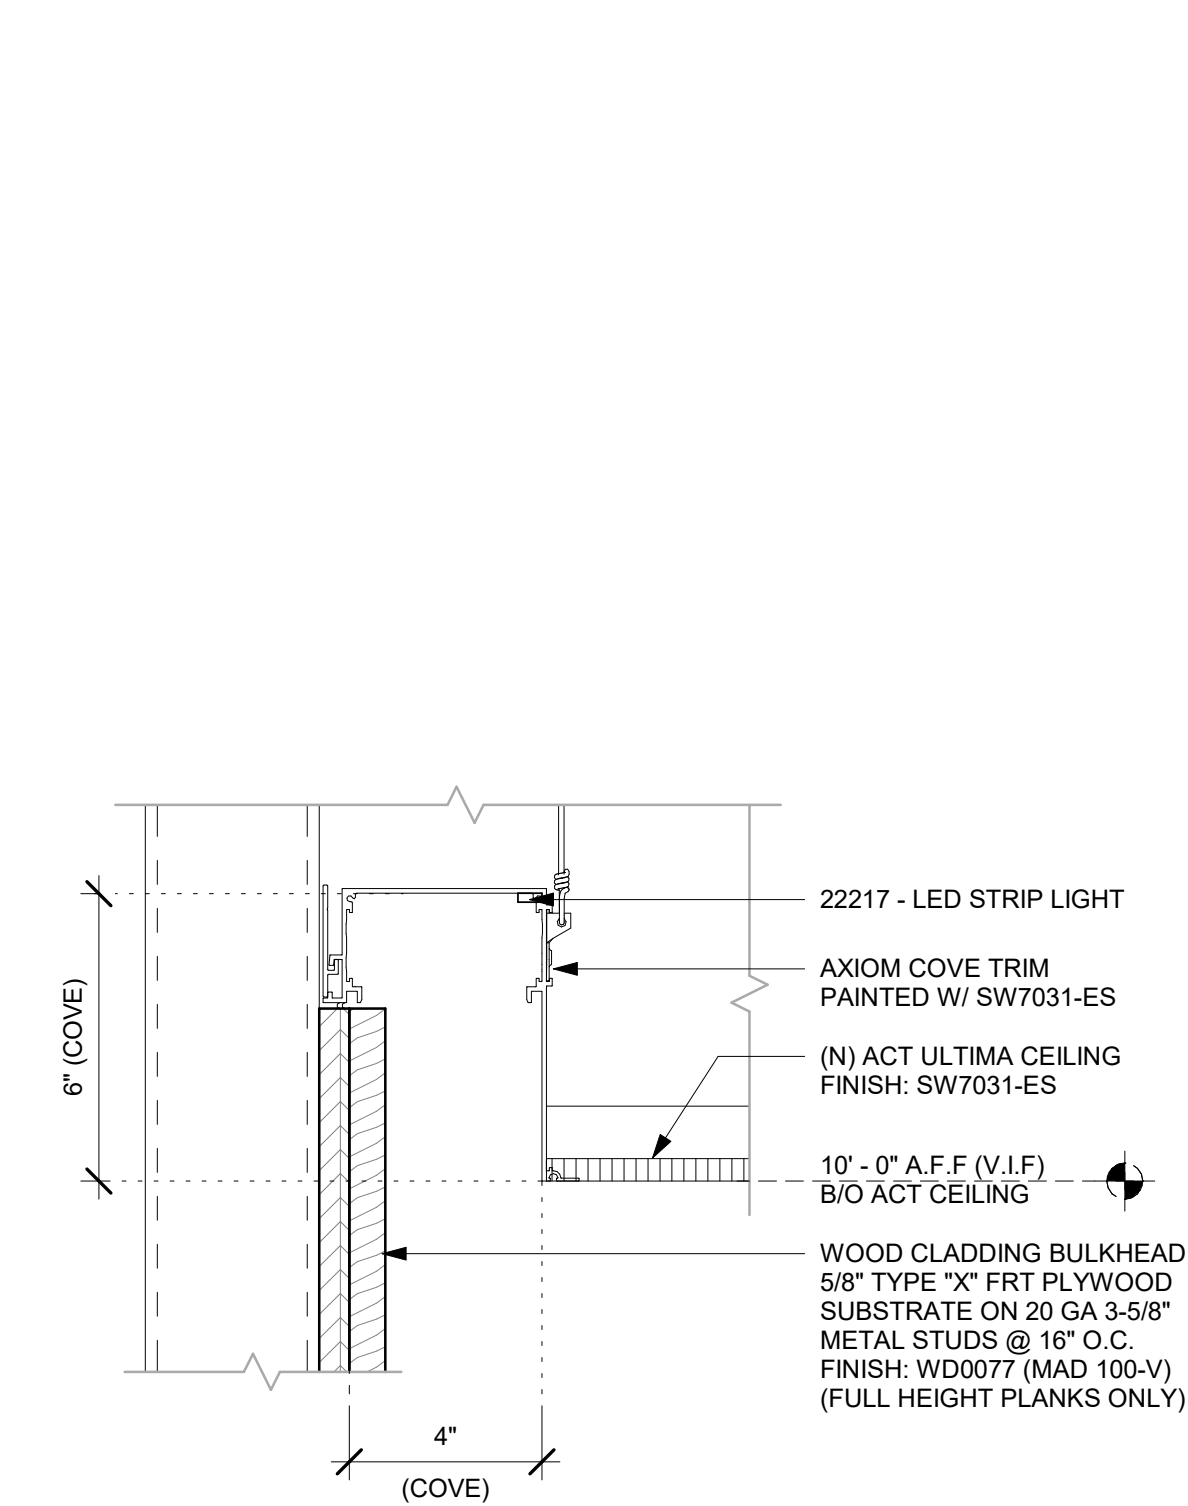


3 COVE DETAIL

Scale: 3" = 1'-0"

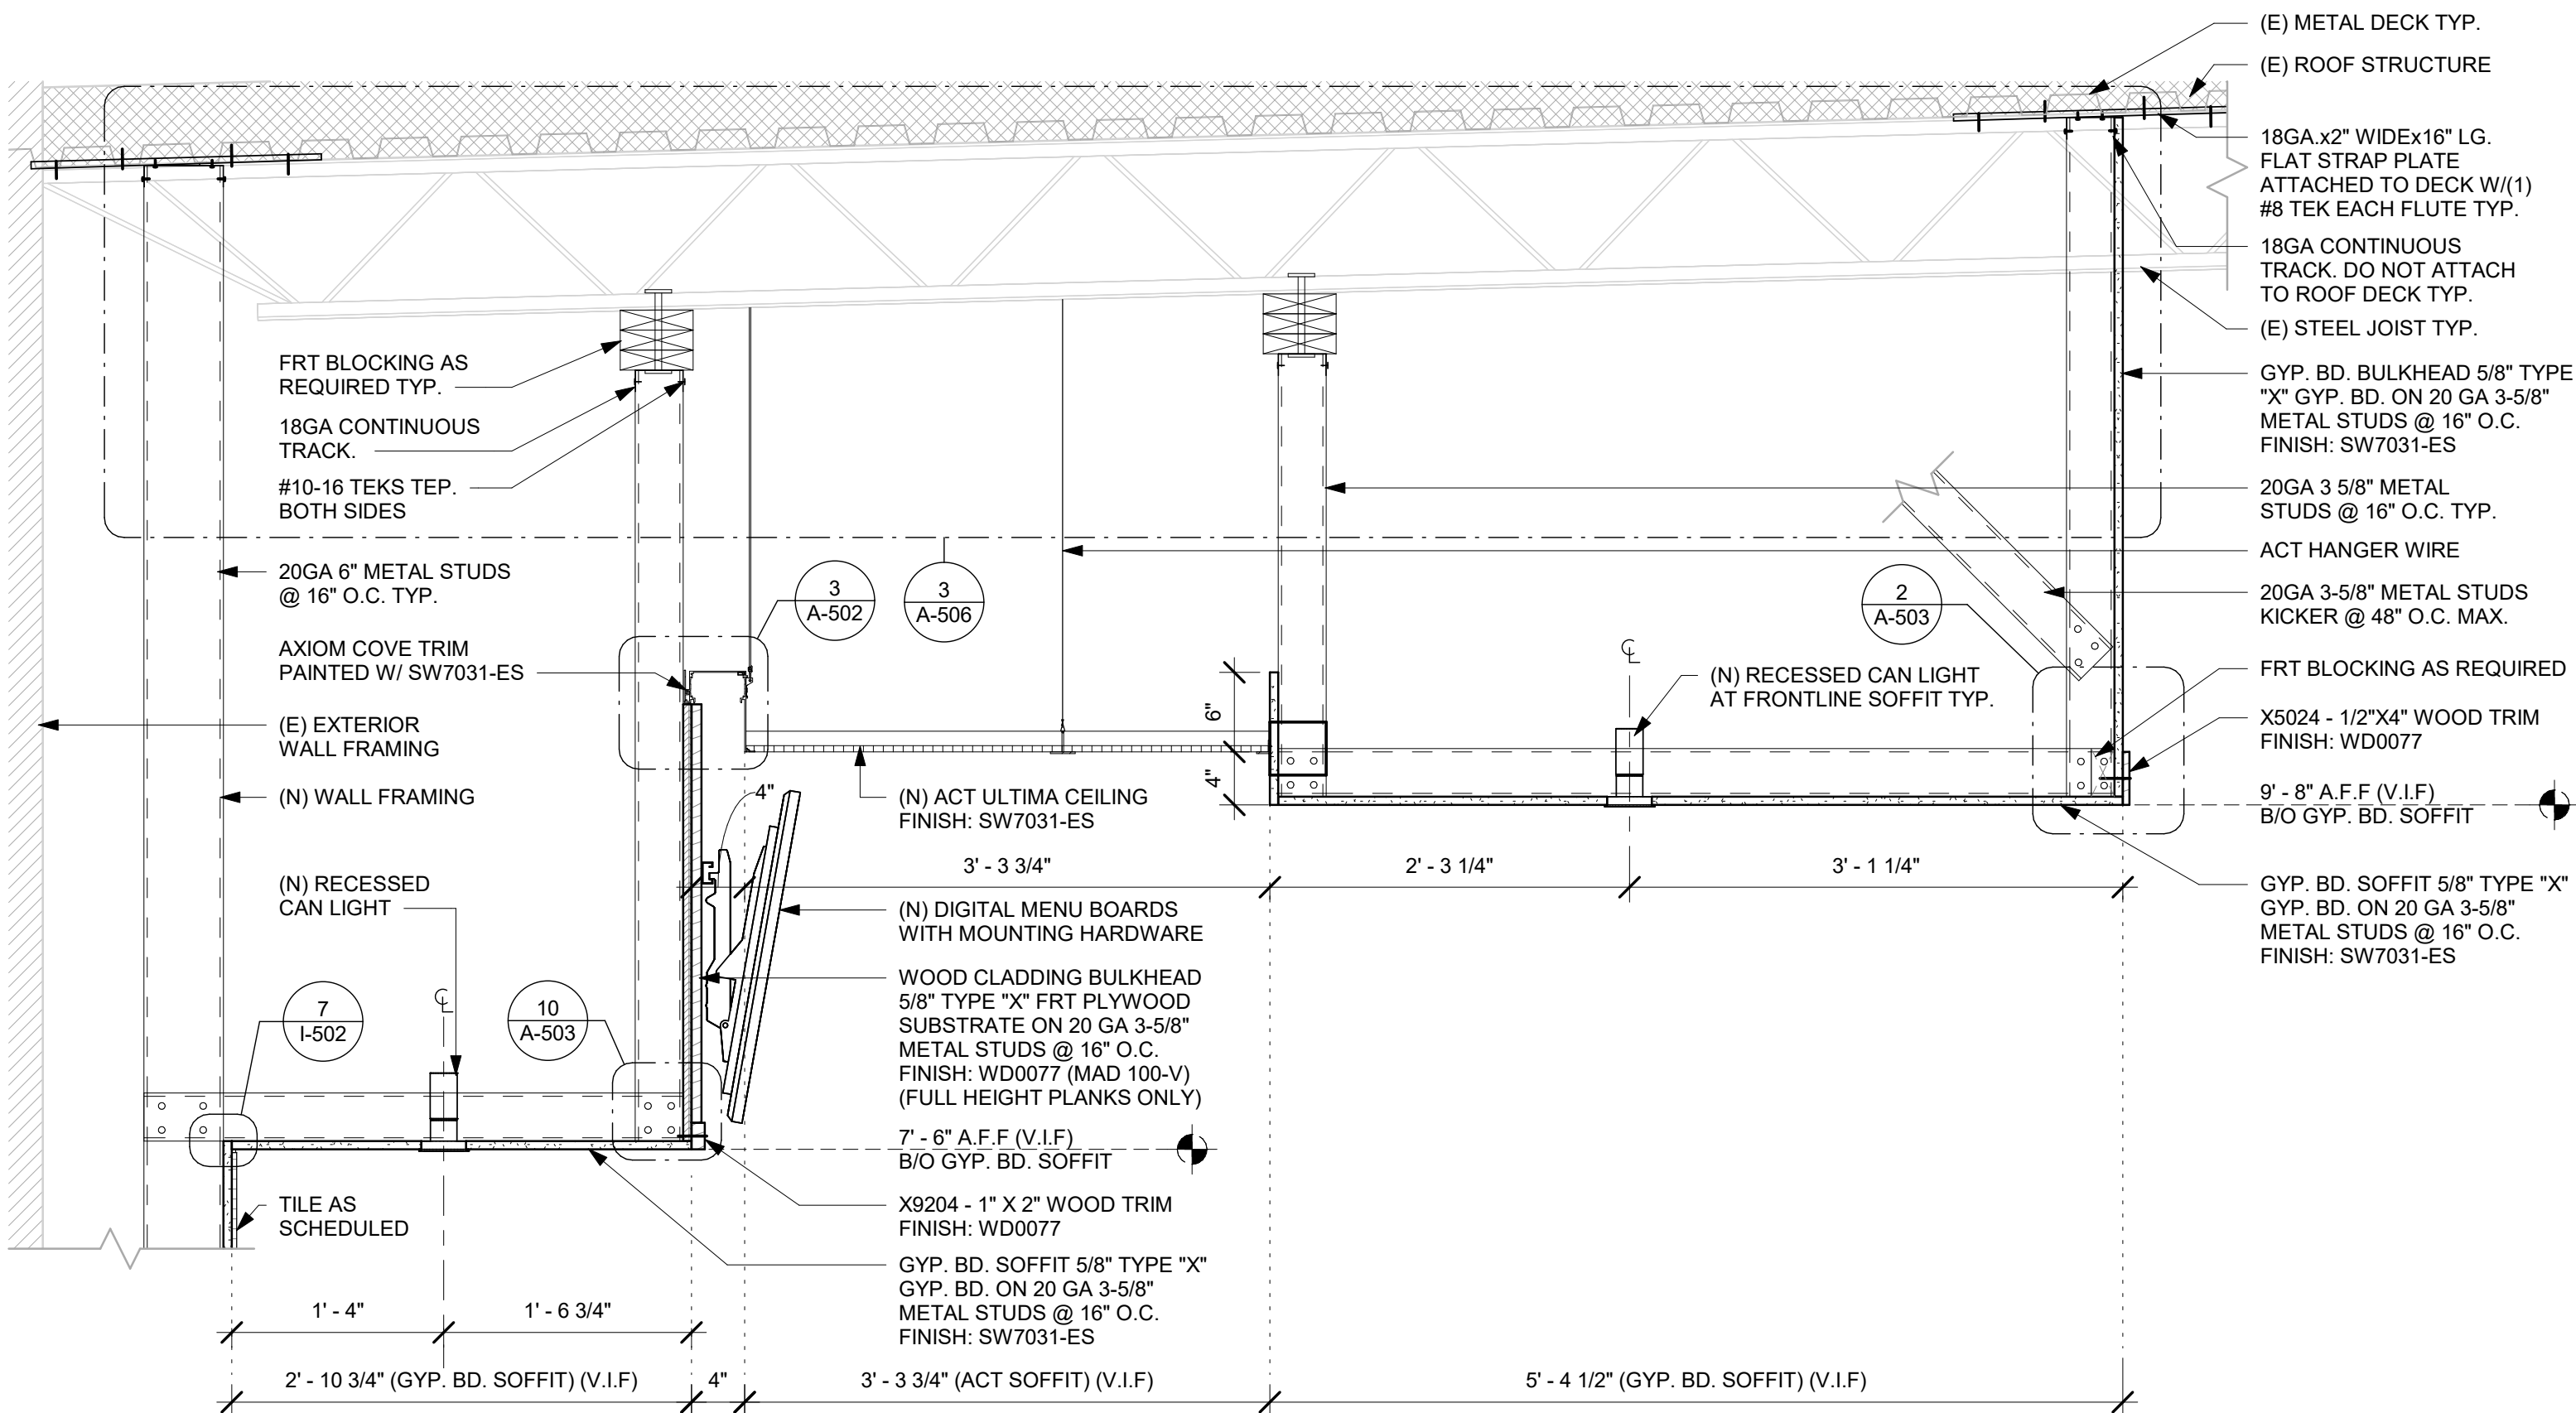


4 SOFFIT CONSTRUCTION

Scale: 1" = 1'-0"

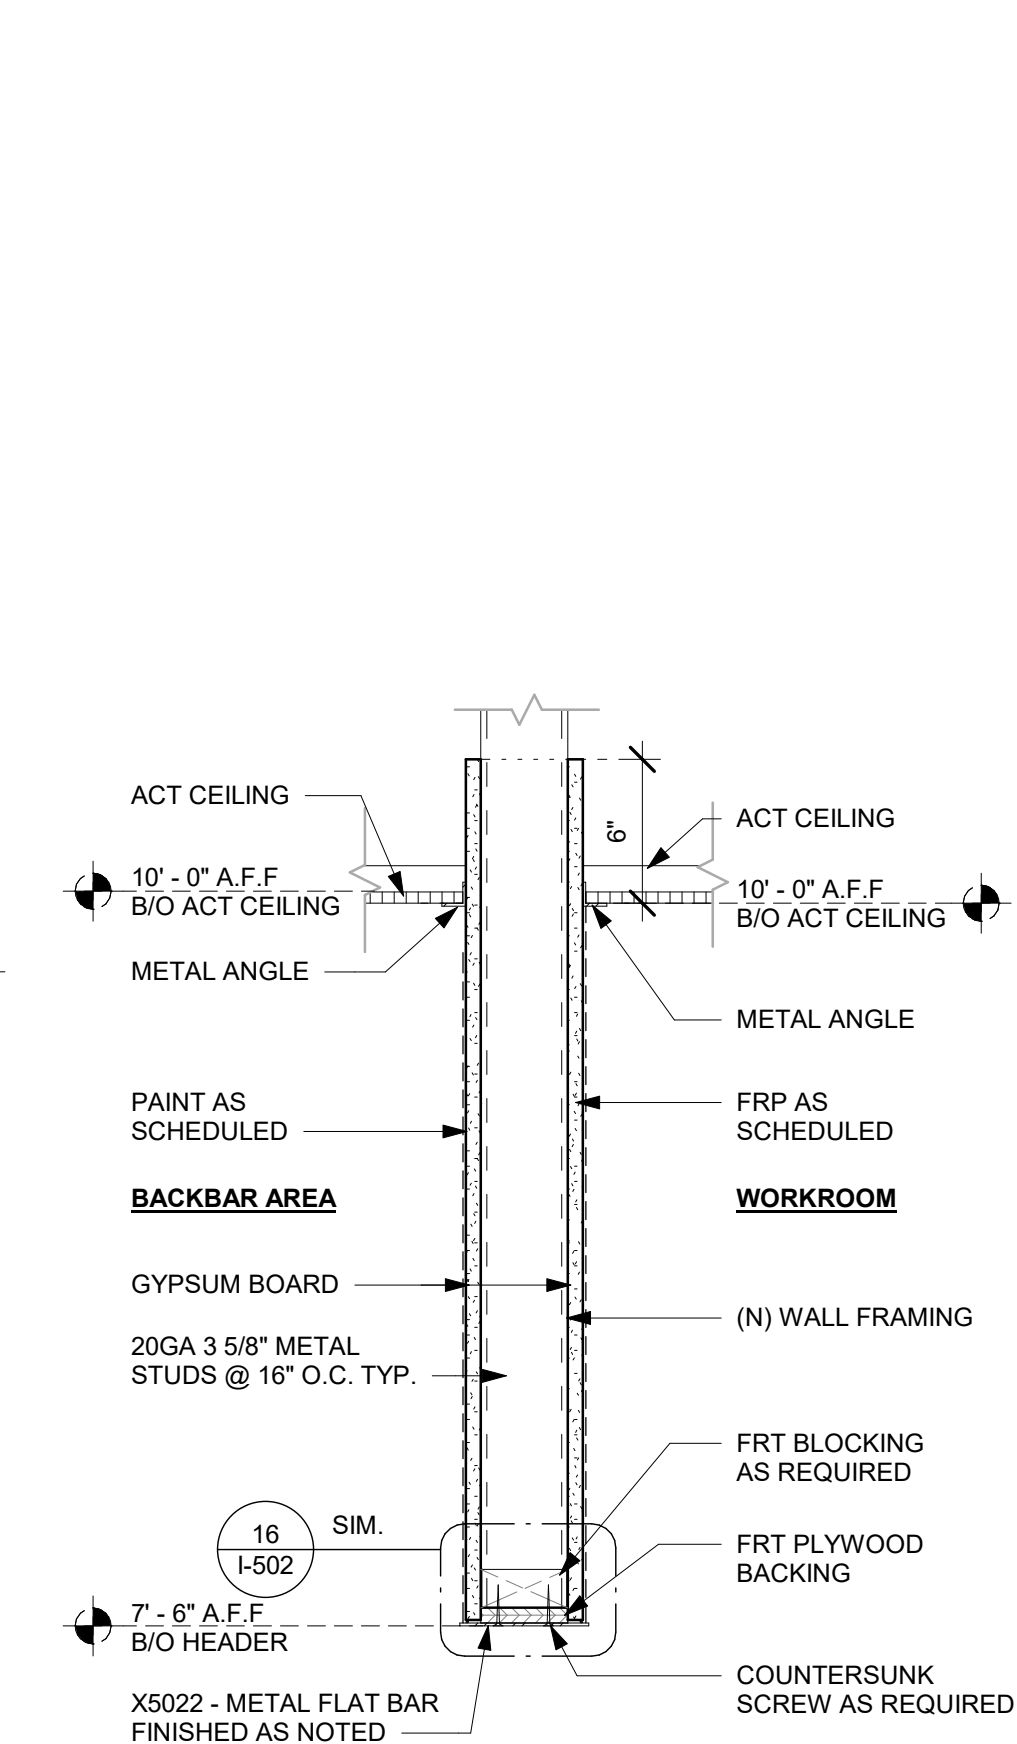

5 HEADER AT WORKROOM

Scale: 1 1/2" = 1'-0"

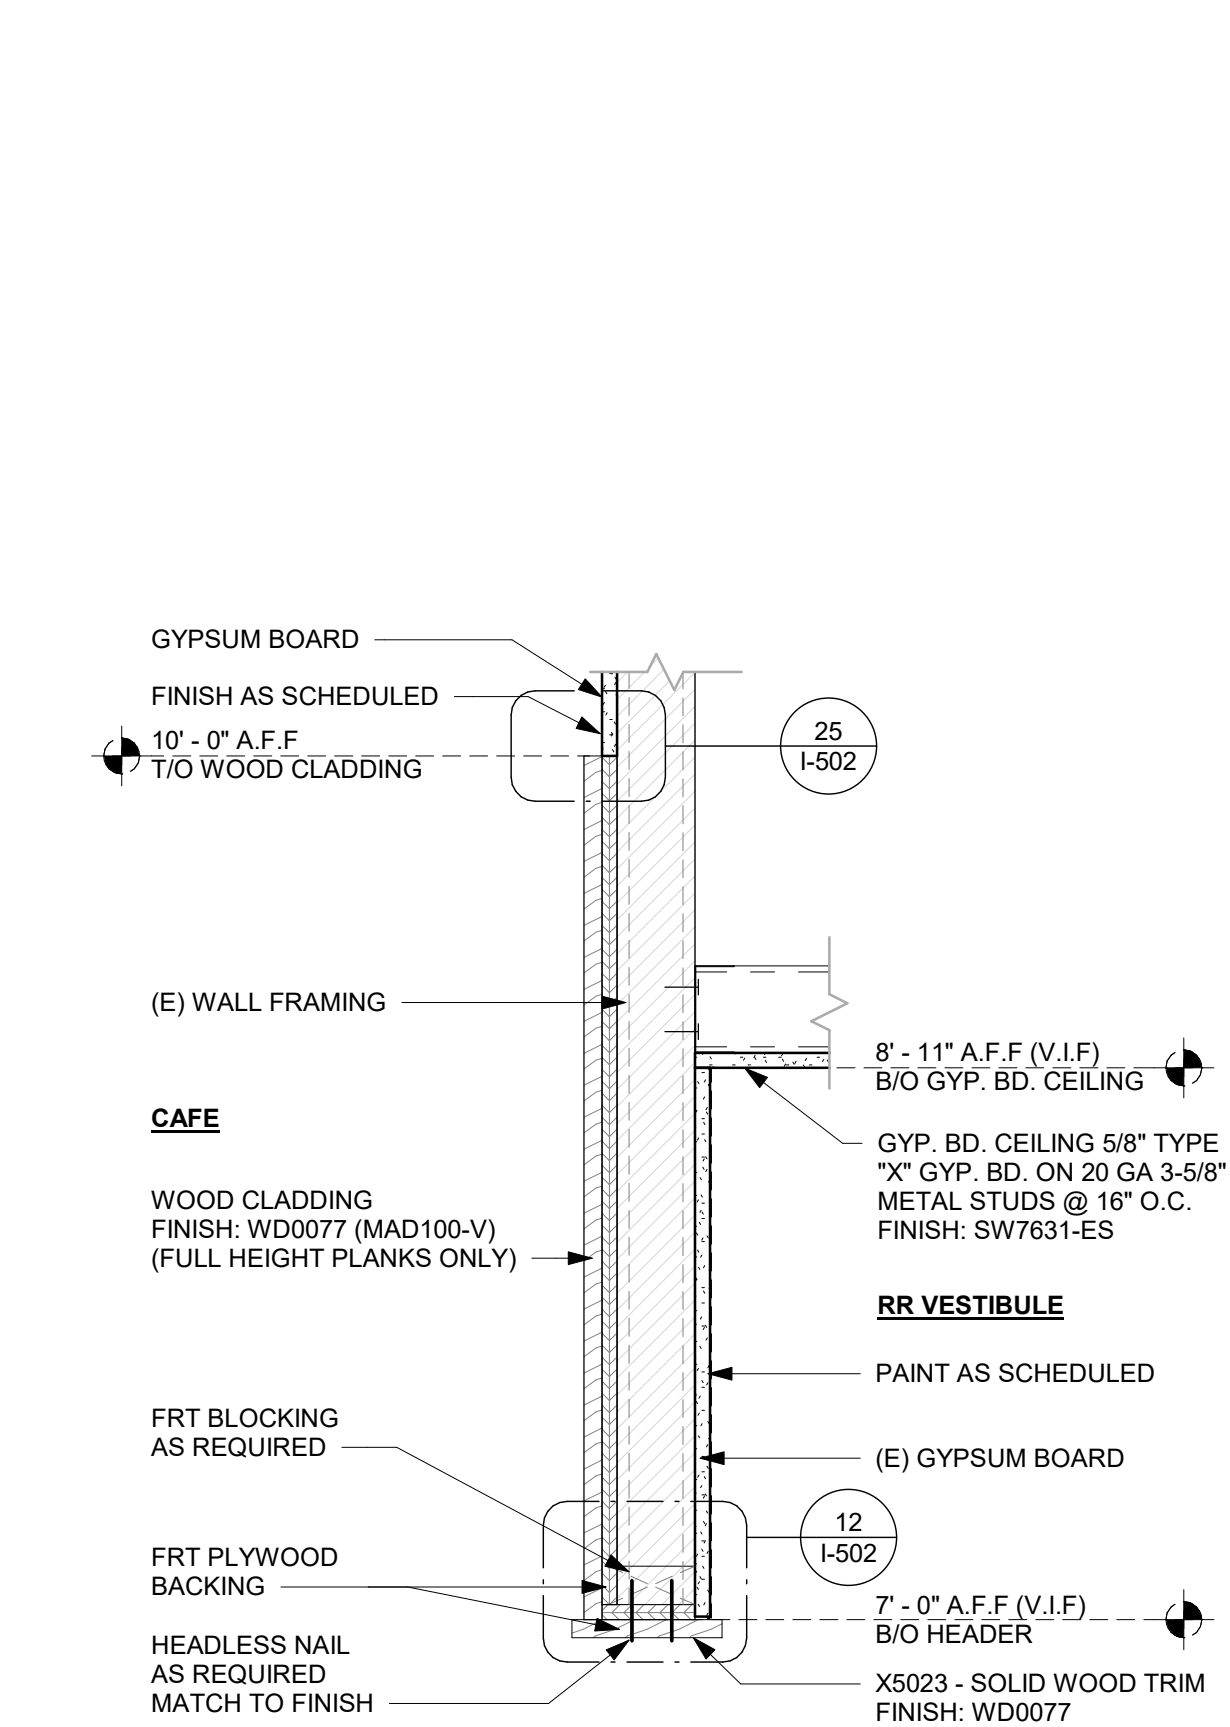

6 HEADER AT RR VESTIBULE

Scale: 1 1/2" = 1'-0"



© 2023 STARBUCKS COFFEE COMPANY

STARBUCKS®
2401 UTAH AVENUE SOUTH
SEATTLE, WASHINGTON 98134
(206) 318-1575

THESE DRAWINGS AND THE PROJECT MANUAL ARE CONFIDENTIAL AND SHALL REMAIN THE SOLE PROPERTY OF STARBUCKS CORPORATION, WHICH IS THE OWNER OF THE COPYRIGHT IN THIS WORK. THEY SHALL NOT BE REPRODUCED IN WHOLE OR IN PART, SHARED WITH THIRD PARTIES OR USED IN ANY MANNER ON OTHER PROJECTS OR EXTENSIONS TO THIS PROJECT WITHOUT THE PRIOR WRITTEN CONSENT OF STARBUCKS CORPORATION. THESE DRAWINGS AND SPECIFICATIONS ARE INTENDED TO EXPRESS DESIGN INTENT FOR A PROTOTYPICAL STARBUCKS STORE (WHICH IS SUBJECT TO CHANGE AT ANYTIME) AND DO NOT REFLECT ACTUAL SITE CONDITIONS. NEITHER PARTY SHALL HAVE ANY OBLIGATION NOR LIABILITY TO THE OTHER (EXCEPT STATED ABOVE) UNTIL A WRITTEN AGREEMENT IS FULLY EXECUTED BY BOTH PARTIES.

STARBUCKS TEMPLATE VERSION: i2023.10.23

Design Forum Architects Inc.

2050 Byers Rd
Miami, OH 45342
Tel: (844) 804-7700

Donald J. Reithman
Architect In Charge
License: AR0017303

MARQUE ENGINEERING
2230 PARK AVE, STE. 100, CINCINNATI, OH 45206
513.457.7131 - WWW.MARQUEENG.COM

FOR CONSTRUCTION

PROJECT NAME:
S SEMORAN BLVD & LEE VISTA BLVD

PROJECT ADDRESS:
**6605 S SEMORAN BLVD
ORLANDO, FL 32822**

STORE #: 9875
PROJECT #: 25630-101
ISSUE DATE: 03/04/2024
DESIGN MANAGER: MARTIN PEREZ
PRODUCTION DESIGNER: ANDY MCLOUD
CHECKED BY: DONALD REITHMAN

Revision Schedule			
Rev	Date	By	Description





SHEET TITLE:
BUILDING DETAILS

SCALE: AS SHOWN


SHEET NUMBER:

A-502

\\file-day.ad.changepinc.com\Client\StarbucksArchitecture\Projects_2023\Florida\Semoran & Lee Vista - 25630-10\25630-101_9875_S Semoran Blvd & Lee Vista Blvd, FL_2023.rvt 3/4/2024 2:39:23 PM

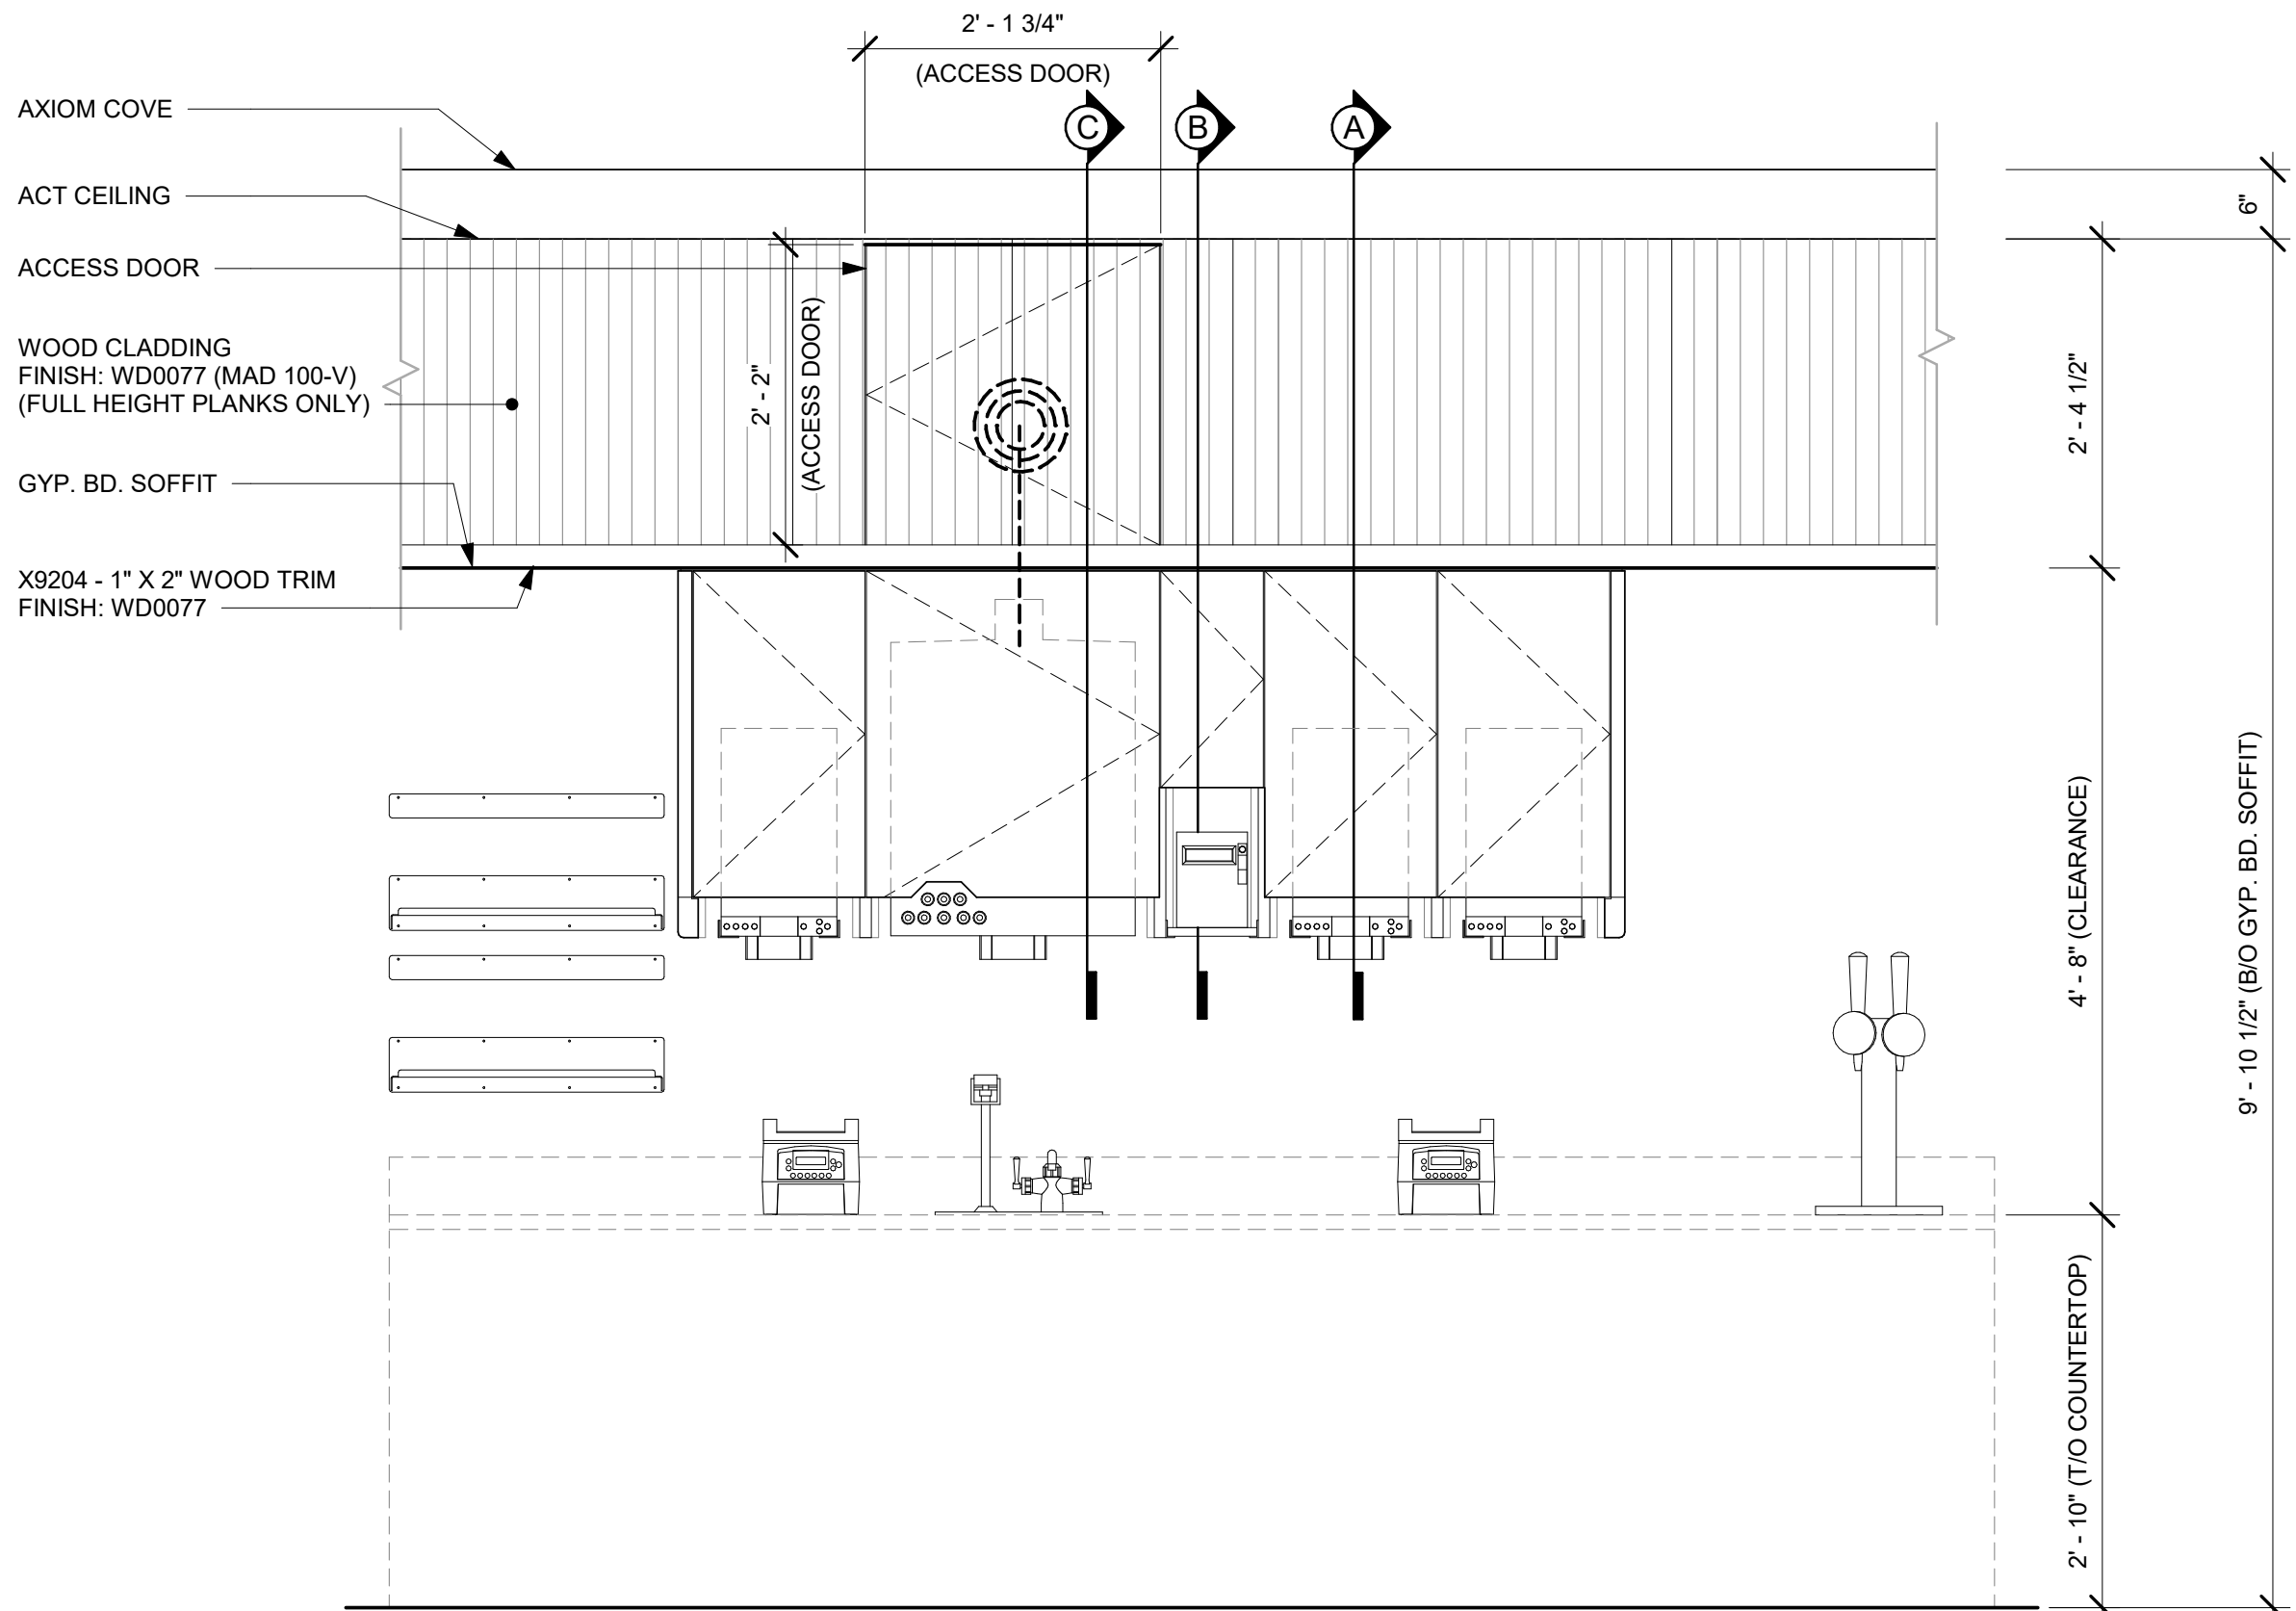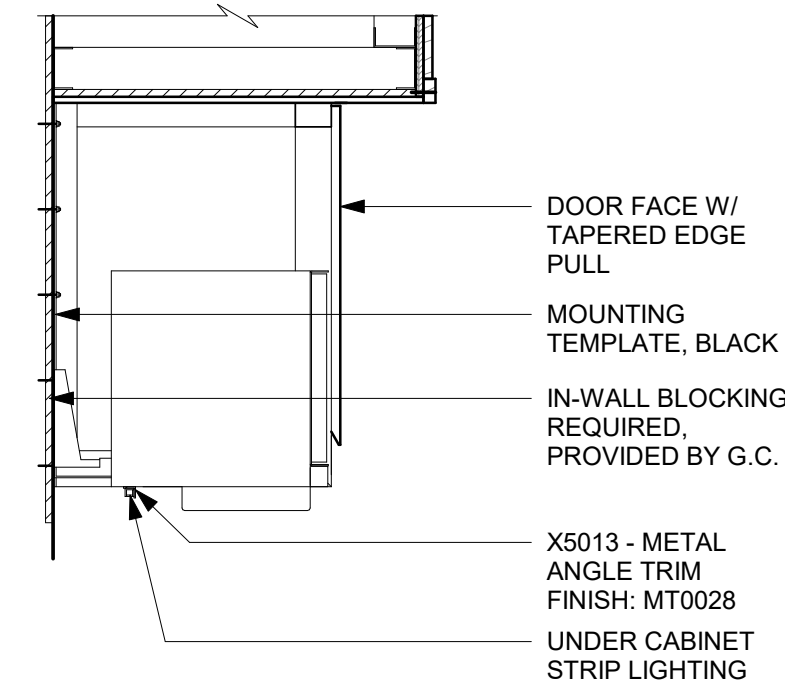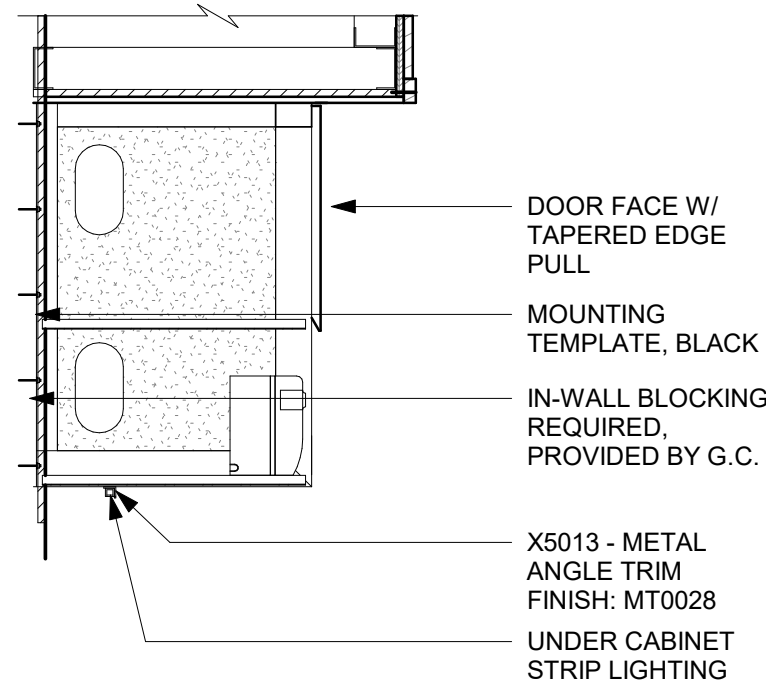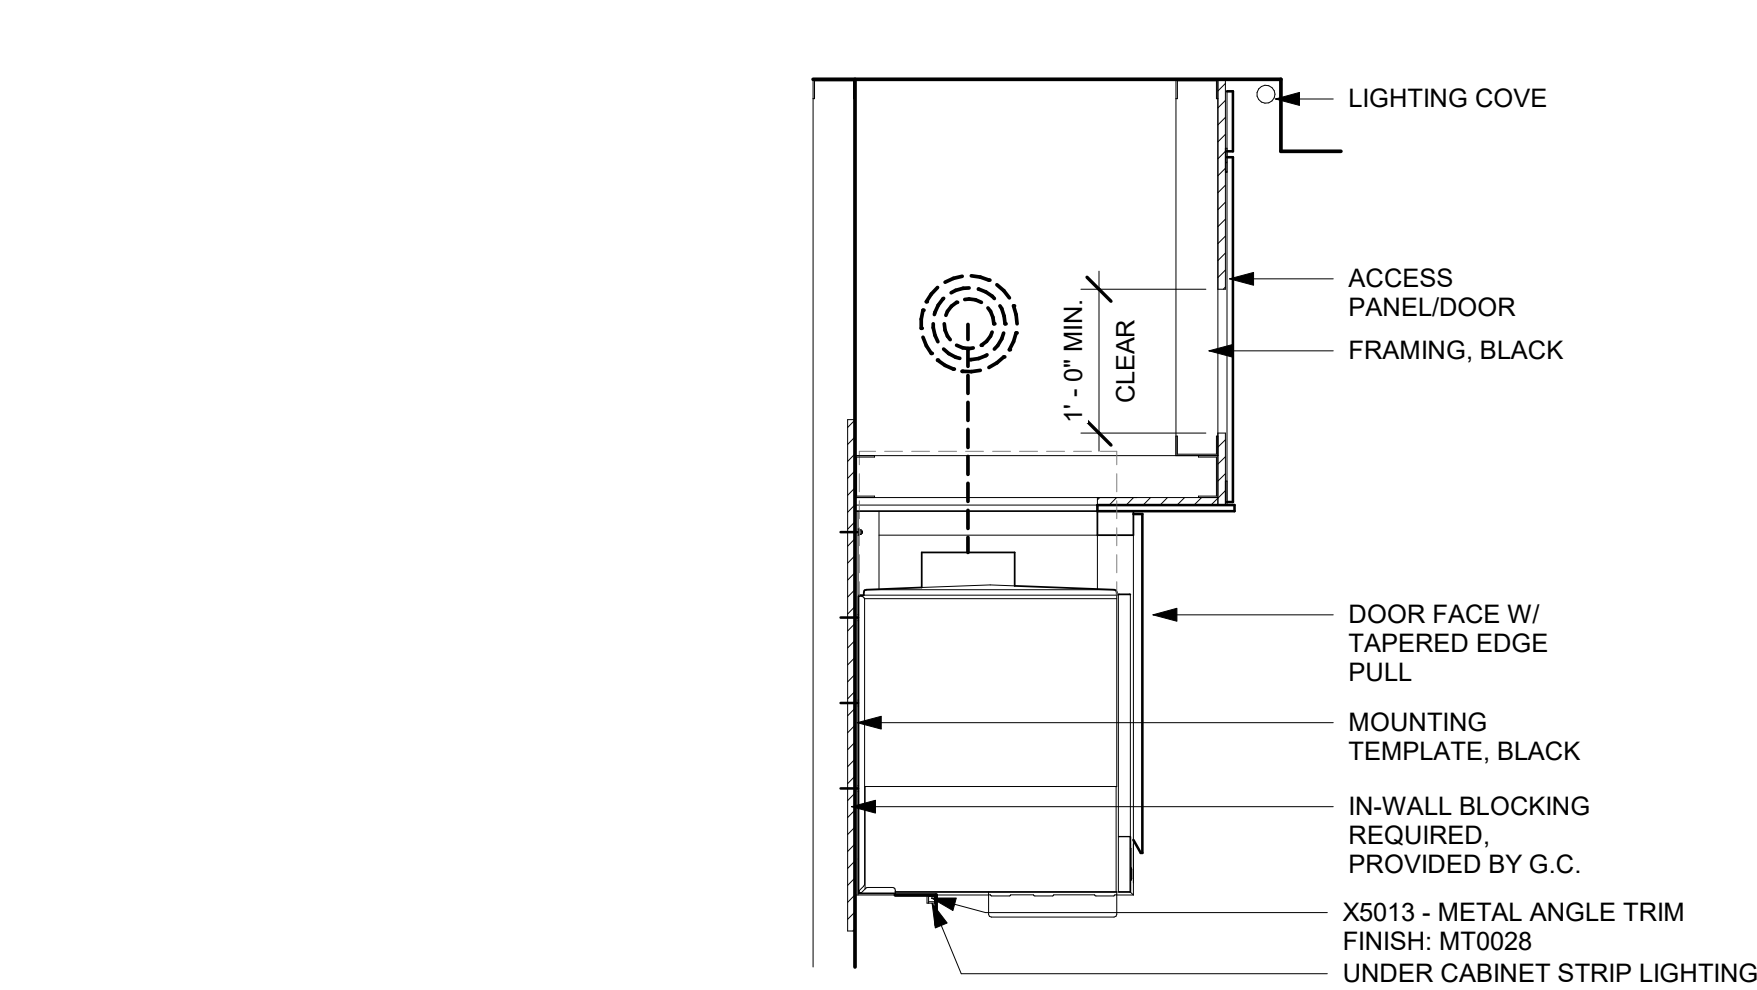


- NOTE:
- CEILING HEIGHT 9' - 10 1/2"
 - 1. NUGGET ICE RIDE SYSTEM TO RUN IN STANDARD SOFFIT
 - 2. DMB TO BE MOUNTED ON FACE OF SOFFIT
 - 3. ACCESS PANEL TO BE SIZED TO AVOID CONFLICT WITH LIGHTING COVE

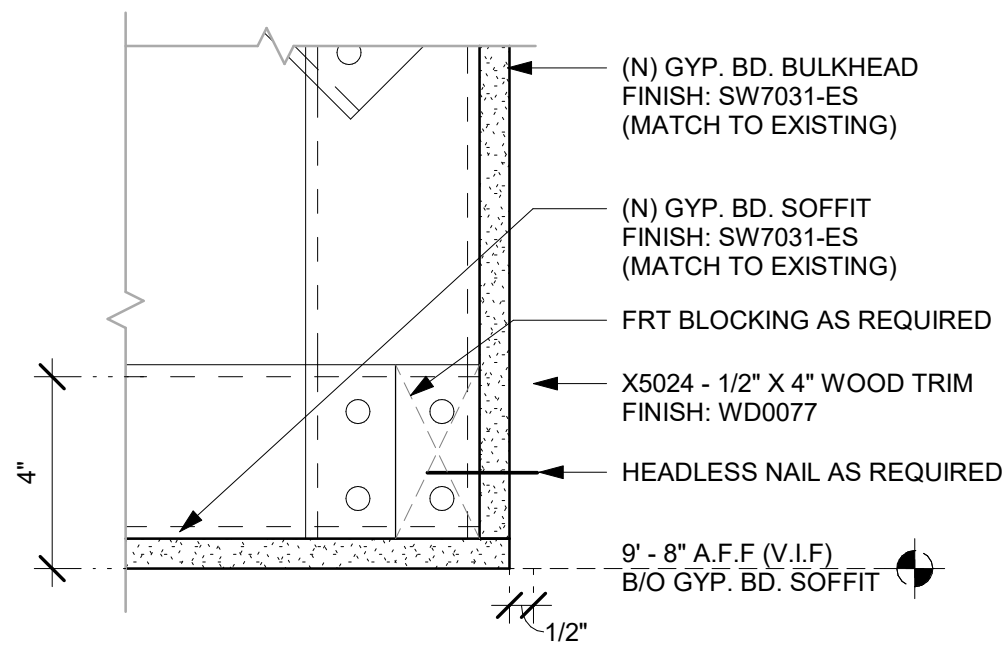


1 UPPER CABINET/SOFFIT ASSEMBLY - STANDARD

Scale: 3/4" = 1'-0"

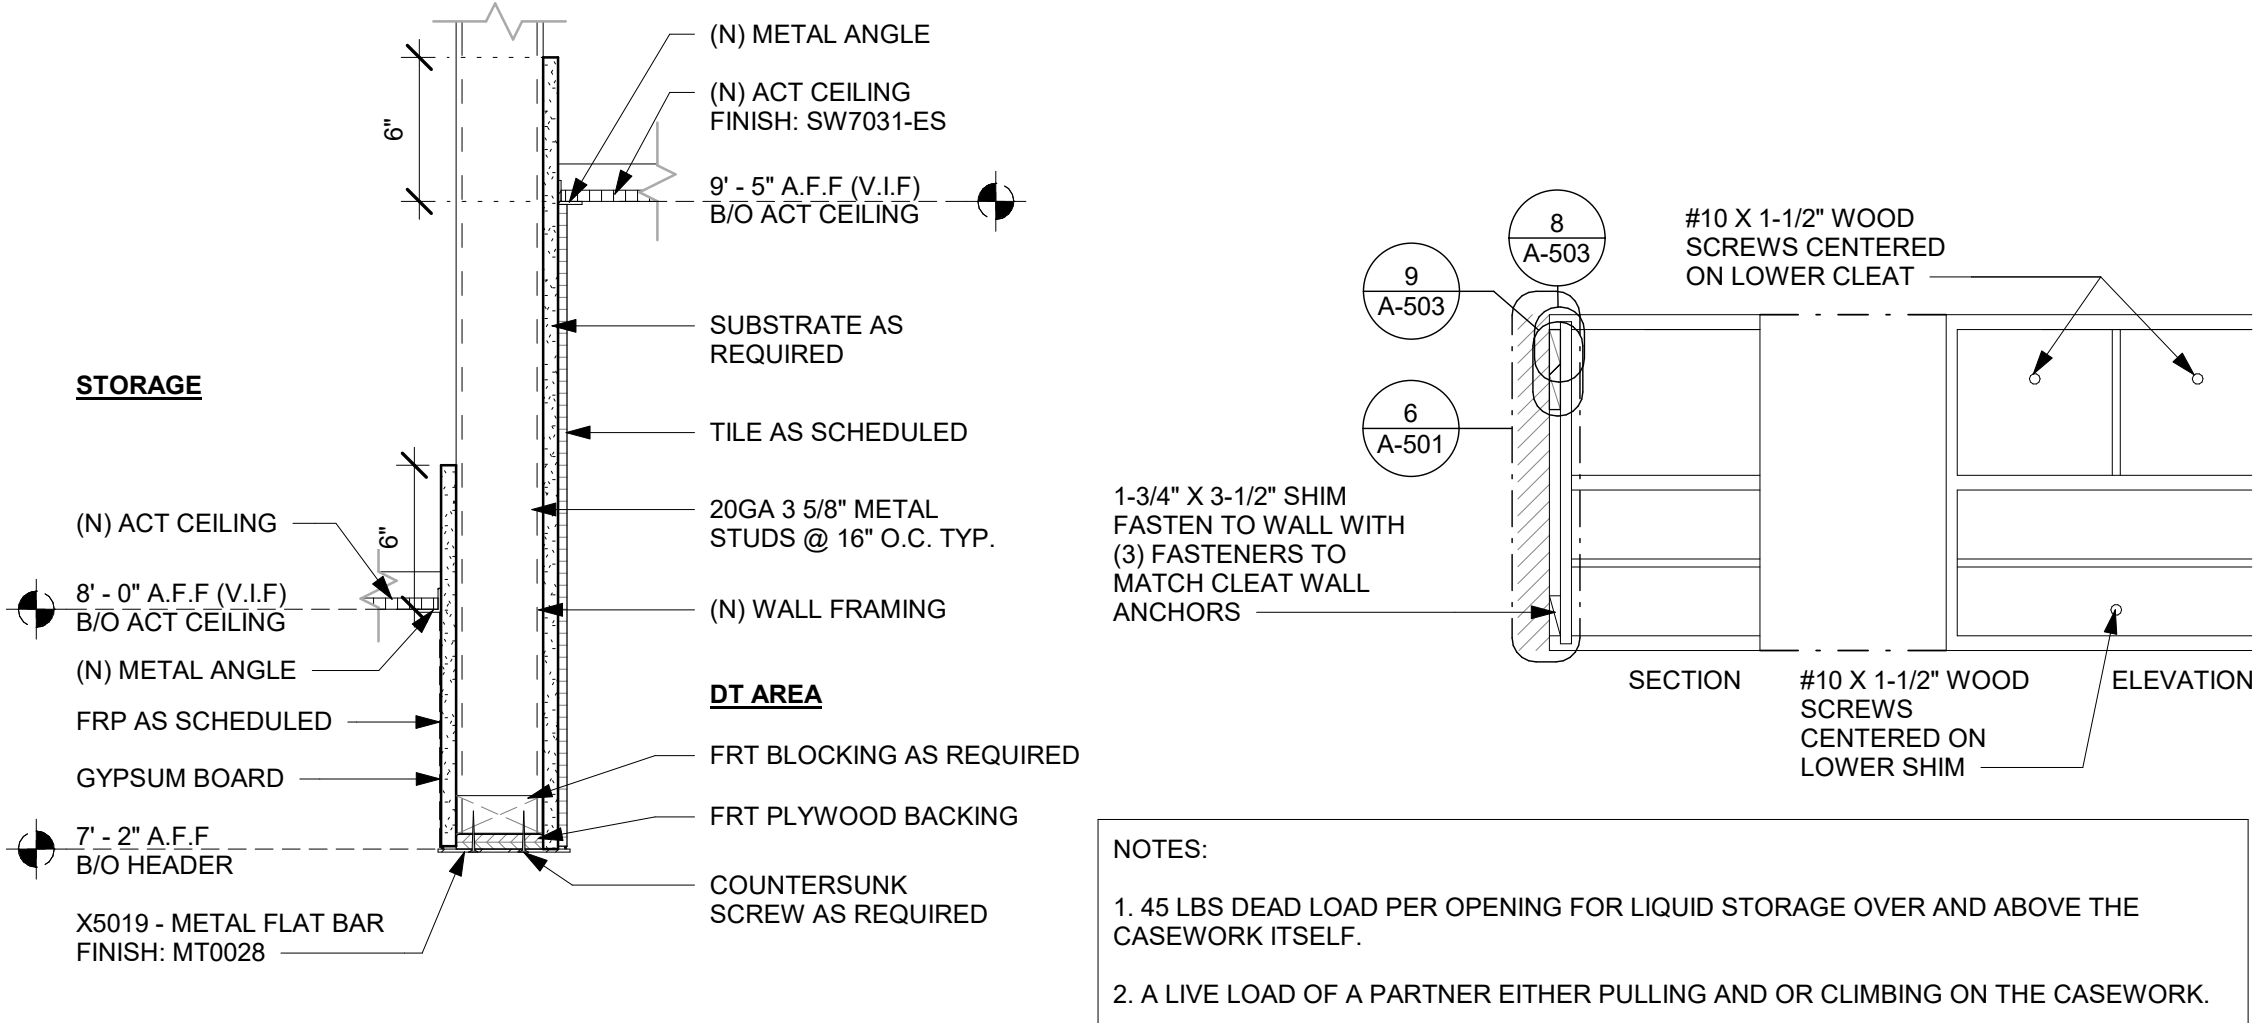

3 HEADER AT STORAGE

Scale: 1 1/2" = 1'-0"

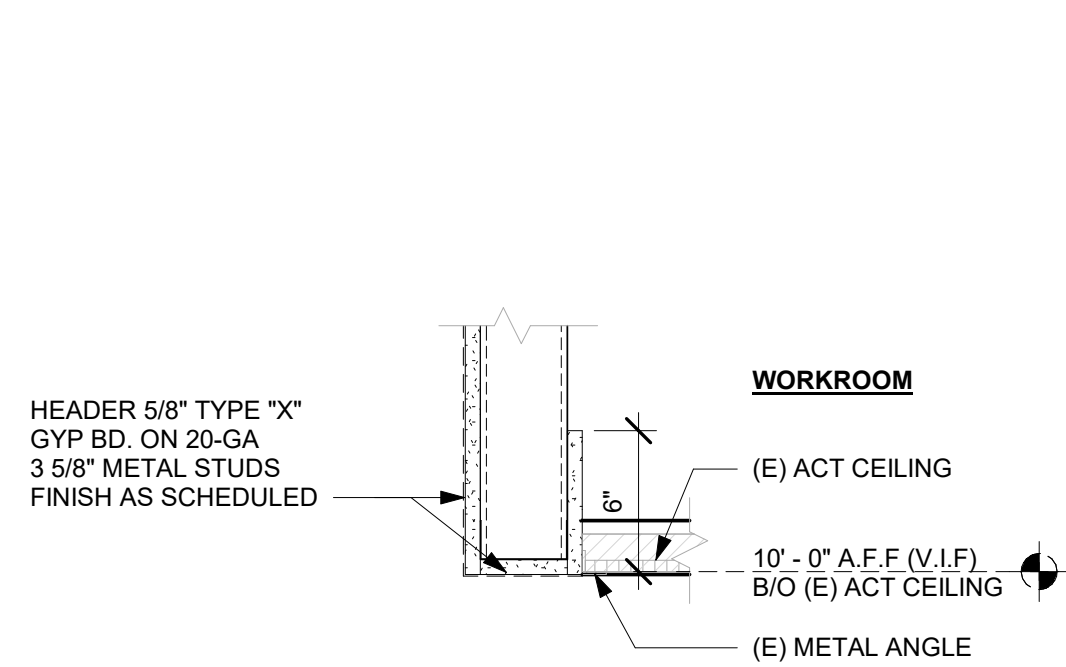


7 HEADER AT WATER FILTRATION AREA

Scale: 1 1/2" = 1'-0"



4 BLOCKING AT CASEWORK

Scale: N.T.S.

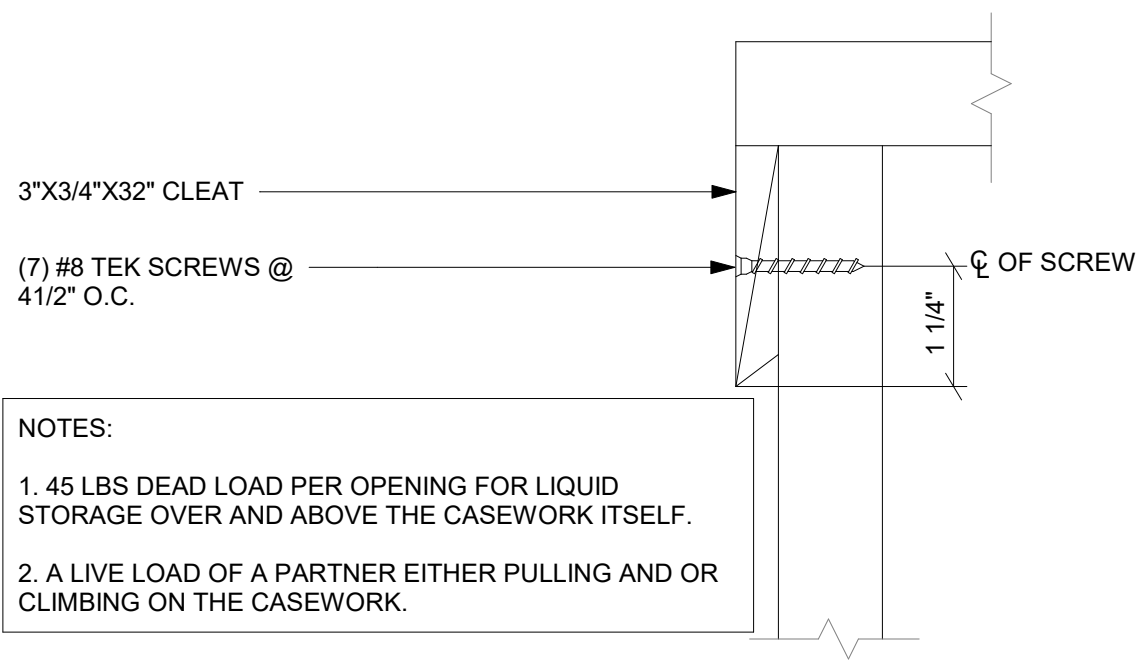


8 CLEAT TO FRAME

Scale: N.T.S.



5 BLOCKING TO METAL STUD

Scale: N.T.S.

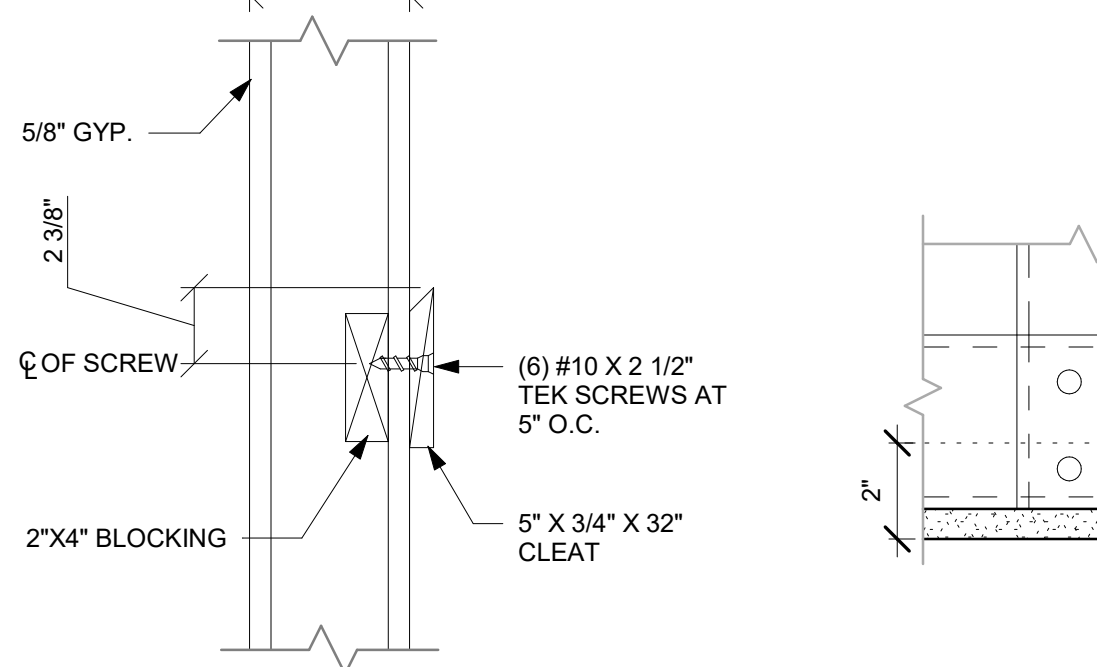


9 CLEAT TO WOOD BLOCKING

Scale: N.T.S.



6 X5013 - METAL ANGLE TRIM DETAIL AT CBE UPPER CABINET

Scale: 3" = 1'-0"

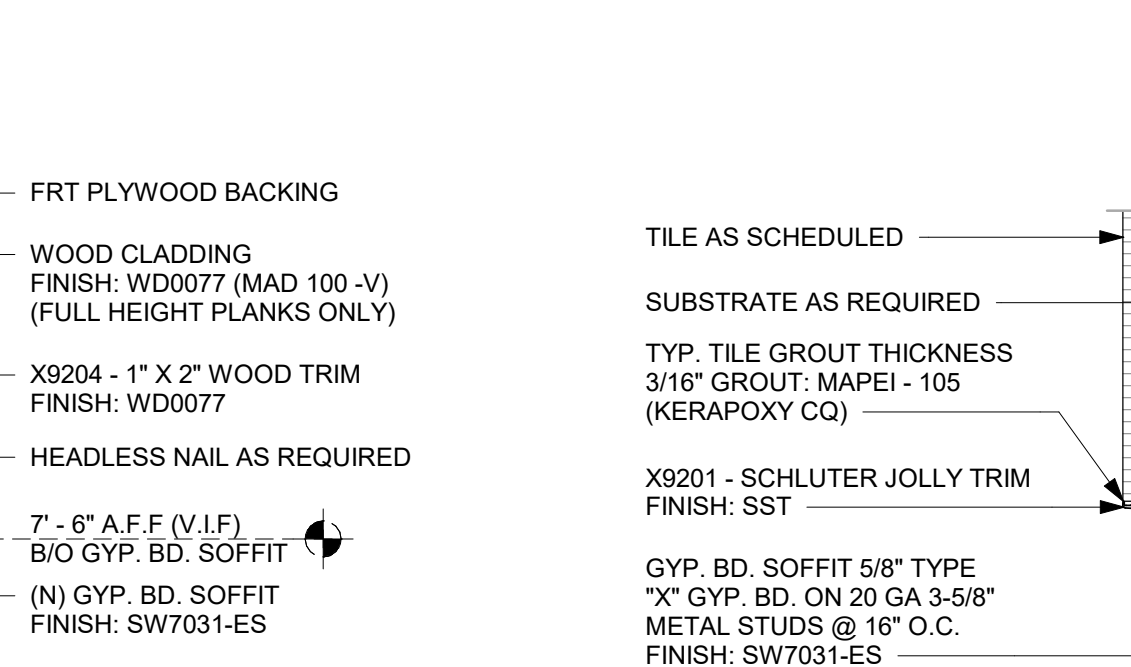

10 X9204 - WOOD TRIM ENLARGE DETAIL

Scale: 3" = 1'-0"



11 SOFFIT EDGE DETAIL AT DT SIDE

Scale: 3" = 1'-0"



© 2023 STARBUCKS COFFEE COMPANY

STARBUCKS®
2401 UTAH AVENUE SOUTH
SEATTLE, WASHINGTON 98134
(206) 318-1575

THESE DRAWINGS AND THE PROJECT MANUAL ARE CONFIDENTIAL AND SHALL REMAIN THE SOLE PROPERTY OF STARBUCKS CORPORATION, WHICH IS THE OWNER OF THE COPYRIGHT IN THIS WORK. THEY SHALL NOT BE REPRODUCED IN WHOLE OR IN PART, SHARED WITH THIRD PARTIES OR USED IN ANY MANNER ON OTHER PROJECTS OR EXTENSIONS TO THIS PROJECT WITHOUT THE PRIOR WRITTEN CONSENT OF STARBUCKS CORPORATION. THESE DRAWINGS AND SPECIFICATIONS ARE INTENDED TO EXPRESS DESIGN INTENT FOR A PROTOTYPICAL STARBUCKS STORE (WHICH IS SUBJECT TO CHANGE AT ANYTIME) AND DO NOT REFLECT ACTUAL SITE CONDITIONS. NEITHER PARTY SHALL HAVE ANY OBLIGATION NOR LIABILITY TO THE OTHER (EXCEPT STATED ABOVE) UNTIL A WRITTEN AGREEMENT IS FULLY EXECUTED BY BOTH PARTIES.

STARBUCKS TEMPLATE VERSION: i2023.10.23

Design Forum Architects Inc.

2050 Byers Rd
Miami, FL 33134
Tel: (844) 804-7700

Donald J. Rehman
Architect In Charge
License: AR0017303



2230 PARK AVE, STE. 100, CINCINNATI, OH 45206
513.457.7131 - WWW.MARQUEENG.COM

FOR CONSTRUCTION

PROJECT NAME:
S SEMORAN BLVD & LEE VISTA BLVD

PROJECT ADDRESS:
**6605 S SEMORAN BLVD
ORLANDO, FL 32822**


STORE #: 9875
PROJECT #: 25630-101
ISSUE DATE: 03/04/2024
DESIGN MANAGER: MARTIN PEREZ
PRODUCTION DESIGNER: ANDY MCLOUD
CHECKED BY: DONALD REHMAN

Revision Schedule			
Rev	Date	By	Description


SHEET TITLE:
BUILDING DETAILS

SCALE: AS SHOWN



SHEET NUMBER:
A-503

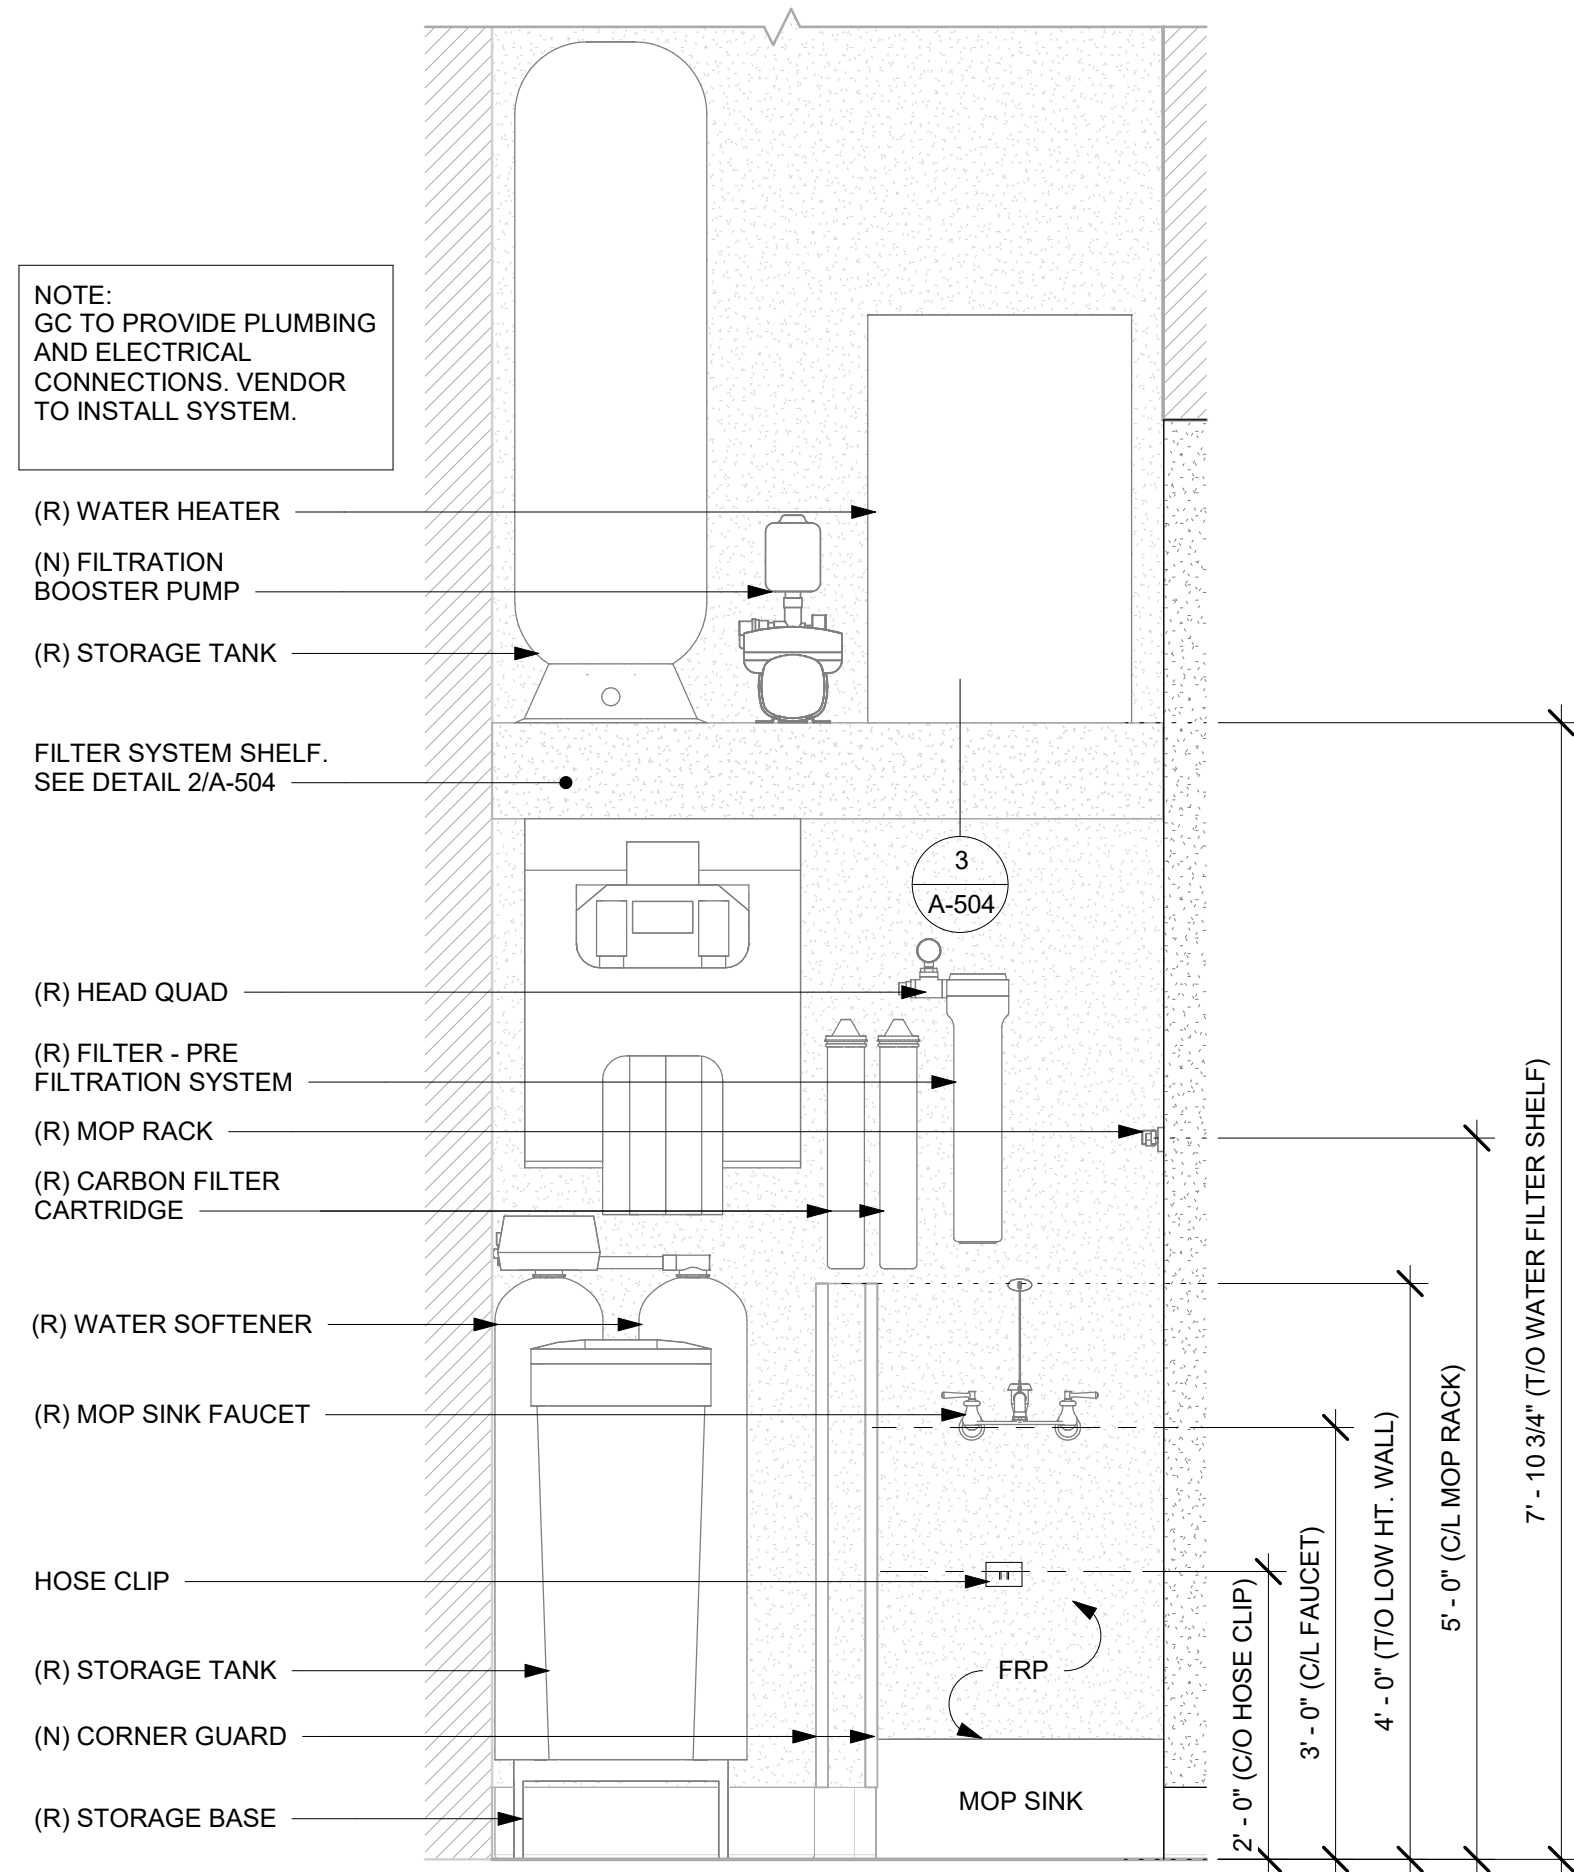


1 WATER FILTRATION SYSTEM ELEVATION

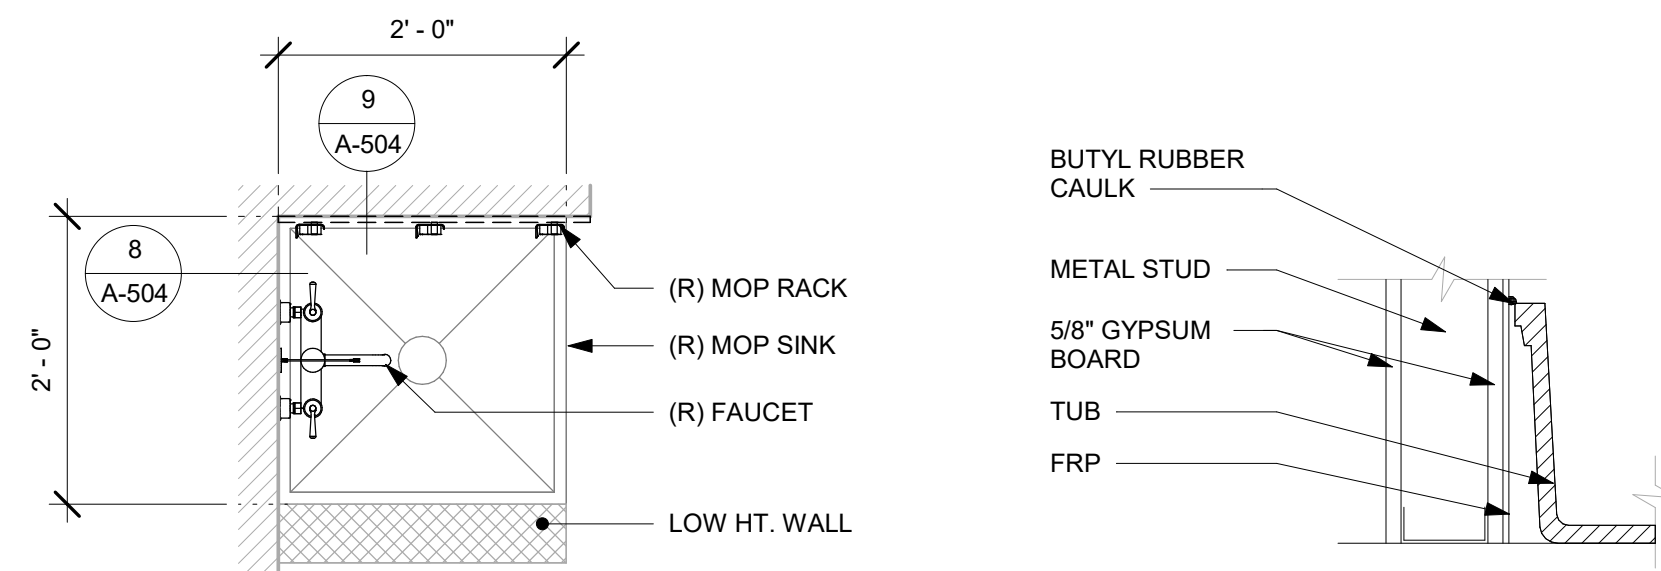







7 MOP SINK - PLAN
Scale: 3/4" = 1'-0"

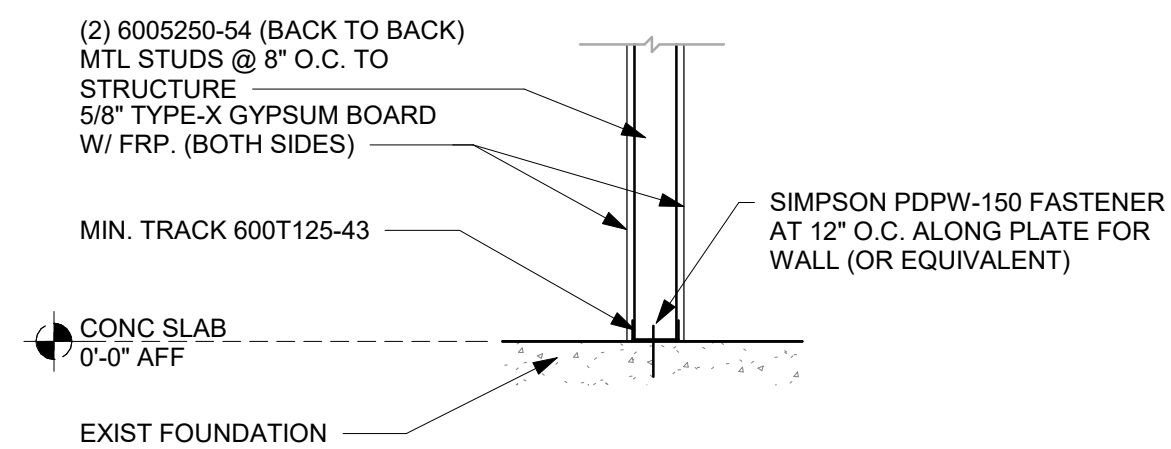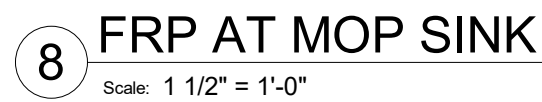

9 FILTER SYSTEM SHELF CONNECTION AT FOUNDATION
Scale: 3/4" = 1'-0"

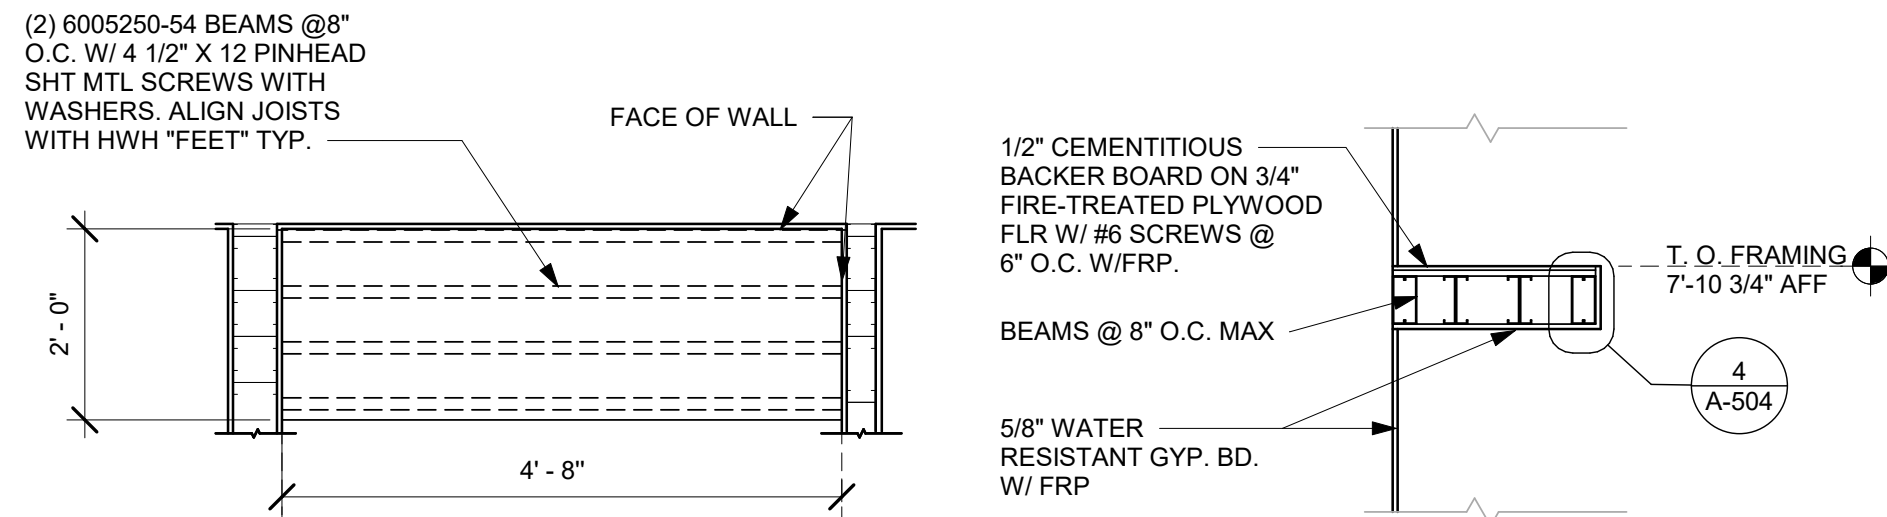

2 FILTER SYSTEM SHELF - PLAN

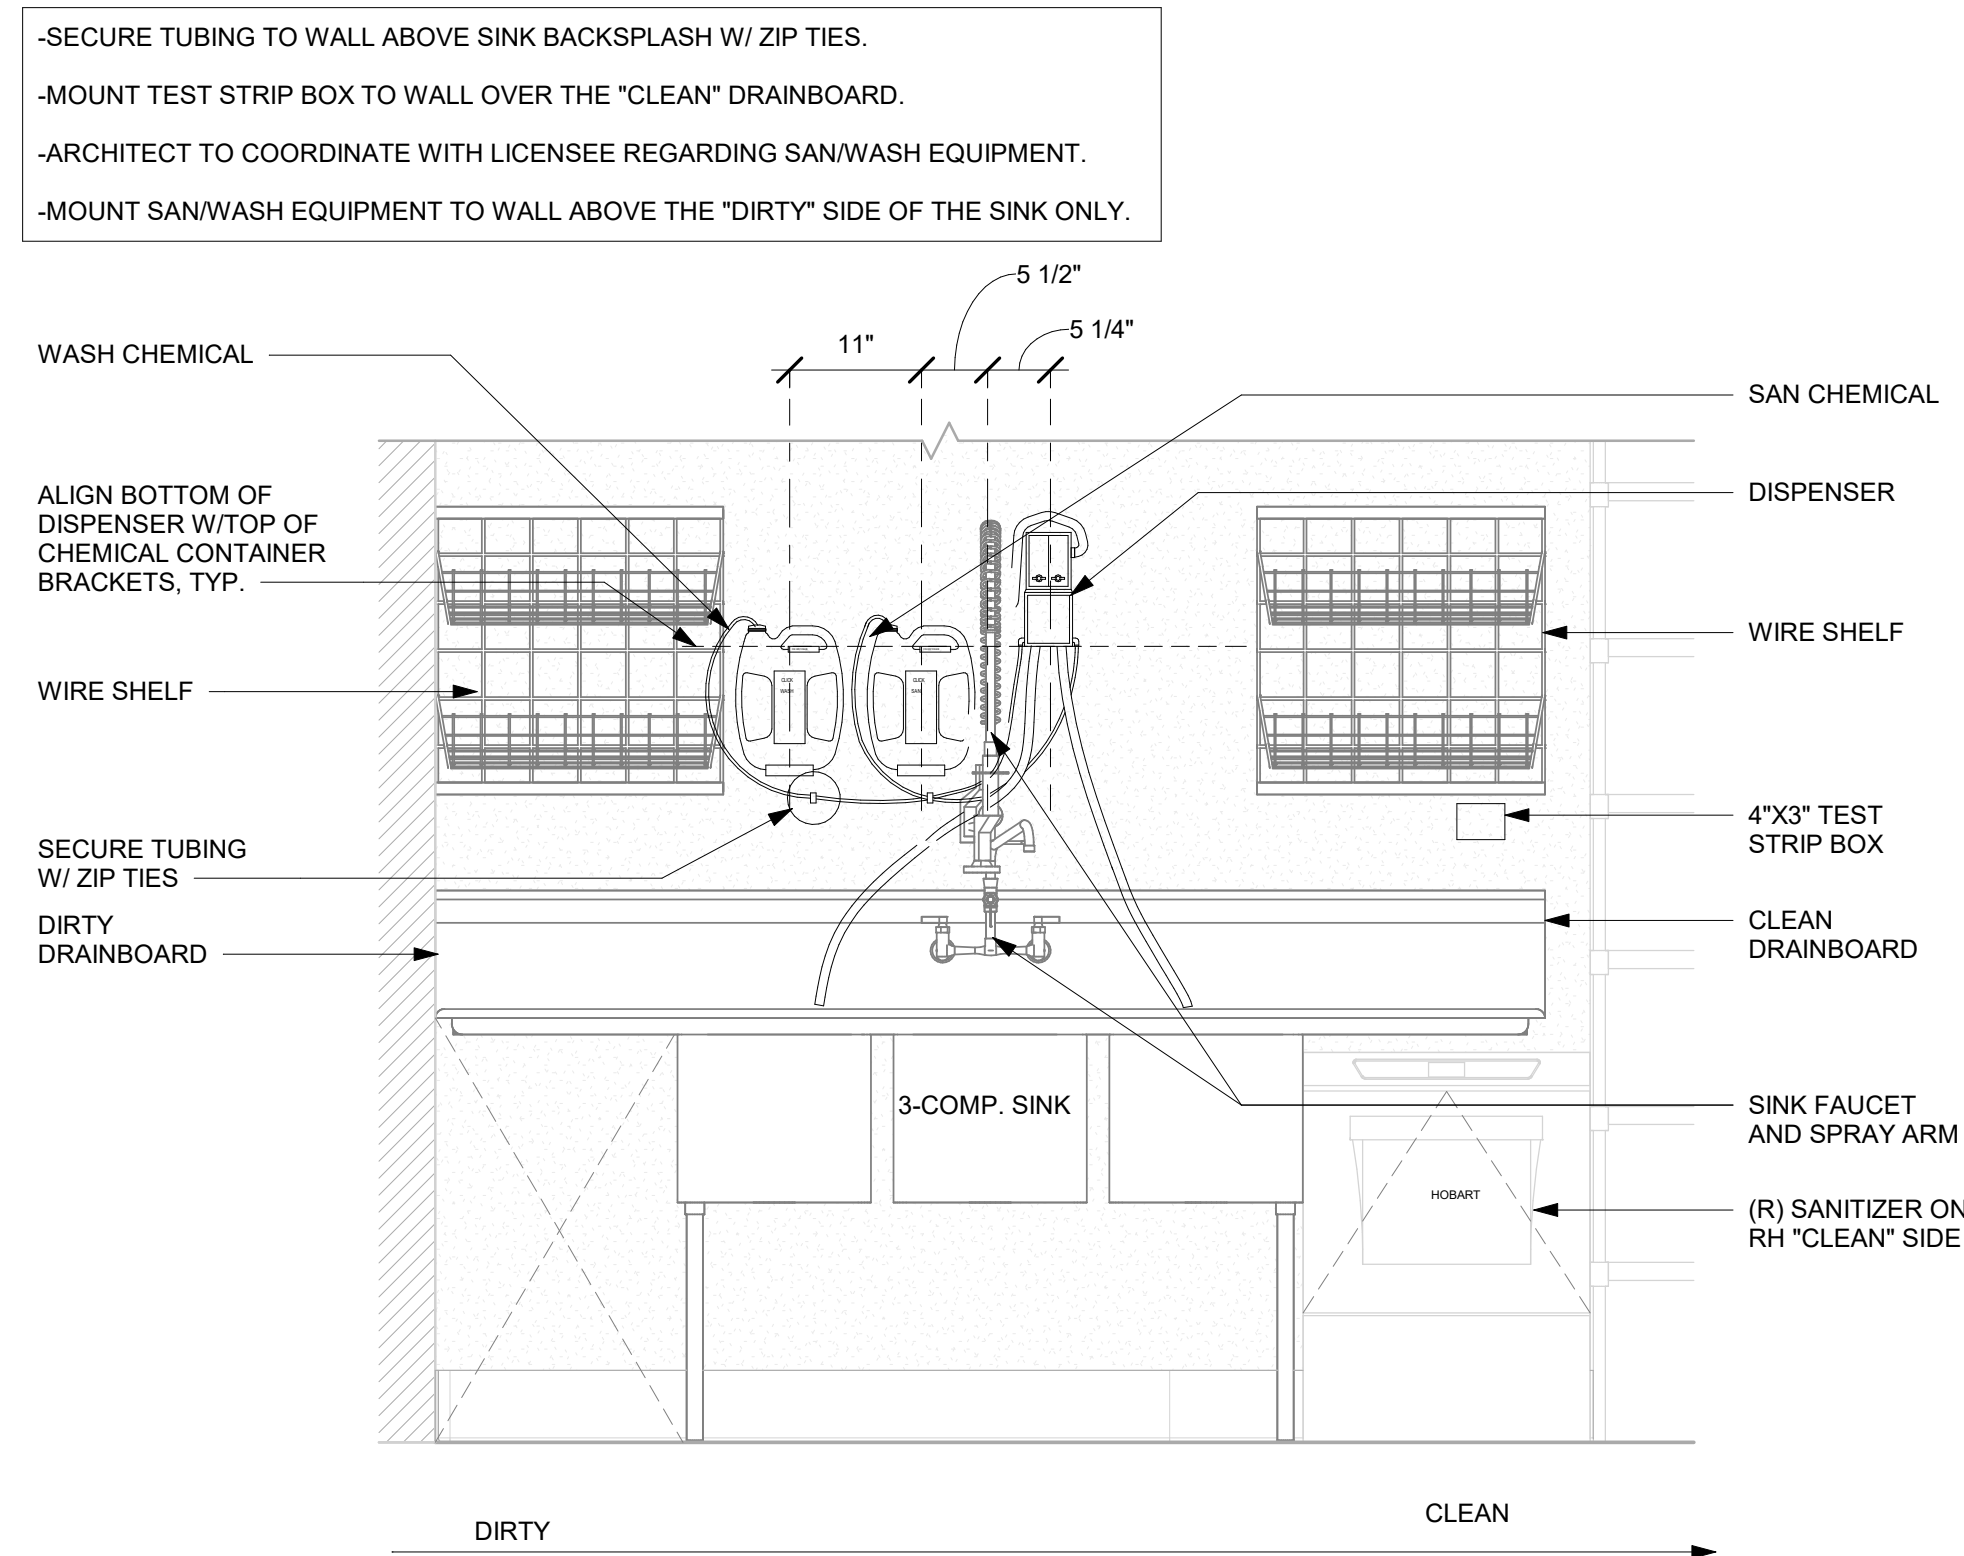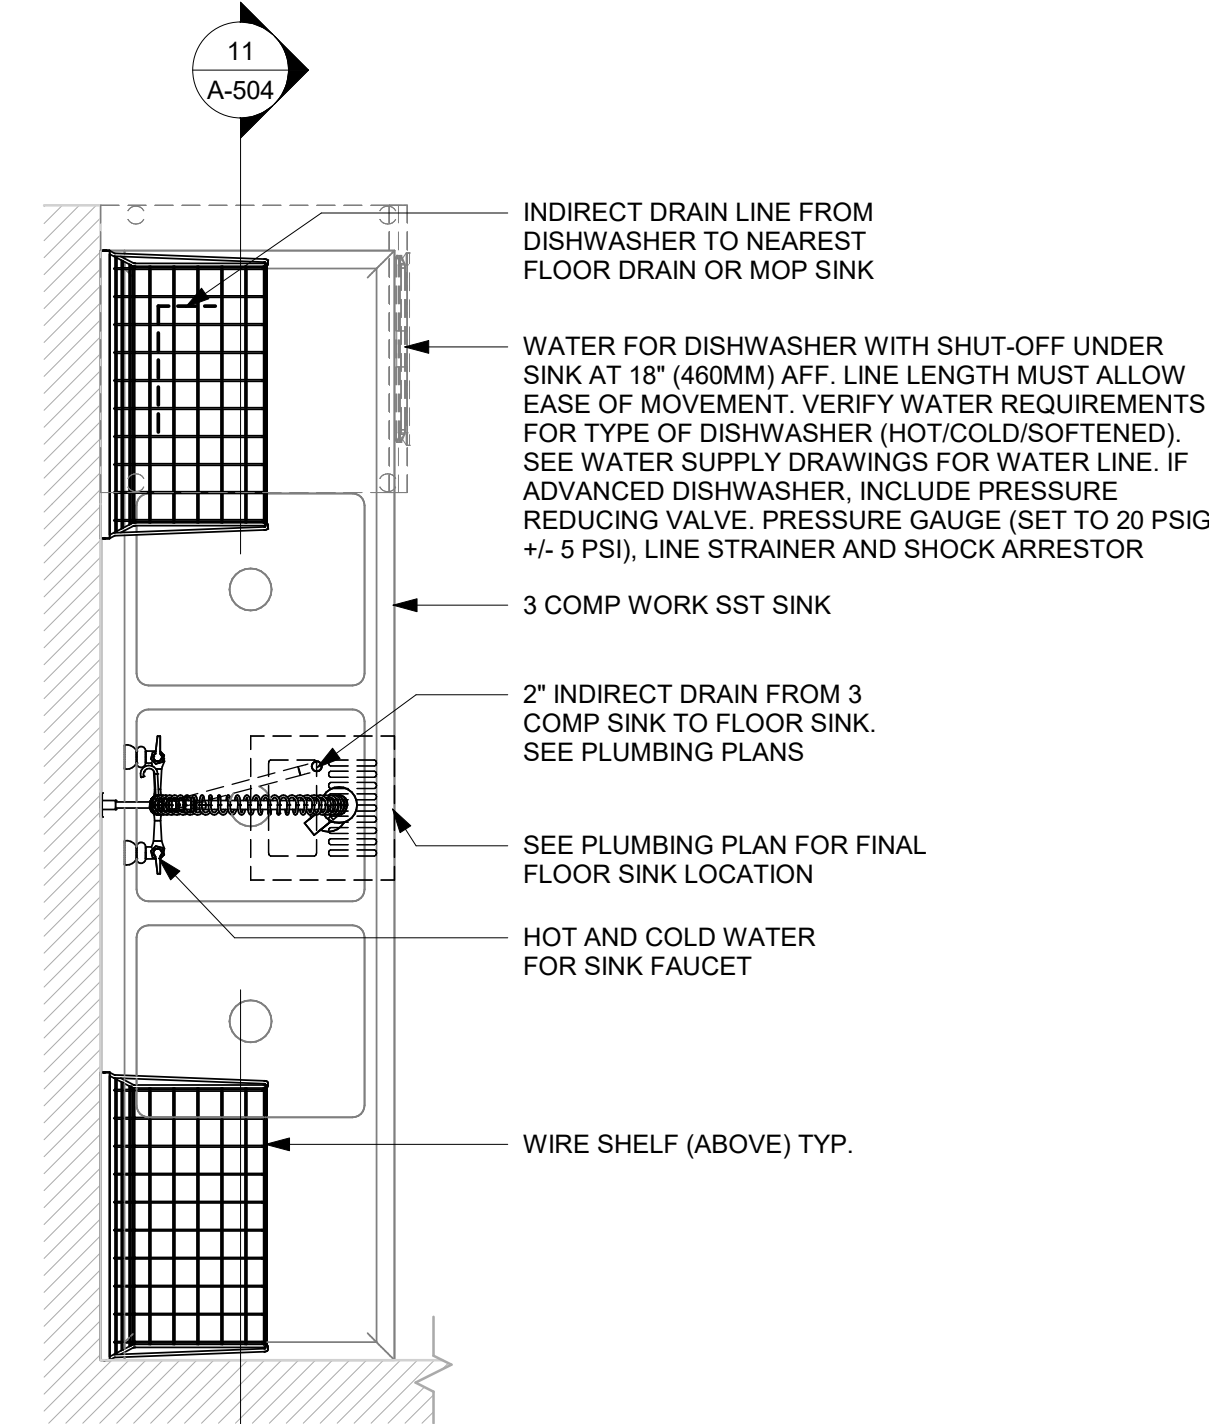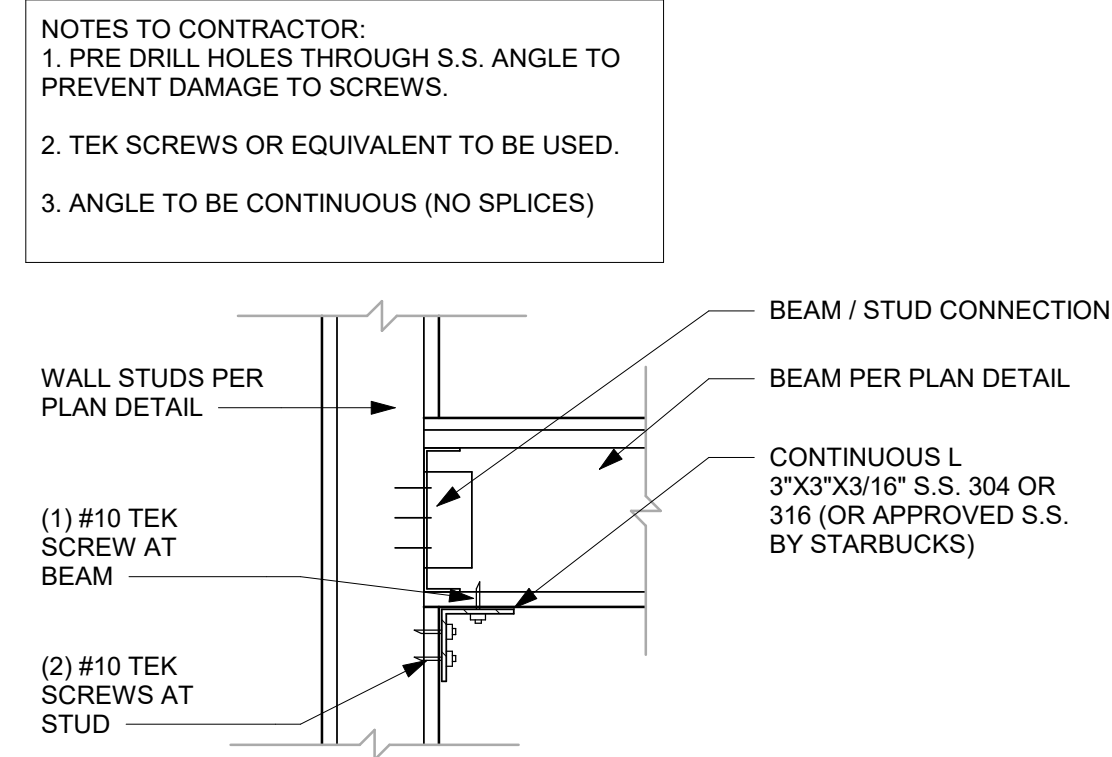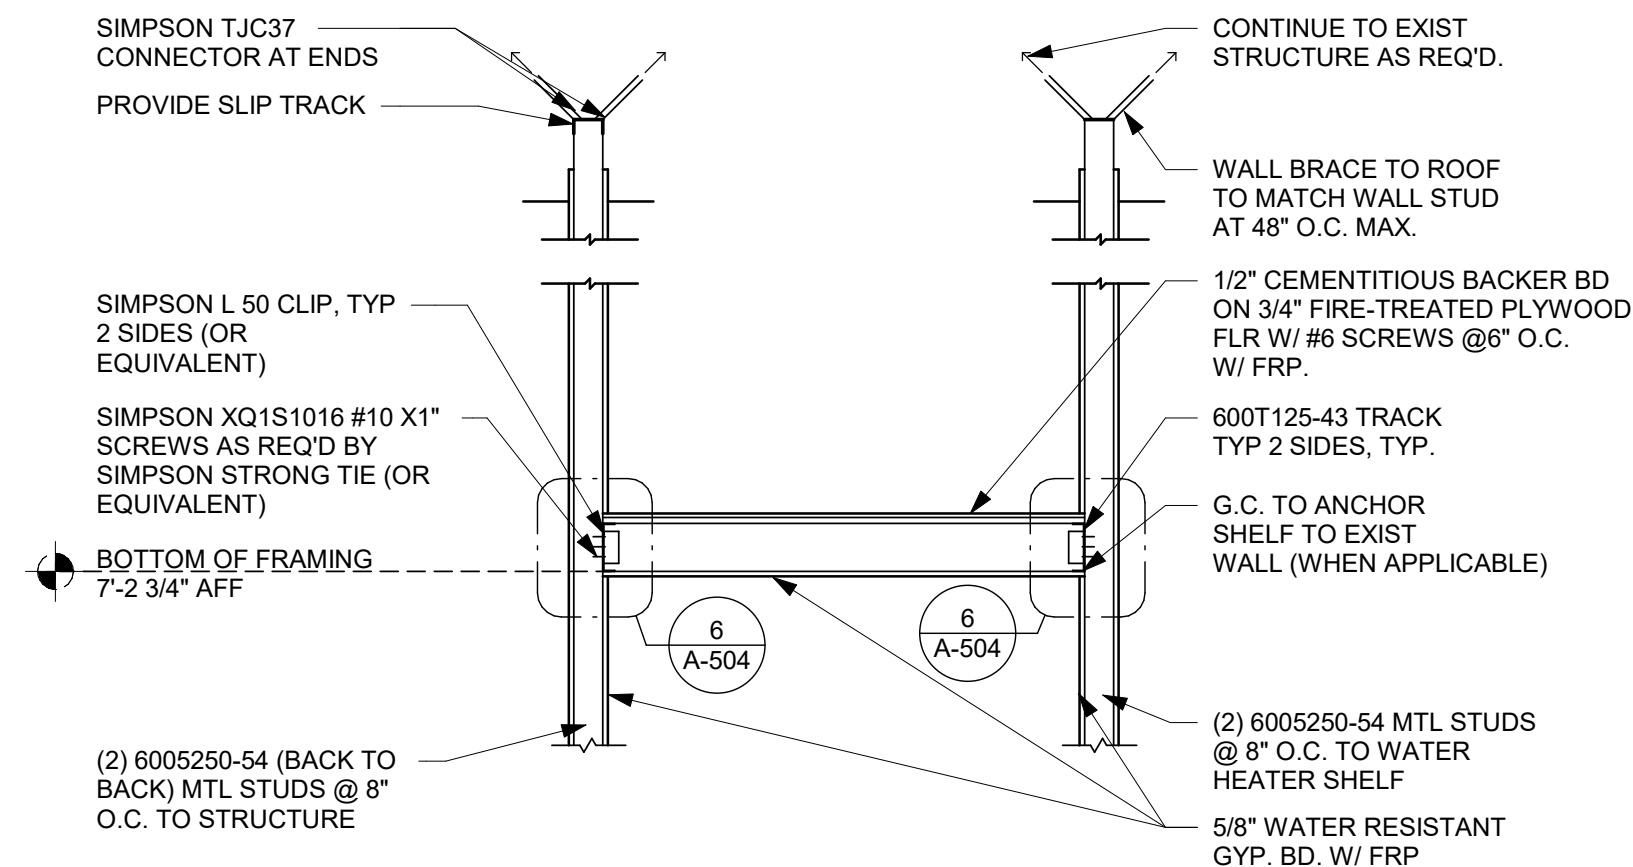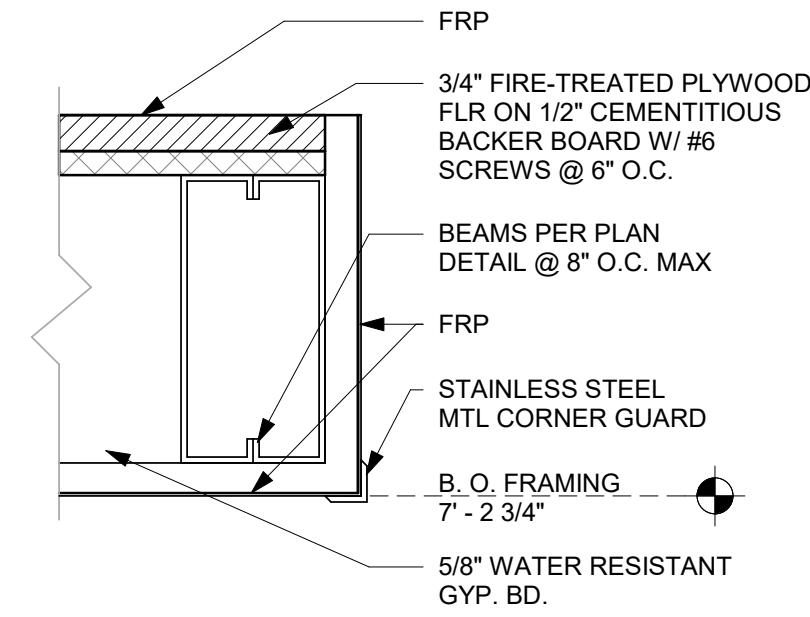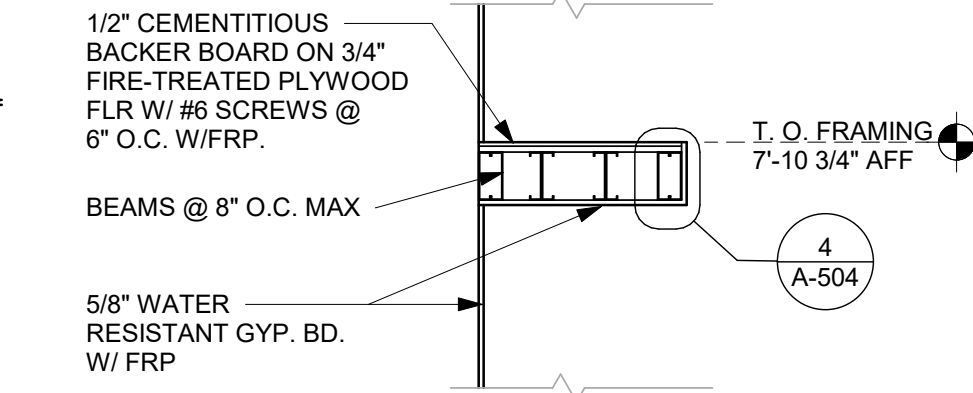

STARBUCKS®
2401 UTAH AVENUE SOUTH
SEATTLE, WASHINGTON 98134
(206) 318-1575

THESE DRAWINGS AND THE PROJECT MANUAL ARE CONFIDENTIAL AND SHALL REMAIN THE SOLE PROPERTY OF STARBUCKS CORPORATION, WHICH IS THE OWNER OF THE COPYRIGHT IN THIS WORK. THEY SHALL NOT BE REPRODUCED (IN WHOLE OR IN PART), SHARED WITH THIRD PARTIES OR USED IN ANY MANNER ON OTHER PROJECTS OR EXTENSIONS TO THIS PROJECT WITHOUT THE PRIOR WRITTEN CONSENT OF STARBUCKS CORPORATION. THE DRAWINGS, DRAWINGS AND SPECIFICATIONS ARE INTENDED TO EXPRESS DESIGN INTENT FOR A PROTOTYPICAL STARBUCKS STORE (WHICH IS SUBJECT TO CHANGE AT ANYTIME) AND DO NOT REFLECT ACTUAL SITE CONDITIONS. NEITHER PARTY SHALL HAVE ANY OBLIGATION NOR LIABILITY TO THE OTHER (EXCEPT STATED ABOVE) UNTIL A WRITTEN AGREEMENT IS FULLY EXECUTED BY BOTH PARTIES.

STARBUCKS TEMPLATE VERSION: i2023.10.23

**Design Forum
Architects Inc.**

2050 Byers Rd
 Miamisburg, OH 45342
 Tel: (844) 804-7700

Donald J. Rethman
Architect In Charge
License: AR0017303



FOR CONSTRUCTION

PROJECT NAME:
**S SEMORAN BLVD &
LEE VISTA BLVD**

PROJECT ADDRESS:
6605 S SEMORAN BLVD
ORLANDO, FL 32822

STORE #: 9875
PROJECT #: 25630-101
ISSUE DATE: 03/04/2024
DESIGN MANAGER: MARTIN PEREZ
PRODUCTION DESIGNER: ANDY MCLOUD
CHECKED BY: DONALD RETHMAN

Revision Schedule			
Rev	Date	By	Description


SHEET TITLE:
WORKROOM DETAILS

SCALE: AS SHOWN

SHEET NUMBER:


A-504

\\file-day.ad.changeupinc.com\Client\StarbucksArchitecture\Projects_2023\Florida\Semoran & Lee Vista -25630-10\125630-101_9875_S Semoran Blvd & Lee Vista Blvd, FL_2023.rvt 3/4/2024 2:39:28 PM

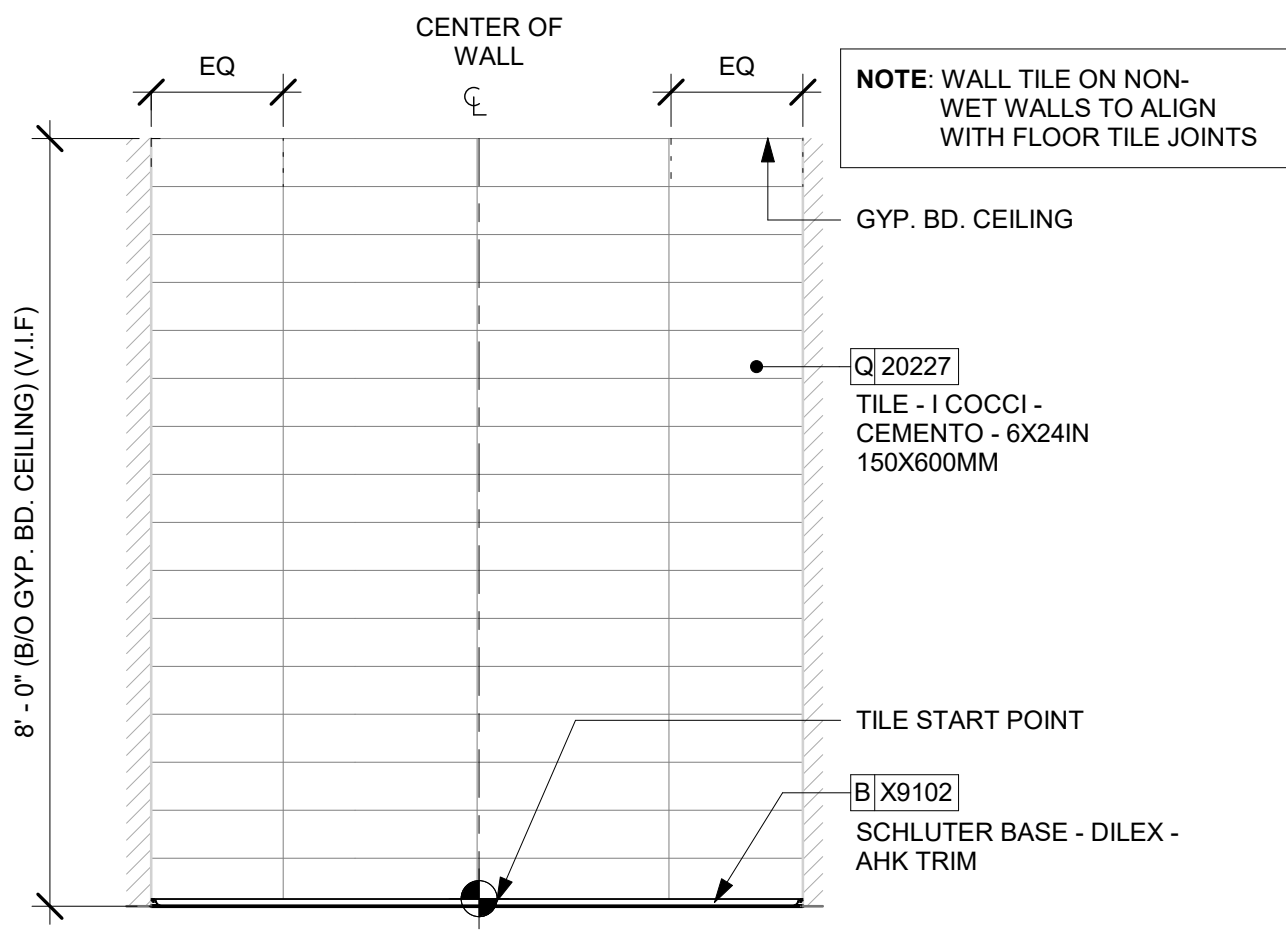


1 WALL TILE PATTERN AT RESTROOM

Scale: 1/2" = 1'-0"

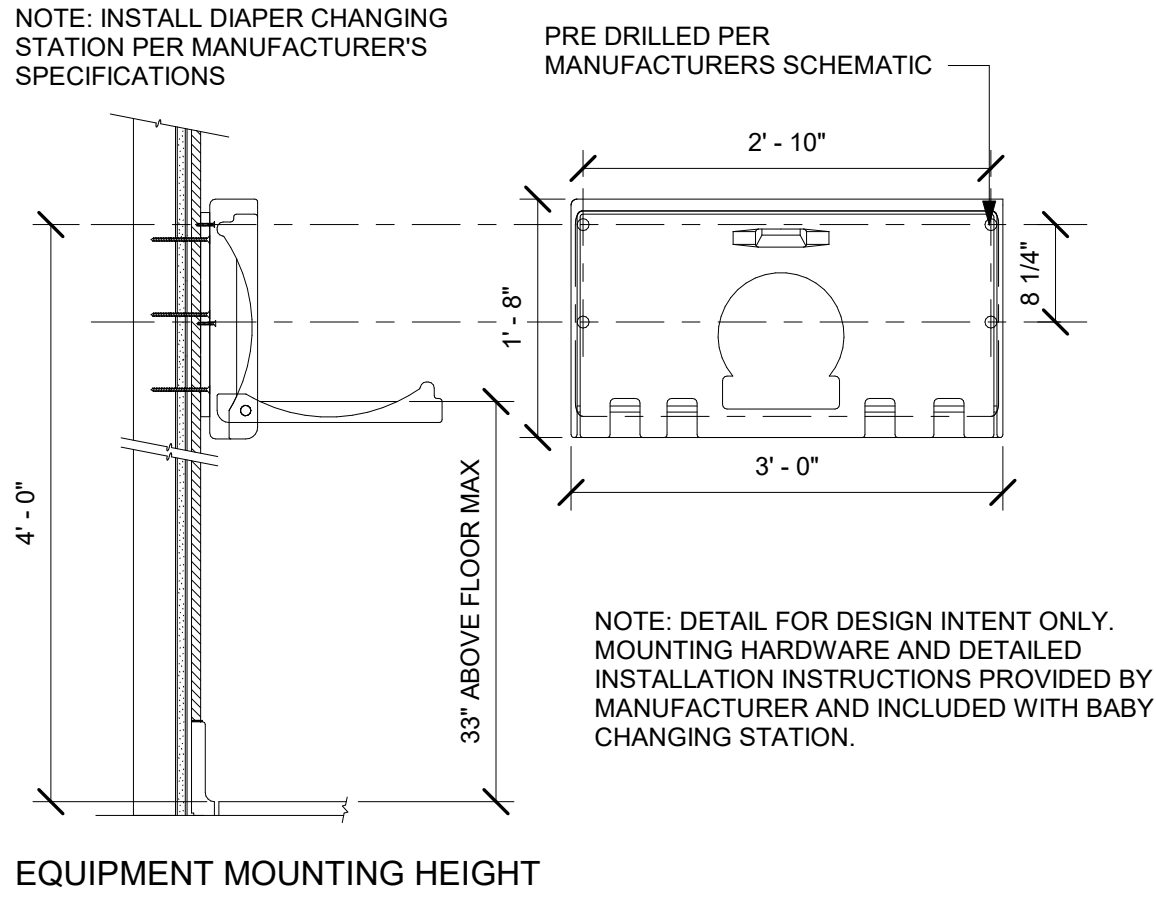


2 WALL MOUNTED BABY CHANGING EQUIPMENT DETAILS

Scale: 3/4" = 1'-0"

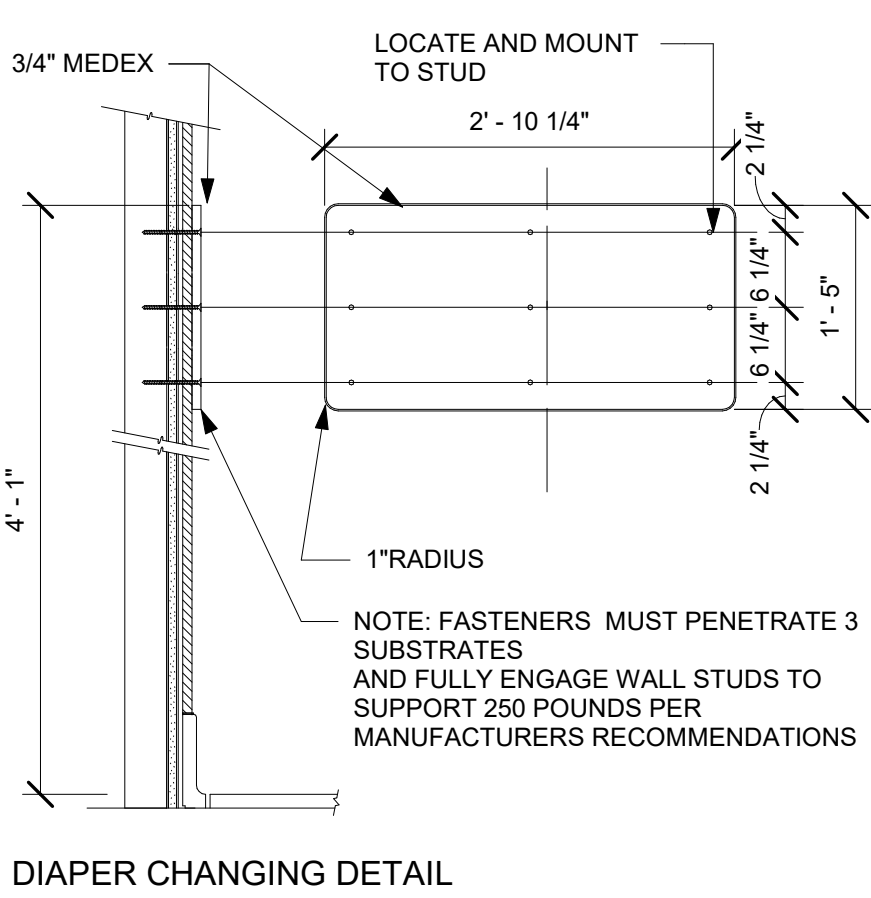


3 HAND DRYER SECTION

Scale: 3" = 1'-0"

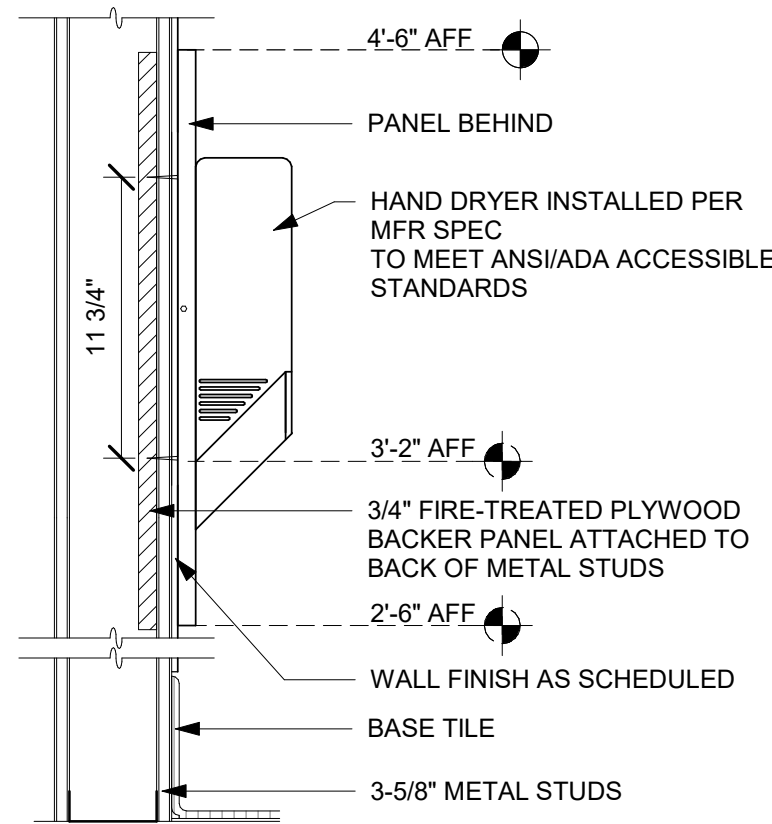


4 HAND DRYER BLOCKING

Scale: 1 1/2" = 1'-0"

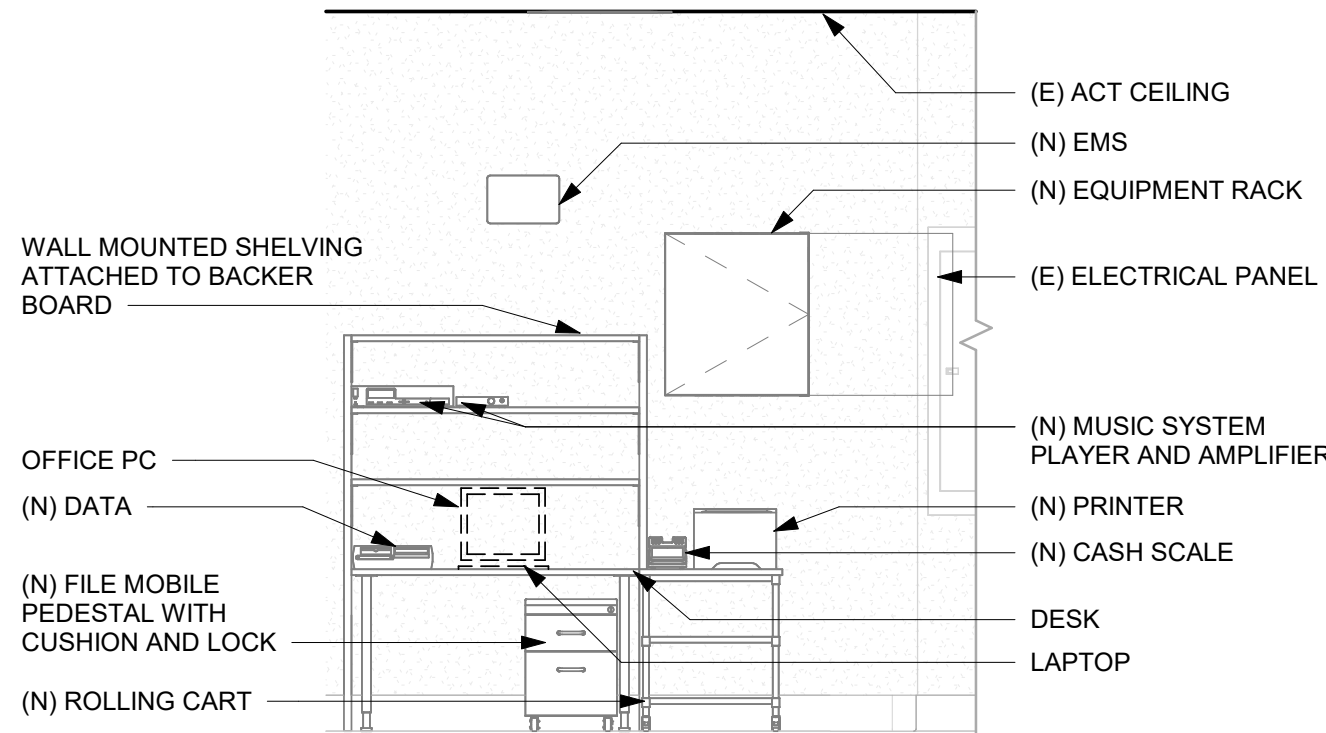


5 MANAGER DESK (DETAIL FOR INSTALLATION)

Scale: 3/8" = 1'-0"

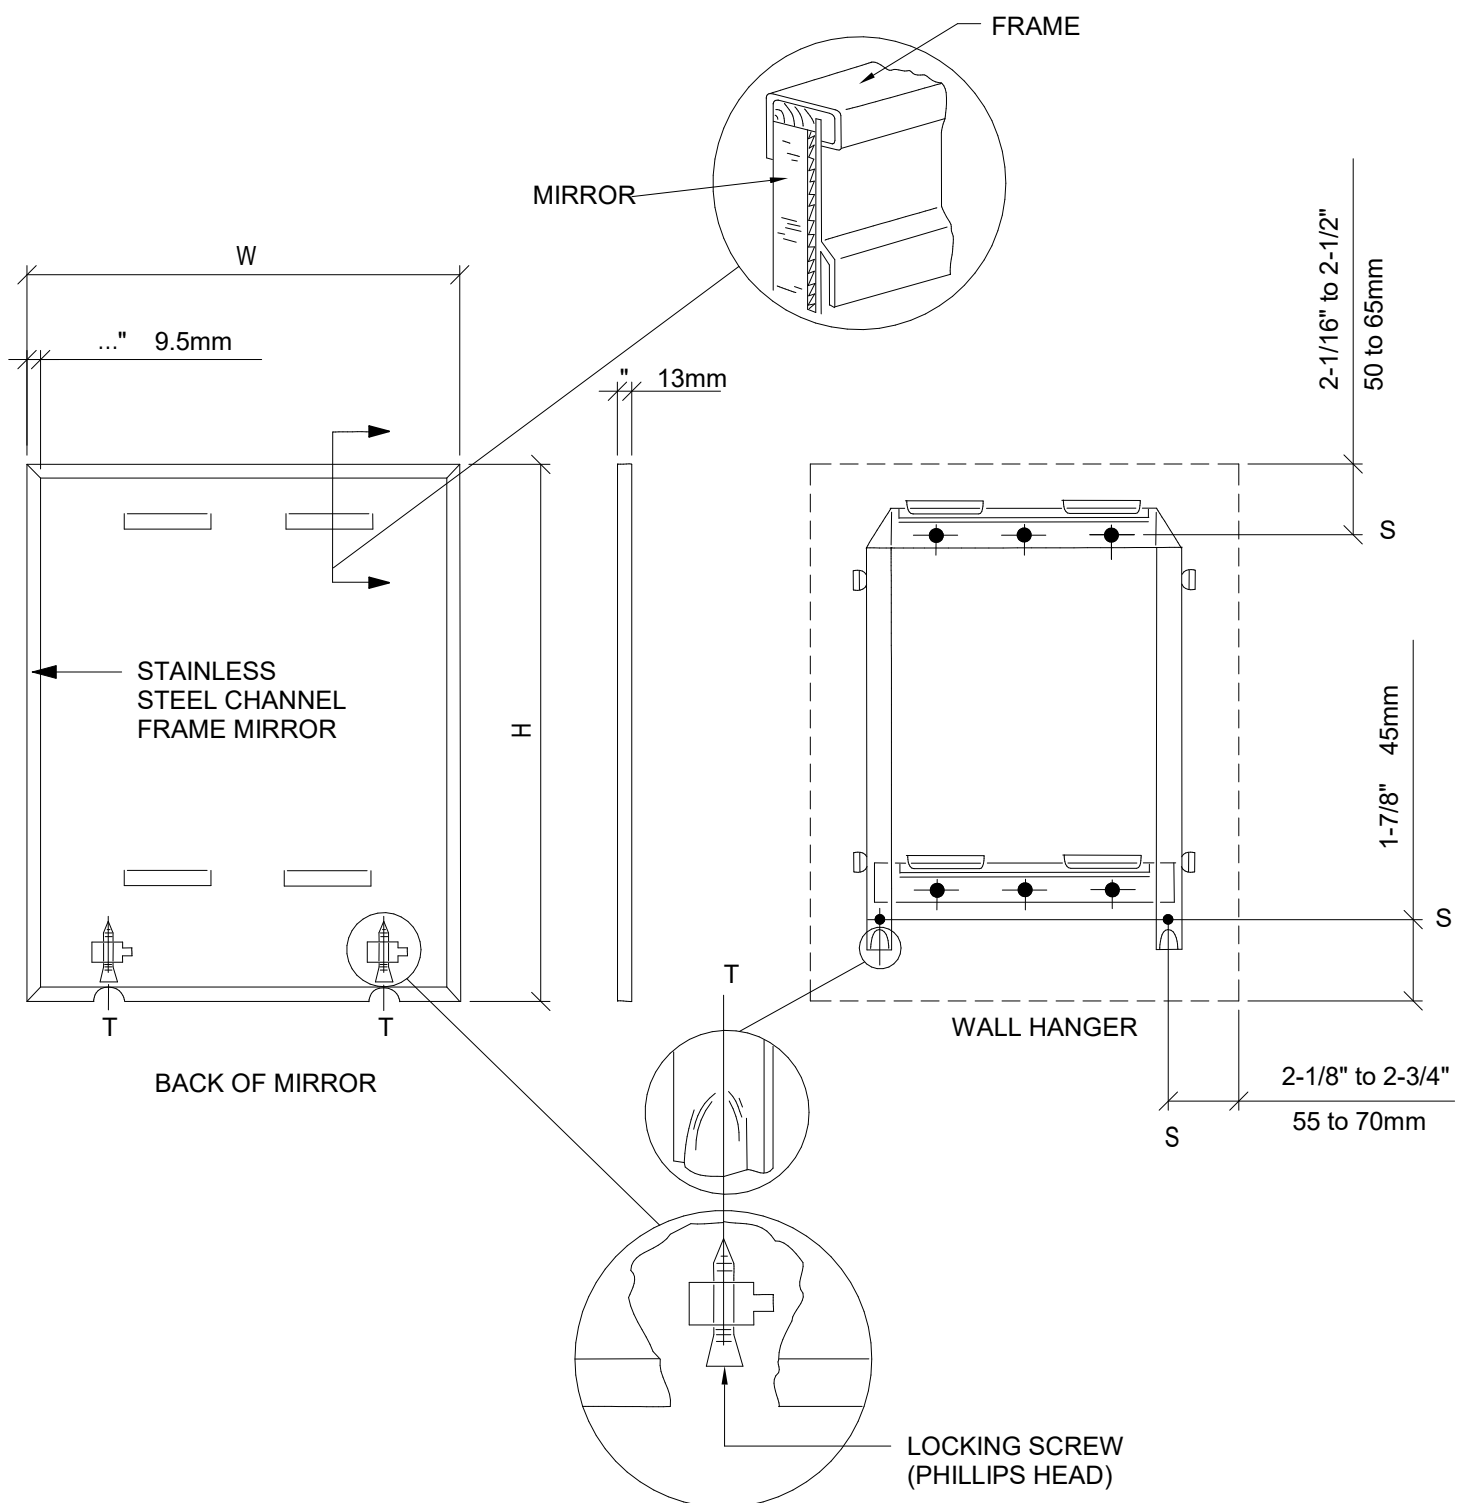

6 MIRROR MOUNTING

Scale: 3/4" = 1'-0"

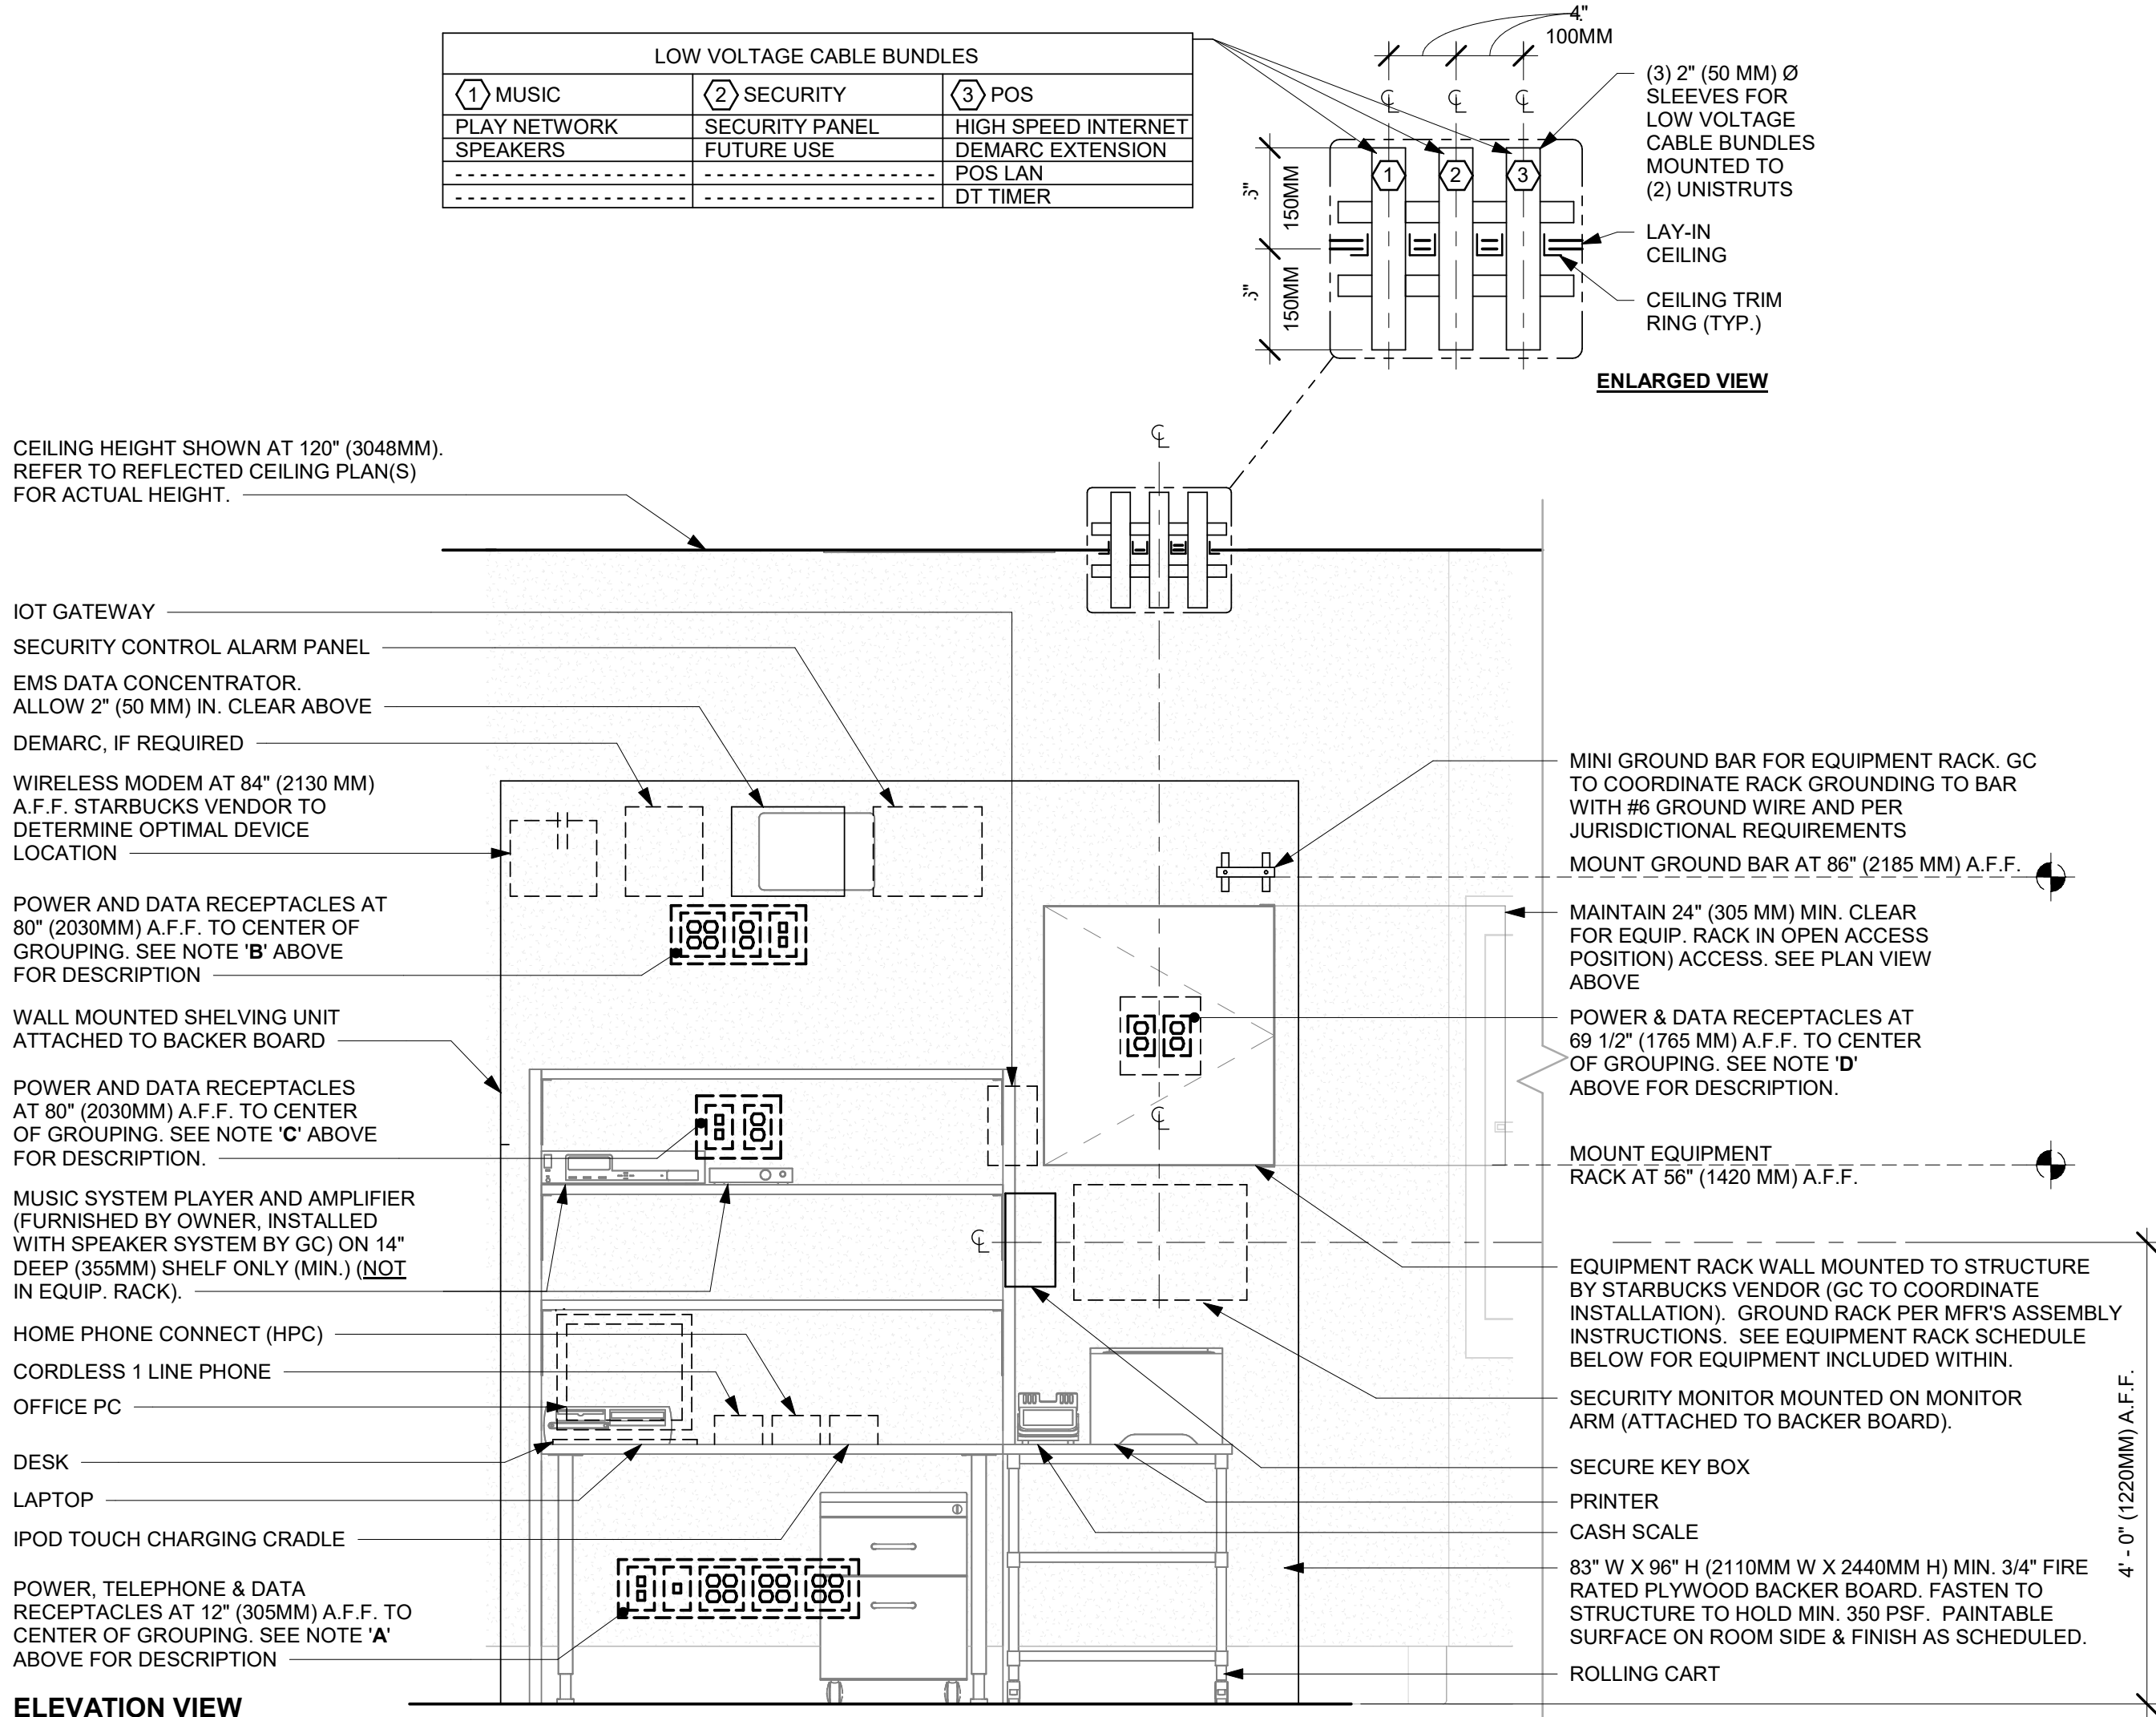

7 MANAGER WORKROOM - ELECTRICAL

Scale: 3/4" = 1'-0"



STARBUCKS®
2401 UTAH AVENUE SOUTH
SEATTLE, WASHINGTON 98134
(206) 318-1575

THESE DRAWINGS AND THE PROJECT MANUAL ARE CONFIDENTIAL AND SHALL REMAIN THE SOLE PROPERTY OF STARBUCKS CORPORATION, WHICH IS THE OWNER OF THE COPYRIGHT IN THIS WORK. THEY SHALL NOT BE REPRODUCED IN WHOLE OR IN PART, SHARED WITH THIRD PARTIES OR USED IN ANY MANNER ON OTHER PROJECTS OR EXTENSIONS TO THIS PROJECT WITHOUT THE PRIOR WRITTEN CONSENT OF STARBUCKS CORPORATION. THESE DRAWINGS AND SPECIFICATIONS ARE INTENDED TO EXPRESS DESIGN INTENT FOR A PROTOTYPICAL STARBUCKS STORE (WHICH IS SUBJECT TO CHANGE AT ANYTIME) AND DO NOT REFLECT ACTUAL SITE CONDITIONS. NEITHER PARTY SHALL HAVE ANY OBLIGATION NOR LIABILITY TO THE OTHER (EXCEPT STATED ABOVE) UNTIL A WRITTEN AGREEMENT IS FULLY EXECUTED BY BOTH PARTIES.

STARBUCKS TEMPLATE VERSION: i2023.10.23

Design Forum Architects Inc.

2050 Byers Rd
Miami, OH 45342
Tel: (844) 804-7700

Donald J. Reihman
Architect In Charge
License: AR0017303



2230 PARK AVE, STE. 100, CINCINNATI, OH 45206
513.457.7131 - WWW.MARQUEENG.COM

FOR CONSTRUCTION

PROJECT NAME:
S SEMORAN BLVD & LEE VISTA BLVD

PROJECT ADDRESS:
**6605 S SEMORAN BLVD
ORLANDO, FL 32822**


STORE #: 9875
PROJECT #: 25630-101
ISSUE DATE: 03/04/2024
DESIGN MANAGER: MARTIN PEREZ
PRODUCTION DESIGNER: ANDY MCLOUD
CHECKED BY: DONALD REHMAN

Revision Schedule			
Rev	Date	By	Description


SHEET TITLE:
RESTROOM AND WORKROOM DETAILS
SCALE: AS SHOWN

SHEET NUMBER:
A-505


\\file-day.ad.changeupinc.com\Client\StarbucksArchitecture\Projects_2023\Florida\Semoran & Lee Vista -256630-10\256630-101_9875_S Semoran Blvd & Lee Vista Blvd, FL_2023.rvt 3/4/2024 2:39:29 PM

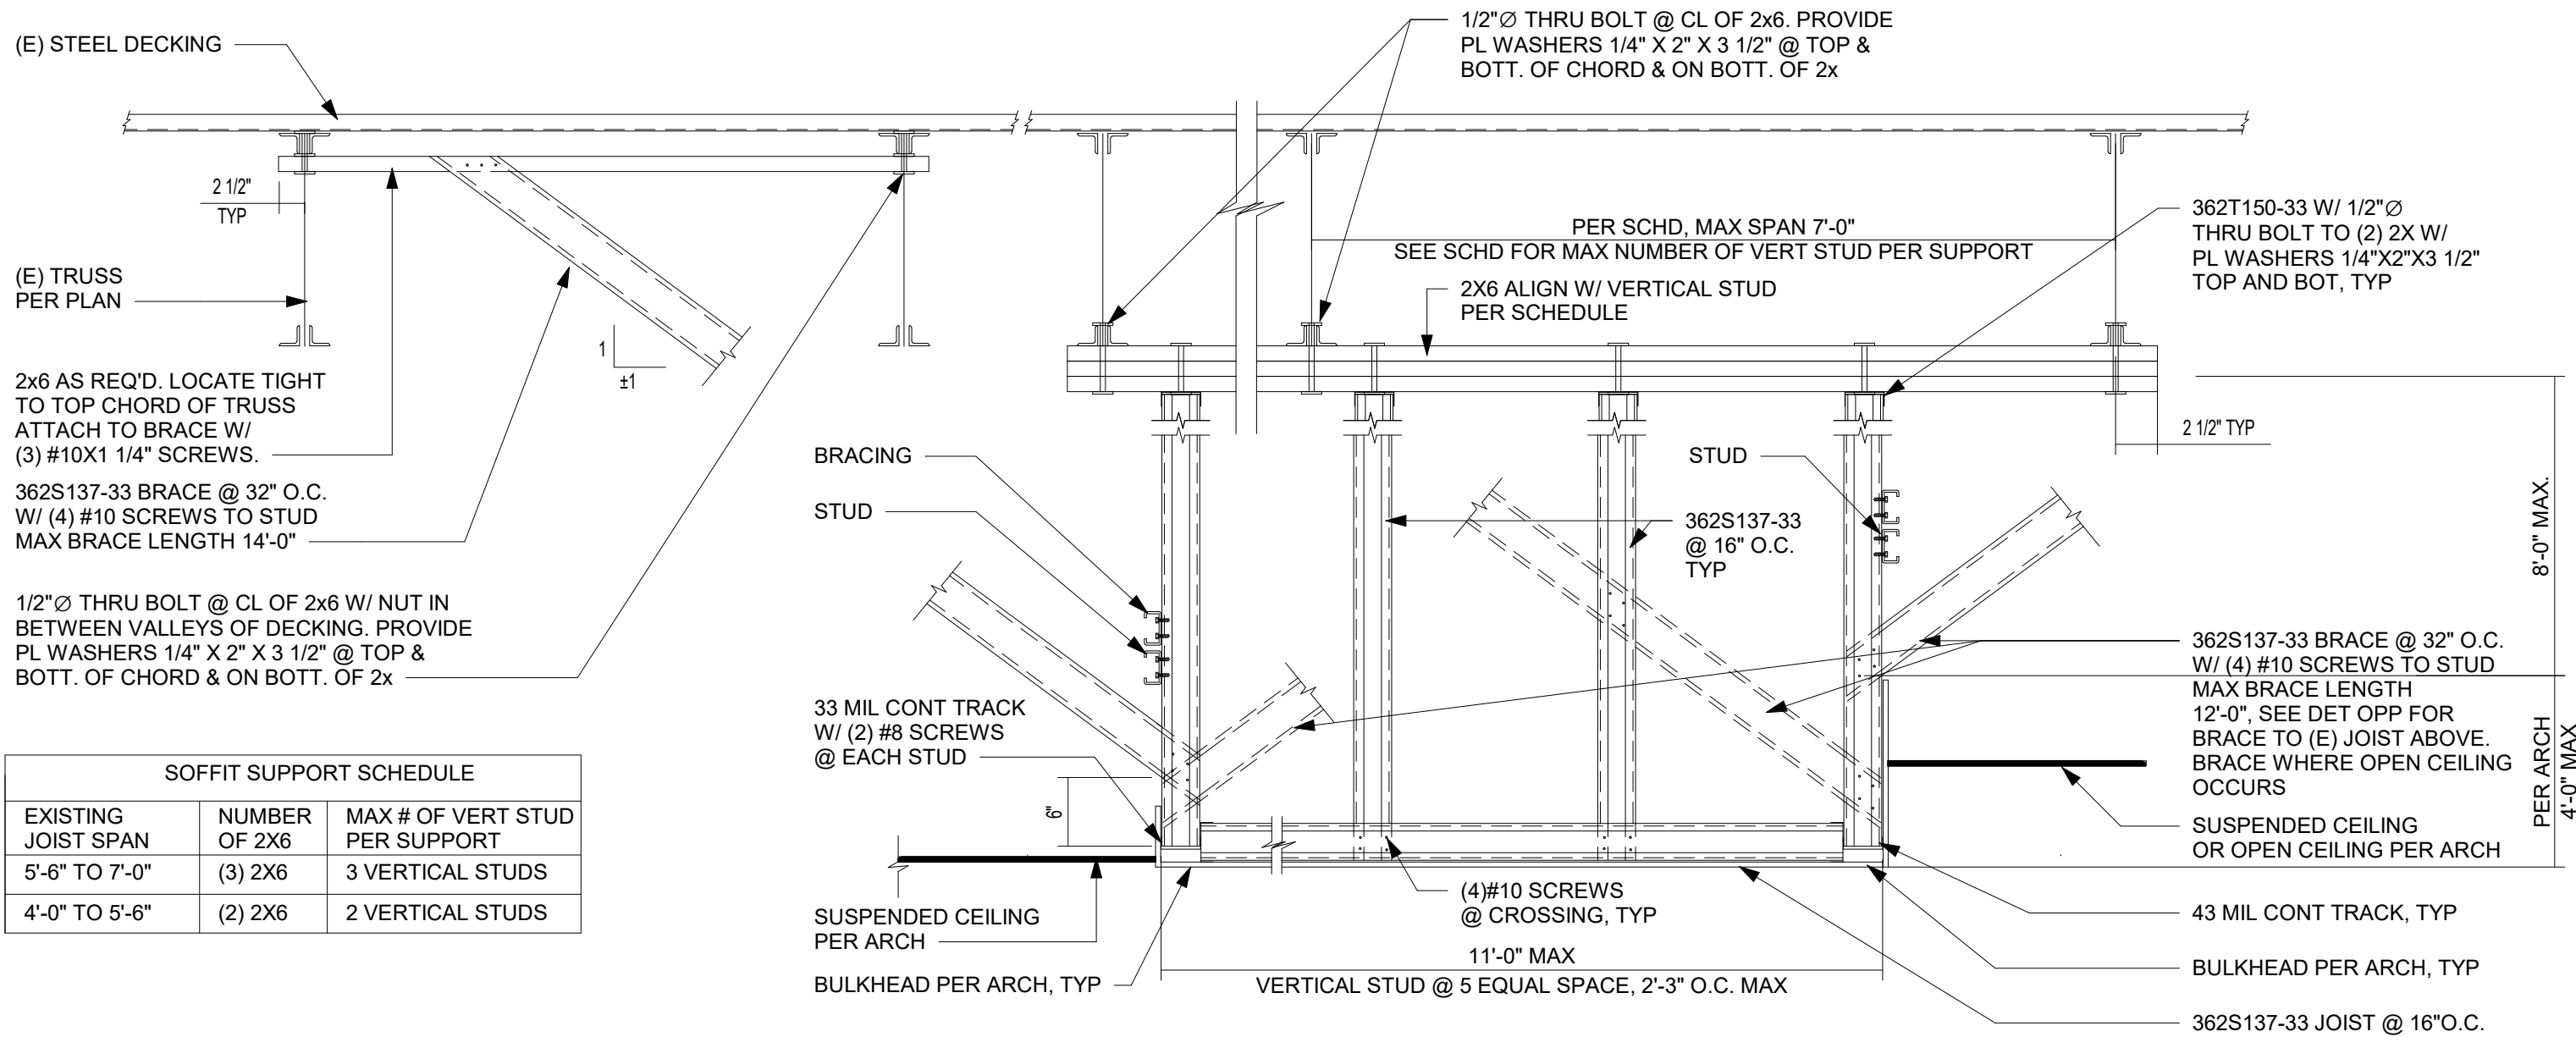


1 TYPICAL SOFFIT PARALLEL TO (E) TRUSS-A
Scale: 3/4" = 1'-0"

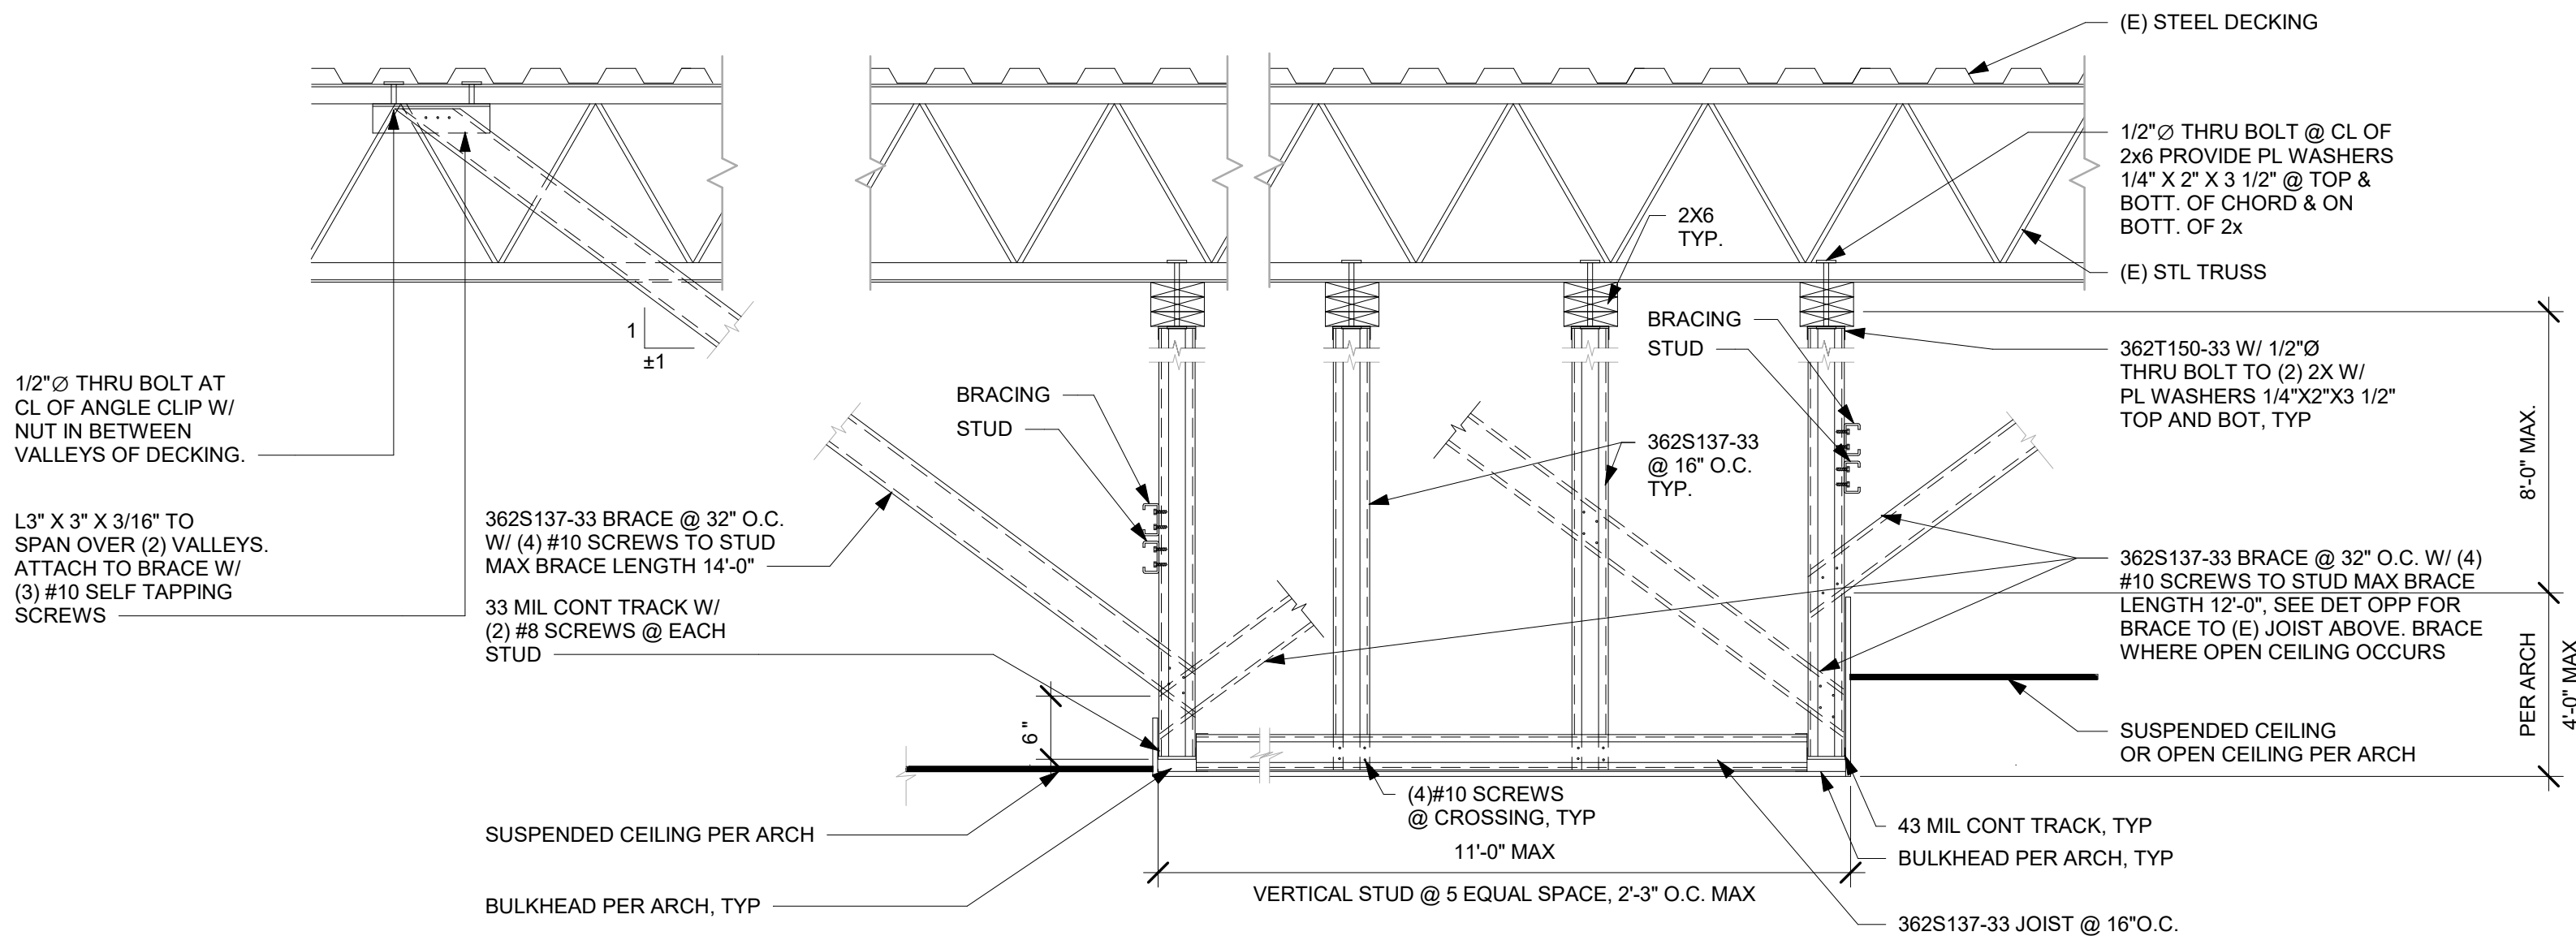

3 TYP SOFFIT PERPENDICULAR TO (E) TRUSS
Scale: 3/4" = 1'-0"

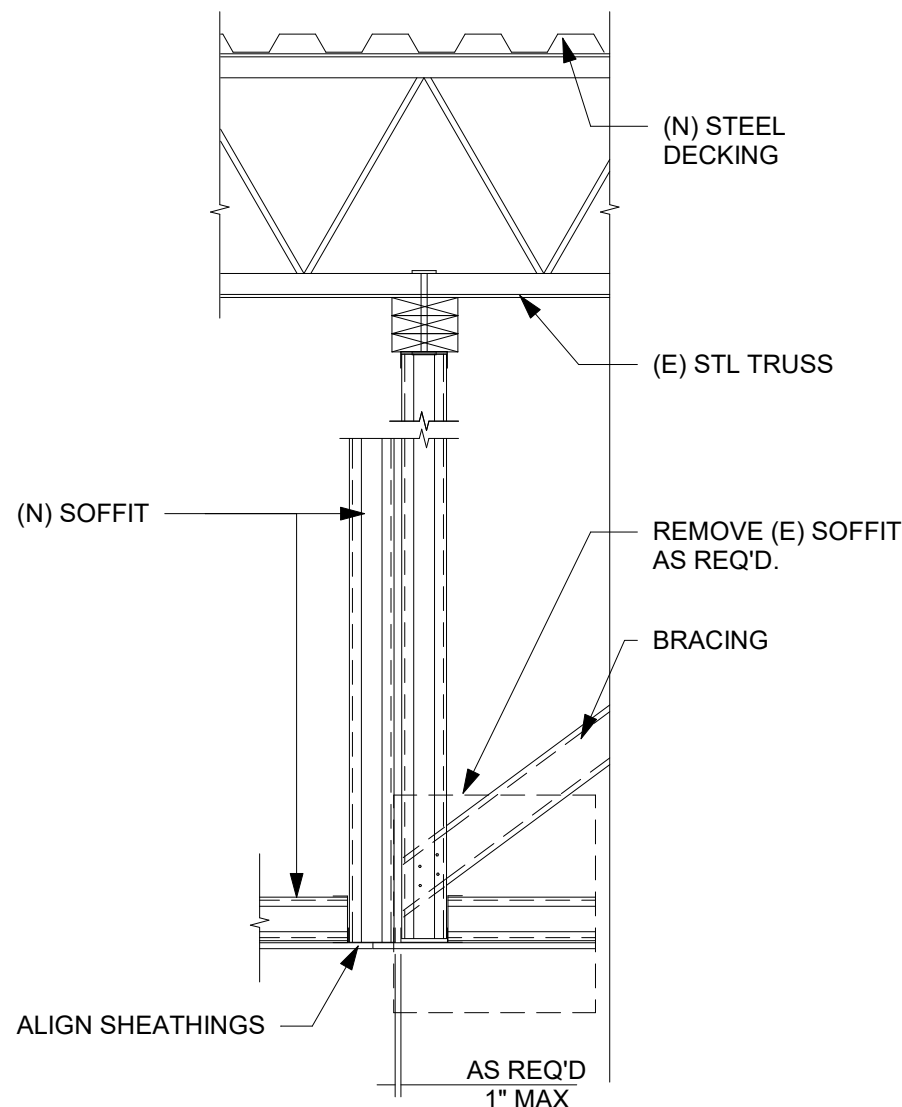

2 NEW SOFFIT TO (E) TRUSS
Scale: 3/4" = 1'-0"

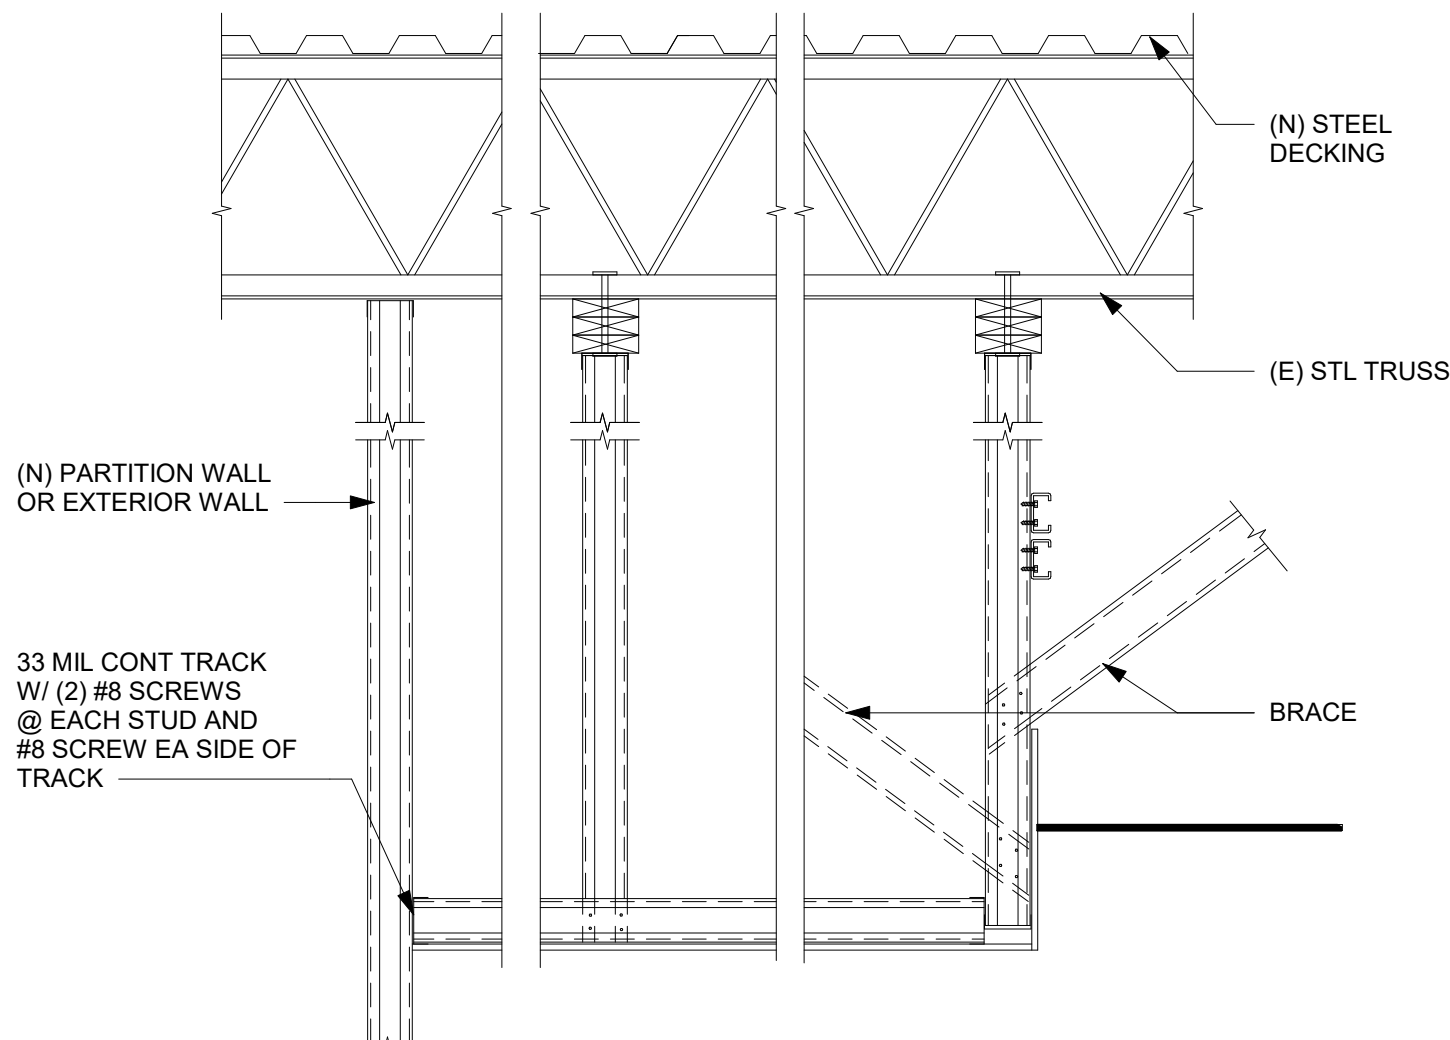

4 TYPICAL SOFFIT TO (N) WALL
Scale: 3/4" = 1'-0"



STARBUCKS®
2401 UTAH AVENUE SOUTH
SEATTLE, WASHINGTON 98134
(206) 318-1575

THESE DRAWINGS AND THE PROJECT MANUAL ARE CONFIDENTIAL AND SHALL REMAIN THE SOLE PROPERTY OF STARBUCKS CORPORATION, WHICH IS THE OWNER OF THE COPYRIGHT IN THIS WORK. THEY SHALL NOT BE REPRODUCED IN WHOLE OR IN PART, SHARED WITH THIRD PARTIES OR USED IN ANY MANNER ON OTHER PROJECTS OR EXTENSIONS TO THIS PROJECT WITHOUT THE PRIOR WRITTEN CONSENT OF STARBUCKS CORPORATION. THESE DRAWINGS AND SPECIFICATIONS ARE INTENDED TO EXPRESS DESIGN INTENT FOR A PROTOTYPICAL STARBUCKS STORE (WHICH IS SUBJECT TO CHANGE AT ANYTIME) AND DO NOT REFLECT ACTUAL SITE CONDITIONS. NEITHER PARTY SHALL HAVE ANY OBLIGATION NOR LIABILITY TO THE OTHER (EXCEPT STATED ABOVE) UNTIL A WRITTEN AGREEMENT IS FULLY EXECUTED BY BOTH PARTIES.

STARBUCKS TEMPLATE VERSION: i2023.10.23

Design Forum Architects Inc.

2050 Byers Rd
Miami, OH 45342
Tel: (614) 804-7700

Donald J. Reithman
Architect In Charge
License: AR0017303



2230 PARK AVE, STE. 100, CINCINNATI, OH 45206
513.457.7131 - WWW.MARQUEENG.COM

FOR CONSTRUCTION

PROJECT NAME:
S SEMORAN BLVD & LEE VISTA BLVD

PROJECT ADDRESS:
**6605 S SEMORAN BLVD
ORLANDO, FL 32822**

STORE #: 9875
PROJECT #: 25630-101
ISSUE DATE: 03/04/2024
DESIGN MANAGER: MARTIN PEREZ
PRODUCTION DESIGNER: ANDY MCLOUD
CHECKED BY: DONALD RETHMAN

Revision Schedule			
Rev	Date	By	Description


SHEET TITLE:
CONNECTION DETAIL

SCALE: 3/4" = 1'-0"

SHEET NUMBER:
A-506

\\file-day.ad.changeupinc.com\Client\StarbucksArchitecture\Projects_2023\Florida\Semoran & Lee Vista -25630-10\125630-101_9875_S Semoran Blvd & Lee Vista Blvd, FL_2023.rvt 3/4/2024 2:39:30 PM

INTERIOR DOOR LEGEND

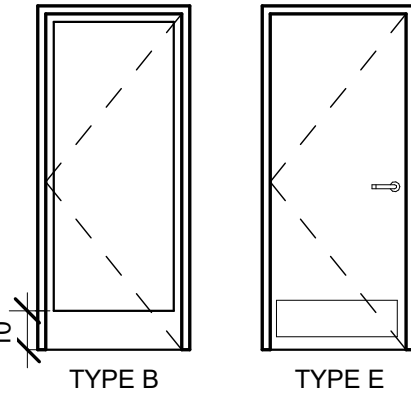


STOREFRONT DOOR (TYPE B)

DOOR HARDWARE SET NO. 2-A - For new single aluminum secondary entry/exit door (50 or more occupancy)				
No.	Item	Description	Manufacturer	Finish
1	Hanging Devices	CFM 83 HD (83 = specified door height)	Pemko	630
1	Securing Devices	CD35A-NL-OP Panic Device	Von Duprin	628/630
2	Securing Devices	C607 7-Pin Core Combined "A" Keyway	Falcon Lock	626
1	Securing Devices	KB609-2 Cut Control Key "A" Keyway	Falcon Lock	---
9	Securing Devices	KB632-2 Cut User Key "A" Keyway	Falcon Lock	----
1	Securing Devices	C953 7-Pin Rim Cylinder Housing	Falcon Lock	626
1	Securing Devices	C987 7-Pin Mortise Cylinder Housing w/AR Cam	Falcon Lock	626
1	Securing Devices	A08794-003 Adjustable Ring, Mortise Cyl. 516-13/32	Falcon Lock	626
1	Operating Trim	Offset Pull BF157	Rockwood	630
1	Closing Devices	8916 Door Closer 8916 AF89P	Dorma	689
1	Stops and Holders	473 Door Stop w/ Hook	Rockwood	626
1	Accessories	137NA Weather Strip 20" 72" x 84"	National Guard	A
1	Accessories	Door Sweep 18062CNB36	Pemko	A
1	Threshold	325 Half Saddle Threshold	National Guard	---
1	Sign	Vinyl Sign: "THIS DOOR MUST REMAIN UNLOCKED WHEN BUILDING IS OCCUPIED"	Seton	---

RESTROOM DOOR (TYPE E)

DOOR HARDWARE SET NO. 6 - For restroom door with lever and privacy lock				
No.	Item	Description	Manufacturer	Finish
3	Hanging Items	TA2714/MPB79 Hinge MacPro Bearing 4.5 x 4.5	McKinney	626
1	Securing Devices	PB5425LN Lock, Shallow Coin Turn, Privacy PB5425LN-693-497 1-3/4	Yale Lock	626
1	Closing Devices	8916 Door Closer 8916 AF89P	Dorma	689
2	Protective Trim Units	K1050 B4E Kickplate 8" x 34" Each Side 32D	Rockwood	630
3	Accessories	GJ64 Rubber Silencer	Glynn Johnson	Gray
1	Stops and Holders	473 Door Stop w/ Hook	Rockwood	626

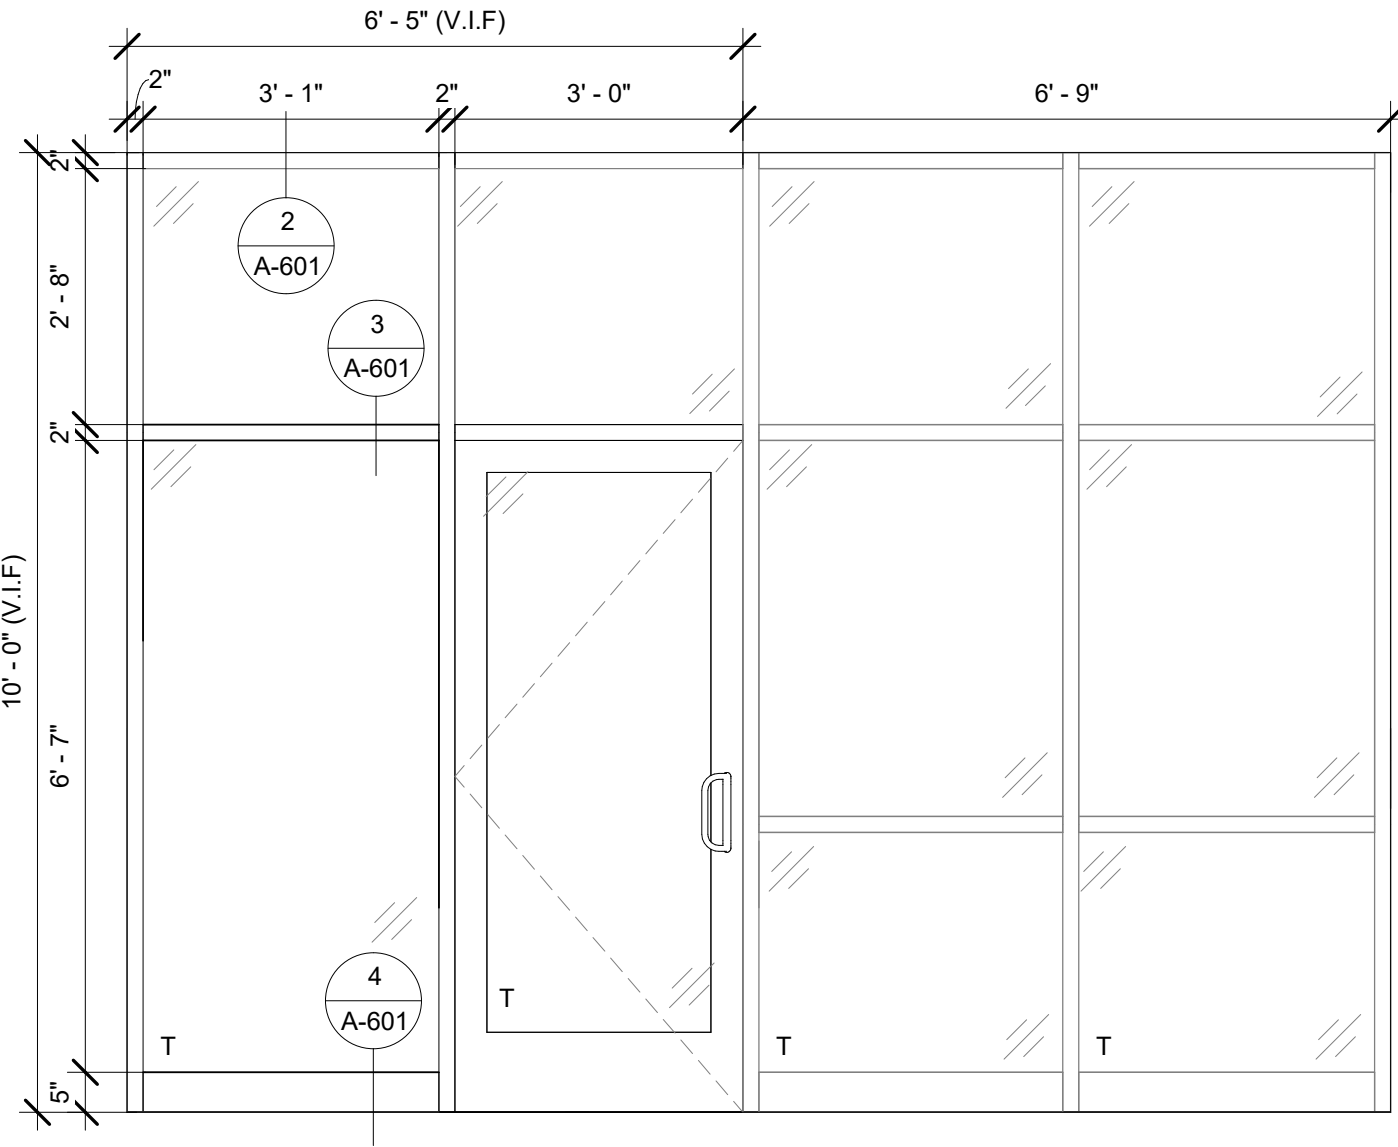

1 W01
Scale: 1/2" = 1'-0"

DOOR SCHEDULE - "D"					
DESIGN ID	COUNT	DESCRIPTION	FURN. BY	INST. BY	COMMENTS
DOOR					
10190	2	DOOR - SINGLE FLUSH - 36IN - TYPE E	SB	GC	DOOR FINISH: STAIN TO MATCH WD0035; FRAME FINISH: SW6991-SG; KICKPLATE : STAINLESS STEEL LOCKNET; SEE HARDWARE SET #6, DOOR TYPE E
X2001	1	DOOR - STOREFRONT METAL FRAME SINGLE - TYPE B	GC	GC	LOCKNET; DOOR FINISH: 1/4" TEMPERED GLASS - INSIDE GLAZING - IMPACT RESISTANT; FRAME FINISH: CLEAR ANODIZED ALUMINIUM; SEE HARDWARE SET # 2-A, DOOR TYPE B

WINDOW SCHEDULE

WINDOW	COUNT	MATERIAL			LINTEL	SILL HEIGHT	FURN. BY	INST. BY	COMMENTS	FLORIDA PRODUCT APPROVAL NUMBER	GLASS LOAD CAPACITY (PSF)			
		FRAME	FINISH	GLAZING							DAYLIGHT OPENING (IN)		GLASS TYPES	
W 01	1	ALUM	MATCH EXISTING	1/4" TEMPERED GLASS - INSIDE GLAZING - IMPACT RESISTANT	10' - 0" V/F	0' - 0"	GC	GC	WINDOW: YKK YHS 50 FI ENTRANCE: YKK AP 35H	WINDOW: 14218.3 ENTRANCE: 16981.2	39.5	84.34	70.0	90.0

ABBREVIATIONS:

-ALUM: ALUMINUM -TEMP: TEMPERED GLASS
-AND: ANODIZED -INSUL: INSULATED GLASS

GLAZING NOTES:

1/4" TEMPERED GLASS - INSIDE GLAZING - IMPACT RESISTANT

GENERAL NOTES:

- SEALANT TO MATCH CLEAR ANODIZED SPANDREL ALUMINUM STOREFRONT SYSTEM.
- FIELD VERIFY ALL DIMENSIONS PRIOR TO STOREFRONT MANUFACTURING.

BUILDING CODES: 2023 FLORIDA BUILDING CODE, 2021 INTERNATIONAL BUILDING CODES, ASCE 7-16

DESIGN LOADS:

WIND DESIGN DATA:
DESIGN WIND SPEED: V(ult) = 138 MPH
RISK CATEGORY: II
WIND EXPOSURE: C
ZONE: 4


COMPONENTS AND CLADDING (ULT.)

WALLS
POS. ZONE 4: +38.0 psf
NEG. ZONE 4: -41.2 psf.


*PLUS AND MINUS SIGNS SIGNIFY PRESSURES ACTING TOWARD AND AWAY FROM BUILDING SURFACES.

DOOR LEGEND


Construction:	Glazing:	Frame:
SC = Solid Core HM = Hollow Metal AL = Aluminum Storefront WD = Wood Storefront E = Existing	T = Solid Core W = Hollow Metal Rating: NR = Non-Rated 1HR = 1 hour 2HR = 2 hour	AL = Aluminum Storefront HM1 = Hollow Metal Single Rabbet HM2 = Hollow Metal Double Rabbet HM3 = Hollow Metal Single Rabbet for CMU HM4 = Hollow Metal No Rabbet
Miscellaneous: U = 1/2" Undercut		

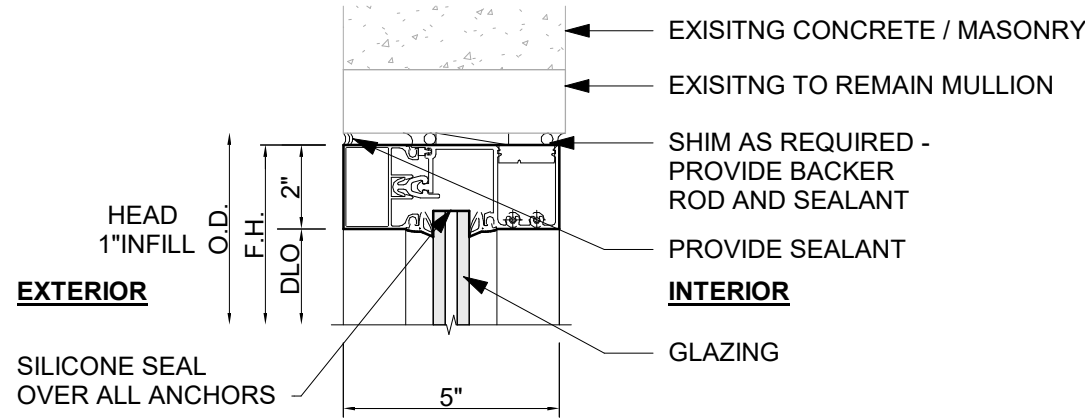

2 GLAZING DETAIL AT TOP
Scale: 3" = 1'-0"

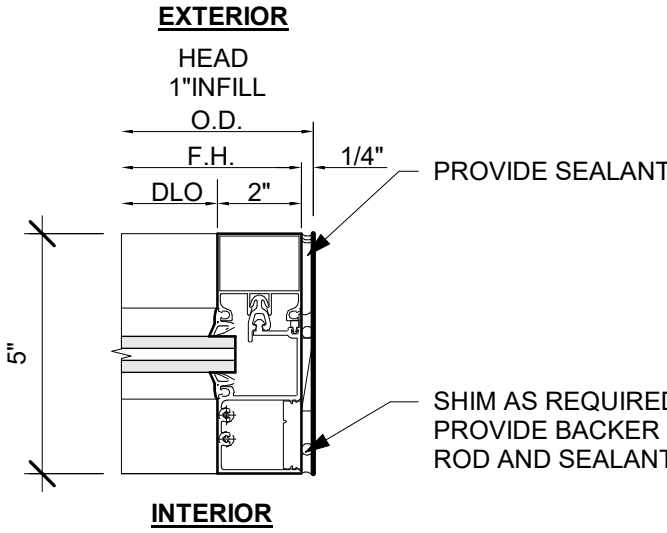

3 GLAZING DETAIL AT MULLION
Scale: 3" = 1'-0"

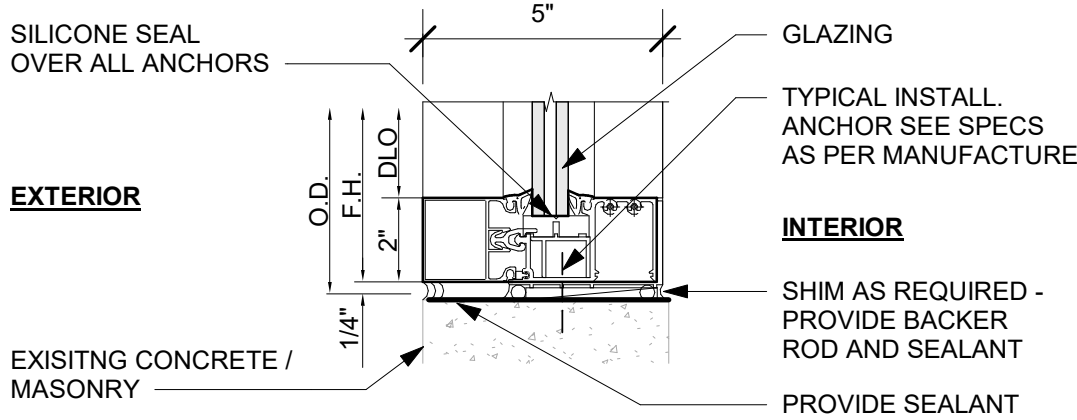

4 GLAZING DETAIL AT BOTTOM
Scale: 3" = 1'-0"

GENERAL NOTES

- STARBUCKS VENDOR TO PROVIDE DOOR HARDWARE COMPONENTS. GC TO INSTALL.
- SEE SHEET A101 FOR TAGGED LOCATION OF EXTERIOR DOORS AND WINDOWS.
- EGRESS SHALL NOT PASS THROUGH KITCHENS, STORAGE ROOMS, CLOSETS OR SIMILAR SPACES. (1014.2)
- PANIC AND FIRE EXIT HARDWARE, WHERE INSTALLED ON DOORS IN THIS BUILDING SHALL SATISFY THE FOLLOWING (1008.1.10):
 - THE ACTUATION PORTION OF THE RELEASING DEVICE SHALL EXTEND AT LEAST ONE-HALF OF THE DOOR LEAF WIDTH.
 - THE MAXIMUM UNLATCHING FORCE DOES NOT EXCEED 15 POUNDS (6.8 KG).
 - PIVOTED OR BALANCED DOORS SHALL BE OF THE PUSH-PAD TYPE WHERE PANIC HARDWARE IS REQUIRED AND THE PAD SHALL NOT EXTEND ACROSS MORE THAN ONE-HALF OF THE DOOR WIDTH, MEASURED FROM THE LATCH SIDE.
 - PANIC HARDWARE LISTED IN ACCORDANCE WITH UL 305.
 - FIRE EXIT HARDWARE LISTED IN ACCORDANCE WITH UL 10C AND UL 305.
- SPY SCOPE HARDWARE, WHERE INSTALLED SHALL BE CENTERED IN DOOR AT 54" (1370MM) A.F.F.

RESPONSIBILITY LEGEND

FURN. BY	INST. BY
GC - FURNISHED BY GENERAL CONTRACTOR	GC - INSTALLED BY GENERAL CONTRACTOR
SB - FURNISHED BY STARBUCKS	SB - INSTALLED BY STARBUCKS
VD - FURNISHED BY VENDOR	VD - INSTALLED BY VENDOR

NOTE:
ALL RESPONSIBILITIES TO BE CONFIRMED WITH STARBUCKS CONSTRUCTION MANAGER PRIOR TO ORDERING / CONSTRUCTION.

FOR CONSTRUCTION



© 2023 STARBUCKS COFFEE COMPANY

STARBUCKS®
2401 UTAH AVENUE SOUTH
SEATTLE, WASHINGTON 98134
(206) 318-1575

THESE DRAWINGS AND THE PROJECT MANUAL ARE CONFIDENTIAL AND SHALL REMAIN THE SOLE PROPERTY OF STARBUCKS CORPORATION, WHICH IS THE OWNER OF THE COPYRIGHT IN THIS WORK. THEY SHALL NOT BE REPRODUCED IN WHOLE OR IN PART, SHARED WITH THIRD PARTIES OR USED IN ANY MANNER ON OTHER PROJECTS OR EXTENSIONS TO THIS PROJECT WITHOUT THE PRIOR WRITTEN CONSENT OF STARBUCKS CORPORATION. THESE DRAWINGS AND SPECIFICATIONS ARE INTENDED TO EXPRESS DESIGN INTENT FOR A PROTOTYPICAL STARBUCKS STORE (WHICH IS SUBJECT TO CHANGE AT ANYTIME) AND DO NOT REFLECT ACTUAL SITE CONDITIONS. NEITHER PARTY SHALL HAVE ANY OBLIGATION NOR LIABILITY TO THE OTHER (EXCEPT STATED ABOVE) UNTIL A WRITTEN AGREEMENT IS FULLY EXECUTED BY BOTH PARTIES.

STARBUCKS TEMPLATE VERSION: i2023.10.23

Design Forum Architects Inc.
2050 Byers Rd
Miami, OH 45342
Tel: (844) 804-7700
Donald J. Reihman
Architect In Charge
License: AR0017303

MARQUE ENGINEERING
2230 PARK AVE, STE. 100, CINCINNATI, OH 45206
513.457.7131 - WWW.MARQUEENG.COM

PROJECT NAME:
S SEMORAN BLVD & LEE VISTA BLVD

PROJECT ADDRESS:
**6605 S SEMORAN BLVD
ORLANDO, FL 32822**

STORE #: 9875
PROJECT #: 25630-101
ISSUE DATE: 03/04/2024
DESIGN MANAGER: MARTIN PEREZ
PRODUCTION DESIGNER: ANDY MCLOUD
CHECKED BY: DONALD REHMAN

Revision Schedule				
Rev	Date	By	Description	

SHEET TITLE:
WINDOW AND DOOR SCHEDULES & DETAILS
SCALE: NO SCALE

SHEET NUMBER:
A-601

\\file-day.ad.changeupinc.com\Client\StarbucksArchitecture\Projects_2023\Florida\Semoran & Lee Vista -25630-10\25630-101_9875_S Semoran Blvd & Lee Vista Blvd, FL_2023.rvt 3/4/2024 2:39:32 PM

KEYED NOTES

1. INSTALL NEW EXTERIOR FURNITURE THROUGHOUT AS SHOWN.

2. EXISTING PATIO RAILING.

3. INSTALL NEW CAFE FURNITURE THROUGHOUT AS SHOWN.

4. INSTALL MERCH BAYS AS INDICATED. SECURE TO WALL.

5. DO NOT CAULK TRASH RINGS TO COUNTERTOPS.

6. LOCATION OF WASTE & RECYLING CART. SEE INTERIOR FINISH ELEVATIONS.

7. RELOCATED 1-DOOR UNDERCOUNTER REFRIGERATOR.

8. RELOCATED MASTRENAS.

9. RELOCATED CUP LABELERS.

10. RELOCATED GRINDER.

11. RELOCATED POS EQUIPMENT.

12. RELOCATED DT POS EQUIPMENT.

13. RELOCATED WARMING OVENS.

14. RELOCATED BLENDERS.

15. INSTALL NEW NITRO EQUIPMENT AS INDICATED.

16. DO NOT BLOCK FOOD CASE INTAKE / EXHAUST.

17. HAND SINK W / INTEGRAL SPLASH GUARD.

18. G.C. TO REVERSE HINGE ON U.C. REFRIGERATOR TO LEFT HAND SWING AS SHOWN.

19. RELOCATED LOCATION OF ALL SWITCHING AND THERMOSTAT.
20. RELOCATED LOCATION OF FIRE EXTINGUISHER.

21. RELOCATED SECURITY SAFE WITH BASE.

22. RELOCATED HAND SINK.

23. RELOCATED METRO RACK.

24. MANAGER'S DESK. SEE MANAGER'S DESK / EQUIPMENT RACK ELECTRICAL DETAIL FOR ADDITIONAL INFORMATION.

25. RELOCATED 1-DOOR REFRIGERATOR.

26. RELOCATED 1-DOOR FREEZER.

27. RELOCATED DISHWASHER.

28. RELOCATED WATER FILTRATION SYSTEM AND MOP SINK.

29. HAMPER TO BE ORDERED BY STORE OPERATIONS.

30. EXISTING LOCATION OF TRASH BIN.

31. SECURE LOCKERS TO WALL PER MFGS. RECOMMENDATIONS.

32. RELOCATED RESTROOM FIXTURE AND ACCESSORIES. REFER TO ENLARGED RESTROOM PLANS AND ELEVATIONS (SHEET I-401) FOR FIXTURE LOCATIONS AND MOUNTING HEIGHTS.

33. NEW FILTRATION BOOSTER PUMP LOCATED ABOVE. SEE PLUMBING DRAWINGS.

34. EXISTING ROOF LADDER.

35. LOCATION OF ORDER STATUS BOARD.

36. EXISTING RECESSED ELECTRICAL PANELS.

37. RELOCATED COAT HOOK.

38. RELOCATED RESTROOM SIGNAGE.

39. RELOCATED ICE MACHINE. GC TO VERIFY THE EXISTING ICE MACHINE, BIN, BIN ADAPTER AND ASSOCIATED EQUIPMENT PRIOR RELOCATION AND COORDINATE WITH STARBUCKS CONSTRUCTION MANAGER AND PROJECT SPECIALIST TO VERIFY ALL COMPOMENTS ARE BEING PROVIDED.

NOTE :
REFER SHEET I-101.1 FOR DATA DEVICE, FURNITURE, GRAPHICS, PLUMBING FIXTURE, SPECIALITY EQUIPMENT, MECHANICAL EQUIPMENT AND SITE SCHEDULE.

GENERAL NOTES

- A. GENERAL CONTRACTOR TO SCHEDULE WITH LOCAL REFRIGERATION CONTRACTOR TO CONDUCT INITIAL FOOD CASE START-UP AND TESTING. FOR LIST OF APPROVED START UP CONTRACTORS, CONTACT PROJECT CONSTRUCTION REPRESENTATIVE.

B. THE SITE IS SERVED BY THE MUNICIPAL WATER AND SEWER SYSTEM UNLESS OTHERWISE NOTED.

C. ALL FLOOR AND WALL JUNCTIONS IN STORAGE AND PREP. AREAS SHALL HAVE A 6" COVED BASE.

D. ALL FOOD STORAGE SHALL BE 6" (150mm) A.F.F.

E. ALL WOOD SURFACES (DOORS, TRIM, SHELVES, CABINETS) SHALL BE SEALED.

F. FLOORS, WALLS AND CEILING FINISHES IN FOOD PREP. AREAS SHALL BE SMOOTH, NON-TOXIC, NON-ABSORBENT, DURABLE AND EASILY CLEANABLE. PAINT SHALL BE WASHABLE AND SEMI-GLOSS OR HIGH-GLOSS FINISH.

G. ALL EQUIPMENT AND INSTALLATION WILL MEET NATIONAL SANITATION FOUNDATION STANDARDS OR EQUIVALENT.

H. ALL EQUIPMENT AND CABINETRY WILL BE FLUSH MOUNTED TO COUNTERS, WALLS OR FLOORS, OR BE RAISED TO ALLOW FOR CLEANING.

I. CONFIRM ALL NECESSARY CLEARANCES PER PRODUCT CUT SHEET REQUIREMENTS FOR ALL EQUIPMENT (E.G. ICE MACHINE).


J. EQUIPMENT UNITS SHALL CONTAIN NO EXPOSED THREADS, EMBELLISHMENTS OR OVERHANGING EDGES THAT SERVE AS PLACES FOR ACCUMULATION OF DUST, DIRT AND DEBRIS.

K. WARMING OVEN(S) SHOWN FOR PERMITTING PURPOSES. INSTALLATION AT STORE OPENING TO BE VERIFIED BY STARBUCKS CONSTRUCTION REPRESENTATIVE.


L. EACH HAND WASHING SINK WILL HAVE A SINGLE SERVICE TOWEL AND SOAP DISPENSER, AND ALL HAND SINKS TO HAVE A COMBINATION FAUCET OR PREMIXING FAUCET.

M. FOR PLUMBING FIXTURES, REFER TO THE PLUMBING DESIGN PLAN. FOR DATA DEVICE SCHEDULE, REFER TO THE ELECTRICAL DESIGN PLAN.


N. SEE ELEVATIONS FOR DISTRIBUTION OF CUP DISPENSERS.

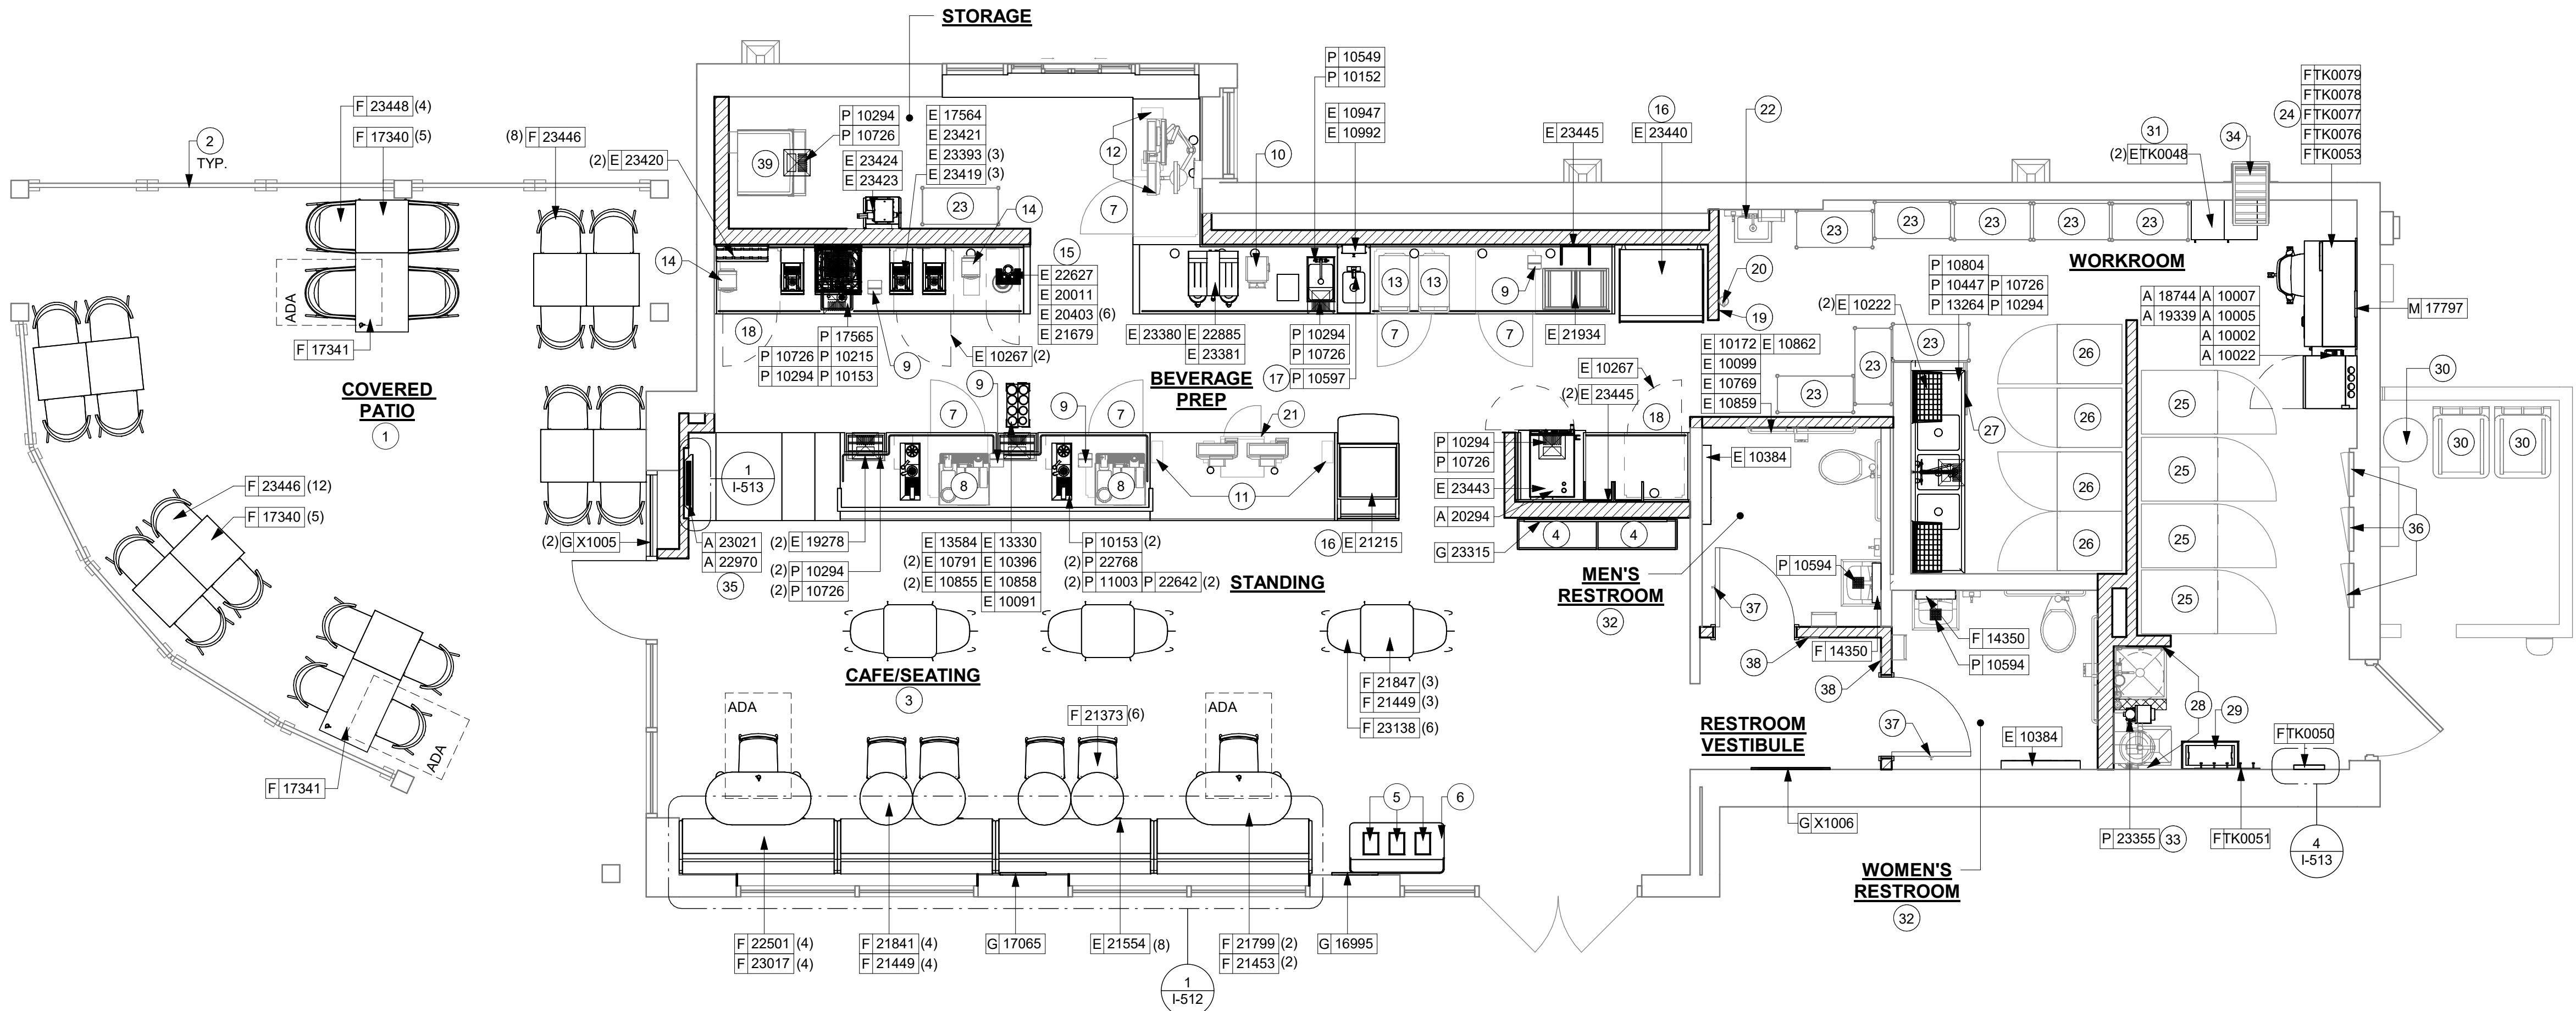

1 FURNITURE, FIXTURES AND EQUIPMENT PLAN
Scale: 1/4" = 1'-0"

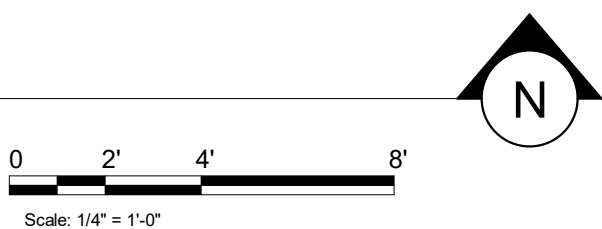

FOR CONSTRUCTION



© 2023 STARBUCKS COFFEE COMPANY

STARBUCKS®
2401 UTAH AVENUE SOUTH
SEATTLE, WASHINGTON 98134
(206) 318-1575

THESE DRAWINGS AND THE PROJECT MANUAL ARE CONFIDENTIAL AND SHALL REMAIN THE SOLE PROPERTY OF STARBUCKS CORPORATION, WHICH IS THE OWNER OF THE COPYRIGHT IN THIS WORK. THEY SHALL NOT BE REPRODUCED IN WHOLE OR IN PART, SHARED WITH THIRD PARTIES OR USED IN ANY MANNER ON OTHER PROJECTS OR EXTENSIONS TO THIS PROJECT WITHOUT THE PRIOR WRITTEN CONSENT OF STARBUCKS CORPORATION. THESE DRAWINGS AND SPECIFICATIONS ARE INTENDED TO EXPRESS DESIGN INTENT FOR A PROTOTYPICAL STARBUCKS STORE (WHICH IS SUBJECT TO CHANGE AT ANYTIME) AND DO NOT REFLECT ACTUAL SITE CONDITIONS. NEITHER PARTY SHALL HAVE ANY OBLIGATION NOR LIABILITY TO THE OTHER (EXCEPT STATED ABOVE) UNTIL A WRITTEN AGREEMENT IS FULLY EXECUTED BY BOTH PARTIES.

STARBUCKS TEMPLATE VERSION: i2023.10.23

Design Forum Architects Inc.
2050 Byers Rd
Miami, OH 45342
Tel: (844) 804-7700
Donald J. Reithman
Architect In Charge
License: AR0017303

MARQUE ENGINEERING
2230 PARK AVE, STE. 100, CINCINNATI, OH 45206
513.457.7131 - WWW.MARQUEENG.COM

PROJECT NAME:
S SEMORAN BLVD & LEE VISTA BLVD

PROJECT ADDRESS:
**6605 S SEMORAN BLVD
ORLANDO, FL 32822**

STORE #: 9875
PROJECT #: 25630-101
ISSUE DATE: 03/04/2024
DESIGN MANAGER: MARTIN PEREZ
PRODUCTION DESIGNER: ANDY MCLOUD
CHECKED BY: DONALD REITHMAN

Revision Schedule			
Rev	Date	By	Description

SHEET TITLE:
FF & E PLAN

SCALE: 1/4" = 1'-0"

SHEET NUMBER:
I-101

DATA DEVICE SCHEDULE - "A"					
DESIGN ID	COUNT	DESCRIPTION	FURN. BY	INST. BY	COMMENTS
AUDIO VISUAL					
10005	1	MUSIC SYSTEM	SB	GC	
10013	2	DT QUEUE CAMERA	SB	GC	
19339	1	AMPLIFIER - 40W	SB	GC	
19493	3	SPEAKER PENDANT MOUNTED - BLACK	SB	GC	
DATA					
10002	1	COMPUTER MANAGER WORKSTATION	SB	GC	
10007	1	PRINTER MANAGER WORKSTATION	SB	GC	
18744	1	EQUIPMENT RACK WITH LOCK - 24IN 610MM	SB	GC	
20294	1	IOT MODULE	SB	GC	
GRAPHICS - INTERIOR MENU					
22970	4	MENU BOARD - DIGITAL DISPLAY - 44X25.25IN 1121X644MM - BLACK	SB	GC	
22971	3	MENU BOARD - DIGITAL MENU BOARD MOUNTING BRACKET SINGLE SCREEN - BLACK	SB	GC	
23021	1	MENU BOARD - ORDER STATUS BOARD MOUNTING BRACKET - BLACK	SB	GC	
POINT OF SALE					
10022	1	MONEY COUNTER	SB	GC	

SPECIALTY EQUIPMENT SCHEDULE - "E"					
DESIGN ID	COUNT	DESCRIPTION	FURN. BY	INST. BY	COMMENTS
COOLING					
10267	3	FRIDGE UNDERCOUNTER 1 DOOR - 27IN 685MM	SB	GC	
20011	1	FRIDGE NITRO 2 TAP JT NITCOM RH	SB	GC	KIT INCLUDES UNDERCOUNTER FRIDGE, FONT, TRAY, AND TUBING
EQUIPMENT					
17564	1	BLENDER PITCHER RINSER WITH SENSOR	SB	GC	
21679	1	NITROGEN GENERATOR ELEMENT COMPACT	SB	GC	
22885	1	BREWER CLOVER VERTICA DOUBLE	SB	GC	
23380	1	BREWER CLOVER VERTICA INSTALL KIT	SB	GC	
23381	1	BREWER CLOVER VERTICA CORD	SB	GC	
23393	3	EQUIPMENT - CBE MILK DISPENSE BRACKET SLIDE	SB	GC	
23419	3	MILK DISPENSER	SB	GC	
23443	1	OVEN COMBI	SB	GC	
FOOD CASE					
21215	1	FOOD CASE - ZEPHYR - 28IN 710MM	SB	GC	
23440	1	FOOD CASE - WARMING WALL - 1000 SQUARE	SB	GC	
ICE					
19278	2	ICE - BIN DROP IN 45LB 20KG HORIZONTAL	SB	GC	
23421	1	ICE - NUGGET ICE DISPENSER - SINGLE ICE MACHINE	SB	GC	
23423	1	ICE - NUGGET ICE DIVERTER	SB	GC	
23424	1	ICE - NUGGET ICE DIVERTER CONTROL PANEL	SB	GC	
OTHER					
10091	1	CUP DISPENSER TALL HOT VERTICAL	SB	GC	
10384	2	DIAPER CHANGING STATION HORIZONTAL	SB	GC	
10396	1	CUP DISPENSER SHORT HOT VERTICAL	SB	GC	
10791	2	CUP DISPENSER GRANDE VENTI COLD VERTICAL	SB	GC	
10855	2	CUP DISPENSER GRANDE VENTI HOT VERTICAL	SB	GC	
10858	1	CUP DISPENSER TALL COLD VERTICAL	SB	GC	
10947	1	SOAP DISPENSER WALL MOUNTED	SB	GC	
10992	1	PAPER TOWEL DISPENSER HALF SIZE - TRANSLUCENT GRAY	SB	GC	
13330	1	MOBILE CUP DISPENSER CADDY	SB	GC	
13584	1	CUP DISPENSER TRENTA COLD VERTICAL	SB	GC	
20403	6	KEG - 3GAL	SB	GC	
21554	8	POWER EXTENSION DUAL RECEPTACLE AND USB SURFACE MOUNT - BLACK	SB	GC	
22627	1	NITRO 2 TAP HANDLE WITH BADGE AND MOUNT KIT	SB	GC	JOE TAP, FOR USE AT BACKBAR NITRO FONT
23420	2	REFRESHER DISPENSE SMALL	SB	GC	
STORAGE					
10222	2	WIRE SHELF GRID AT SINK	SB	GC	
21934	1	PASTRY TRAY RACK UNDERCOUNTER - 30IN 760MM	SB	GC	
23445	3	PASTRY COOLING RACK WALL MOUNTED	SB	GC	
TK0048	2	5 COMP LOCKER - 15IN 380MM	SB	GC	

FURNITURE SCHEDULE - "F"					
DESIGN ID	COUNT	DESCRIPTION	FURN. BY	INST. BY	COMMENTS
BANQUETTE					
22501	4	BANQUETTE - SAN JUAN - 6FT 183CM - WALNUT WD0077	SB	GC	FINISH: WD0077; SEE DETAIL: 1/I-512
23017	4	BANQUETTE - SAN JUAN CUSHION SEAT AND BACK C EDGE - 6FT 183CM - CARAMEL BROWN NATURAL F0008	SB	GC	FINISH: F-0008; SEE DETAIL: 1/I-512; LENGTH REQUIRED: (1) 6' - 0"
CHAIR					
21373	6	CHAIR - CAFE PEGGY UPHOLSTERED - WALNUT AND CARAMEL BROWN NATURAL WD0077 F0008	SB	GC	
23138	6	CHAIR - CAFE ASHER UPHOLSTERED BACK - WALNUT AND BLACK NATURAL WD0077 F0046	SB	GC	
23446	20	CHAIR - CAFE HANS 2.0 - BLACK	SB	GC	
23448	4	CHAIR - LOUNGE HANS 2.0 - BLACK	SB	GC	
TK0077	1	CHAIR - MANAGERS WORKSTATION	SB	GC	STEELCASE SERIES ONE ARMLESS
DESK					
TK0053	1	DESK - MANAGERS WORKSTATION SHELVES - 48IN 1220MM	SB	GC	
TK0076	1	DESK - MANAGERS WORKSTATION - 48X24X27IN 1220X610X85MM	SB	GC	
MIRROR					
14350	2	MIRROR - RESTROOM ANGLED- 18X36IN 455X915MM	SB	GC	INSTALLED AT CENTER OF SINK, MIN. 40" A.F.F. TO B.O. MIRROR.
TK0050	1	MIRROR - BOH - 16X51IN 405X1295MM	SB	GC	SEE DETAIL: 4/I-513
OTHER					
TK0051	1	COAT HOOK STRIP - 30IN 760MM	SB	GC	BLACK FINISH
STORAGE					
TK0078	1	FILE MOBILE PEDESTAL WITH CUSHION AND LOCK	SB	GC	
TK0079	1	MANAGERS DESK CART - 24X20IN 610X510MM	SB	GC	
TABLE					
17340	10	TABLE - CAFE METAL PEDESTAL BASE SQUARE - 24IN 610MM - BLACK MT0028	SB	GC	
17341	2	TABLE - ACCESSIBLE METAL WITH TAPERED LEGS - 36X24IN 915X610MM - BLACK MT0028	SB	GC	
21449	7	TABLE - BASE CAFE HEIGHT BOTTLE - FLAT BLACK MT0028	SB	GC	
21453	2	TABLE - BASE ACCESSIBLE BOTTLE - FLAT BLACK MT0028	SB	GC	
21799	2	TABLE - TOP ACCESSIBLE ROUND EDGE OBLONG - 48X24IN 1220X610MM - WALNUT WD0077	SB	GC	
21841	4	TABLE - TOP ROUND EDGE ROUND - 24IN 610MM - WALNUT WD0077	SB	GC	
21847	3	TABLE - TOP ROUND EDGE SQUARE - 24IN 610MM - WALNUT WD0077	SB	GC	
WINDOW TREATMENT					
22486	9	ROLLER SHADE - DARK BROWN - 5PC OPEN	SB	GC	LENGTH REQUIRED (V.I.F.): (1) 3' - 0" (1) 3' - 2" (1) 3' - 1" (4) 4' - 4" (1) 2' - 8" (1) 6' - 0" EXTEND TO TOP OF BOTTOM MULLION

GRAPHICS AND ARTWORK SCHEDULE - "G"					
DESIGN ID	COUNT	DESCRIPTION	FURN. BY	INST. BY	COMMENTS
GRAPHICS - ARTWORK					
16995	1	SBXART 16995 MICHAEL HANSON - COLOMBIA 22 - BW - FRAME WITH MAT- ART SIZE: 13" W X 22" H; MAT BORDER: 4" X 4"; OVERALL SIZE: 21" W X 30" H - PAPER - 1; FRAME: 1A - 613674 EBONIZED WALNUT	SB	GC	SEE ELEVATION: 1/I-202
17065	1	SBXART 17065 MICHAEL HANSON - PANAMA 18 - BW - FRAME WITH MAT- ART SIZE: 13" W X 22" H; MAT BORDER: 4" X 4"; OVERALL SIZE: 21" W X 30" H - PAPER - 1; FRAME: 1A - 613674 EBONIZED WALNUT	SB	GC	SEE ELEVATION: 1/I-202
23315	1	SBXART 23315 RYAN R BROWNE - HACIENDA ABSTRACTION 4 - WRAPPED CANVAS IN FLOAT FRAME - ART SIZE: 64"W X 43" H - REVEAL 1/4" - PRINT TO EDGES - PRINT EDGES BLACK -OVERALL SIZE: 65"W X 44" H - CANVAS 1 - FRAME 3A - 623674 EBONIZED WALNUT	SB	GC	SEE ELEVATION: 1/I-201
X1006	1	COMMUNITY BOARD WITH 3" FRAME; OVERALL SIZE: 48" W X 36" H	SB	GC	SEE ELEVATION: 4/I-204
GRAPHICS - OTHER					
X1005	2	3M FASARA GLASS FINISHES FROST/MATTE RE1SIAR, SILVER, 50 IN X 98.4 FT, 1 ROLL/CASE	SB	GC	BLOCK-OUT FILM APPLIED TO EXTERIOR OF WINDOW SIZE REQUIRED: (V.I.F.) (1) 3' - 1" W X 2' - 8" H (1) 3' - 1" W X 6' - 7" H

MECHANICAL EQUIPMENT SCHEDULE - "M"					
DESIGN ID	COUNT	DESCRIPTION	FURN. BY	INST. BY	COMMENTS
OTHER					
17797	1	ENERGY MANAGEMENT SYSTEM - HVAC ONLY	SB	GC	


PLUMBING FIXTURE SCHEDULE - "P"					
DESIGN ID	COUNT	DESCRIPTION	FURN. BY	INST. BY	COMMENTS
DRAIN					
10294	7	DRAIN - FLOOR SINK SQUARE - 12IN 305MM	SB	GC	ZURN FD2372-H, A.R.E. FLOOR SINK WITH 6" SUPM DEPTH AND 1/2 GRATE.
10594	2	DRAIN - FLOOR SINK SQUARE - 5IN 125MM	GC	GC	ZURN ZN415B
10726	7	FLOOR SINK - GRATE HALF SQUARE - 12IN 305MM	SB	GC	ZURN FD2372-H, A.R.E. FLOOR SINK WITH 6" SUPM DEPTH AND 1/2 GRATE.
FAUCET					
10152	1	FAUCET - DOUBLE LABORATORY WITH BENT RISER SPOUT	SB	GC	
10153	3	FAUCET - WATER TOWER - 12IN 305MM	SB	GC	
10215	1	FAUCET - DOUBLE LABORATORY WITH SWING SPOUT	SB	GC	
10447	1	FAUCET - PRE RINSE SPRAYER WALL MOUNTED	SB	GC	
10597	1	FAUCET - SINGLE HANDLE	SB	GC	
10804	1	FAUCET - PRE RINSE SWING SPOUT	SB	GC	
11003	2	FAUCET - METERED	SB	GC	
22642	2	FAUCET - INSTANTHOT SYSTEM 2 BUTTON WITH BOILER AND BRACKET	SB	GC	KIT INCLUDES FONT, UNDERCOUNTER BOILER AND BOILER BRACKET FOR SIDE PANEL MOUNTING - BRACKET CAN BE FLOOR MOUNTED USING SET OF (4) STAINLESS STEEL LEGS, ORDERED SEPARATELY THROUGH VENDOR.
FILTER					
23355	1	FILTER - FILTRATION BOOSTER PUMP	SB	SB	GC TO COORD. WITH VENDOR
SINK					
10549	1	SINK - RINSE DROP IN SST - 12X20IN 305X510MM	SB	GC	
13264	1	SINK - 3 COMP WORK SST - 93IN 2350MM	SB	GC	
17565	1	SINK - RINSE WITH DRAINBOARD - 15X27IN 380X685MM	SB	GC	
22768	2	SINK - COUNTERTOP RINSER WITH WATER TOWER - 26X9IN 660X235MM	SB	GC	

RESPONSIBILITY LEGEND

FURN. BY	INST. BY
GC - FURNISHED BY GENERAL CONTRACTOR	GC - INSTALLED BY GENERAL CONTRACTOR
SB - FURNISHED BY STARBUCKS	SB - INSTALLED BY STARBUCKS
VD - FURNISHED BY VENDOR	VD - INSTALLED BY VENDOR

NOTE:
ALL RESPONSIBILITIES TO BE CONFIRMED WITH STARBUCKS CONSTRUCTION MANAGER PRIOR TO ORDERING / CONSTRUCTION.

FOR CONSTRUCTION



© 2023 STARBUCKS COFFEE COMPANY

STARBUCKS®
2401 UTAH AVENUE SOUTH
SEATTLE, WASHINGTON 98134
(206) 318-1575

THESE DRAWINGS AND THE PROJECT MANUAL ARE CONFIDENTIAL AND SHALL REMAIN THE SOLE PROPERTY OF STARBUCKS CORPORATION, WHICH IS THE OWNER OF THE COPYRIGHT IN THIS WORK. THEY SHALL NOT BE REPRODUCED IN WHOLE OR IN PART, SHARED WITH THIRD PARTIES OR USED IN ANY MANNER ON OTHER PROJECTS OR EXTENSIONS TO THIS PROJECT WITHOUT THE PRIOR WRITTEN CONSENT OF STARBUCKS CORPORATION. THESE DRAWINGS AND SPECIFICATIONS ARE INTENDED TO EXPRESS DESIGN INTENT FOR A PROTOTYPICAL STARBUCKS STORE (WHICH IS SUBJECT TO CHANGE AT ANYTIME) AND DO NOT REFLECT ACTUAL SITE CONDITIONS. NEITHER PARTY SHALL HAVE ANY OBLIGATION NOR LIABILITY TO THE OTHER (EXCEPT STATED ABOVE) UNTIL A WRITTEN AGREEMENT IS FULLY EXECUTED BY BOTH PARTIES.

STARBUCKS TEMPLATE VERSION: i2023.10.23

Design Forum Architects Inc.

2050 Byers Rd
Miami, OH 45342
Tel: (844) 804-7700

Donald J. Reithman
Architect in Charge
License: AR0017303

MARQUE ENGINEERING

2230 PARK AVE, STE. 100, CINCINNATI, OH 45206
513.457.7131 - WWW.MARQUEENG.COM

PROJECT NAME:
S SEMORAN BLVD & LEE VISTA BLVD

PROJECT ADDRESS:
**6605 S SEMORAN BLVD
ORLANDO, FL 32822**

STORE #: 9875

PROJECT #: 25630-101

ISSUE DATE: 03/04/2024

DESIGN MANAGER: MARTIN PEREZ

PRODUCTION DESIGNER: ANDY MCLOUD

CHECKED BY: DONALD REITHMAN

Revision Schedule			
Rev	Date	By	Description

SHEET TITLE:
FF & E SCHEDULES

SCALE: NO SCALE

SHEET NUMBER:
I-101.1

SEE SHEET I-101.1 FOR DATA DEVICE SCHEDULE "A"

SEE SHEET I-103 FOR CASEWORK AND CASEWORK F
SCHEDULE "C"



I-102



STARBUCKS®
2401 UTAH AVENUE SOUTH
SEATTLE, WASHINGTON 98134
(206) 318-1575


THESE DRAWINGS AND THE PROJECT MANUAL ARE CONFIDENTIAL, AND SHALL REMAIN THE SOLE PROPERTY OF STARBUCKS CORPORATION, WHICH IS THE OWNER OF THE COPYRIGHT IN THIS WORK. THEY SHALL NOT BE REPRODUCED (IN WHOLE OR IN PART), SHARED WITH THIRD PARTIES OR USED IN ANY MANNER ON OTHER PROJECTS OR EXTENSIONS TO THIS PROJECT WITHOUT THE PRIOR WRITTEN CONSENT OF STARBUCKS CORPORATION. THESE DRAWINGS AND DRAWINGS ARE NOT TO BE EXTENDED TO EXPRESS DESIGN INTENT FOR A PROTOTYPICAL STARBUCKS STORE, WHICH IS SUBJECT TO CHANGE AT ANYTIME) AND DO NOT REFLECT ACTUAL SITE CONDITIONS. NEITHER PARTY SHALL HAVE ANY OBLIGATION NOR LIABILITY TO THE OTHER (EXCEPT STATED ABOVE) UNTIL A WRITTEN AGREEMENT IS FULLY EXECUTED BY BOTH PARTIES.

STARBUCKS TEMPLATE VERSION: i2023.10.23

**Design Forum
Architects Inc.**


2050 Byers Rd
Miamisburg, OH 45342
Tel: (844) 804-7700

Donald J. Rethman
Architect In Charge
License: AR0017303

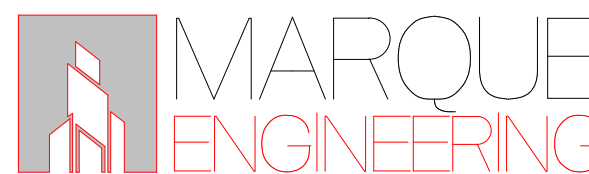


\\file-day.ad.changeupinc.com\Client\StarbucksArchitecture\Projects_2023\Florida\Semoran & Lee Vista -25630-101\25630-101_9875_S Semoran Blvd & Lee Vista Blvd, FL_2023.rvt 3/4/2024 2:39:37 PM

ADAPTABLE CASEWORK FRAMEWORK SCHEDULE - "C"					
DESIGN ID	COUNT	DESCRIPTION	FURN. BY	INST. BY	COMMENTS
DIEWALL					
21885	11	DIEWALL - FRAMING - VARIABLE LENGTH	SB	GC	
21888	40	DIEWALL - SUPPORT LEG	SB	GC	
23439	1	DIEWALL - WRM STRUCTURE LOWERED COUNTER	SB	GC	

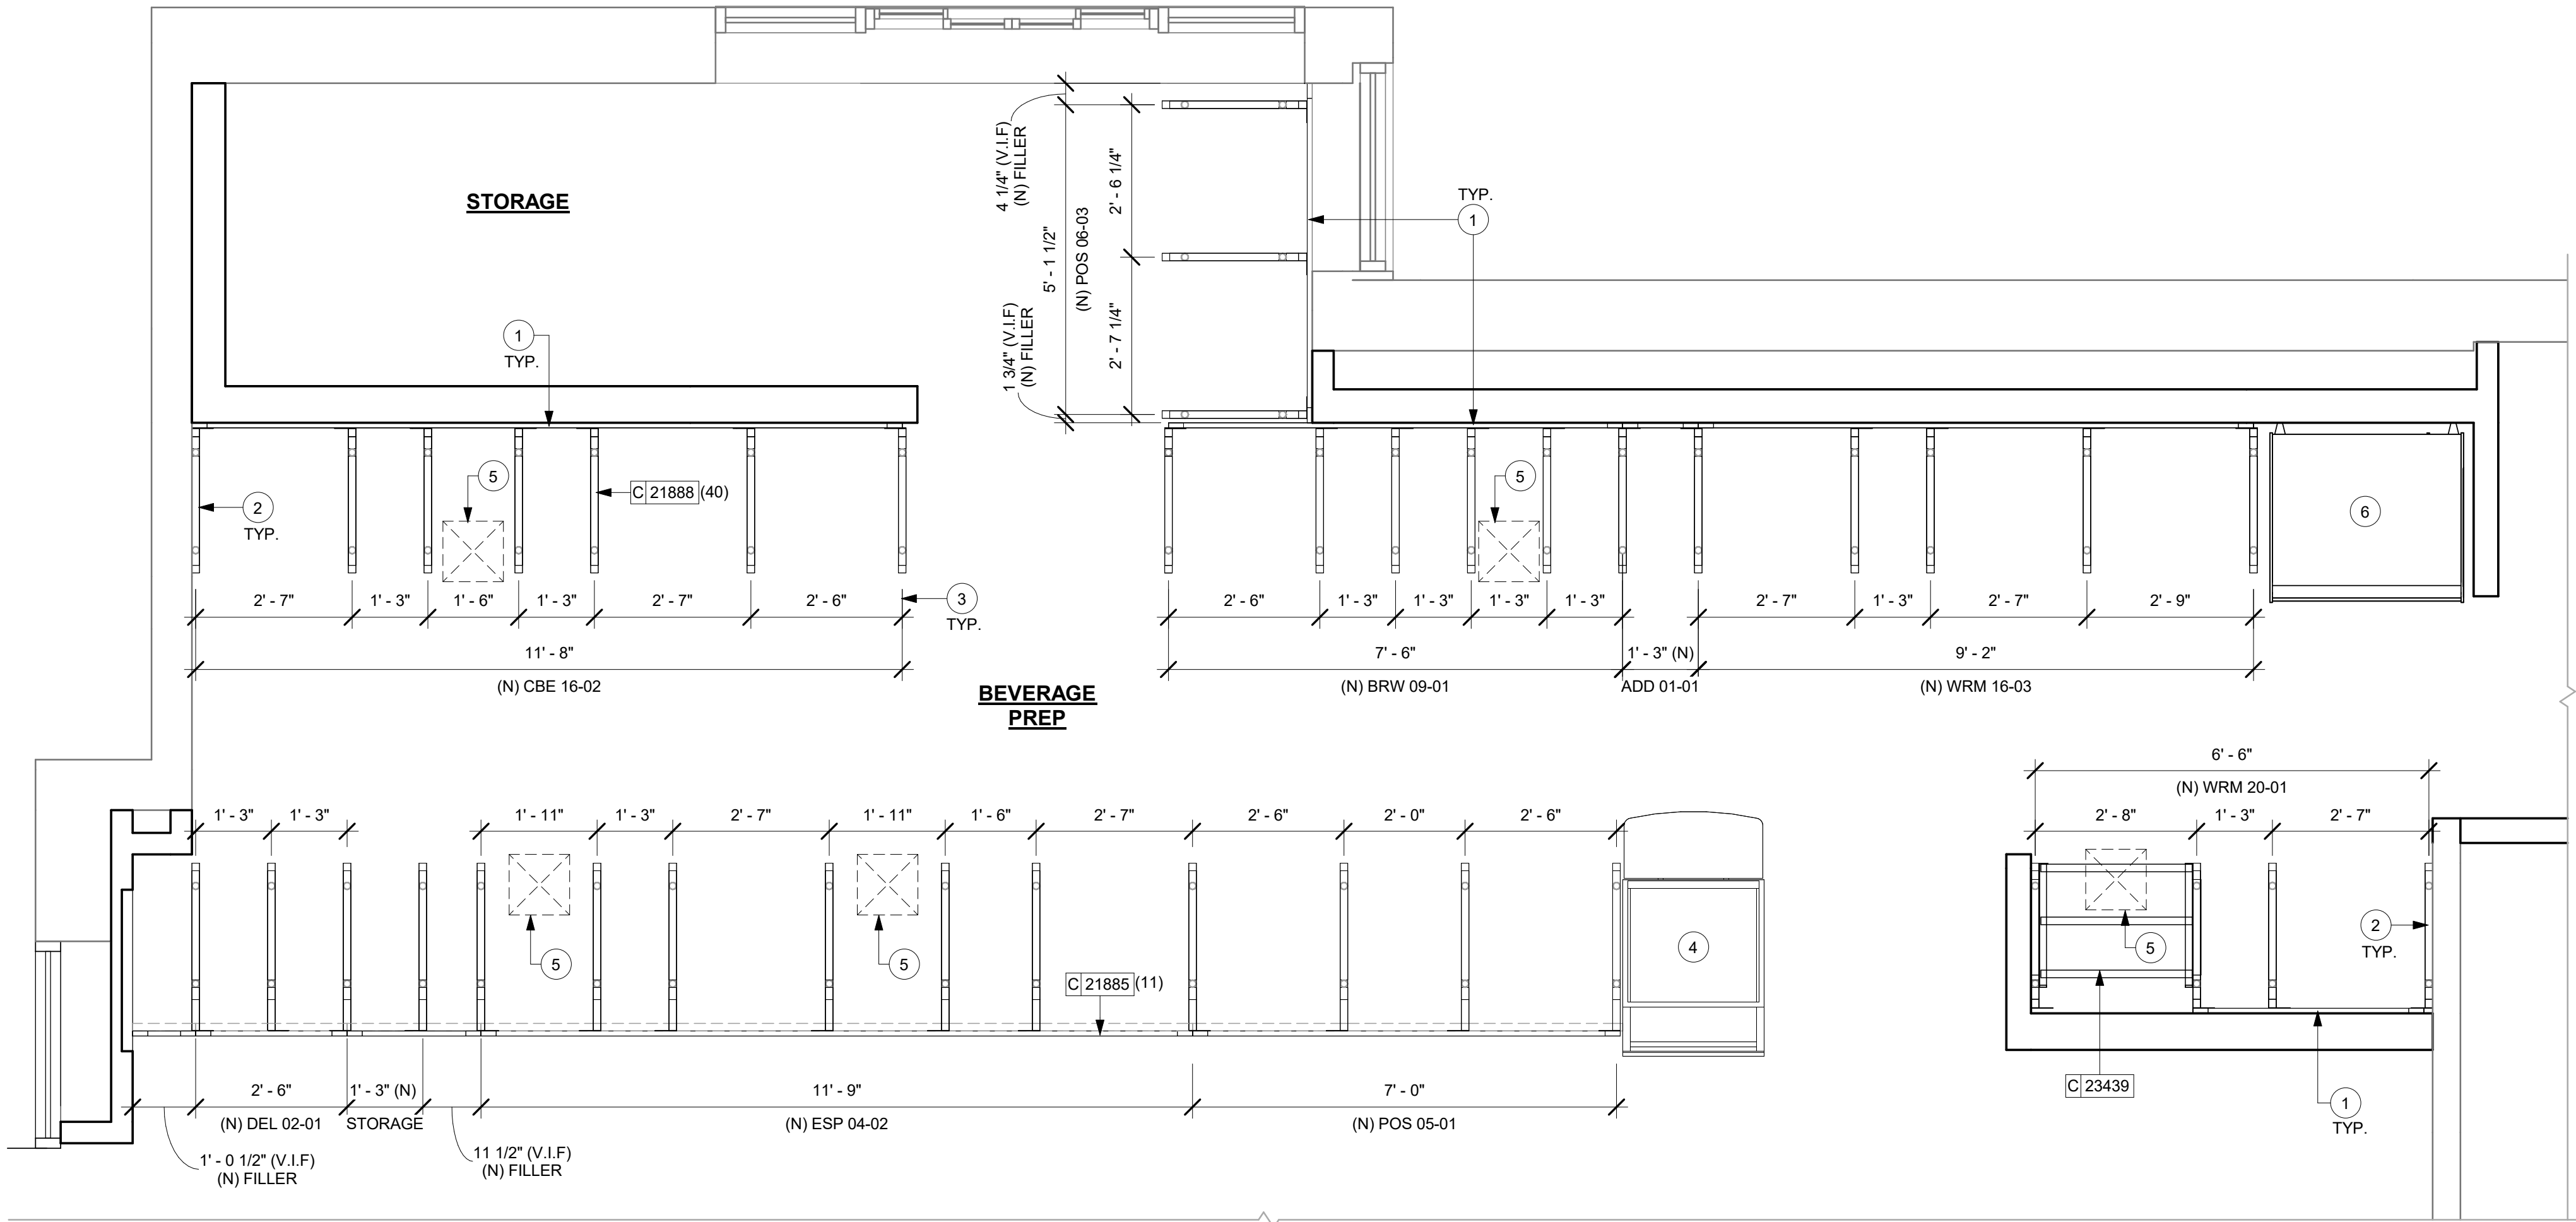

1 ADAPTABLE CASEWORK FRAMEWORK PLAN
Scale: 1/2" = 1'-0"

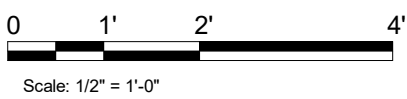

GENERAL NOTES

- SEE SHEET I-103 FOR COMPLETE CASEWORK SCHEDULE.
- METAL COMPONENTS PROVIDED BY CASEWORK SUPPLIER UNLESS OTHERWISE NOTED.
- DIEWALL TO BE INSTALLED PRIOR TO FLOORING MATERIAL INSTALLATION.
- DIEWALL TO BE ANCHORED TO FLOOR WITH HARDWARE SUPPLIED BY CASEWORK VENDOR.
- G.C. TO PROVIDE CONTINUOUS WALL BLOCKING BEHIND CASEWORK. G.C. TO INSTALL BLOCKING BETWEEN DIEWALL BASE.
- CASEWORK FRAME AT BAR ENDS ARE SUPPORTED BY 90 DEGREE DIEWALL BASE.
- ALL DIMENSIONS TAKEN FROM FRONTLINE DATUM POINT TO OUTSIDE CORNER OF DIEWALL BASE.
- TOP EDGE OF DIEWALL FRAME TO BE INSTALLED AT 32 13/16" A.F.F. AT LOW POINT.
- ALL DIMENSIONS ARE TO CENTER OF CABINET FRAME UNLESS NOTED OTHERWISE.

KEYED NOTES


- PROVIDE 3/4" BLOCKING TO 34" A.F.F. FOR ALL WALL FRAMES TO SUPPORT CASEWORK LEG.
- METAL SUPPORT LEG ADJACENT TO WALL TO BE SUPPORTED BY METAL ANGLE FASTENED TO WALL PER CONSTRUCTION DETAILS.
- DIMENSIONS LOCATING SUPPORT LEG ARE TO CENTER OF FRAME.
- NEW FOOD CASE.
- NEW FLOOR SINK BELOW. CASEWORK MANUFACTURER TO COORDINATE DESIGN TO ENSURE THIS AREA IS READILY ACCESSIBLE FOR CLEANING AND FREE OF COUNTERTOP SUPPORT.
- WARMING WALL.

RESPONSIBILITY LEGEND

FURN. BY	INST. BY
GC - FURNISHED BY GENERAL CONTRACTOR	GC - INSTALLED BY GENERAL CONTRACTOR
SB - FURNISHED BY STARBUCKS	SB - INSTALLED BY STARBUCKS
VD - FURNISHED BY VENDOR	VD - INSTALLED BY VENDOR

NOTE:
ALL RESPONSIBILITIES TO BE CONFIRMED WITH STARBUCKS CONSTRUCTION MANAGER PRIOR TO ORDERING / CONSTRUCTION.

FOR CONSTRUCTION



© 2023 STARBUCKS COFFEE COMPANY

STARBUCKS®
2401 UTAH AVENUE SOUTH
SEATTLE, WASHINGTON 98134
(206) 318-1575

THESE DRAWINGS AND THE PROJECT MANUAL ARE CONFIDENTIAL AND SHALL REMAIN THE SOLE PROPERTY OF STARBUCKS CORPORATION, WHICH IS THE OWNER OF THE COPYRIGHT IN THIS WORK. THEY SHALL NOT BE REPRODUCED IN WHOLE OR IN PART, SHARED WITH THIRD PARTIES OR USED IN ANY MANNER ON OTHER PROJECTS OR EXTENSIONS TO THIS PROJECT WITHOUT THE PRIOR WRITTEN CONSENT OF STARBUCKS CORPORATION. THESE DRAWINGS AND SPECIFICATIONS ARE INTENDED TO EXPRESS DESIGN INTENT FOR A PROTOTYPICAL STARBUCKS STORE (WHICH IS SUBJECT TO CHANGE AT ANYTIME) AND DO NOT REFLECT ACTUAL SITE CONDITIONS. NEITHER PARTY SHALL HAVE ANY OBLIGATION NOR LIABILITY TO THE OTHER (EXCEPT STATED ABOVE) UNTIL A WRITTEN AGREEMENT IS FULLY EXECUTED BY BOTH PARTIES.

STARBUCKS TEMPLATE VERSION: i2023.10.23

Design Forum Architects Inc.
2050 Byers Rd
Miamisburg, OH 45342
Tel: (844) 804-7700
Donald J. Reihman
Architect In Charge
License: AR0017303

MARQUE ENGINEERING
2230 PARK AVE, STE. 100, CINCINNATI, OH 45206
513.457.7131 - WWW.MARQUEENG.COM

PROJECT NAME:
S SEMORAN BLVD & LEE VISTA BLVD

PROJECT ADDRESS:
**6605 S SEMORAN BLVD
ORLANDO, FL 32822**

STORE #: 9875
PROJECT #: 25630-101
ISSUE DATE: 03/04/2024
DESIGN MANAGER: MARTIN PEREZ
PRODUCTION DESIGNER: ANDY MCLOUD
CHECKED BY: DONALD RETHMAN

Revision Schedule			
Rev	Date	By	Description


SHEET TITLE:
ADAPTABLE CASEWORK FRAMEWORK PLAN
SCALE: 1/2" = 1'-0"

SHEET NUMBER:
I-102.2


\\file-day.ad.changeupinc.com\Client\StarbucksArchitecture\Projects_2023\Florida\Semoran & Lee Vista -25630-101\25630-101_9875_S Semoran Blvd & Lee Vista Blvd, FL_2023.rvt 3/4/2024 2:39:38 PM

ADAPTABLE CASEWORK CABINET TYPES AND BILL OF MATERIALS SCHEDULE										
KEY NUMBER	CABINET TYPE	FULL HT. DOORS	3/4 DOOR	3/4 DOOR W/ VENT	DRAWER	BOTTOM SHELF	ADJUST. SHELF	BACK PANEL	SIDE PANELS	BOX BASE ^{AA}
101	15" STORAGE	1 ^{DID} 21894	N/A	N/A	N/A	1 ^{DID} 21891	1 ^{DID} 21893	1 ^{DID} 21892	2 ^{**} 21890	NO
102	18" SINK	1 ^{DID} 21901	N/A	N/A	N/A	1 ^{DID} 21898	N/A	1 ^{DID} 21899	2 ^{**} 21890	NO
103	30" STORAGE	1 ^{DID} 21905	N/A	N/A	N/A	1 ^{DID} 21902	1 ^{DID} 21904	1 ^{DID} 21903	2 ^{**} 21890	NO
104	30" POS	N/A	N/A	N/A	N/A	1 ^{DID} 21902	2 ^{DID} 21904	1 ^{DID} 21912	2 ^{**} 21890	NO
106	15" DRAWER	N/A	1 ^{DID} 21895	N/A	1 ^{DID} 21896	1 ^{DID} 21891	1 ^{DID} 21893	1 ^{DID} 21892	2 ^{**} 21890	NO
108	15" CUBBY - COFFEE	N/A	N/A	N/A	N/A	1 ^{DID} 21891	1 ^{DID} 21893	1 ^{DID} 21892	2 ^{**} 21890	NO
109	15" CUBBY - TRASH	N/A	1/0" 21895	N/A	N/A	N/A	0	0	2 ^{**} 21890	NO
110	15" SINK	1/0" 21894	N/A	N/A	N/A	1 ^A 21891	0	0	2 ^{**} 21890	NO
111	15" STORAGE	1/0" 21894	N/A	N/A	N/A	1 ^{DID} 21891	N/A	1 ^{DID} 21892	(2) ^{**} 21890	NO
112	24" SAFE	N/A	N/A	N/A	1 ^{DID} 10024	N/A	0	0	(1,2) ^{**} 21890	NO
113	30" REFRIGERATOR	N/A	N/A	N/A	N/A	N/A	0	0	(1,2) ^{**} 21890	NO
114	15" STORAGE	N/A	2 ^{DID} 23425	N/A	N/A	N/A	N/A	N/A	2 ^{**} 21890	NO
* DOOR NOT REQUIRED WHERE CUSTOMER VIEW IS LIMITED OR NEGLIGIBLE (i.e. FRONTLINE OR BEHIND WALLS)HR										
^{**} SIDE PANEL QUANTITY SHOWN IS FOR STAND-ALONE CABINETS; ACUTAL SIDE PANEL QUANTITY IS DEPENDENT ON ADJACENT CABINET TYPE AS SIDE PANELS CAN BE SHARED.										
^A BOTTOM SHELF AND BOX BASE (IF APPLICABLE), SHOULD BE REMOVED AT SINK/ICE BIN CABINETS WITH FLOOR SINK LOCATED BELOW										
^{AA} BOX BASE TO BE PROVIDED AT SPECIFIC CABINETS WHEN REQUIRED BY JURISDICTIONAL CODE OR LOCAL OPERATOR PREFERENCE (NOTED AS "YES")										

ADAPTABLE CASEWORK SUBSTRATE PANEL SCHEDULE - "C"					
DESIGN ID	COUNT	DESCRIPTION	FURN. BY	INST. BY	COMMENTS
DIEWALL					
21887	5	DIEWALL - SUBSTRATE PANEL - VARIABLE LENGTH	SB	GC	

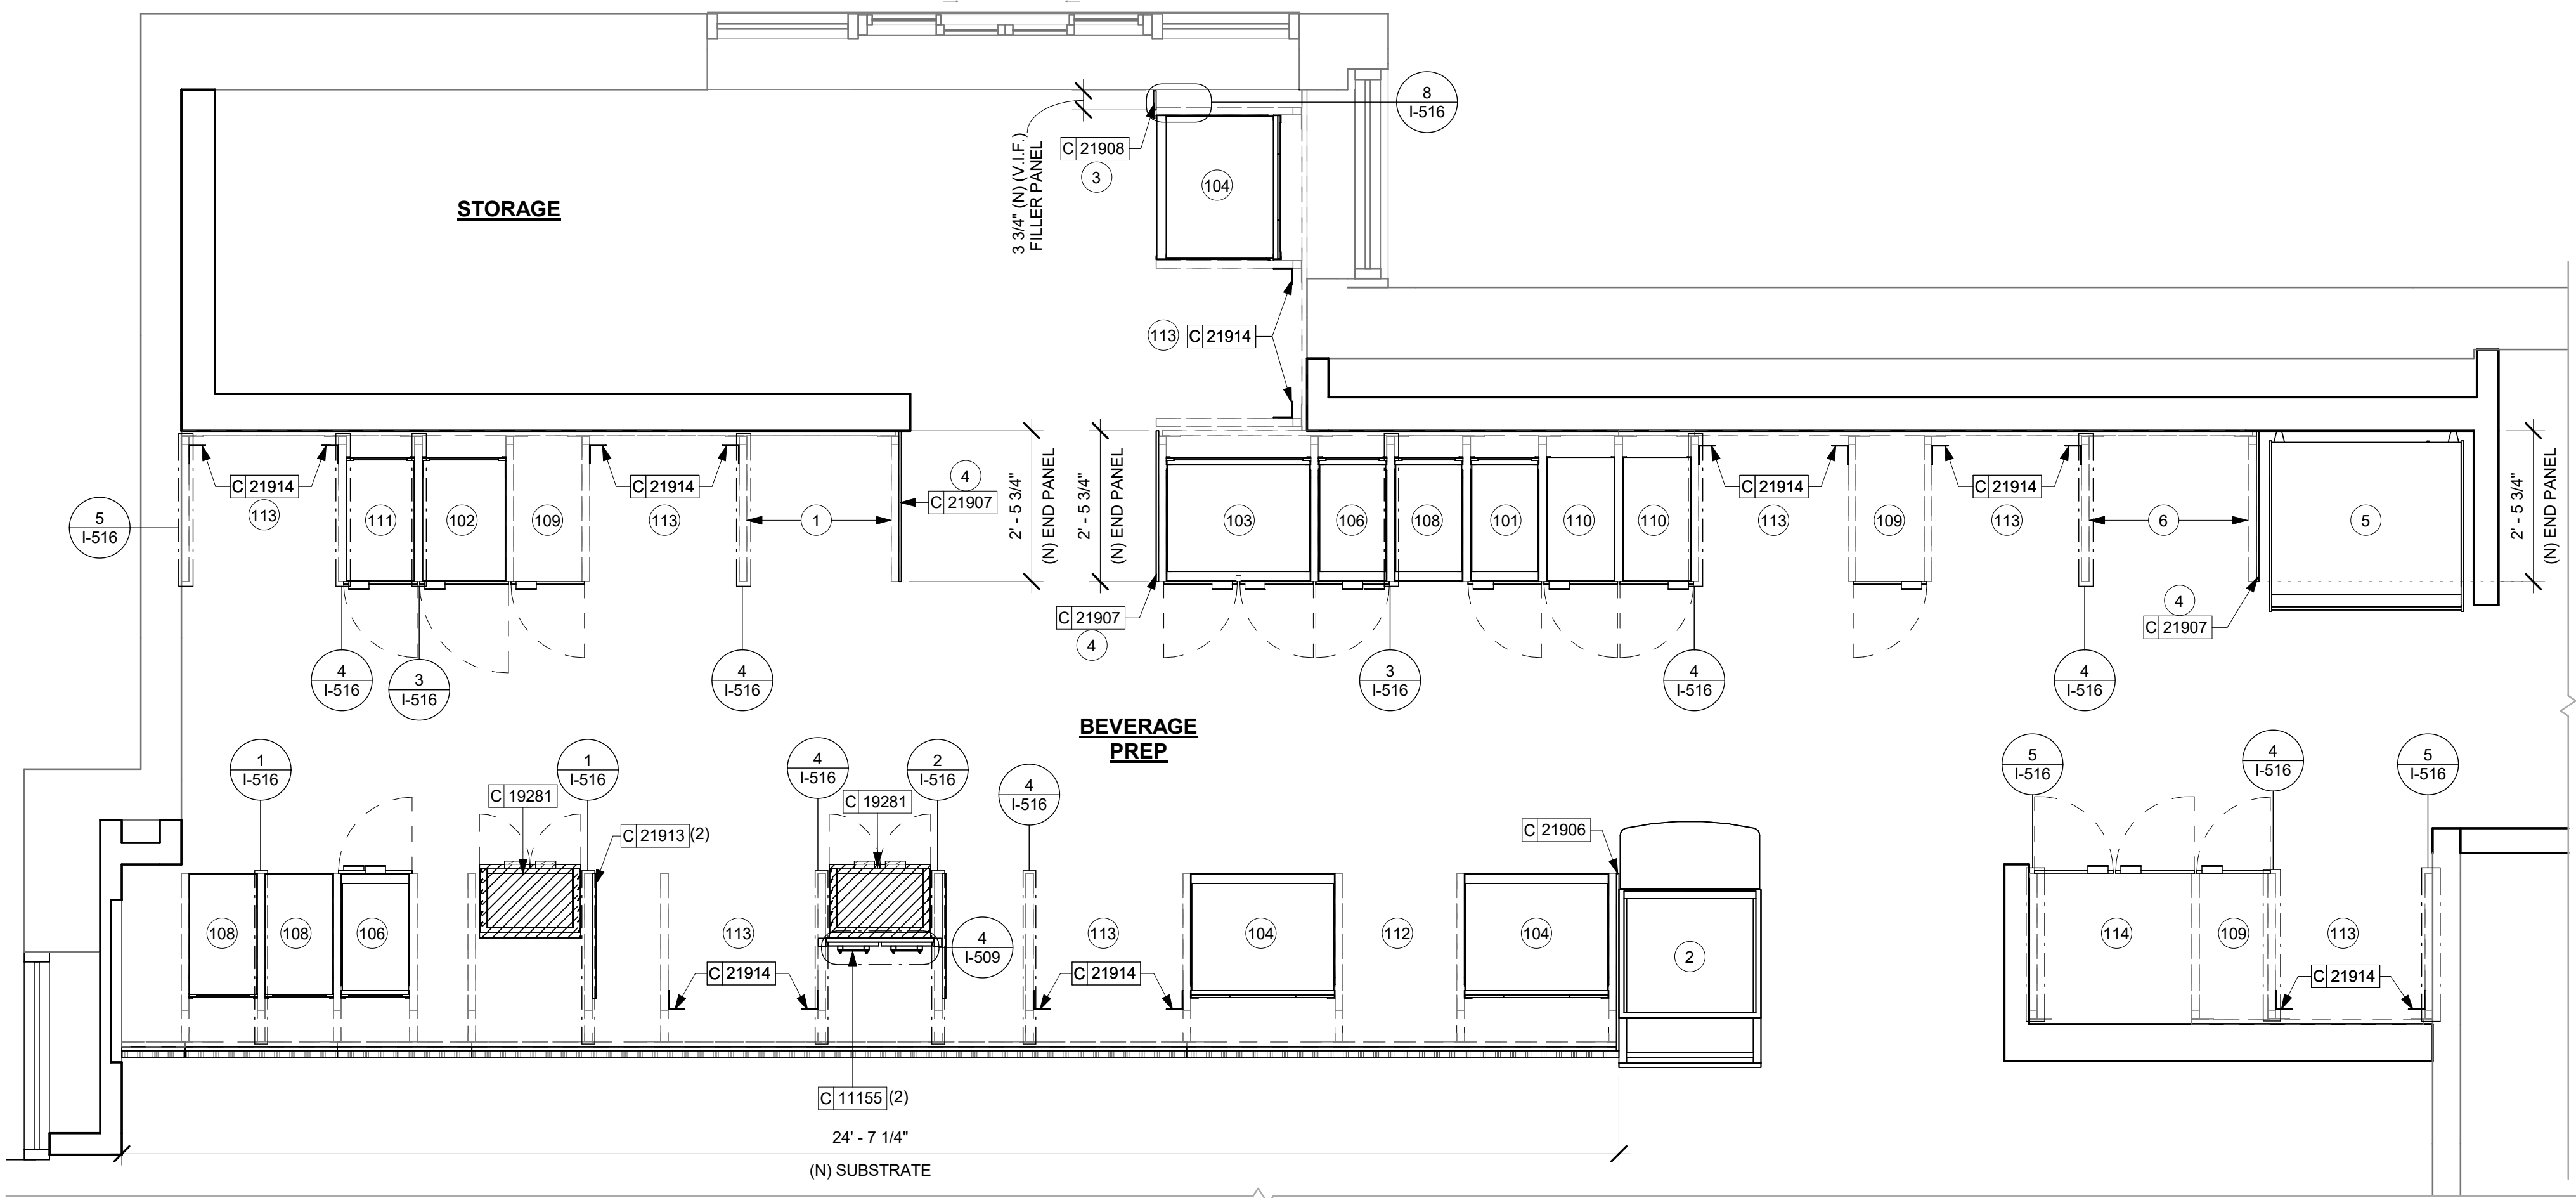

1 ADAPTABLE CASEWORK CABINET PLAN
Scale: 1/2" = 1'-0"

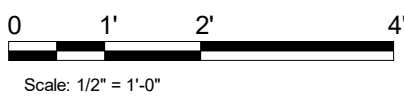

GENERAL NOTES

- A. SEE SHEET I-103 FOR COMPLETE CASEWORK SCHEDULE.
- B. ALL DIMENSIONS ARE TO CENTER OF FRAME ASSEMBLY.
- C. CABINET PANELS:
 - > ALL CABINET SHELVEING TO BE SECURED TO METAL COMPONENTS WITH #8 ROUND HEAD SCREWS.
 - > ALL METAL COMPONENTS SHALL BE SECURED TO FRAME ASSEMBLY AT KEY HOLE LOCATIONS.
 - > BOTTOM FLASHING SECURED TO HDPE WITH SILICONE.
- D. SUBSTRATE PANELS:
 - > SUBSTRATE PANELS SHALL BE MEDEX.
 - > CASEWORK VENDOR SHALL PROVIDE ALL SUB PANELS TO BE CUT TO SIZE PRIOR TO SHIPPING.
 - > CASEWORK VENDOR SHALL APPLY Z-CLIPS TO FINISH PANELS PRIOR TO SHIPPING.
 - > FRONTLINE PANELS TO BE SECURED TO SUBSTRATE VIA Z-CLIP APPLICATION.
 - > PANEL INSTALLATION TO START AT OUTSIDE CORNER LOCATIONS.
 - > END PANELS TO BE SCRIBED ON SITE.
 - > ALL PANEL CUT-OUTS SHALL BE FINISHED ALL
 - > Z-CLIPS TO BE INSTALLED 1" AWAY FROM PANEL EDGE.

KEYED NOTES

- 1. NITRO EQUIPMENT LOCATION.
- 2. NEW FOOD CASE.
- 3. FILLER FINISH PANEL TO BE SHIPPED LONGER THAN DIMENSIONED AND CUT TO FIT IN FIELD.
- 4. CASEWORK SUPPLIER TO PROVIDE ADDITIONAL BACKER SUBSTRATE TO ALIGN END CAP PANEL TO ADJACENT DOOR FACES.
- 5. WARMING WALL.
- 6. UNDERCOUNTER PASTRY TRAY LOCATION.

RESPONSIBILITY LEGEND

FURN. BY	INST. BY
GC - FURNISHED BY GENERAL CONTRACTOR	GC - INSTALLED BY GENERAL CONTRACTOR
SB - FURNISHED BY STARBUCKS	SB - INSTALLED BY STARBUCKS
VD - FURNISHED BY VENDOR	VD - INSTALLED BY VENDOR

NOTE:
ALL RESPONSIBILITIES TO BE CONFIRMED WITH STARBUCKS CONSTRUCTION MANAGER PRIOR TO ORDERING / CONSTRUCTION.



STARBUCKS®
2401 UTAH AVENUE SOUTH
SEATTLE, WASHINGTON 98134
(206) 318-1575

THESE DRAWINGS AND THE PROJECT MANUAL ARE CONFIDENTIAL AND SHALL REMAIN THE SOLE PROPERTY OF STARBUCKS CORPORATION, WHICH IS THE OWNER OF THE COPYRIGHT IN THIS WORK. THEY SHALL NOT BE REPRODUCED IN WHOLE OR IN PART, SHARED WITH THIRD PARTIES OR USED IN ANY MANNER ON OTHER PROJECTS OR EXTENSIONS TO THIS PROJECT WITHOUT THE PRIOR WRITTEN CONSENT OF STARBUCKS CORPORATION. THESE DRAWINGS AND SPECIFICATIONS ARE INTENDED TO EXPRESS INTENT FOR A PROTOTYPICAL STARBUCKS STORE (WHICH IS SUBJECT TO CHANGE AT ANYTIME) AND DO NOT REFLECT ACTUAL SITE CONDITIONS. NEITHER PARTY SHALL HAVE ANY OBLIGATION NOR LIABILITY TO THE OTHER (EXCEPT STATED ABOVE) UNTIL A WRITTEN AGREEMENT IS FULLY EXECUTED BY BOTH PARTIES.

STARBUCKS TEMPLATE VERSION: i2023.10.23

Design Forum Architects Inc.

2050 Byers Rd
Miamisburg, OH 45342
Tel: (844) 804-7700

Donald J. Reihman
Architect In Charge
License: AR0017303



2230 PARK AVE, STE. 100, CINCINNATI, OH 45206
513.457.7131 - WWW.MARQUEENG.COM

FOR CONSTRUCTION

PROJECT NAME:
S SEMORAN BLVD & LEE VISTA BLVD

PROJECT ADDRESS:
**6605 S SEMORAN BLVD
ORLANDO, FL 32822**

STORE #: 9875
PROJECT #: 25630-101
ISSUE DATE: 03/04/2024
DESIGN MANAGER: MARTIN PEREZ
PRODUCTION DESIGNER: ANDY MCLOUD
CHECKED BY: DONALD REITHMAN

Revision Schedule			
Rev	Date	By	Description

SHEET TITLE:
ADAPTABLE CASEWORK CABINET PLAN
SCALE: 1/2" = 1'-0"

SHEET NUMBER:
I-102.3


ADAPTABLE CASEWORK CABINET SCHEDULE - "C"					
DESIGN ID	COUNT	DESCRIPTION	FURN. BY	INST. BY	COMMENTS
CABINET					
19281	2	CABINET - ESPRESSO ICE BIN STAINLESS - 20IN 510MM	SB	GC	
21890	27	CABINET - SIDE PANEL	SB	GC	
21891	9	CABINET - BOTTOM SHELF - 15IN 380MM	SB	GC	
21892	7	CABINET - BACK PANEL - 15IN 380MM	SB	GC	
21893	4	CABINET - ADJUSTABLE SHELF - 15IN 380MM	SB	GC	
21894	4	CABINET - DOOR - 15IN 380MM	SB	GC	FINISH: CP0024
21895	5	CABINET - DOOR TRASH - 15IN 380MM	SB	GC	FINISH: CP0024
21896	2	CABINET - DRAWER - 15IN 380MM	SB	GC	FINISH: CP0024
21898	1	CABINET - BOTTOM SHELF - 18IN 455MM	SB	GC	
21899	1	CABINET - BACK PANEL - 18IN 455MM	SB	GC	
21901	1	CABINET - DOOR - 18IN 455MM	SB	GC	FINISH: CP0024
21902	4	CABINET - BOTTOM SHELF - 30IN 760MM	SB	GC	
21903	1	CABINET - BACK PANEL - 30IN 760MM	SB	GC	
21904	7	CABINET - ADJUSTABLE SHELF - 30IN 760MM	SB	GC	
21905	1	CABINET - DOOR - 30IN 760MM	SB	GC	
21906	1	CABINET - END CAP FRONTBAR	SB	GC	FINISH: CP0024
21907	3	CABINET - END CAP BACKBAR	SB	GC	FINISH: CP0024
21908	1	CABINET - FILLER PANEL - VARIABLE LENGTH	SB	GC	FINISH: CP0024; LENGTH REQUIRED: (V.I.F) (1) 0' - 3 3/4"
21909	1	CABINET - DT POS UPPER CUBBY - 32IN 815MM	SB	GC	FINISH: PLX001
21910	1	CABINET - FRENCH CLEAT - VARIABLE LENGTH	SB	GC	LENGTH REQUIRED, (V.I.F) (1) 2' - 6 1/2"
21912	3	CABINET - BACK PANEL FOR POS - 30IN 760MM	SB	GC	
21913	2	CABINET - EQUIPMENT MOUNTING PANEL	SB	GC	
22749	1	CABINET - ESPRESSO PUMP MOUNT PANEL	SB	GC	
22986	2	CABINET - DELIVERY DRAWER - 15IN 380MM	SB	GC	
23425	2	CABINET - WRM DOOR LOWERED COUNTER - 15IN 380MM	SB	GC	
CABINETS					
23711	1	CABINET - CBE UPPER CASEWORK IN-LINE - RF - 82IN	SB	GC	FINISH: PLX001
CAFE					
20352	1	FREESTANDING INLINE 2 UNIT SHORT - 72IN 1830MM - WALNUT WD0077	SB	GC	
23963	1	WASTE AND RECYCLE STATION THREE DROP - WARM BROWN WOODGRAIN AND WHITE PL0030 CP0002	SB	GC	
OTHER					
10829	8	CORNER GUARD - .75IN 19MM	SB	GC	LOCATED @ BOH; PROVIDED BY CASEWORK VENDOR
11155	2	ESPRESSO MACHINE PUMP MOUNT - 10X10IN 255X255MM	SB	GC	
21914	8	FRIDGE STOP BRACKET SET	SB	GC	
X5013	1	CUSTOM METAL ANGLE TRIM AT SOFFIT	SB	GC	FINISH: MT0028; SEE DETAIL: 7/A-503; PROVIDED BY CASEWORK VENDOR
X5014	1	CUSTOM CORIAN SILL TOP	SB	GC	FINISH: CP0056; SEE DETAIL: 4/I-511; PROVIDED BY CASEWORK VENDOR
X5019	1	CUSTOM METAL TRIM AT DT HEADER	SB	GC	FINISH: MT0028; SEE DETAIL: 2/I-107; PROVIDED BY CASEWORK VENDOR
X5020	1	FRY REGLET "Y" TRIM AT WOOD CLADDING EDGE	SB	GC	FINISH: BLACK; SEE DETAIL: 19/I-502; LOCATED @ CAFE; PROVIDED BY CASEWORK VENDOR 1/4" POST OUTSIDE CORNER TRIM; MODEL: 1/2" - MWPOSC2550, FINISH: STANDARD POWDER COAT - BLACK. GC TO VERIFY LENGTHS
X5021	1	CUSTOM METAL TRIM AT BACKBAR	SB	GC	FINISH: MT0028; SEE DETAIL: 15/I-502; PROVIDED BY CASEWORK VENDOR
X5022	1	CUSTOM METAL TRIM AT WORKROOM	SB	GC	FINISH: MT0028; SEE DETAIL: 5/A-502; PROVIDED BY CASEWORK VENDOR
X5023	1	CUSTOM WOOD TRIM FRAME AT RR VESTIBULE	SB	GC	FINISH: WD0077; SEE DETAIL: 6/A-502; PROVIDED BY CASEWORK VENDOR
X5024	1	CUSTOM WOOD CAP AT SOFFIT	SB	GC	FINISH: WD0077; SEE DETAIL: 2/A-503; PROVIDED BY CASEWORK VENDOR
X5025	1	CUSTOM OSB WOOD FRAME	SB	GC	FINISH: WD0077; SEE DETAIL: 1/I-513; PROVIDED BY CASEWORK VENDOR
X5026	1	CUSTOM WOOD CAP	SB	GC	FINISH: WD0077; SEE DETAIL: 3/I-107; PROVIDED BY CASEWORK VENDOR
X5027	4	CUSTOM 1IN X 1IN WOOD SLAT - 82IN HEIGHT	SB	GC	FINISH: WD0077; SEE DETAIL: 1/I-515; PROVIDED BY CASEWORK VENDOR
X5028	16	CUSTOM 1IN X 1IN WOOD SLAT - 9IN HEIGHT	SB	GC	FINISH: WD0077; SEE DETAIL: 1/I-515; PROVIDED BY CASEWORK VENDOR
X5029	16	CUSTOM 1IN X 1IN WOOD SLAT - 22IN HEIGHT	SB	GC	FINISH: WD0077; SEE DETAIL: 1/I-515; PROVIDED BY CASEWORK VENDOR
X5030	8	CUSTOM 1IN X 1IN WOOD SLAT - 110IN HEIGHT	SB	GC	FINISH: WD0077; SEE DETAIL: 1/I-515; PROVIDED BY CASEWORK VENDOR
X5032	3	CUSTOM WOOD TRIM FRAME AT STOREFRONT	SB	GC	FINISH: WD0077; SEE DETAIL: 1/I-514; PROVIDED BY CASEWORK VENDOR
X5033	1	CUSTOM WOOD TRIM FRAME AT STOREFRONT ENTRY	SB	GC	FINISH: WD0077; SEE DETAIL: 1/I-514; PROVIDED BY CASEWORK VENDOR
X5038	1	CUSTOM METAL TRIM AT BACKBAR	SB	GC	FINISH: MT0028; SEE DETAIL: 10/I-502; PROVIDED BY CASEWORK VENDOR
PANEL					
21833	5	FINISH PANEL - VARIABLE LENGTH	SB	GC	FINISH: WD0077 (MAD303-V)

RESPONSIBILITY LEGEND

FURN. BY	INST. BY
GC - FURNISHED BY GENERAL CONTRACTOR	GC - INSTALLED BY GENERAL CONTRACTOR
SB - FURNISHED BY STARBUCKS	SB - INSTALLED BY STARBUCKS
VD - FURNISHED BY VENDOR	VD - INSTALLED BY VENDOR

NOTE:
ALL RESPONSIBILITIES TO BE CONFIRMED WITH STARBUCKS CONSTRUCTION MANAGER PRIOR TO ORDERING / CONSTRUCTION.

FOR CONSTRUCTION



© 2023 STARBUCKS COFFEE COMPANY

STARBUCKS®
2401 UTAH AVENUE SOUTH
SEATTLE, WASHINGTON 98134
(206) 318-1575


THESE DRAWINGS AND THE PROJECT MANUAL ARE CONFIDENTIAL AND SHALL REMAIN THE SOLE PROPERTY OF STARBUCKS CORPORATION, WHICH IS THE OWNER OF THE COPYRIGHT IN THIS WORK. THEY SHALL NOT BE REPRODUCED IN WHOLE OR IN PART, SHARED WITH THIRD PARTIES OR USED IN ANY MANNER ON OTHER PROJECTS OR EXTENSIONS TO THIS PROJECT WITHOUT THE PRIOR WRITTEN CONSENT OF STARBUCKS CORPORATION. THESE DRAWINGS AND SPECIFICATIONS ARE INTENDED TO EXPRESS DESIGN INTENT FOR A PROTOTYPICAL STARBUCKS STORE (WHICH IS SUBJECT TO CHANGE AT ANYTIME) AND DO NOT REFLECT ACTUAL SITE CONDITIONS. NEITHER PARTY SHALL HAVE ANY OBLIGATION NOR LIABILITY TO THE OTHER (EXCEPT STATED ABOVE) UNTIL A WRITTEN AGREEMENT IS FULLY EXECUTED BY BOTH PARTIES.

STARBUCKS TEMPLATE VERSION: i2023.10.23

Design Forum Architects Inc.

2050 Byers Rd
Miamisburg, OH 45342
Tel: (844) 804-7700

Donald J. Reihman
Architect In Charge
License: AR0017303

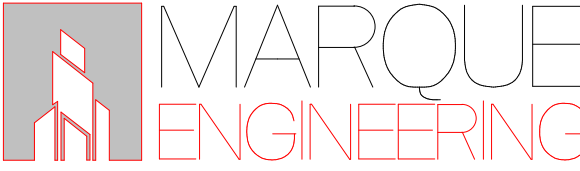

2230 PARK AVE, STE. 100, CINCINNATI, OH 45206
513.457.7131 - WWW.MARQUEENG.COM

PROJECT NAME:
S SEMORAN BLVD & LEE VISTA BLVD

PROJECT ADDRESS:
**6605 S SEMORAN BLVD
ORLANDO, FL 32822**

STORE #: 9875
PROJECT #: 25630-101
ISSUE DATE: 03/04/2024
DESIGN MANAGER: MARTIN PEREZ
PRODUCTION DESIGNER: ANDY MCLOUD
CHECKED BY: DONALD RETHMAN

Revision Schedule			
Rev	Date	By	Description

SHEET TITLE:
ADAPTABLE CASEWORK CABINET SCHEDULE
SCALE: NO SCALE

SHEET NUMBER:
I-102.3.1

\\file-day.ad.changeupinc.com\Client\StarbucksArchitecture\Projects_2023\Florida\Semorran & Lee Vista - 25630-101\25630-101_9875_S Semoran Blvd & Lee Vista Blvd, FL_2023.rvt 3/4/2024 2:39:39 PM

ADAPTABLE CASEWORK COUNTERTOP SCHEDULE - "C"					
DESIGN ID	COUNT	DESCRIPTION	FURN. BY	INST. BY	COMMENTS
COUNTERTOP					
21928	1	COUNTERTOP - END CAP BACKBAR	SB	GC	FINISH: CP0056
22354	1	COUNTERTOP - ESPRESSO SHROUD - 141IN 3580MM	SB	GC	FINISH: CP0056
22395	1	COUNTERTOP - HAND SINK LOW SPLASH - 15IN 380MM	SB	GC	
X5001	1	CUSTOM COUNTERTOP - END CAP FRONTBAR	SB	GC	FINISH: CP0056; SEE DETAIL: 2/I-509; SIM. DID# 21923; CUSTOM DUE TO 4" FRONT EDGE
X5002	1	CUSTOM COUNTERTOP - POS - 84IN 2135MM	SB	GC	FINISH: CP0056; SEE DETAIL: 2/I-509; SIM. DID# 22361; CUSTOM DUE TO 4" FRONT EDGE
X5003	1	CUSTOM COUNTERTOP - ESPRESSO FRONTBAR - LF - 141IN 3580MM	SB	GC	FINISH: CP0056; SEE DETAIL: 2/I-509; SIM. DID# 22352; CUSTOM DUE TO 4" FRONT EDGE
X5004	2	CUSTOM COUNTERTOP - FILLER FRONTBAR - VARIABLE LENGTH	SB	GC	FINISH: CP0056; SEE DETAIL: 2/I-509; SIM. DID# 21918; CUSTOM DUE TO 4" FRONT EDGE; LENGTH REQUIRED: (V.I.F) (1) 1' - 0 1/2" (1) 0' - 11 1/2"
X5005	1	CUSTOM COUNTERTOP - FRONTBAR - 15IN 380MM	SB	GC	FINISH: CP0056; SEE DETAIL: 2/I-509; SIM. DID# 21920; CUSTOM DUE TO 4" FRONT EDGE
X5006	1	CUSTOM COUNTERTOP - FRONTBAR - 30IN 760MM	SB	GC	FINISH: CP0056; SEE DETAIL: 2/I-509; SIM. DID# 21922; CUSTOM DUE TO 4" FRONT EDGE
X5010	1	CUSTOM COUNTERTOP - END CAP BACKBAR	SB	GC	FINISH: CP0056; SIM. DID# 21928; CUSTOM DUE TO 8IN INTEGRAL BACKSPLASH
X5011	1	COUNTERTOP - BREW - LF - 90IN 2285MM	SB	GC	FINISH: CP0056; SIM. DID# 22328; CUSTOM DUE TO 8IN INTEGRAL BACKSPLASH
X5012	1	CUSTOM COUNTERTOP - 2IN TALL BACKSPLASH - VARIABLE LENGTH	SB	GC	FINISH: CP0056; SEE DETAIL: 4/I-510; LENGTH REQUIRED: (V.I.F) (1) 2' - 6 1/2"
X5016	1	CUSTOM COUNTERTOP - WARMING WITH RACK - RF - 110IN 2795MM	SB	GC	FINISH: CP0056; SIM. DID # 22385; CUSTOM DUE TO 8IN INTEGRAL BACKSPLASH

ADAPTABLE CASEWORK COUNTERTOP SCHEDULE - "C"					
DESIGN ID	COUNT	DESCRIPTION	FURN. BY	INST. BY	COMMENTS
X5017	1	CUSTOM COUNTERTOP - WRM RF - 78IN 1980MM	SB	GC	FINISH: CP0056; SIM. DID #23430; CUSTOM DUE TO 8IN INTEGRAL BACKSPLASH
X5018	3	CUSTOM COUNTERTOP - 8IN TALL BACKSPLASH - VARIABLE LENGTH	SB	GC	FINISH: CP0056; SEE DETAIL: 10/I-510; LENGTH REQUIRED: (V.I.F) (3) 2' - 6 1/2"
X5034	4	CUSTOM COUNTERTOP - FILLER BACKBAR - VARIABLE LENGTH	SB	GC	FINISH: CP0056; SIM. DID # 21919; CUSTOM DUE TO 8IN INTEGRAL BACKSPLASH; LENGTH REQUIRED: (V.I.F) (3) 0' - 3/4" (1) 0' - 1 1/4"
X5035	1	CUSTOM COUNTERTOP - DT POS - LF - 67IN 1700MM	SB	GC	FINISH: CP0056; SEE DETAIL: 6/I-511; W/ 8IN INTEGRAL BACKSPLASH; SEE DETAIL: 6/I-511
X5036	1	CUSTOM COUNTERTOP - CBE IN-LINE RF - 139IN 3530MM	SB	GC	FINISH: CP0056; SIM. DID# 23403; CUSTOM DUE TO 8IN INTEGRAL BACKSPLASH

GENERAL NOTES

- A. SEE SHEET I-103 FOR COMPLETE CASEWORK SCHEDULE.
- B. G.C.'S INSTALLER SHALL VERIFY COUNTER CHANNEL REQUIREMENTS PRIOR TO CUTTING IN FIELD.
- C. G.C./INSTALLER TO VERIFY COUNTERTOP SUPPORT CHANNEL MEASUREMENTS PRIOR TO CUTTING. FIELD CUT AT SINKS AND ICE BINS.
- D. "C" CHANNEL MOUNTS OVER FRONT AND REAR INDEX BRACKETS WHICH ARE INSERTED INTO FRAMEWORK.
- E. SILICONE SEAM AT TRANSITION FROM COUNTERTOP TO HAND SINKS.
- F. SILICONE AND SEAL ALL SEAMS BETWEEN SINKS, EQUIPMENT AND COUNTERTOPS.
- G. ONCE COUNTERTOP IS SET, LEVELED AND SEALED, SECURE CHANNEL TO UNDERSIDE OF SUBSTRATE.

KEYED NOTES

1. CASEWORK FRAME BELOW.
2. LOCATE WATER TROUGH AT EDGE OF COUNTERTOP AS SHOWN.
3. RAISED EDGE GROMMETS.
4. CUT OUT FOR RECESSED SINK, ICE BIN OR TRASH DROP. SEE EQUIPMENT AND/OR MANUFACTURER'S CUTSHEETS FOR DIMENSIONS.
5. NEW FOOD CASE.
6. CUT OUT FOR NITRO.
7. CORIAN SHROUD AT ESPRESSO BAR.
8. WARMING WALL.


LEGEND

- INDICATES STAINLESS STEEL (SST) COUNTERTOP
- INDICATES SOLID SURFACE (SS) COUNTERTOP
- DATUM POINT

RESPONSIBILITY LEGEND

FURN. BY	INST. BY
GC - FURNISHED BY GENERAL CONTRACTOR	GC - INSTALLED BY GENERAL CONTRACTOR
SB - FURNISHED BY STARBUCKS	SB - INSTALLED BY STARBUCKS
VD - FURNISHED BY VENDOR	VD - INSTALLED BY VENDOR

NOTE:
ALL RESPONSIBILITIES TO BE CONFIRMED WITH STARBUCKS CONSTRUCTION MANAGER PRIOR TO ORDERING / CONSTRUCTION.

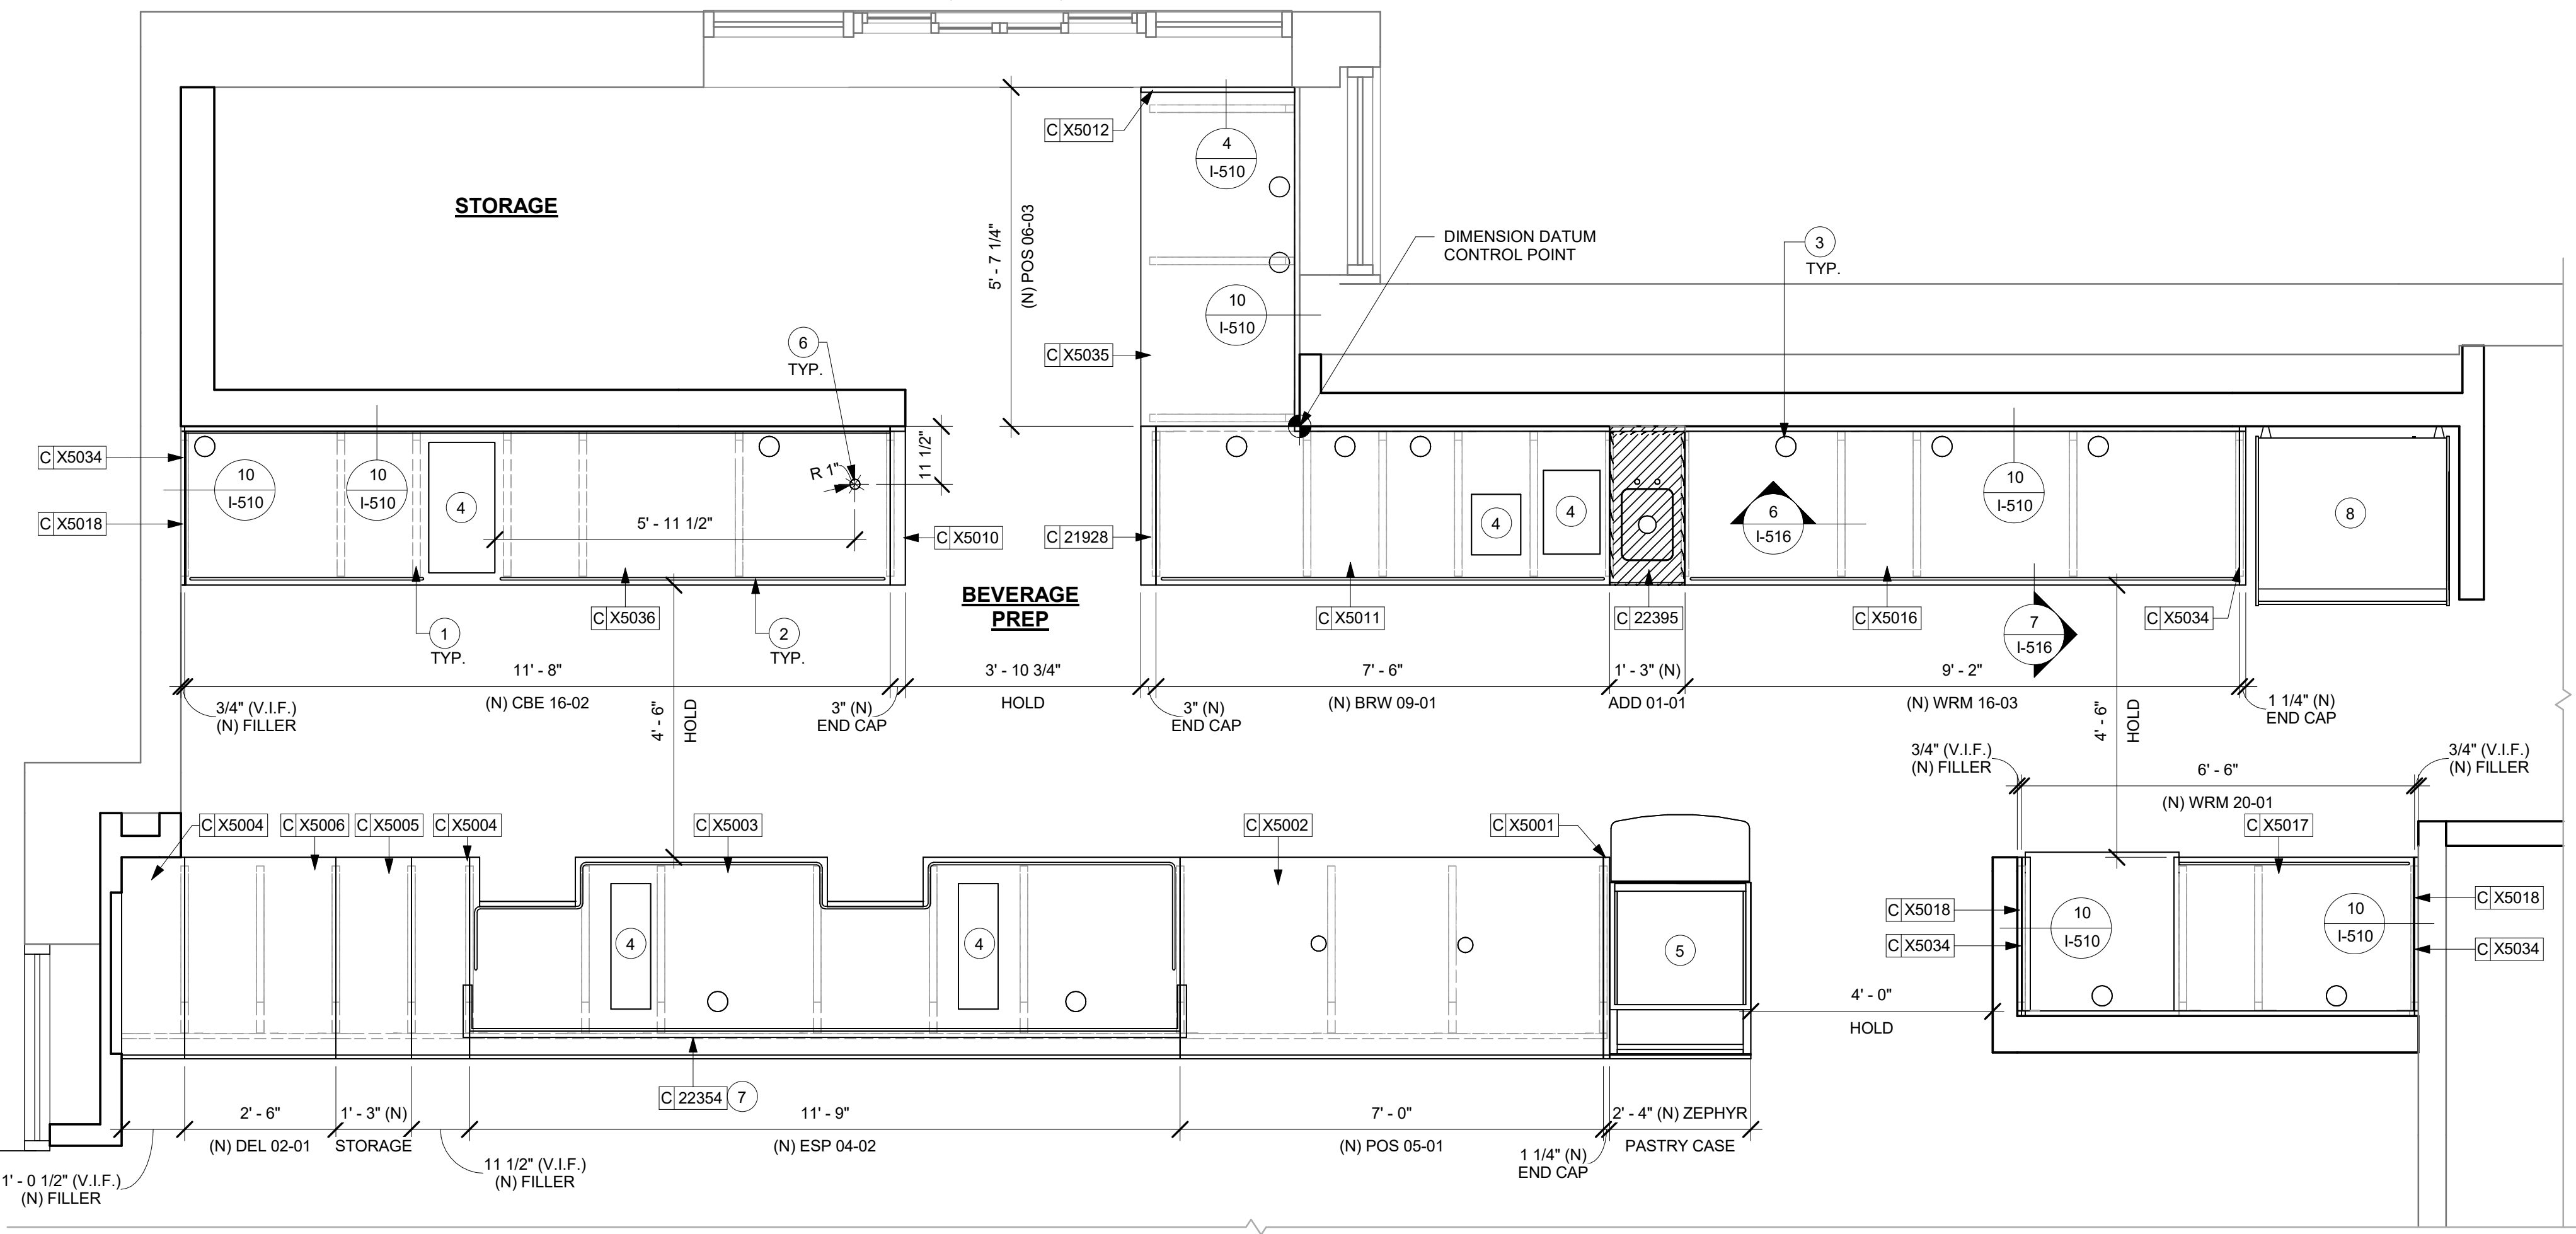

1 ADAPTABLE CASEWORK COUNTERTOP PLAN

Scale: 1/2" = 1'-0"

0 1' 2' 4'
Scale: 1/2" = 1'-0"

FOR CONSTRUCTION



© 2023 STARBUCKS COFFEE COMPANY

STARBUCKS®
2401 UTAH AVENUE SOUTH
SEATTLE, WASHINGTON 98134
(206) 318-1575

THESE DRAWINGS AND THE PROJECT MANUAL ARE CONFIDENTIAL AND SHALL REMAIN THE SOLE PROPERTY OF STARBUCKS CORPORATION, WHICH IS THE OWNER OF THE COPYRIGHT IN THIS WORK. THEY SHALL NOT BE REPRODUCED IN WHOLE OR IN PART, SHARED WITH THIRD PARTIES OR USED IN ANY MANNER ON OTHER PROJECTS OR EXTENSIONS TO THIS PROJECT WITHOUT THE PRIOR WRITTEN CONSENT OF STARBUCKS CORPORATION. THESE DRAWINGS AND SPECIFICATIONS ARE INTENDED TO EXPRESS THE INTENT FOR A PROTOTYPICAL STARBUCKS STORE (WHICH IS SUBJECT TO CHANGE AT ANYTIME) AND DO NOT REFLECT ACTUAL SITE CONDITIONS. NEITHER PARTY SHALL HAVE ANY OBLIGATION NOR LIABILITY TO THE OTHER (EXCEPT STATED ABOVE) UNTIL A WRITTEN AGREEMENT IS FULLY EXECUTED BY BOTH PARTIES.

STARBUCKS TEMPLATE VERSION: i2023.10.23

Design Forum Architects Inc.

2050 Byers Rd
Miami, FL 33134
Tel: (844) 804-7700

Donald J. Reihman
Architect in Charge
License: AR0017303



2230 PARK AVE, STE. 100, CINCINNATI, OH 45206
513.457.7131 - WWW.MARQUEENG.COM

PROJECT NAME:
S SEMORAN BLVD & LEE VISTA BLVD

PROJECT ADDRESS:
**6605 S SEMORAN BLVD
ORLANDO, FL 32822**

STORE #: 9875
PROJECT #: 25630-101
ISSUE DATE: 03/04/2024
DESIGN MANAGER: MARTIN PEREZ
PRODUCTION DESIGNER: ANDY MCLOUD
CHECKED BY: DONALD RETHMAN

Revision Schedule			
Rev	Date	By	Description

SHEET TITLE:
ADAPTABLE CASEWORK COUNTERTOP PLAN
SCALE: 1/2" = 1'-0"

SHEET NUMBER:
I-102.4

CASEWORK SCHEDULE - "C"					
DESIGN ID	COUNT	DESCRIPTION	FURN. BY	INST. BY	COMMENTS
CABINET					
19281	2	CABINET - ESPRESSO ICE BIN STAINLESS - 20IN 510MM	SB	GC	
21890	27	CABINET - SIDE PANEL	SB	GC	
21891	9	CABINET - BOTTOM SHELF - 15IN 380MM	SB	GC	
21892	7	CABINET - BACK PANEL - 15IN 380MM	SB	GC	
21893	4	CABINET - ADJUSTABLE SHELF - 15IN 380MM	SB	GC	
21894	4	CABINET - DOOR - 15IN 380MM	SB	GC	FINISH: CP0024
21895	5	CABINET - DOOR TRASH - 15IN 380MM	SB	GC	FINISH: CP0024
21896	2	CABINET - DRAWER - 15IN 380MM	SB	GC	FINISH: CP0024
21898	1	CABINET - BOTTOM SHELF - 18IN 455MM	SB	GC	
21899	1	CABINET - BACK PANEL - 18IN 455MM	SB	GC	
21901	1	CABINET - DOOR - 18IN 455MM	SB	GC	FINISH: CP0024
21902	4	CABINET - BOTTOM SHELF - 30IN 760MM	SB	GC	
21903	1	CABINET - BACK PANEL - 30IN 760MM	SB	GC	
21904	7	CABINET - ADJUSTABLE SHELF - 30IN 760MM	SB	GC	
21905	1	CABINET - DOOR - 30IN 760MM	SB	GC	
21906	1	CABINET - END CAP FRONTBAR	SB	GC	FINISH: CP0024
21907	3	CABINET - END CAP BACKBAR	SB	GC	FINISH: CP0024
21908	1	CABINET - FILLER PANEL - VARIABLE LENGTH	SB	GC	FINISH: CP0024; LENGTH REQUIRED: (V.I.F) (1) 0' - 3 3/4"
21909	1	CABINET - DT POS UPPER CUBBY - 32IN 815MM	SB	GC	FINISH: PLX001
21910	1	CABINET - FRENCH CLEAT - VARIABLE LENGTH	SB	GC	LENGTH REQUIRED, (V.I.F) (1) 2' - 6 1/2"
21912	3	CABINET - BACK PANEL FOR POS - 30IN 760MM	SB	GC	
21913	2	CABINET - EQUIPMENT MOUNTING PANEL	SB	GC	
22749	1	CABINET - ESPRESSO PUMP MOUNT PANEL	SB	GC	
22986	2	CABINET - DELIVERY DRAWER - 15IN 380MM	SB	GC	
23425	2	CABINET - WRM DOOR LOWERED COUNTER - 15IN 380MM	SB	GC	
CABINETS					
23711	1	CABINET - CBE UPPER CASEWORK IN-LINE - RF - 82IN	SB	GC	FINISH: PLX001
CAFE					
20352	1	FREESTANDING INLINE 2 UNIT SHORT - 72IN 1830MM - WALNUT WD0077	SB	GC	
23963	1	WASTE AND RECYCLE STATION THREE DROP - WARM BROWN WOODGRAIN AND WHITE PL0030 CP0002	SB	GC	
COUNTERTOP					
21928	1	COUNTERTOP - END CAP BACKBAR	SB	GC	FINISH: CP0056
22354	1	COUNTERTOP - ESPRESSO SHROUD - 141IN 3580MM	SB	GC	FINISH: CP0056
22395	1	COUNTERTOP - HAND SINK LOW SPLASH - 15IN 380MM	SB	GC	
X5001	1	CUSTOM COUNTERTOP - END CAP FRONTBAR	SB	GC	FINISH: CP0056; SEE DETAIL: 2/I-509; SIM. DID# 21923; CUSTOM DUE TO 4" FRONT EDGE
X5002	1	CUSTOM COUNTERTOP - POS - 84IN 2135MM	SB	GC	FINISH: CP0056; SEE DETAIL: 2/I-509; SIM. DID# 22361; CUSTOM DUE TO 4" FRONT EDGE
X5003	1	CUSTOM COUNTERTOP - ESPRESSO FRONTBAR - LF - 141IN 3580MM	SB	GC	FINISH: CP0056; SEE DETAIL: 2/I-509; SIM. DID# 22352; CUSTOM DUE TO 4" FRONT EDGE
X5004	2	CUSTOM COUNTERTOP - FILLER FRONTBAR - VARIABLE LENGTH	SB	GC	FINISH: CP0056; SEE DETAIL: 2/I-509; SIM. DID# 21918; CUSTOM DUE TO 4" FRONT EDGE; LENGTH REQUIRED: (V.I.F) (1) 1' - 0 1/2" (1) 0' - 11 1/2"
X5005	1	CUSTOM COUNTERTOP - FRONTBAR - 15IN 380MM	SB	GC	FINISH: CP0056; SEE DETAIL: 2/I-509; SIM. DID# 21920; CUSTOM DUE TO 4" FRONT EDGE
X5006	1	CUSTOM COUNTERTOP - FRONTBAR - 30IN 760MM	SB	GC	FINISH: CP0056; SEE DETAIL: 2/I-509; SIM. DID# 21922; CUSTOM DUE TO 4" FRONT EDGE
X5010	1	CUSTOM COUNTERTOP - END CAP BACKBAR	SB	GC	FINISH: CP0056; SIM. DID# 21928; CUSTOM DUE TO 8IN INTEGRAL BACKSPLASH
X5011	1	COUNTERTOP - BREW - LF - 90IN 2285MM	SB	GC	FINISH: CP0056; SIM. DID# 22328; CUSTOM DUE TO 8IN INTEGRAL BACKSPLASH
X5012	1	CUSTOM COUNTERTOP - 2IN TALL BACKSPLASH - VARIABLE LENGTH	SB	GC	FINISH: CP0056; SEE DETAIL: 4/I-510; LENGTH REQUIRED: (V.I.F) (1) 2' - 6 1/2"
X5016	1	CUSTOM COUNTERTOP - WARMING WITH RACK - RF - 110IN 2795MM	SB	GC	FINISH: CP0056; SIM. DID # 22385; CUSTOM DUE TO 8IN INTEGRAL BACKSPLASH
X5017	1	CUSTOM COUNTERTOP - WRM RF - 78IN 1980MM	SB	GC	FINISH: CP0056; SIM. DID #23430; CUSTOM DUE TO 8IN INTEGRAL BACKSPLASH
X5018	3	CUSTOM COUNTERTOP - 8IN TALL BACKSPLASH - VARIABLE LENGTH	SB	GC	FINISH: CP0056; SEE DETAIL: 10/I-510; LENGTH REQUIRED: (V.I.F) (3) 2' - 6 1/2"
X5034	4	CUSTOM COUNTERTOP - FILLER BACKBAR - VARIABLE LENGTH	SB	GC	FINISH: CP0056; SIM. DID # 21919; CUSTOM DUE TO 8IN INTEGRAL BACKSPLASH; LENGTH REQUIRED: (V.I.F) (3) 0' - 3/4" (1) 0' - 1 1/4"
X5035	1	CUSTOM COUNTERTOP - DT POS - LF - 67IN 1700MM	SB	GC	FINISH: CP0056; SEE DETAIL: 6/I-511; W/ 8IN INTEGRAL BACKSPLASH; SEE DETAIL: 6/I-511
X5036	1	CUSTOM COUNTERTOP - CBE IN-LINE RF - 139IN 3530MM	SB	GC	FINISH: CP0056; SIM. DID# 23403; CUSTOM DUE TO 8IN INTEGRAL BACKSPLASH
DIEWALL					
21885	11	DIEWALL - FRAMING - VARIABLE LENGTH	SB	GC	
21886	5	DIEWALL - BASE - VARIABLE LENGTH	SB	GC	
21887	5	DIEWALL - SUBSTRATE PANEL - VARIABLE LENGTH	SB	GC	
21888	40	DIEWALL - SUPPORT LEG	SB	GC	
23439	1	DIEWALL - WRM STRUCTURE LOWERED COUNTER	SB	GC	
OTHER					
10829	8	CORNER GUARD - .75IN 19MM	SB	GC	LOCATED @ BOH; PROVIDED BY CASEWORK VENDOR
11155	2	ESPRESSO MACHINE PUMP MOUNT - 10X10IN 255X255MM	SB	GC	
21914	8	FRIDGE STOP BRACKET SET	SB	GC	
X5013	1	CUSTOM METAL ANGLE TRIM AT SOFFIT	SB	GC	FINISH: MT0028; SEE DETAIL: 7/A-503; PROVIDED BY CASEWORK VENDOR
X5014	1	CUSTOM CORIAN SILL TOP	SB	GC	FINISH: CP0056; SEE DETAIL: 4/I-511; PROVIDED BY CASEWORK VENDOR
X5019	1	CUSTOM METAL TRIM AT DT HEADER	SB	GC	FINISH: MT0028; SEE DETAIL: 2/I-107; PROVIDED BY CASEWORK VENDOR

CASEWORK SCHEDULE - "C"					
DESIGN ID	COUNT	DESCRIPTION	FURN. BY	INST. BY	COMMENTS
X5020	1	FRY REGLET "Y" TRIM AT WOOD CLADDING EDGE	SB	GC	FINISH: BLACK; SEE DETAIL: 19/I-502; LOCATED @ CAFE; PROVIDED BY CASEWORK VENDOR
X5021	1	CUSTOM METAL TRIM AT BACKBAR	SB	GC	FINISH: MT0028; SEE DETAIL: 15/I-502; PROVIDED BY CASEWORK VENDOR
X5022	1	CUSTOM METAL TRIM AT WORKROOM	SB	GC	FINISH: MT0028; SEE DETAIL: 5/A-502; PROVIDED BY CASEWORK VENDOR
X5023	1	CUSTOM WOOD TRIM FRAME AT RR VESTIBULE	SB	GC	FINISH: WD0077; SEE DETAIL: 6/A-502; PROVIDED BY CASEWORK VENDOR
X5024	1	CUSTOM WOOD CAP AT SOFFIT	SB	GC	FINISH: WD0077; SEE DETAIL: 2/A-503; PROVIDED BY CASEWORK VENDOR
X5025	1	CUSTOM OSB WOOD FRAME	SB	GC	FINISH: WD0077; SEE DETAIL: 1/I-513; PROVIDED BY CASEWORK VENDOR
X5026	1	CUSTOM WOOD CAP	SB	GC	FINISH: WD0077; SEE DETAIL: 3/I-107; PROVIDED BY CASEWORK VENDOR
X5027	4	CUSTOM 1IN X 1IN WOOD SLAT - 82IN HEIGHT	SB	GC	FINISH: WD0077; SEE DETAIL: 1/I-515; PROVIDED BY CASEWORK VENDOR
X5028	16	CUSTOM 1IN X 1IN WOOD SLAT - 9IN HEIGHT	SB	GC	FINISH: WD0077; SEE DETAIL: 1/I-515; PROVIDED BY CASEWORK VENDOR
X5029	16	CUSTOM 1IN X 1IN WOOD SLAT - 22IN HEIGHT	SB	GC	FINISH: WD0077; SEE DETAIL: 1/I-515; PROVIDED BY CASEWORK VENDOR
X5030	8	CUSTOM 1IN X 1IN WOOD SLAT - 110IN HEIGHT	SB	GC	FINISH: WD0077; SEE DETAIL: 1/I-515; PROVIDED BY CASEWORK VENDOR
X5032	3	CUSTOM WOOD TRIM FRAME AT STOREFRONT	SB	GC	FINISH: WD0077; SEE DETAIL: 1/I-514; PROVIDED BY CASEWORK VENDOR
X5033	1	CUSTOM WOOD TRIM FRAME AT STOREFRONT ENTRY	SB	GC	FINISH: WD0077; SEE DETAIL: 1/I-514; PROVIDED BY CASEWORK VENDOR
X5038	1	CUSTOM METAL TRIM AT BACKBAR	SB	GC	FINISH: MT0028; SEE DETAIL: 10/I-502; PROVIDED BY CASEWORK VENDOR
PANEL					
21933	5	FINISH PANEL - VARIABLE LENGTH	SB	GC	FINISH: WD0077 (MAD303-V)

CW FINISH - NCS			
LOCATION	DESCRIPTION	FINISH CODE	COMMENTS
CABINETS			
DT POS CUBBY	PLASTIC LAMINATE - WILSONART KHAKI BROWN D50	PLX001	
SIREN SYSTEM COLD BEVERAGE	PLASTIC LAMINATE - WILSONART KHAKI BROWN D50	PLX001	
UNDERCOUNTER CABINET BACKBAR	COMPOSITE - BLACK DIAMOND PAPERSTONE	CP0024	
UNDERCOUNTER CABINET FRONTBAR	COMPOSITE - BLACK DIAMOND PAPERSTONE	CP0024	
UNDERCOUNTER CABINET INTERIOR	PLASTIC LAMINATE - BLACK HDPE	PL0044	
CAFE			
WASTE & RECYLING TOP	COMPOSITE - WHITE WITH VEINING	CP0002	
COUNTERTOPS - BACKBAR			
DT POS, BREW AND WARM COUNTERTOPS	COMPOSITE - WEATHERED CONCRETE	CP0056	
END CAP, ADD AND CBE COUNTERTOPS	COMPOSITE - WEATHERED CONCRETE	CP0056	
HAND SINK COUNTERTOP	STAINLESS STEEL - BRUSHED	#4 BRUSHED 16GA SST	
COUNTERTOPS - FRONT BAR			
DEL. STORAGE AND ADD COUNTERTOPS	COMPOSITE - WEATHERED CONCRETE	CP0056	
END CAP, ESPRESSO AND POS COUNTERTOPS	COMPOSITE - WEATHERED CONCRETE	CP0056	
FINISH PANELS			
DEL. STORAGE AND ADD FINISH PANELS	WOOD - WALNUT - FLUTED - VERTICAL	WD0077	MAD303-V
END CAP, ESPRESSO AND POS FINISH PANELS	WOOD - WALNUT - FLUTED - VERTICAL	WD0077	MAD303-V
FINISH PANEL TRIM DETAIL	METAL - FLAT BLACK POWDERCOAT	MT0028	
WASTE & RECYLING CART FINISH PANELS	PLASTIC LAMINATE - WARM BROWN GRAIN	PL0030	
OTHER			
CHAIR RAIL	WOOD - WALNUT	WD0077	
DT WINDOW SILL	COMPOSITE - WEATHERED CONCRETE	CP0056	
METAL TRIM	METAL - FLAT BLACK POWDERCOAT	MT0028	
SHROUD	COMPOSITE - WEATHERED CONCRETE	CP0056	
WOOD CLADDING @ CAFE	WOOD - WALNUT - PLANK - VERTICAL	WD0077	MAD100-V (FULL HEIGHT PLANKS)
WOOD CLADDING @ SOFFIT	WOOD - WALNUT - PLANK - VERTICAL	WD0077	MAD100-V (FULL HEIGHT PLANKS AT ENGINE SOFFIT)
WOOD SLATS @ CAFE	WOOD - WALNUT	WD0077	
WOOD TRIM	WOOD - WALNUT	WD0077	
WOOD TRIM @ STOREFRONT	WOOD - WALNUT	WD0077	

RESPONSIBILITY LEGEND

FURN. BY	INST. BY
GC - FURNISHED BY GENERAL CONTRACTOR	GC - INSTALLED BY GENERAL CONTRACTOR
SB - FURNISHED BY STARBUCKS	SB - INSTALLED BY STARBUCKS
VD - FURNISHED BY VENDOR	VD - INSTALLED BY VENDOR

NOTE:
ALL RESPONSIBILITIES TO BE CONFIRMED WITH STARBUCKS CONSTRUCTION MANAGER PRIOR TO ORDERING / CONSTRUCTION.



STARBUCKS®
2401 UTAH AVENUE SOUTH
SEATTLE, WASHINGTON 98134
(206) 318-1575

THESE DRAWINGS AND THE PROJECT MANUAL ARE CONFIDENTIAL AND SHALL REMAIN THE SOLE PROPERTY OF STARBUCKS CORPORATION, WHICH IS THE OWNER OF THE COPYRIGHT IN THIS WORK. THEY SHALL NOT BE REPRODUCED IN WHOLE OR IN PART, SHARED WITH THIRD PARTIES OR USED IN ANY MANNER ON OTHER PROJECTS OR EXTENSIONS TO THIS PROJECT WITHOUT THE PRIOR WRITTEN CONSENT OF STARBUCKS CORPORATION. THESE DRAWINGS AND SPECIFICATIONS ARE INTENDED TO EXPRESS DESIGN INTENT FOR A PROTOTYPICAL STARBUCKS STORE (WHICH IS SUBJECT TO CHANGE AT ANYTIME) AND DO NOT REFLECT ACTUAL SITE CONDITIONS. NEITHER PARTY SHALL HAVE ANY OBLIGATION NOR LIABILITY TO THE OTHER (EXCEPT STATED ABOVE) UNTIL A WRITTEN AGREEMENT IS FULLY EXECUTED BY BOTH PARTIES.


STARBUCKS TEMPLATE VERSION: i2023.10.23

Design Forum Architects Inc.

2050 Byers Rd
Miami, OH 45342
Tel: (844) 804-7700

Donald J. Rehman
Architect In Charge
License: AR0017303

2230 PARK AVE, STE. 100, CINCINNATI, OH 45206
513.457.7131 - WWW.MARQUEENG.COM

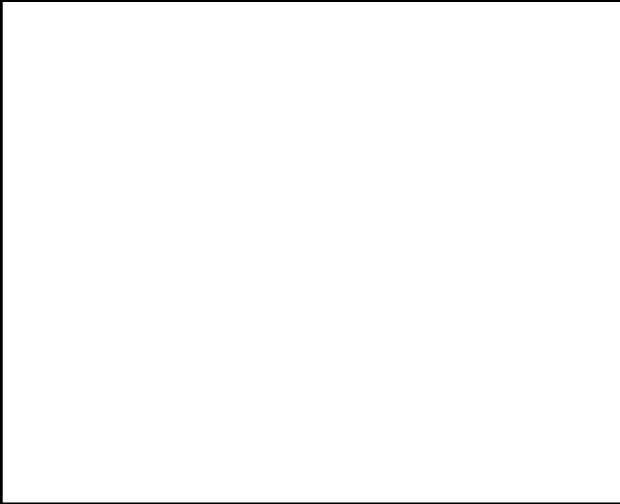

PROJECT NAME:
S SEMORAN BLVD & LEE VISTA BLVD

PROJECT ADDRESS:
**6605 S SEMORAN BLVD
ORLANDO, FL 32822**

STORE #:	9875
PROJECT #:	25630-101
ISSUE DATE:	03/04/2024
DESIGN MANAGER:	MARTIN PEREZ
PRODUCTION DESIGNER:	ANDY MCLOUD
CHECKED BY:	DONALD RETHMAN

Revision Schedule			
Rev	Date	By	Description

SHEET TITLE:
CASEWORK SCHEDULES

SCALE: NO SCALE

SHEET NUMBER:
I-103

FOR CONSTRUCTION


DESIGN ID	LENGTH	DESCRIPTION	FURN. BY	INST. BY	COMMENTS
BASE TRIM					
X9100	34' - 5"	FLOOR FRAME 16 GA 2B SS AROUND WALK-OFF MAT RECESSED	SB	GC	SOURCED FROM VD; SEE DETAIL: 1/1-501
X9102	51' - 2 1/2"	SCHLUTER BASE - DILEX - AHK TRIM	GC	GC	SCHLUTER SYSTEM WILL REQUIRE USE OF 90 DEGREE CORNER PIECE TO ACCOMMODATE FOR RADIUS TRIM PROFILE. FINISH: DARK ANTHRACITE - SATIN ANODIZED ALUMINUM
METAL BASE					
X9101	23' - 6 3/4"	METAL BASE - 6IN 150MM - BLACK - MT0028	GC	GC	PROVIDED BY CASEWORK VENDOR
TILE BASE					
18740	54' - 7 3/4"	TILE BASE - PLAZA NOVA - BLACK SHADOW - 6X12IN 150X300MM	SB	GC	GROUT: MAPEI - 10 BLACK, OR EQUAL
19795	234' - 3 1/4"	POLYVINYL TILE BASE SHEET - ECO-GRIP - PEWTER - 6X96IN 150X2438MM	GC	GC	

DESIGN ID	AREA	DESCRIPTION	FURN. BY	INST. BY	COMMENTS
TILE					
1795	807 SF	POLYVINYL FLOOR SHEET - ECO-GRIP - PEWTER - 60X96IN 1524X2438MM	GC	GC	GC TO PROCURE FROM ALLIED INDUSTRIES
20228	669 SF	TILE - 1 COCCI - CEMENTO - 24X24IN 600X600MM	SB	GC	GROUT: MAPEI - 47 CHARCOAL, OR EQUAL
WALK OFF MAT					
19289	39 SF	WALK OFF MAT - HELIX Z2 - BLACK AND GUNMETAL - 12X9IN 305X230MM	SB	GC	CANNOT BE CUT TO SIZE; USE HELIX Z1 AS BORDER WHEN FULL TILES CANNOT BE PLACED

RESPONSIBILITY LEGEND


FURN. BY	INST. BY
GC - FURNISHED BY GENERAL CONTRACTOR	GC - INSTALLED BY GENERAL CONTRACTOR
SB - FURNISHED BY STARBUCKS	SB - INSTALLED BY STARBUCKS
VD - FURNISHED BY VENDOR	VD - INSTALLED BY VENDOR

NOTE:
ALL RESPONSIBILITIES TO BE CONFIRMED WITH
STARBUCKS CONSTRUCTION MANAGER PRIOR TO
ORDERING / CONSTRUCTION.

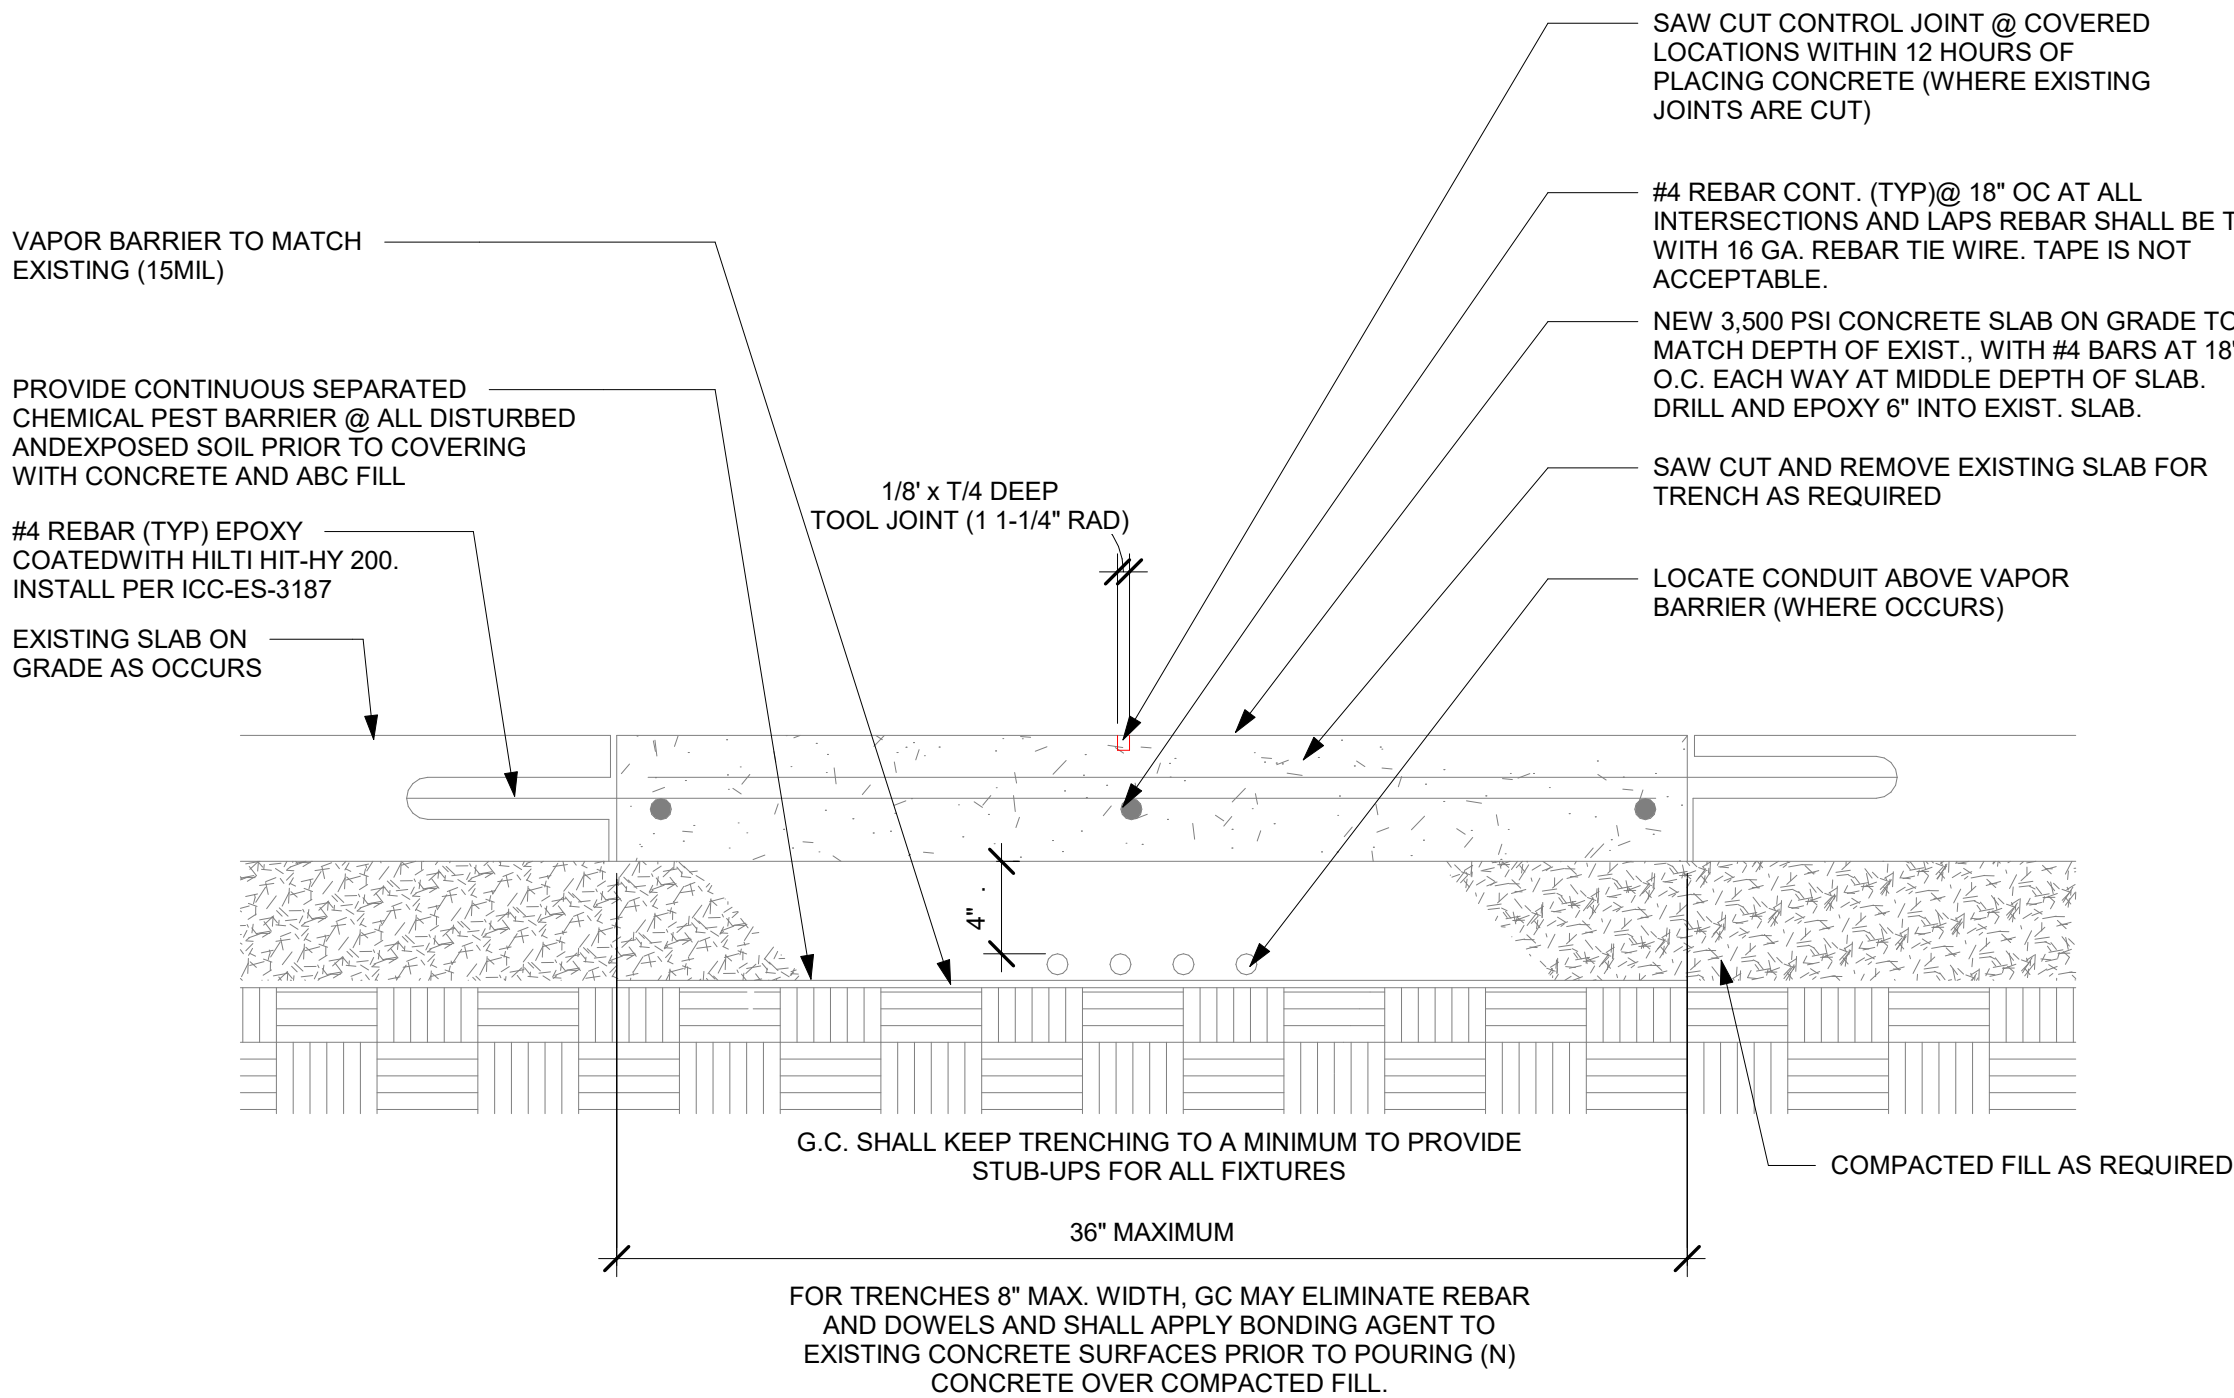


TRENCH DETAIL

Scale: 6" = 1'-0"

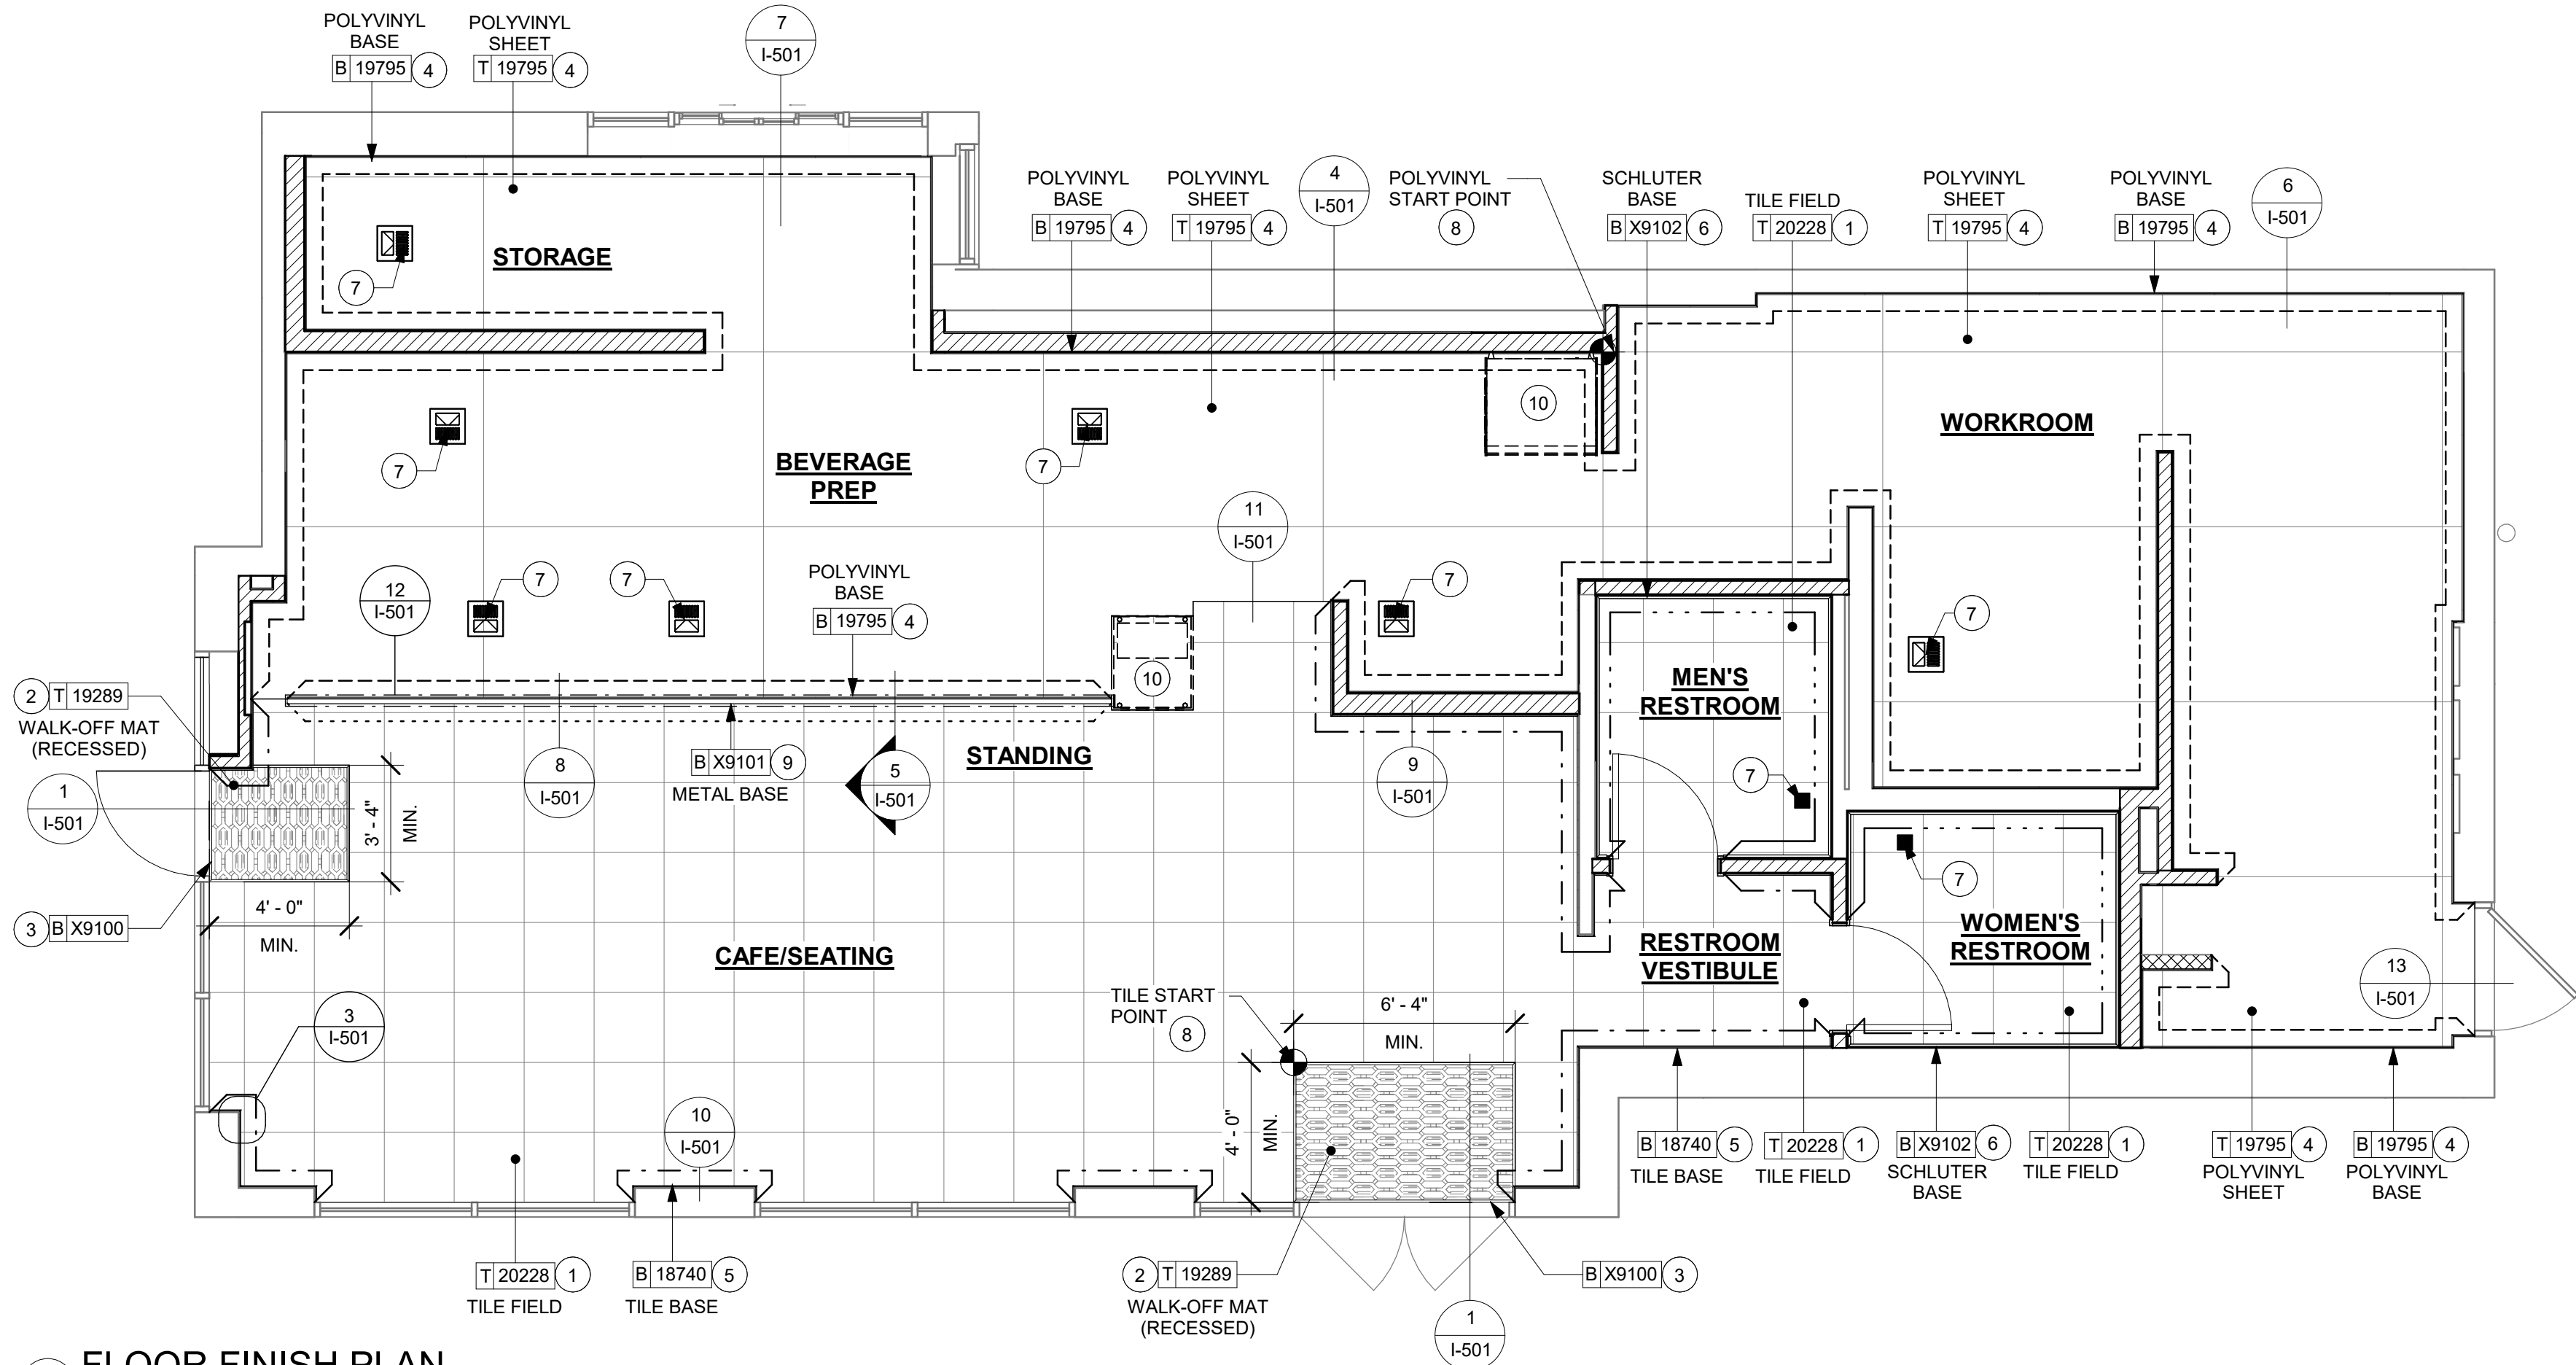

1 FLOOR FINISH PLAN

Scale: 1/4" = 1'-0"

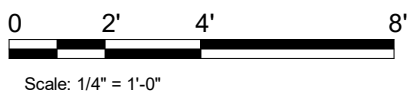

© 2023 STARBUCKS COFFEE COMPANY

STARBUCKS®
2401 UTAH AVENUE SOUTH
SEATTLE, WASHINGTON 98134
(206) 318-1575

THESE DRAWINGS AND THE PROJECT MANUAL ARE CONFIDENTIAL, AND SHALL REMAIN THE SOLE PROPERTY OF STARBUCKS CORPORATION, WHICH IS THE OWNER OF THE COPYRIGHT IN THIS WORK. THEY SHALL NOT BE REPRODUCED (IN WHOLE OR IN PART), SHARED WITH THIRD PARTIES OR USED IN ANY MANNER ON OTHER PROJECTS OR EXTENSIONS TO THIS PROJECT WITHOUT THE PRIOR WRITTEN CONSENT OF STARBUCKS CORPORATION. THESE DRAWINGS AND DRAWINGS ARE NOT TO BE EXTENDED TO EXPRESS DESIGN INTENT FOR A PROTOTYPICAL STARBUCKS STORE, WHICH IS SUBJECT TO CHANGE AT ANYTIME) AND DO NOT REFLECT ACTUAL SITE CONDITIONS. NEITHER PARTY SHALL HAVE ANY OBLIGATION NOR LIABILITY TO THE OTHER (EXCEPT STATED ABOVE) UNTIL A WRITTEN AGREEMENT IS FULLY EXECUTED BY BOTH PARTIES.

STARBUCKS TEMPLATE VERSION: i2023.10.23

Design Forum Architects Inc.

2050 Byers Rd
Miamisburg, OH 45342
Tel: (844) 804-7700

Donald J. Rethman
Architect In Charge
License: AR0017303



FOR CONSTRUCTION

PROJECT NAME:
S SEMORAN BLVD &
LEE VISTA BLVD

PROJECT ADDRESS:
6605 S SEMORAN BLVD
ORLANDO, FL 32822

STORE #: 9875
PROJECT #: 25630-101
ISSUE DATE: 03/04/2024
DESIGN MANAGER: MARTIN PER
PRODUCTION DESIGNER: ANDY MCLO
CHECKED BY: DONALD RET

Revision Schedule			
Rev	Date	By	Description

SHEET TITLE:
FLOOR FINISH PLAN

SCALE: 1/4" = 1'-0"

I-106

\\file-day.ad.changeupinc.com\Client\StarbucksArchitecture\Projects_2023\Florida\Semoran & Lee Vista - 25630-10\125630-101_9875_S Semoran Blvd & Lee Vista Blvd, FL_2023.rvt 3/4/2024 2:39:44 PM

PAINT SCHEDULE					
COLOR CODE	DESCRIPTION	LRV	FURN. BY	INST. BY	COMMENTS
SW6991-SG	SW - BLACK MAGIC - EGGSHELL	3	GC	GC	USE PRIMER CP-1
SW7020-ES	SW - BLACK FOX - EGGSHELL	7	GC	GC	USE PRIMER CP-1
SW7031-ES	SW - MEGA GREIGE -EGGSHELL	37	GC	GC	USE PRIMER CP-1
SW7039-ES	SW - VIRTUAL TAUPE - EGGSHELL	20	GC	GC	USE PRIMER CP-1
SW7631-ES	SW - CITY LOFT - EGGSHELL	70	GC	GC	USE PRIMER CP-1

WALL TREATMENT (AREA) SCHEDULE - "Q"					
DESIGN ID	AREA	DESCRIPTION	FURN. BY	INST. BY	COMMENTS
PLASTIC					
23764	766 SF	POLYWALL WALLCOVERING	GC	GC	
TILE					
20227	477 SF	TILE - I COCCI - CEMENTO - 6X24IN 150X600MM	SB	GC	GROUT: MAPEI - 47 CHARCOAL, OR EQUAL
X9200	714 SF	TILE - GEO WHITE MATTE - 10X2IN 254X50MM	SB	GC	GROUT: MAPEI 105 TO START FULL TILE UNDER GYP CEILING
WALL COVERING					
21060	171 SF	WALL COVERING - ACCORD - SHARK	SB	GC	
WOOD CLADDING					
X9202	330 SF	WOOD - WALNUT - PLANK - VERTICAL	SB	GC	WD0077 MAD 100-V PLANK; PROVIDED BY CASEWORK VENDOR

WALL TREATMENT (LENGTH) SCHEDULE- "R"					
DESIGN ID	LENGTH	DESCRIPTION	FURN. BY	INST. BY	COMMENTS
TRIM					
X9201	124' - 11"	SCHLUTER JOLLY TRIM ; STAINLESS STEEL	GC	GC	SEE DETAIL: 7/I-502 AND 9/I-502; FINISH: STAINLESS STEEL
X9204	18' - 9 3/4"	1" X 2" WOOD TRIM	SB	GC	FINISH: WD0077; SEE DETAIL: 10/A-503; PROVIDED BY CASEWORK VENDOR

LEGEND

	INDICATES PARTIAL HEIGHT - FRP*	Q 23764
	INDICATES BACKBAR WALL TILE AND JOLLY TRIM ABOVE*	Q X9200 R X9201
	INDICATES WOOD CLADDING - (WD0077 MAD-100)*	Q X9202
	INDICATES 1" X 1" CUSTOM WOOD SLATS - (WD0077)*	C X5030
	INDICATES WALLCOVERING*	Q 21060
	INDICATES FULL HEIGHT FRP - WHITE*	Q 23764
	INDICATES RESTROOM WALL TILE	Q 20227
	SCHLUTER TRIM - JOLLY; FINISH: STAINLESS STEEL	R X9201
	INDICATES CORNER GUARD FOR BOH/CAFE INSTALL 6" (150mm) TO 42" (1065mm) A.F.F. UNLESS OTHERWISE NOTED.	C 10829
* SEE INTERIOR FINISH ELEVATIONS FOR TAGGED LOCATION OF WALL FINISH MATERIAL.		
** SEE RESTROOM PLAN & ELEVATIONS FOR TAGGED LOCATION OF WALL FINISH MATERIAL.		

RESPONSIBILITY LEGEND

FURN. BY	INST. BY
GC - FURNISHED BY GENERAL CONTRACTOR	GC - INSTALLED BY GENERAL CONTRACTOR
SB - FURNISHED BY STARBUCKS	SB - INSTALLED BY STARBUCKS
VD - FURNISHED BY VENDOR	VD - INSTALLED BY VENDOR


NOTE:
ALL RESPONSIBILITIES TO BE CONFIRMED WITH STARBUCKS CONSTRUCTION MANAGER PRIOR TO ORDERING / CONSTRUCTION.

KEYED NOTES

- INSTALL FULL HEIGHT FRP AT NEW WORKROOM, STORAGE AND MANAGER'S ROOM WALLS AS INDICATED.
- PROVIDE FIRE TREATED BLOCKING AS REQUIRED TO SUPPORT WALL ATTACHMENTS (SEE BUILDING FLOOR PLAN ON SHEET A-101 FOR MORE INFORMATION).
- REFER TO SHEET I-502 FOR WALL FINISH DETAILS.
- FRP BENEATH BACKBAR AT EXPOSED WALLS EXTEND FROM TOP OF WALL BASE TO UNDERSIDE OF COUNTERTOP.
- PAINT WALL AS INDICATED ON INTERIOR FINISH ELEVATIONS.
- EXISTING RECESSED ELECTRICAL PANELS.
- INSTALL NEW WALL TILE AT RESTROOM AS INDICATED.
- INSTALL CORNER GUARD AT OUTSIDE CORNER AS INDICATED. SEE DETAILS: 8/I-502.
- GC TO INSTALL BACKBAR WALL TILE AS INDICATED ON INTERIOR FINISH ELEVATIONS.SEE DETAILS: 6/I-502.
- EXISTING FRP AT WORKROOM AND MANAGER'S ROOM WALLS. PATCH AND REPAIR IF REQUIRED.
- INSTALL METAL TRIM AT BACKBAR WALL EDGE AS INDICATED.
- INSTALL JOLLY SCHLUTER TRIM ABOVE BACKBAR TILE AS INDICATED.
- INSTALL JOLLY SCHLUTER AT BACKBAR TILE CORNER AS INDICATED.
- INSTALL WOOD CLADDING AS INDICATED ON INTERIOR FINISH ELEVATIONS.
- INSTALL WOOD TRIM AROUND RESTROOM VESTIBULE OPENING WALL AS INDICATED.
- NSTALL FRY REGLET "Y" TRIM AT WOOD CLADDING EDGE AS INDICATED.
- INSTALL FINISH TRANSITION JOLLY TRIM AS INDICATED.
- INSTALL WOOD TRIM AROUND STOREFRONT WINDOW / DOOR OPENING AS INDICATED.
- PAINT WALL ABOVE WALLCOVERING AS INDICATED ON INTERIOR FINISH ELEVATIONS.

GENERAL NOTES

- WORKROOM TO BE FINISHED PER LOCAL CODE REQUIREMENTS.
- GENERAL CONTRACTOR TO PROVIDE AND INSTALL WORKROOM WALL FINISHES.
- FLOORS, WALLS AND CEILING FINISHES IN FOOD PREPARATION AREAS SHALL BE SMOOTH, NON-TOXIC, NON-ABSORBENT, DURABLE AND EASILY CLEANABLE. PAINT SHALL BE WASHABLE; SEMI-GLOSS OR HIGH-GLOSS FINISH.
- CHANGE PAINT COLOR ONLY AT INSIDE CORNERS UNLESS OTHERWISE INDICATED.
- PAINT SUBSTITUTIONS ARE NOT ALLOWED. USE STARBUCKS' NATIONAL ACCOUNT "COLOR CODE" WHEN ORDERING PAINTS.
- PAINT FINISHES SHALL BE APPLIED AS FOLLOWS, UNLESS NOTED OTHERWISE:
 - WOODS AND METAL SURFACES SHALL BE SEMI-GLOSS OR EQUAL.
 - ACCENT AND TRIM PAINTS TO BE SEMI-GLOSS OR EQUAL.
 - WALL AND CEILING PAINTS TO BE EGGSHELL OR EQUAL.
 - PAINTS IN BOH, RESTROOM(S) OR CAFE BAR SHALL BE SEMI-GLOSS OR EQUAL.
- ALL WOOD SURFACES (DOORS, TRIM, SHELVES, CABINETRY) SHALL BE SEALED.
- REFER TO CASEWORK FINISH SCHEDULE FOR CASEWORK FINISH MATERIAL INFORMATION.
- REFER TO INTERIOR FINISH ELEVATIONS FOR ARTWORK/ GRAPHICS LOCATIONS.
- REFER TO MANUFACTURER'S INSTRUCTIONS INCLUDED WITH ARTWORK/GRAPHICS FOR PROPER INSTALLATION.
- ALL FLOOR AND WALL JUNCTIONS IN STORAGE AND FOOD PREPARATION AREAS SHALL HAVE A 6" COVED BASE.
- INSTALL BLOCKING AND HANGERS FOR WALL SHELVING BEFORE INSTALLING BACK BAR TILE.


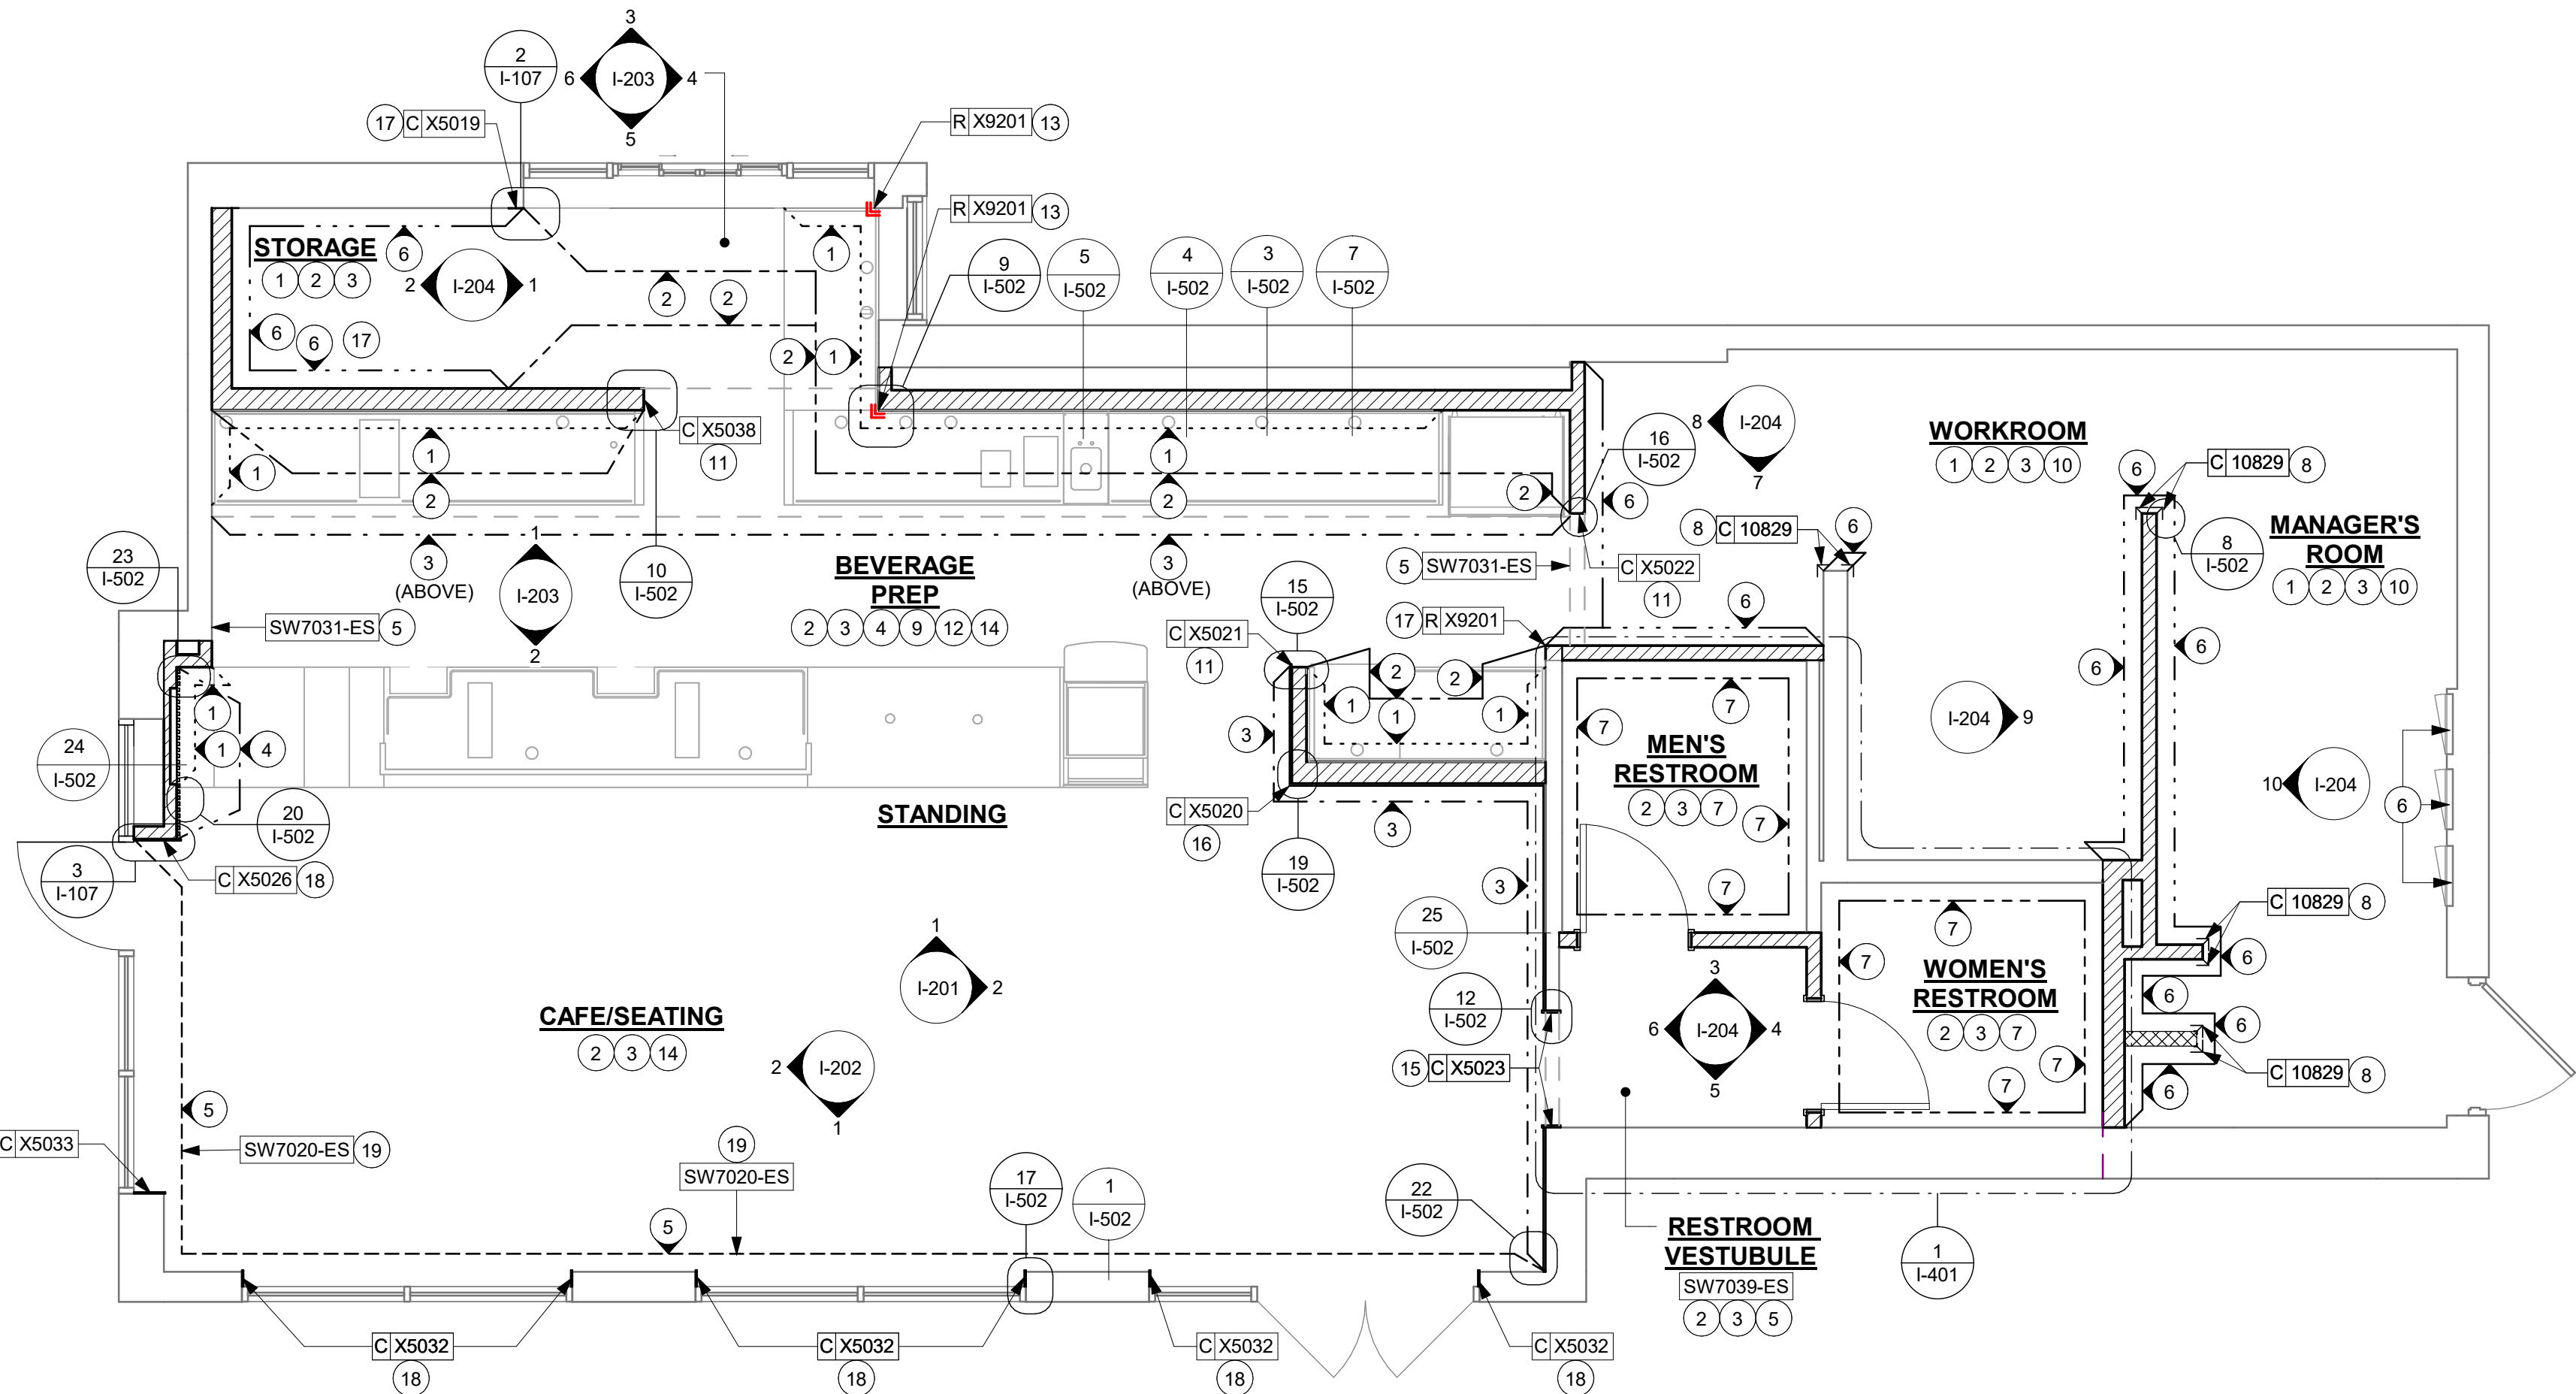


1 WALL FINISH PLAN

Scale: 1/4" = 1'-0"

2 X5019 - FINISH EDGE DETAIL

Scale: 6" = 1'-0"

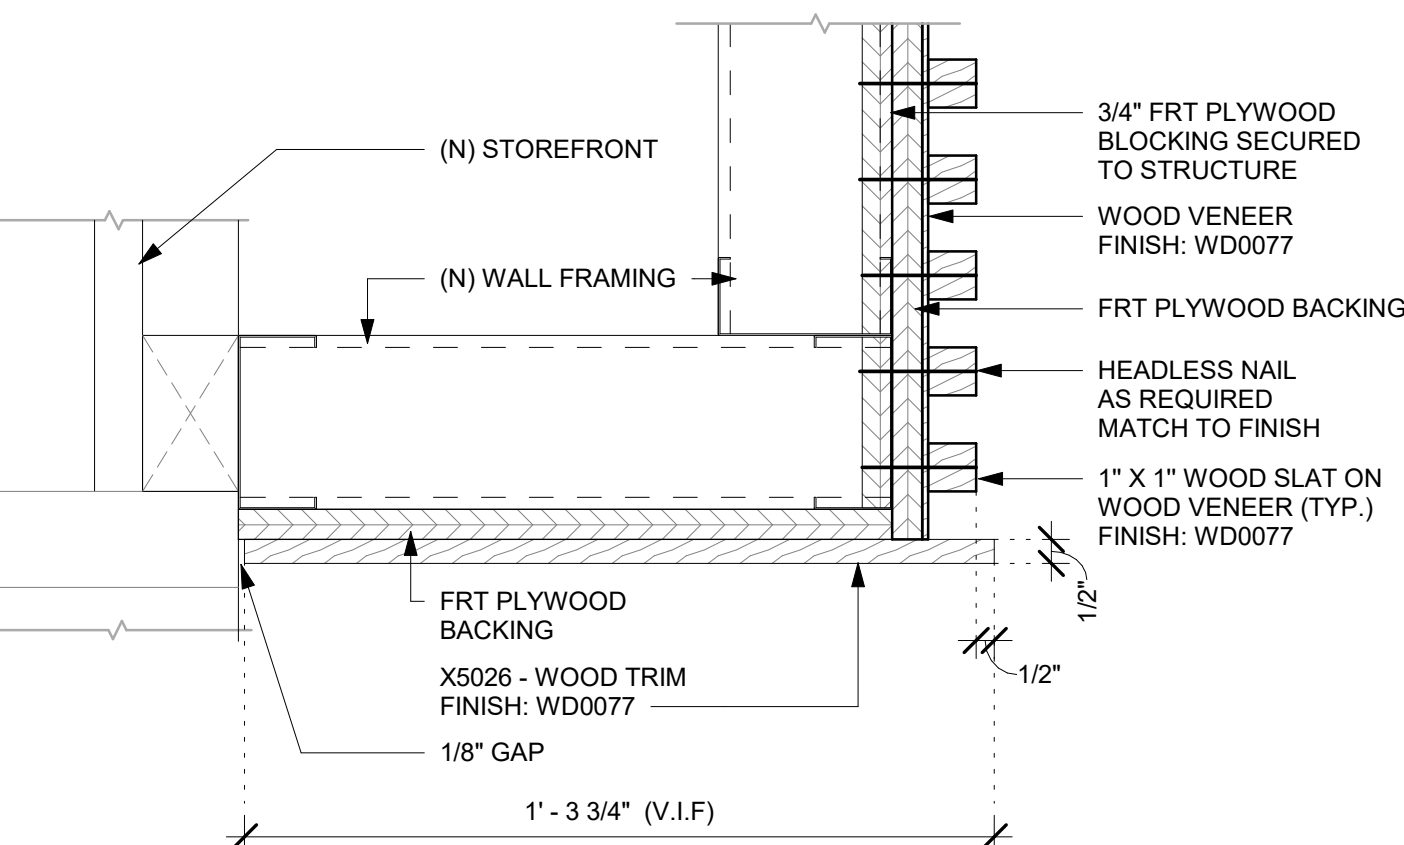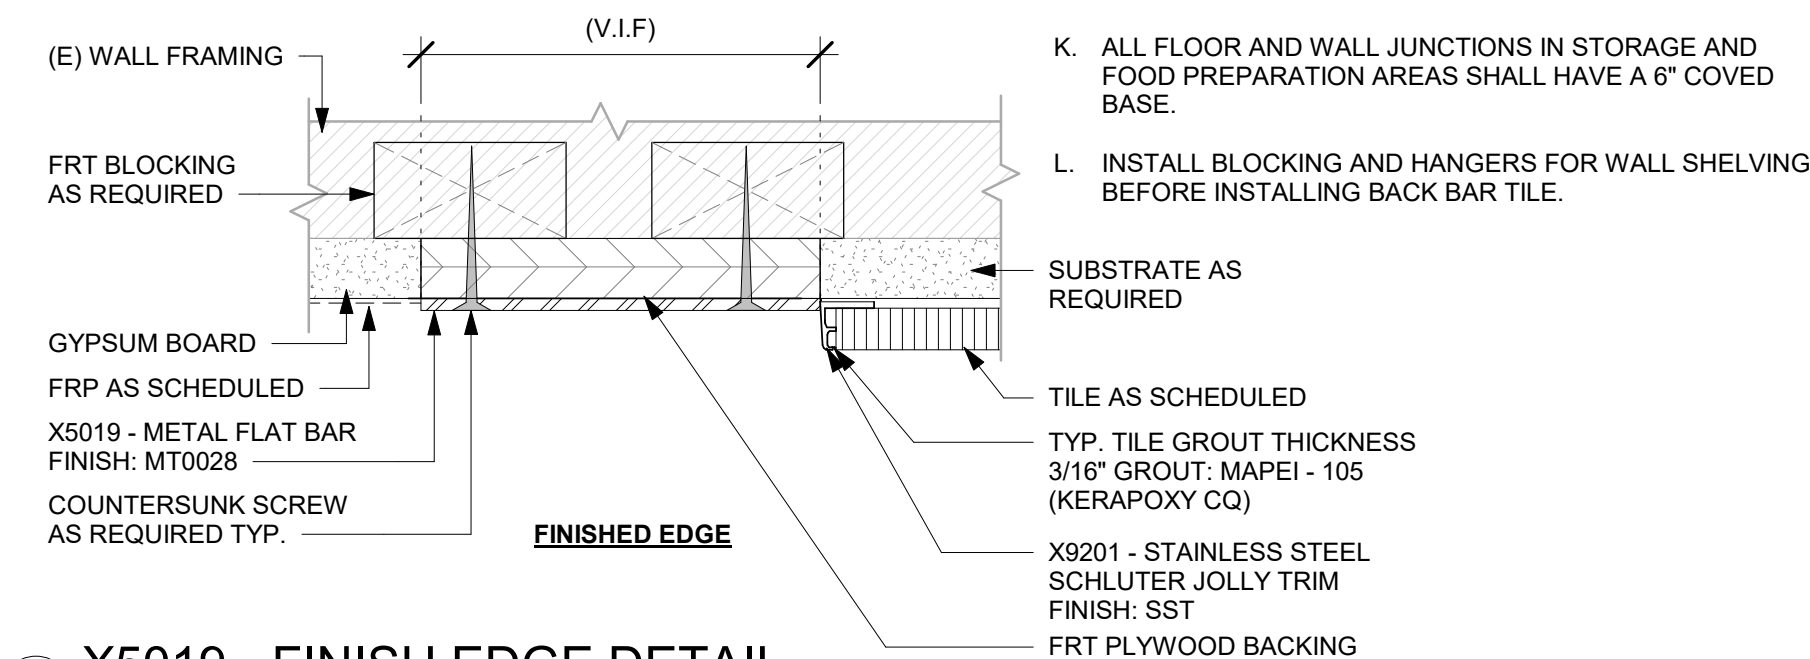

3 X5026 - WOOD TRIM AT STOREFRONT

Scale: 3" = 1'-0"

FOR CONSTRUCTION



STARBUCKS®
2401 UTAH AVENUE SOUTH
SEATTLE, WASHINGTON 98134
(206) 318-1575

THESE DRAWINGS AND THE PROJECT MANUAL ARE CONFIDENTIAL AND SHALL REMAIN THE SOLE PROPERTY OF STARBUCKS CORPORATION, WHICH IS THE OWNER OF THE COPYRIGHT IN THIS WORK. THEY SHALL NOT BE REPRODUCED IN WHOLE OR IN PART, SHARED WITH THIRD PARTIES OR USED IN ANY MANNER ON OTHER PROJECTS OR EXTENSIONS TO THIS PROJECT WITHOUT THE PRIOR WRITTEN CONSENT OF STARBUCKS CORPORATION. THESE DRAWINGS AND SPECIFICATIONS ARE INTENDED TO EXPRESS DESIGN INTENT FOR A PROTOTYPICAL STARBUCKS STORE (WHICH IS SUBJECT TO CHANGE AT ANYTIME) AND DO NOT REFLECT ACTUAL SITE CONDITIONS. NEITHER PARTY SHALL HAVE ANY OBLIGATION NOR LIABILITY TO THE OTHER (EXCEPT STATED ABOVE) UNTIL A WRITTEN AGREEMENT IS FULLY EXECUTED BY BOTH PARTIES.

STARBUCKS TEMPLATE VERSION: i2023.10.23

Design Forum Architects Inc.

2050 Byers Rd
Miami, OH 45342
Tel: (844) 804-7700

Donald J. Reihman
Architect In Charge
License: AR0017303

MARQUE ENGINEERING
2230 PARK AVE, STE. 100, CINCINNATI, OH 45206
513.457.7131 - WWW.MARQUEENG.COM

PROJECT NAME:
S SEMORAN BLVD & LEE VISTA BLVD

PROJECT ADDRESS:
**6605 S SEMORAN BLVD
ORLANDO, FL 32822**

STORE #: 9875
PROJECT #: 25630-101
ISSUE DATE: 03/04/2024
DESIGN MANAGER: MARTIN PEREZ
PRODUCTION DESIGNER: ANDY MCLOUD
CHECKED BY: DONALD REHMAN


Revision Schedule			
Rev	Date	By	Description

SHEET TITLE:
WALL FINISH PLAN


SCALE: 1/4" = 1'-0"

SHEET NUMBER:

I-107

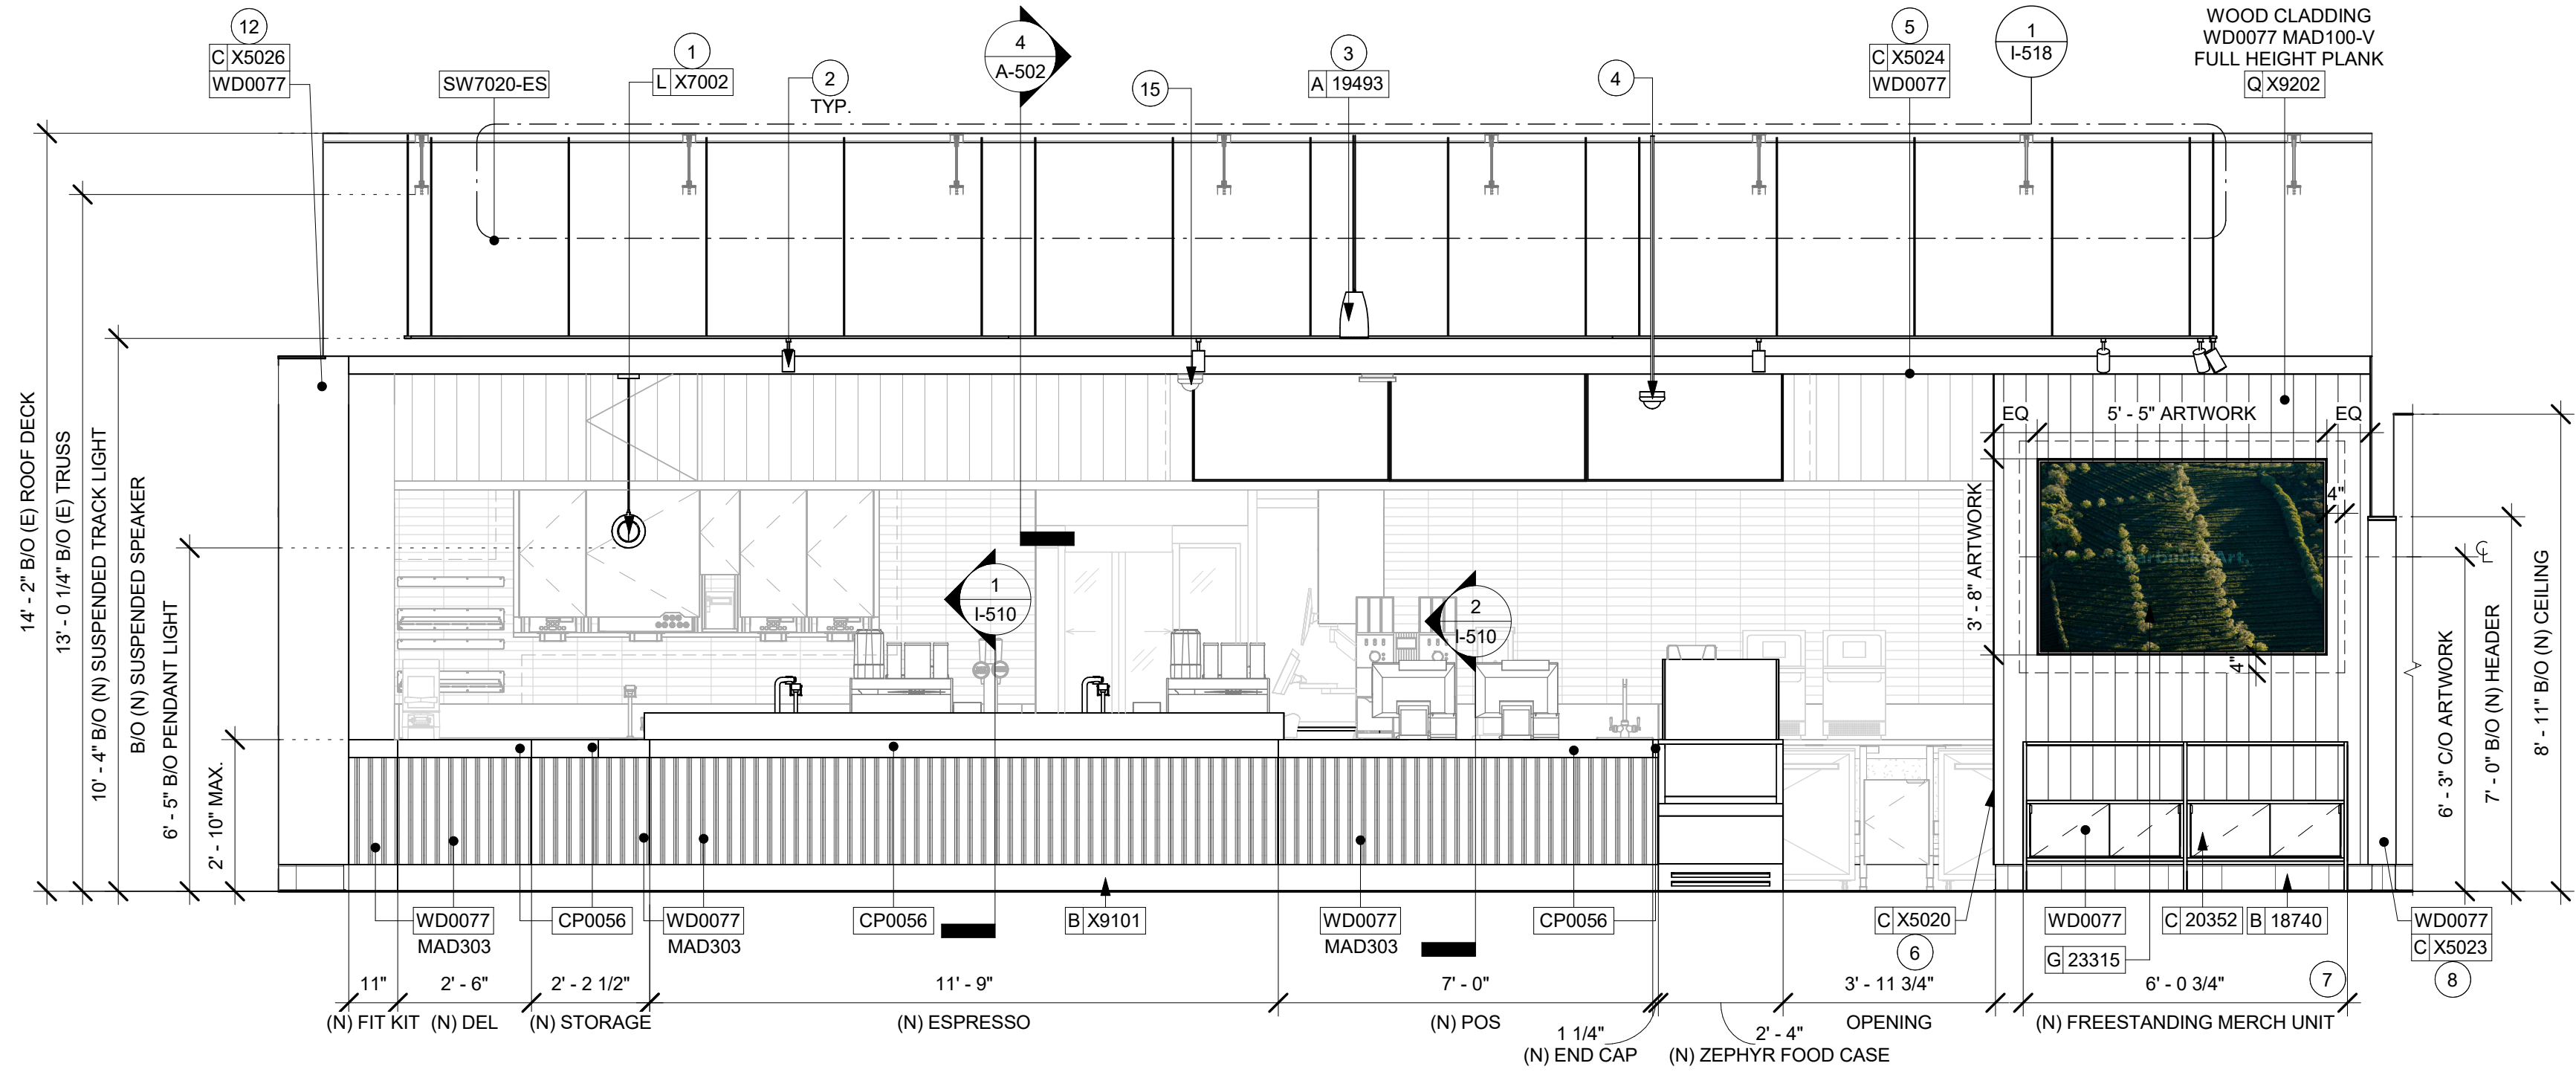

1 FRONT BAR (CUSTOMER SIDE)
Scale: 3/8" = 1'-0"

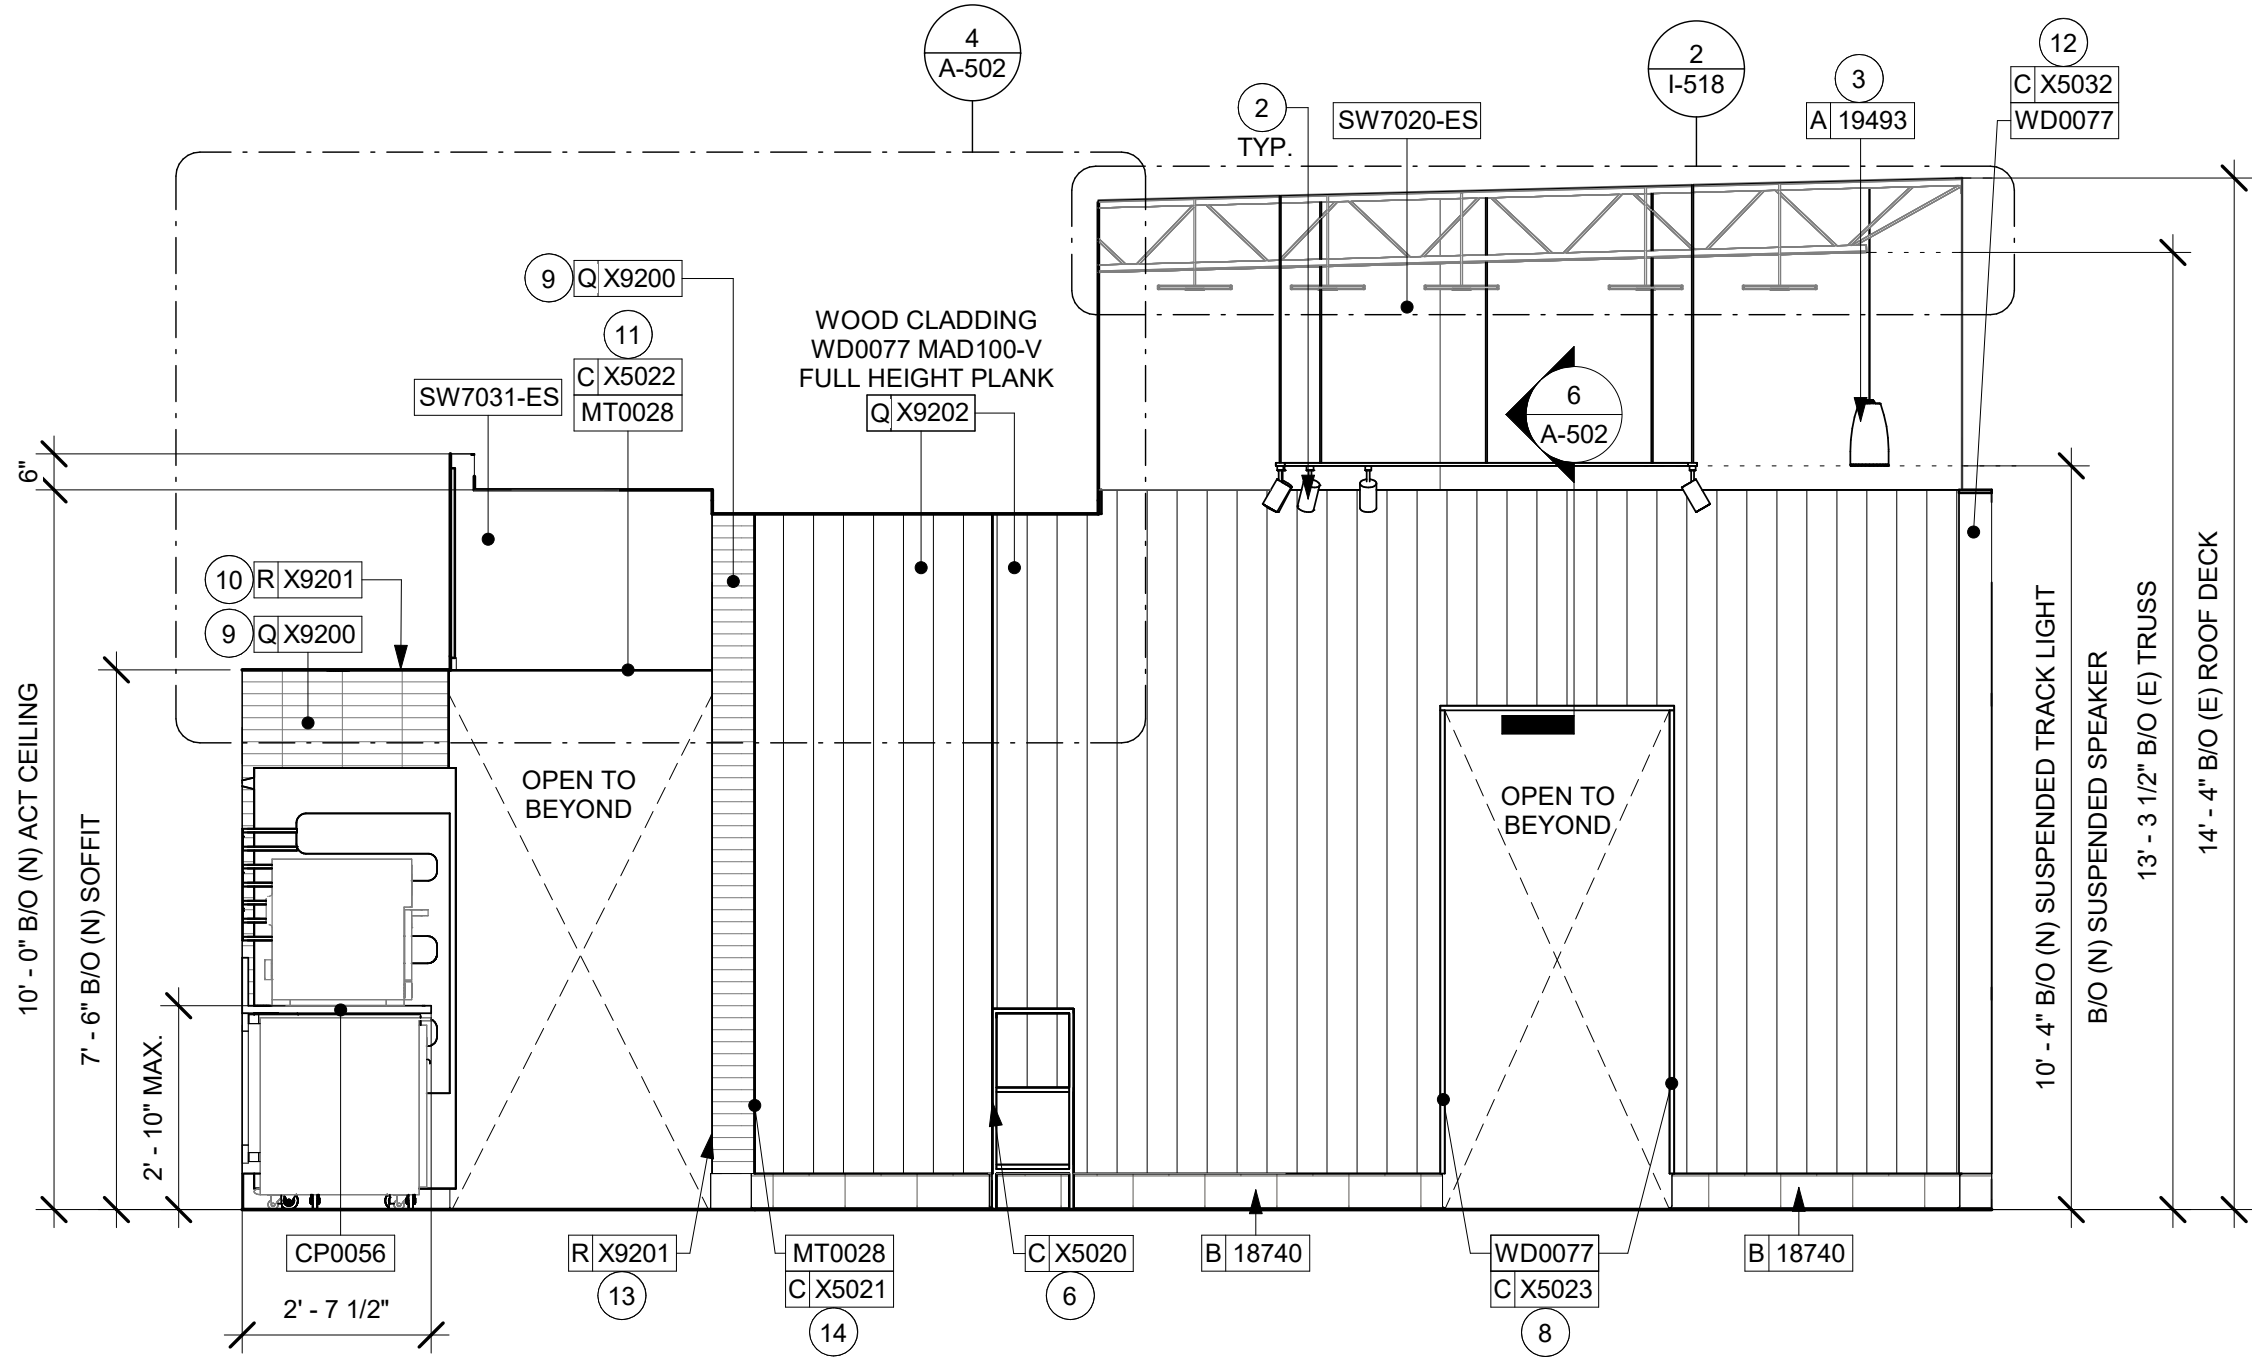

2 CAFE - EAST
Scale: 3/8" = 1'-0"

GENERAL NOTES

- A. FOR PAINT AND WALL TREATMENT SCHEDULES, REFER TO THE INTERIOR FINISH SHEET. FOR GRAPHICS SCHEDULE, REFER TO THE FURNITURE, FIXTURES, AND EQUIPMENT (FF & E) SCHEDULES.
- B. REFER TO MANUFACTURER'S INSTRUCTIONS INCLUDED WITH ARTWORK/GRAPHICS FOR PROPER INSTALLATION.
- C. PAINT FINISHES SHALL BE APPLIED AS FOLLOWS, UNLESS NOTED OTHERWISE:
- WOODS AND METAL SURFACES SHALL BE SEMI-GLOSS OR EQUAL.
 - ACCENT AND TRIM PAINTS TO BE SEMI-GLOSS OR EQUAL.
 - WALL AND CEILING PAINTS TO BE EGGSHELL OR EQUAL.
 - PAINTS IN BOH, RESTROOM(S) OR CAFE BAR SHALL BE SEMI-GLOSS OR EQUAL.
- D. FLOORS, WALLS AND CEILING FINISHES IN FOOD PREPARATION AREAS SHALL BE SMOOTH, NON-TOXIC, NON-ABSORBENT, DURABLE AND EASILY CLEANABLE. PAINT SHALL BE WASHABLE; SEMI-GLOSS OR HIGH GLOSS FINISH.

KEYED NOTES

- INSTALL PENDANT LIGHT AS INDICATED.
- INSTALL SUSPENDED TRACK LIGHTING AS INDICATED. SEE LIGHTING PLAN.
- INSTALL SUSPENDED SPEAKER AS INDICATED. SEE LIGHTING PLAN.
- INSTALL SUSPENDED SECURITY CAMERA AS INDICATED.
- INSTALL WOOD CAP AT SOFFIT AS INDICATED.
- INSTALL FRY REGLET "Y" CORNER TRIM AT WOOD CLADDING EDGE AS INDICATED.
- INSTALL FREESTANDING MERCH UNIT AS INDICATED.
- INSTALL WOOD TRIM AROUND RESTROOM VESTIBULE OPENING AS INDICATED.
- GC TO INSTALL BACKBAR WALL TILE AS INDICATED. SEE DETAIL ON SHEET 6/I-502.
- INSTALL JOLLY SCHLUTER TRIM ABOVE BACKBAR TILE AS INDICATED.
- INSTALL METAL TRIM AROUND BACKBAR OPENING AS INDICATED.
- INSTALL WOOD TRIM AROUND STOREFRONT WINDOW AND DOOR OPENING AS INDICATED.
- INSTALL FINISH TRANSITION JOLLY TRIM AS INDICATED.
- INSTALL METAL TRIM AT BACKBAR WALL EDGE AS INDICATED.
- RELOCATED CEILING MOUNTED SECURITY CAMERA.

LEGEND

- INDICATES WALL BLOCKING. FIRE TREATED WALL BLOCKING TO BE PROVIDED AS REQUIRED TO SUPPORT WALL ATTACHMENTS. EXTEND BLOCKING 4" (100mm) BEYOND EDGE OF ATTACHMENTS.
- WALL TILE START POINT DATUM



© 2023 STARBUCKS COFFEE COMPANY

STARBUCKS®
2401 UTAH AVENUE SOUTH
SEATTLE, WASHINGTON 98134
(206) 318-1575

THESE DRAWINGS AND THE PROJECT MANUAL ARE CONFIDENTIAL AND SHALL REMAIN THE SOLE PROPERTY OF STARBUCKS CORPORATION, WHICH IS THE OWNER OF THE COPYRIGHT IN THIS WORK. THEY SHALL NOT BE REPRODUCED IN WHOLE OR IN PART, SHARED WITH THIRD PARTIES OR USED IN ANY MANNER ON OTHER PROJECTS OR EXTENSIONS TO THIS PROJECT WITHOUT THE PRIOR WRITTEN CONSENT OF STARBUCKS CORPORATION. THESE DRAWINGS AND SPECIFICATIONS ARE INTENDED TO EXPRESS INTENT FOR A PROTOTYPICAL STARBUCKS STORE (WHICH IS SUBJECT TO CHANGE AT ANYTIME) AND DO NOT REFLECT ACTUAL SITE CONDITIONS. NEITHER PARTY SHALL HAVE ANY OBLIGATION NOR LIABILITY TO THE OTHER (EXCEPT STATED ABOVE) UNTIL A WRITTEN AGREEMENT IS FULLY EXECUTED BY BOTH PARTIES.

STARBUCKS TEMPLATE VERSION: i2023.10.23

Design Forum Architects Inc.

2050 Byers Rd
Miami, FL 33134
Tel: (305) 804-7700

Donald J. Rehman
Architect In Charge
License: AR0017303

MARQUE ENGINEERING
2230 PARK AVE, STE. 100, CINCINNATI, OH 45206
513.457.7131 - WWW.MARQUEENG.COM

FOR CONSTRUCTION

PROJECT NAME:
S SEMORAN BLVD & LEE VISTA BLVD

PROJECT ADDRESS:
**6605 S SEMORAN BLVD
ORLANDO, FL 32822**

STORE #: 9875
PROJECT #: 25630-101
ISSUE DATE: 03/04/2024
DESIGN MANAGER: MARTIN PEREZ
PRODUCTION DESIGNER: ANDY MCLOUD
CHECKED BY: DONALD REHMAN

Revision Schedule			
Rev	Date	By	Description

SHEET TITLE:
INTERIOR FINISH ELEVATIONS
SCALE: 3/8" = 1'-0"

SHEET NUMBER:
I-201



STARBUCKS®
2401 UTAH AVENUE SOUTH
SEATTLE, WASHINGTON 98134
(206) 318-1575

STARBUCKS TEMPLATE VERSION: i2023.10.23

Donald J. Rethman
Architect In Charge
License: AR0017303

PROJECT NAME: S SEMORAN BLVD &
LEE VISTA BLVD


PROJECT ADDRESS:
6605 S SEMORAN BLVD
ORLANDO, FL 32822

STORE #: 9875
PROJECT #: 25630-101
ISSUE DATE: 03/04/2024
DESIGN MANAGER: MARTIN PER
PRODUCTION DESIGNER: ANDY MCLOU
CHECKED BY: DONALD RET


SHEET TITLE:
INTERIOR FINISH
ELEVATIONS
SCALE: 3/8" = 1'-0"

SHEET NUMBER: I-202


\\file-day.ad.changeupinc.com\Client\StarbucksArchitecture\Projects_2023\Florida\Semoran & Lee Vista -25630-10\125630-101_9875_S Semoran Blvd & Lee Vista Blvd, FL_2023.rvt 3/4/2024 2:39:51 PM

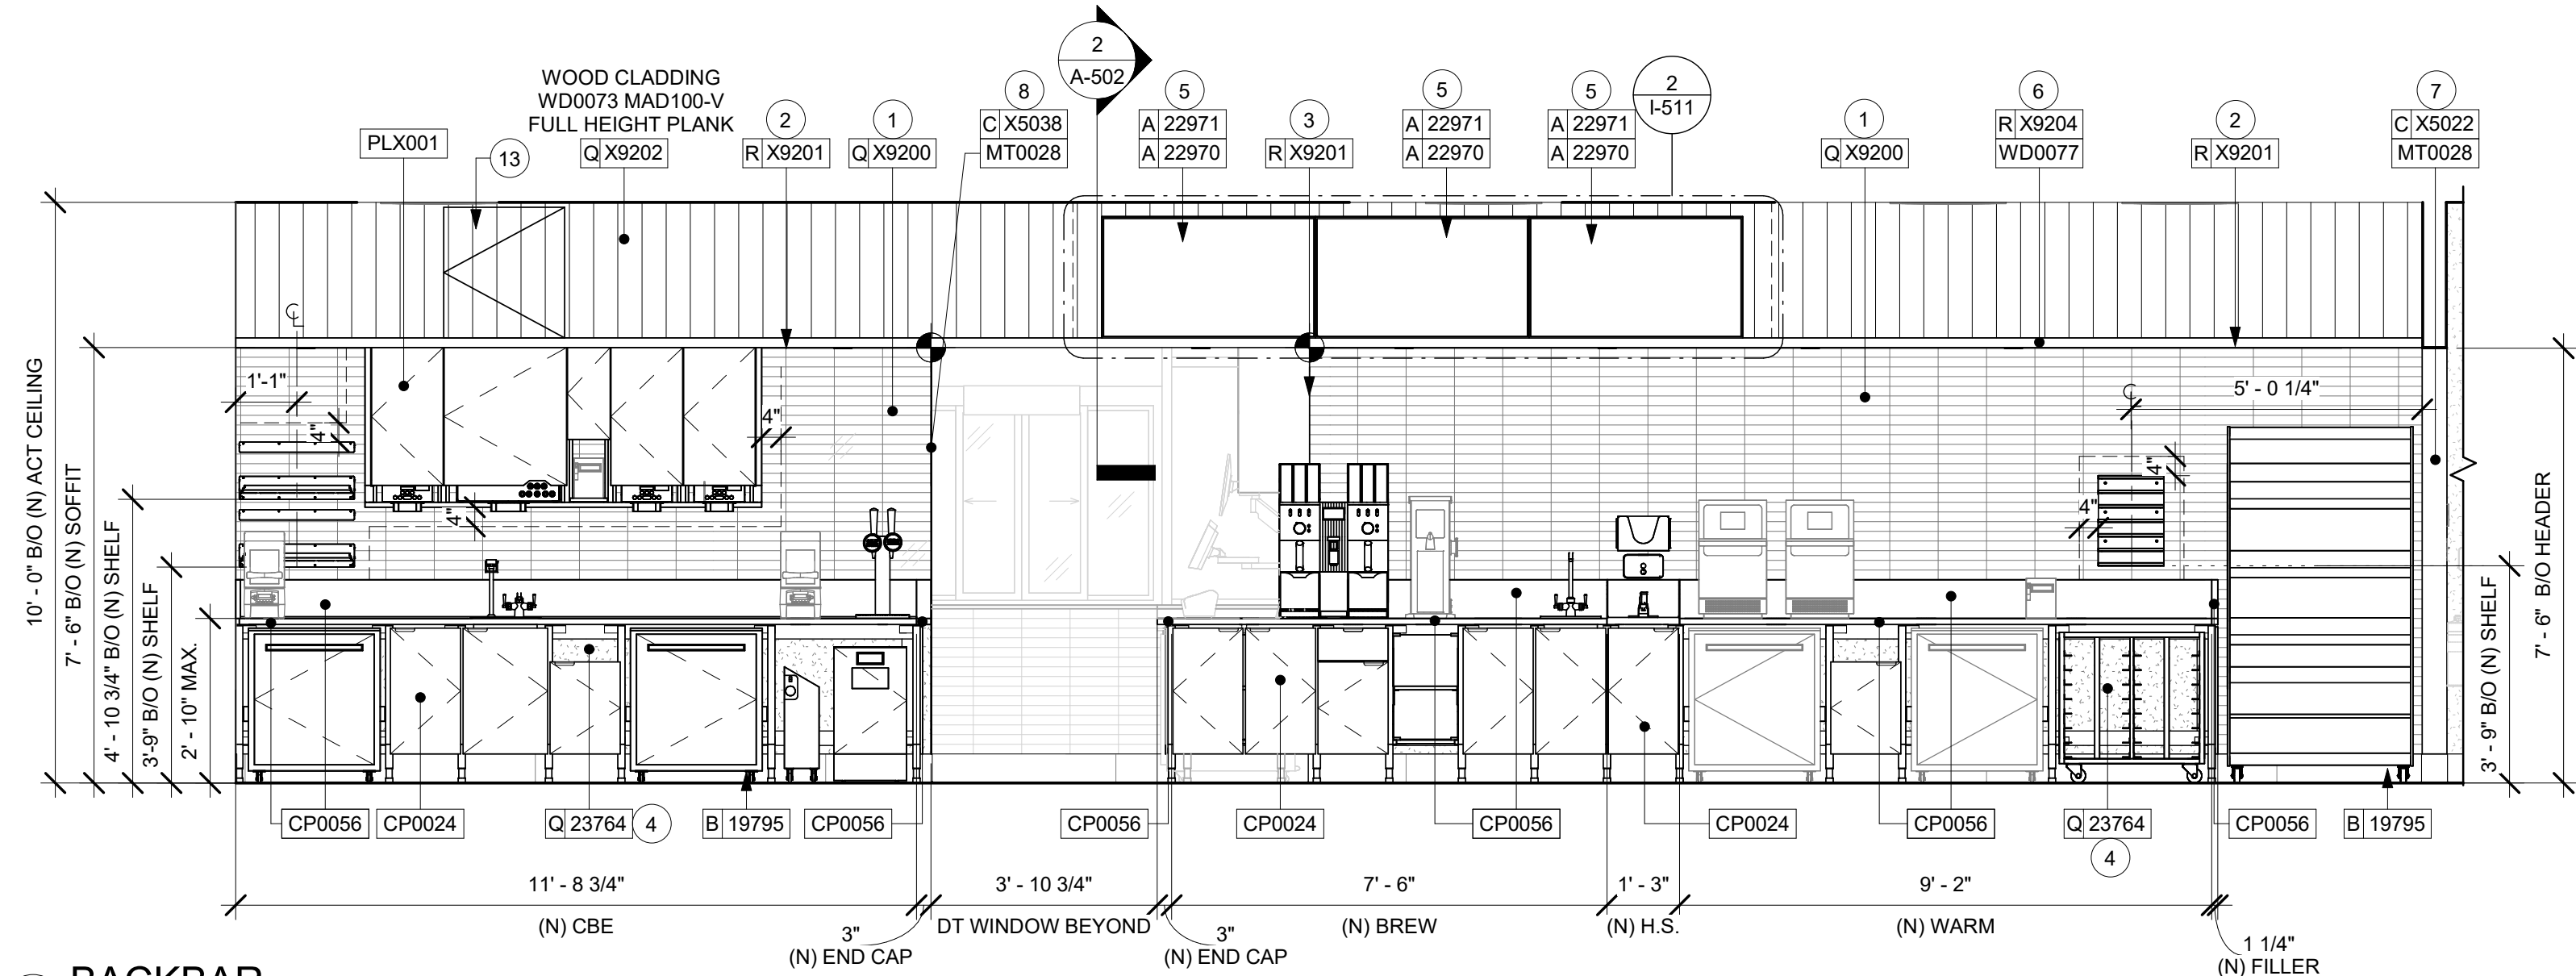


1 BACKBAR
Scale: 3/8" = 1'-0"

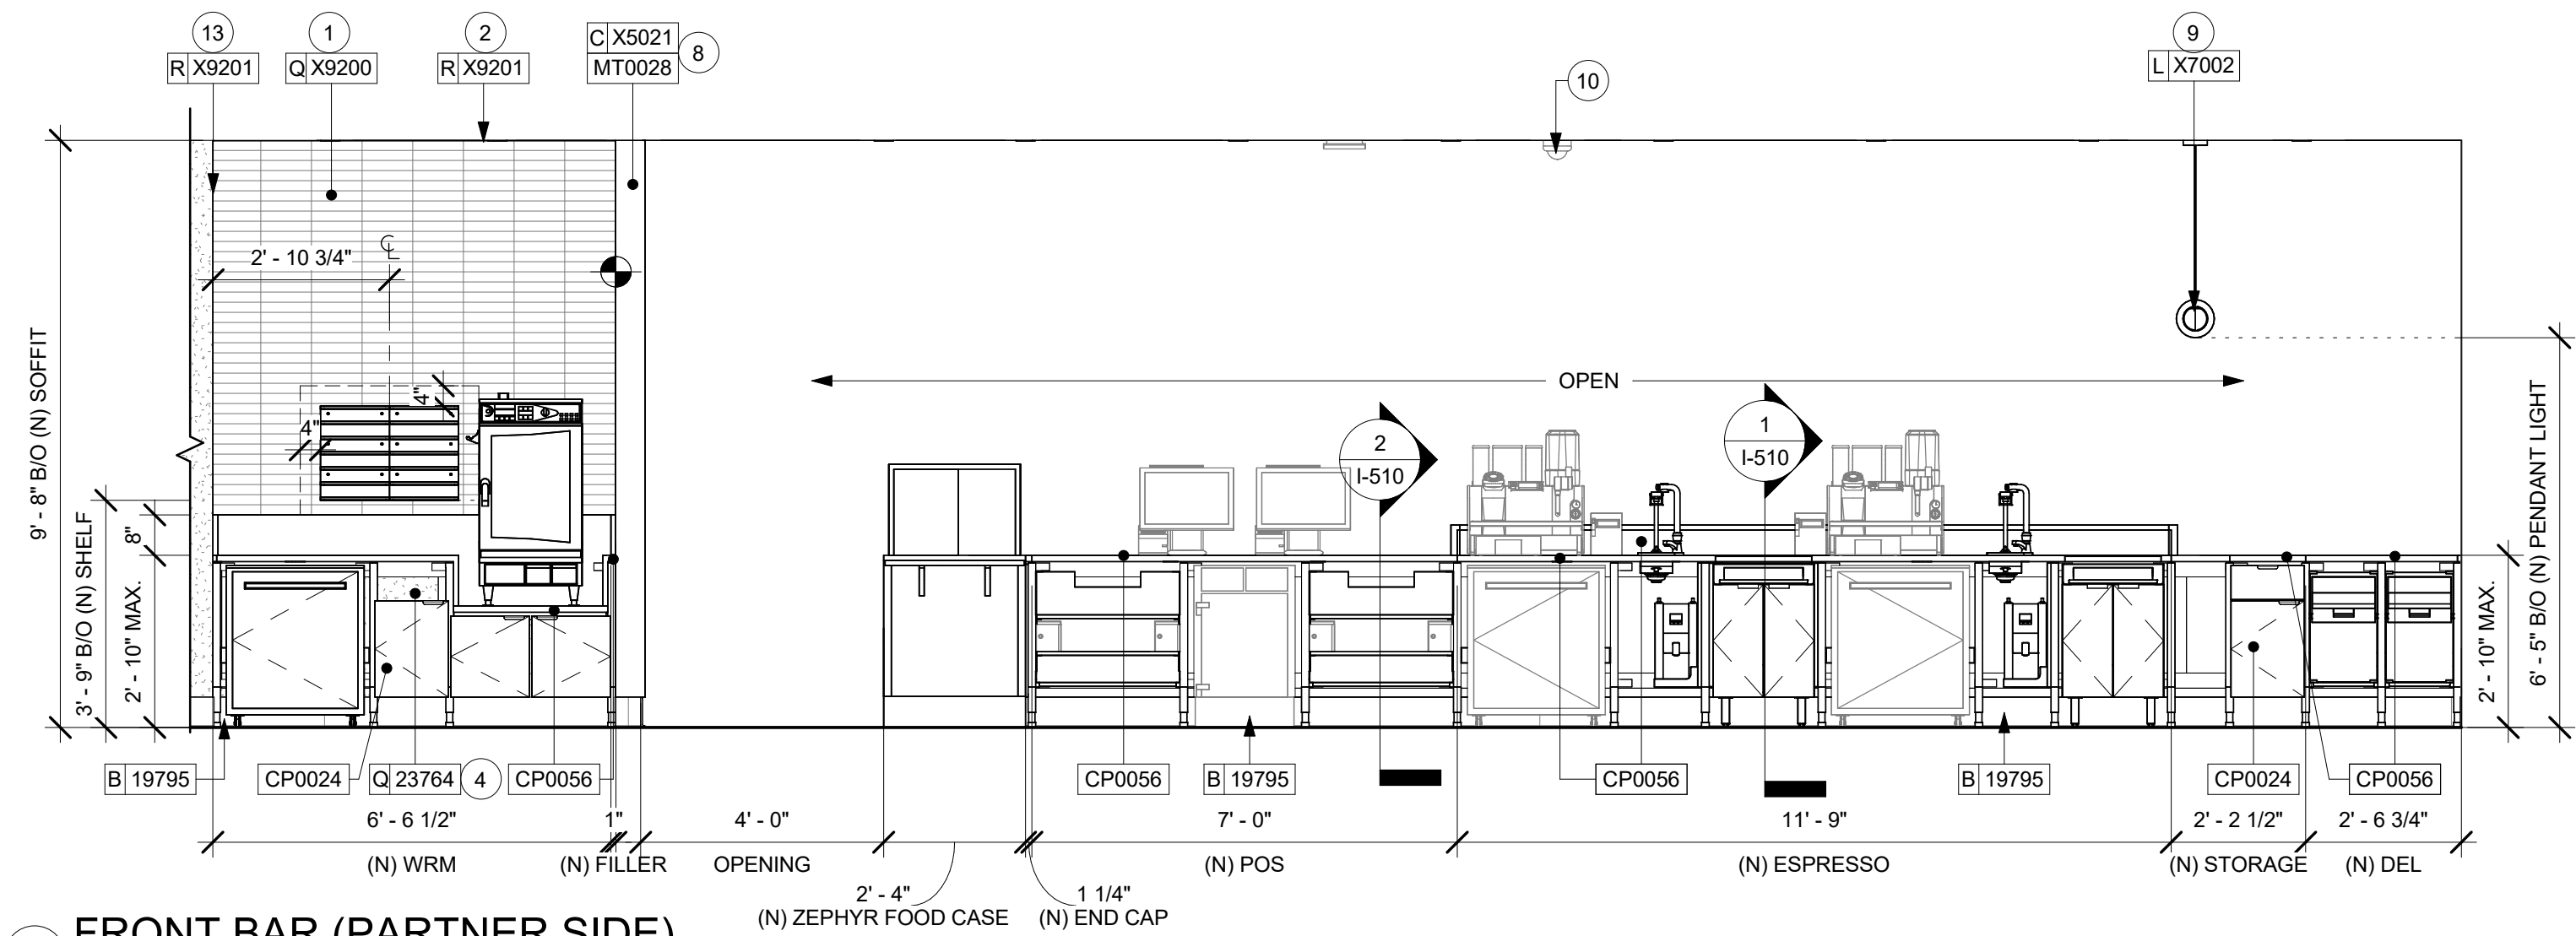


2 FRONT BAR (PARTNER SIDE)
Scale: 3/8" = 1'-0"

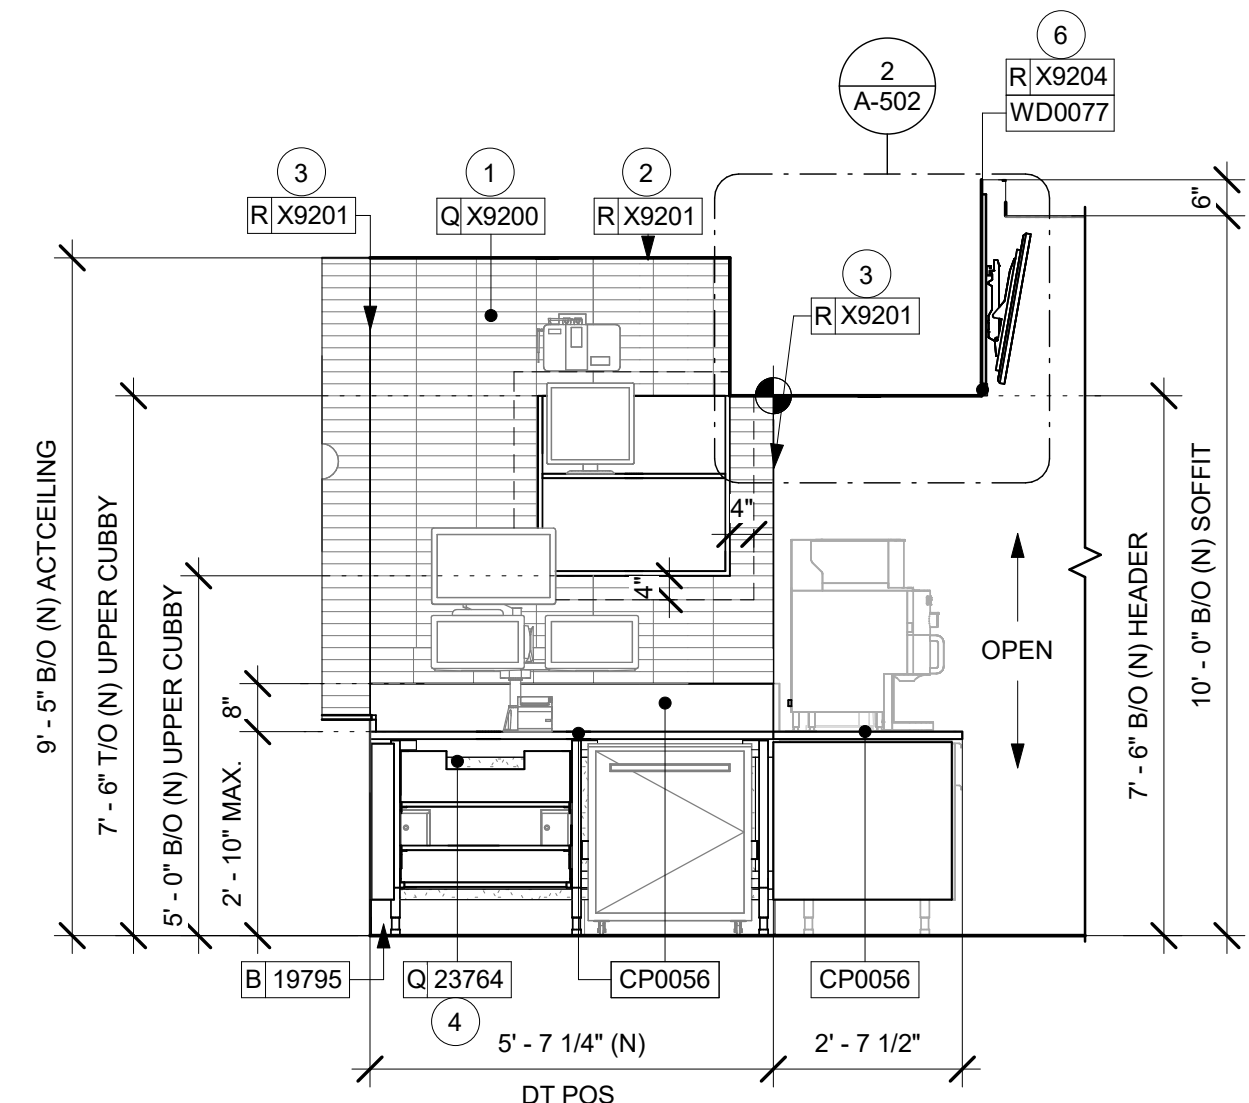


4 DT POS
Scale: 3/8" = 1'-0"

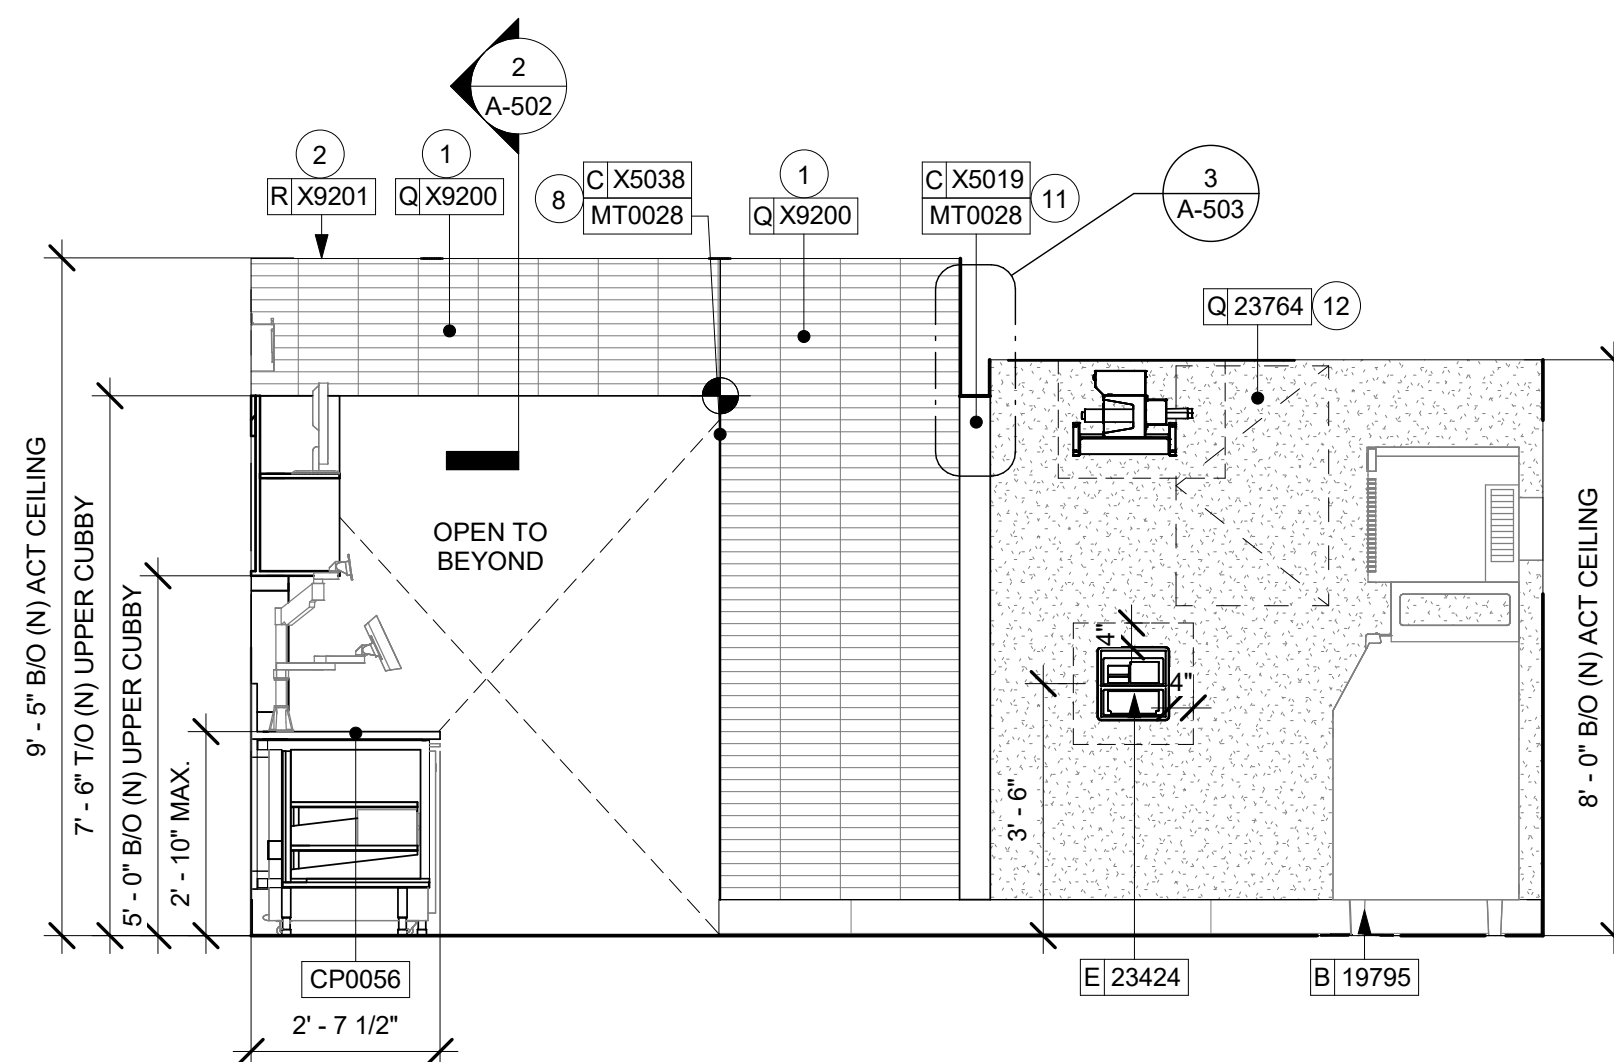

5 DT HEADER
Scale: 3/8" = 1'-0"

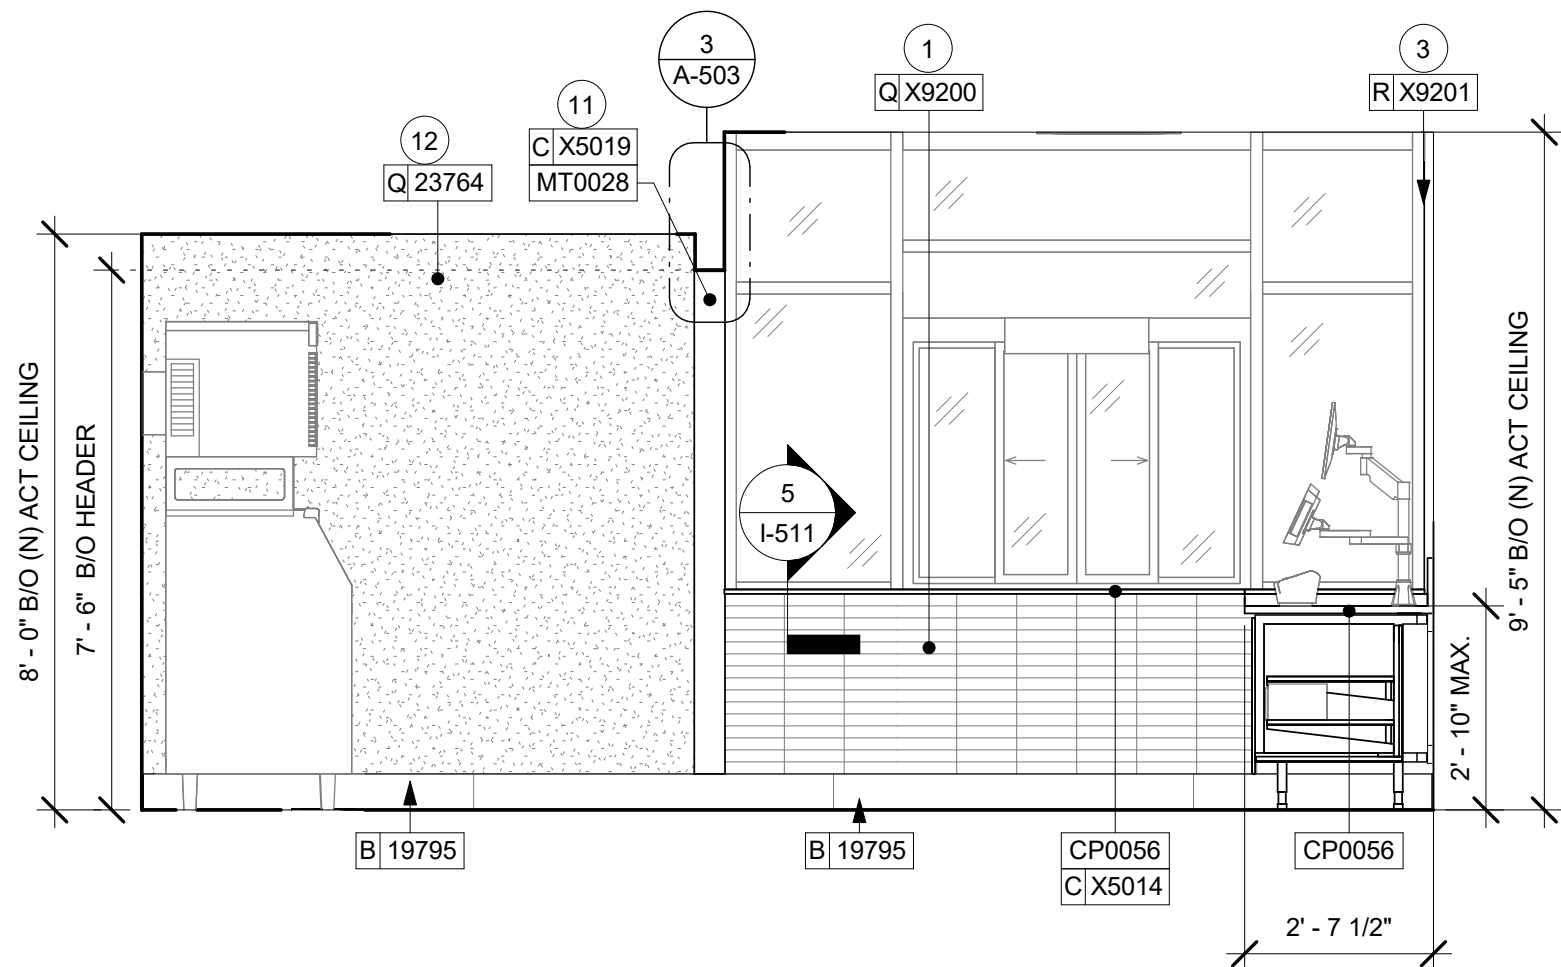

3 DT WINDOW
Scale: 3/8" = 1'-0"

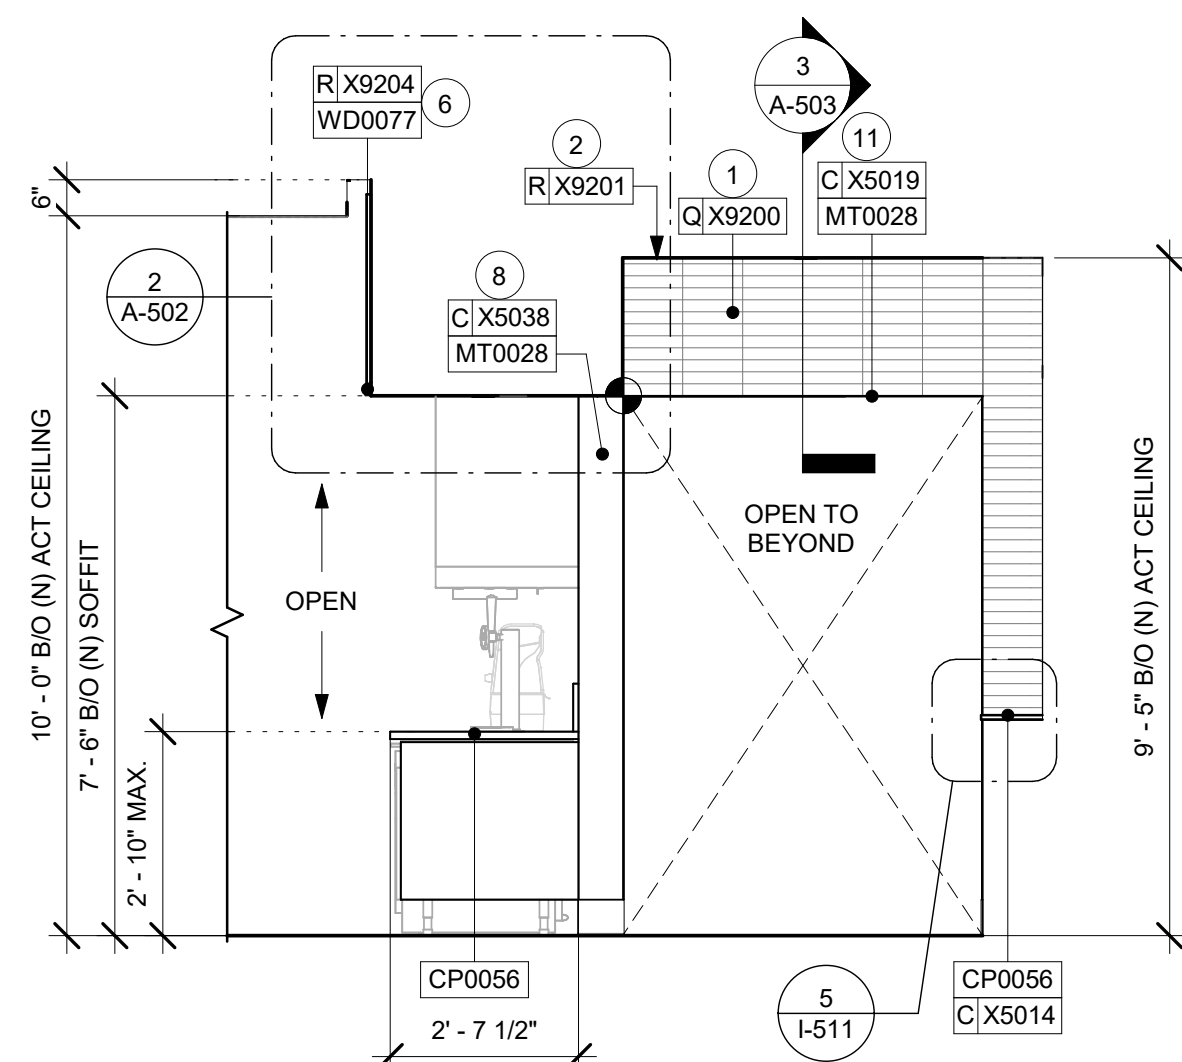

6 STORAGE HEADER
Scale: 3/8" = 1'-0"

KEYED NOTES

- GC TO INSTALL BACKBAR WALL TILE AS INDICATED. SEE DETAIL ON SHEET 6/I-502. GC TO START WITH FULL TILE AT THE TOP.
- INSTALL JOLLY SCHLUTER TRIM ABOVE BACKBAR TILE AS INDICATED.
- INSTALL QUADEC SCHLUTER TRIM AT BACKBAR TILE CORNER AS INDICATED. SEE DETAILS: 9/I-502.
- FRP BENEATH BACKBAR AT EXPOSED WALLS. EXTEND FROM TOP OF WALL BASE TO UNDERSIDE OF COUNTERTOP.
- ATTACH DIGITAL MENU BOARDS PER INSTALLATION DETAIL.
- INSTALL WOOD CAP AT BACKBAR HEADER AS INDICATED.
- INSTALL METAL TRIM AROUND WORKROOM OPENING AS INDICATED.
- INSTALL METAL TRIM AT BACKBAR WALL EDGE AS INDICATED.
- INSTALL PENDANT LIGHT AS INDICATED.
- RELOCATED CEILING MOUNTED SECURITY CAMERA.
- INSTALL METAL TRIM AROUND STORAGE HEADER AS INDICATED.
- INSTALL FULL HEIGHT FRP AT STORAGE NEW WALLS AS INDICATED.
- LOCATION OF ACCESS PANEL FOR CBE UPPER CABINET TO ACCESS NUGET ICE RAIL SYSTEM AS INDICATED.

GENERAL NOTES

- FOR PAINT AND WALL TREATMENT SCHEDULES, REFER TO THE INTERIOR FINISH SHEET. FOR GRAPHICS SCHEDULE, REFER TO THE FURNITURE, FIXTURES, AND EQUIPMENT (FF & E) SCHEDULES.
- REFER TO MANUFACTURER'S INSTRUCTIONS INCLUDED WITH ARTWORK/GRAPHICS FOR PROPER INSTALLATION.
- PAINT FINISHES SHALL BE APPLIED AS FOLLOWS, UNLESS NOTED OTHERWISE:
 - WOODS AND METAL SURFACES SHALL BE SEMI-GLOSS OR EQUAL.
 - ACCENT AND TRIM PAINTS TO BE SEMI-GLOSS OR EQUAL.
 - WALL AND CEILING PAINTS TO BE EGGSHELL OR EQUAL.
 - PAINTS IN BOH, RESTROOM(S) OR CAFE BAR SHALL BE SEMI-GLOSS OR EQUAL.
- FLOORS, WALLS AND CEILING FINISHES IN FOOD PREPARATION AREAS SHALL BE SMOOTH, NON-TOXIC, NON-ABSORBENT, DURABLE AND EASILY CLEANABLE. PAINT SHALL BE WASHABLE; SEMI-GLOSS OR HIGH GLOSS FINISH.

LEGEND

- INDICATES WALL BLOCKING.
FIRE TREATED WALL BLOCKING TO BE PROVIDED AS REQUIRED TO SUPPORT WALL ATTACHMENTS. EXTEND BLOCKING 4" (100mm) BEYOND EDGE OF ATTACHMENTS.
- WALL TILE START POINT DATUM



FOR CONSTRUCTION



STARBUCKS®
2401 UTAH AVENUE SOUTH
SEATTLE, WASHINGTON 98134
(206) 318-1575

THESE DRAWINGS AND THE PROJECT MANUAL ARE CONFIDENTIAL AND SHALL REMAIN THE SOLE PROPERTY OF STARBUCKS CORPORATION, WHICH IS THE OWNER OF THE COPYRIGHT IN THIS WORK. THEY SHALL NOT BE REPRODUCED IN WHOLE OR IN PART, SHARED WITH THIRD PARTIES OR USED IN ANY MANNER ON OTHER PROJECTS OR EXTENSIONS TO THIS PROJECT WITHOUT THE PRIOR WRITTEN CONSENT OF STARBUCKS CORPORATION. THESE DRAWINGS AND SPECIFICATIONS ARE INTENDED TO EXPRESS DESIGN INTENT FOR A PROTOTYPICAL STARBUCKS STORE (WHICH IS SUBJECT TO CHANGE AT ANYTIME) AND DO NOT REFLECT ACTUAL SITE CONDITIONS. NEITHER PARTY SHALL HAVE ANY OBLIGATION NOR LIABILITY TO THE OTHER (EXCEPT STATED ABOVE) UNTIL A WRITTEN AGREEMENT IS FULLY EXECUTED BY BOTH PARTIES.

STARBUCKS TEMPLATE VERSION: i2023.10.23

Design Forum Architects Inc.

2050 Byers Rd
Miamisburg, OH 45342
Tel: (844) 804-7700

Donald J. Reihman
Architect In Charge
License: AR0017303

MARQUE ENGINEERING

2230 PARK AVE, STE. 100, CINCINNATI, OH 45206
513.457.7131 - WWW.MARQUEENG.COM

PROJECT NAME:
S SEMORAN BLVD & LEE VISTA BLVD

PROJECT ADDRESS:
**6605 S SEMORAN BLVD
ORLANDO, FL 32822**


STORE #: 9875
PROJECT #: 25630-101
ISSUE DATE: 03/04/2024
DESIGN MANAGER: MARTIN PEREZ
PRODUCTION DESIGNER: ANDY MCLOUD
CHECKED BY: DONALD REHMAN

Revision Schedule			
Rev	Date	By	Description

SHEET TITLE:
INTERIOR FINISH ELEVATIONS
SCALE: 3/8" = 1'-0"

SHEET NUMBER:
I-203

\\file-day.ad.changeupinc.com\Client\StarbucksArchitecture\Projects_2023\Florida\Semoran & Lee Vista -25630-101\25630-101_9875_S Semoran Blvd & Lee Vista Blvd, FL_2023.rvt 3/4/2024 2:39:54 PM

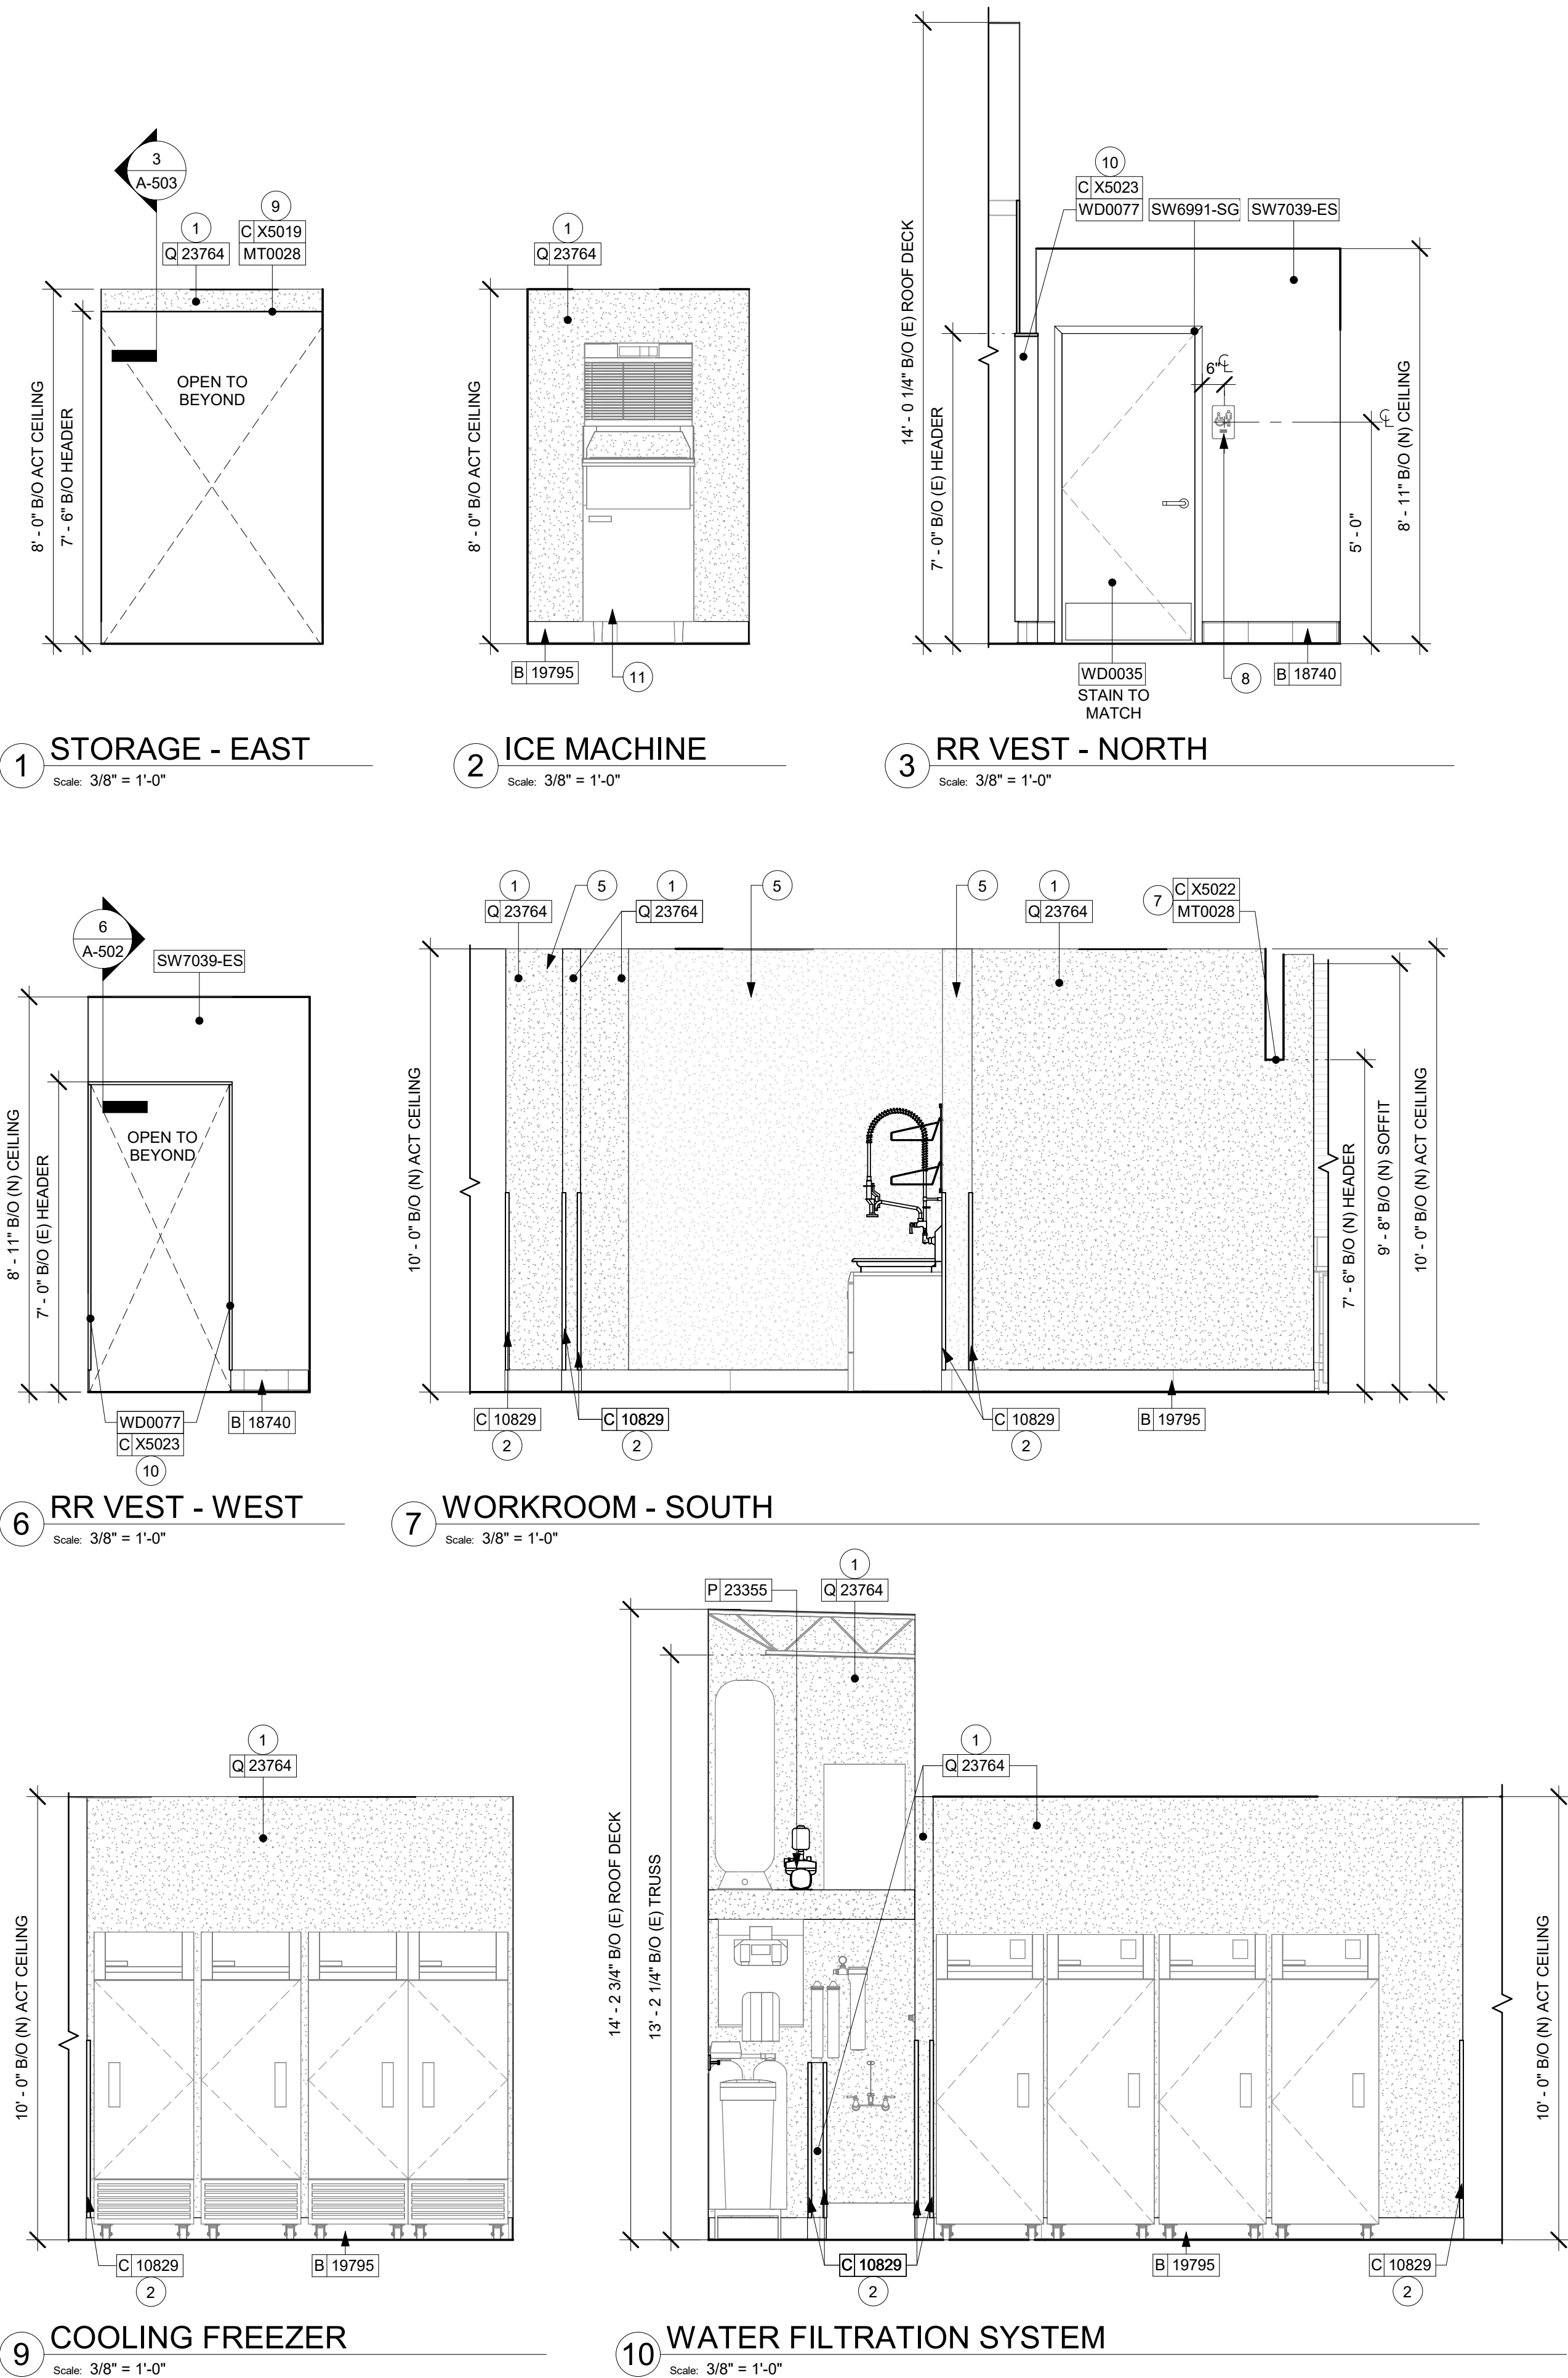

GENERAL NOTES


- FOR PAINT AND WALL TREATMENT SCHEDULES, REFER TO THE INTERIOR FINISH SHEET, FOR GRAPHICS SCHEDULE, REFER TO THE FURNITURE, FIXTURES, AND EQUIPMENT (FF & E) SCHEDULES.
- REFER TO MANUFACTURER'S INSTRUCTIONS INCLUDED WITH ARTWORK/GRAPHICS FOR PROPER INSTALLATION.
- PAINT FINISHES SHALL BE APPLIED AS FOLLOWS, UNLESS NOTED OTHERWISE.
 - WOODS AND METAL SURFACES SHALL BE SEMI-GLOSS OR EQUAL.
 - ACCENT AND TRIM PAINTS TO BE SEMI-GLOSS OR EQUAL.
 - WALL AND CEILING PAINTS TO BE EGGSHELL OR EQUAL.
 - PAINTS IN BOH, RESTROOM(S) OR CAFE BAR SHALL BE SEMI-GLOSS OR EQUAL.
- FLOORS, WALLS AND CEILING FINISHES IN FOOD PREPARATION AREAS SHALL BE SMOOTH, NON-TOXIC, NON-ABSORBENT, DURABLE AND EASILY CLEANABLE. PAINT SHALL BE WASHABLE, SEMI-GLOSS OR HIGH GLOSS FINISH.

KEYED NOTES


- INSTALL FULL HEIGHT FRP AT WORKROOM NEW WALLS AS INDICATED.
- INSTALL CORNER GUARD AT OUTSIDE CORNER AS INDICATED. SEE DETAILS: 8/I-502.
- RELOCATED FIRE EXTINGUISHER.
- RELOCATED LOCATION OF ALL SWITCHING.
- EXISTING FRP.
- LOCATION OF ALL EXIT/ EMERGENCY LIGHTS FOR REFERENCE ONLY. GC TO VERIFY WITH LOCAL FIRE MARSHAL PRIOR TO INSTALLATION.
- INSTALL METAL TRIM AROUND WORKROOM OPENING AS INDICATED.
- RELOCATED RESTROOM SIGNAGE.
- INSTALL METAL TRIM AT STORAGE HEADER AS INDICATED.
- INSTALL WOOD TRIM AROUND RESTROOM VESTIBULE OPENING AS INDICATED.
- RELOCATED ICE MACHINE (SEE PLUMBING AND ELECTRICAL DRAWINGS FOR ADDITIONAL INFORMATION).
- RELOCATED LOCATION OF THERMOSTAT.

LEGEND

- INDICATES WALL BLOCKING. FIRE TREATED WALL BLOCKING TO BE PROVIDED AS REQUIRED TO SUPPORT WALL ATTACHMENTS. EXTEND BLOCKING 4" (100mm) BEYOND EDGE OF ATTACHMENTS.
- WALL TILE START POINT DATUM

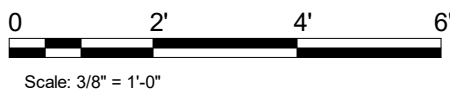

FOR CONSTRUCTION



© 2023 STARBUCKS COFFEE COMPANY

STARBUCKS®
2401 UTAH AVENUE SOUTH
SEATTLE, WASHINGTON 98134
(206) 318-1575

THESE DRAWINGS AND THE PROJECT MANUAL ARE CONFIDENTIAL AND SHALL REMAIN THE SOLE PROPERTY OF STARBUCKS CORPORATION, WHICH IS THE OWNER OF THE COPYRIGHT IN THIS WORK. THEY SHALL NOT BE REPRODUCED IN WHOLE OR IN PART, SHARED WITH THIRD PARTIES OR USED IN ANY MANNER ON OTHER PROJECTS OR EXTENSIONS TO THIS PROJECT WITHOUT THE PRIOR WRITTEN CONSENT OF STARBUCKS CORPORATION. THESE DRAWINGS AND SPECIFICATIONS ARE INTENDED TO EXPRESS INTENT FOR A PROTOTYPICAL STARBUCKS STORE (WHICH IS SUBJECT TO CHANGE AT ANYTIME) AND DO NOT REFLECT ACTUAL SITE CONDITIONS. NEITHER PARTY SHALL HAVE ANY OBLIGATION NOR LIABILITY TO THE OTHER (EXCEPT STATED ABOVE) UNTIL A WRITTEN AGREEMENT IS FULLY EXECUTED BY BOTH PARTIES.

STARBUCKS TEMPLATE VERSION: i2023.10.23

Design Forum Architects Inc.
2050 Byers Rd
Miami, OH 45342
Tel: (844) 804-7700
Donald J. Rethman
Architect In Charge
License: AR0017303

MARQUE ENGINEERING
2230 PARK AVE, STE. 100, CINCINNATI, OH 45206
513.457.7131 - WWW.MARQUEENG.COM

PROJECT NAME:
S SEMORAN BLVD & LEE VISTA BLVD

PROJECT ADDRESS:
**6605 S SEMORAN BLVD
ORLANDO, FL 32822**

STORE #: 9875
PROJECT #: 25630-101
ISSUE DATE: 03/04/2024
DESIGN MANAGER: MARTIN PEREZ
PRODUCTION DESIGNER: ANDY MCLOUD
CHECKED BY: DONALD RETHMAN

Rev	Date	By	Description

SHEET TITLE:
INTERIOR FINISH ELEVATIONS
SCALE: 3/8" = 1'-0"

SHEET NUMBER:
I-204

\\file-day.ad.changeupinc.com\Client\StarbucksArchitecture\Projects_2023\Florida\S Semoran & Lee Vista -25630-10\25630-101_9875_S Semoran Blvd & Lee Vista Blvd, FL_2023.rvt 3/4/2024 2:39:58 PM



1 VIEW TOWARDS FRONT BAR

NOTE: 3D VIEWS ARE FOR REFERENCE ONLY.
REFER TO DETAIL SHEETS FOR CONSTRUCTION.




2 VIEW TOWARDS CAFE SEATING

NOTE: 3D VIEWS ARE FOR REFERENCE ONLY.
REFER TO DETAIL SHEETS FOR CONSTRUCTION.



3 VIEW TOWARDS CONDIMENT CART

NOTE: 3D VIEWS ARE FOR REFERENCE ONLY.
REFER TO DETAIL SHEETS FOR CONSTRUCTION.

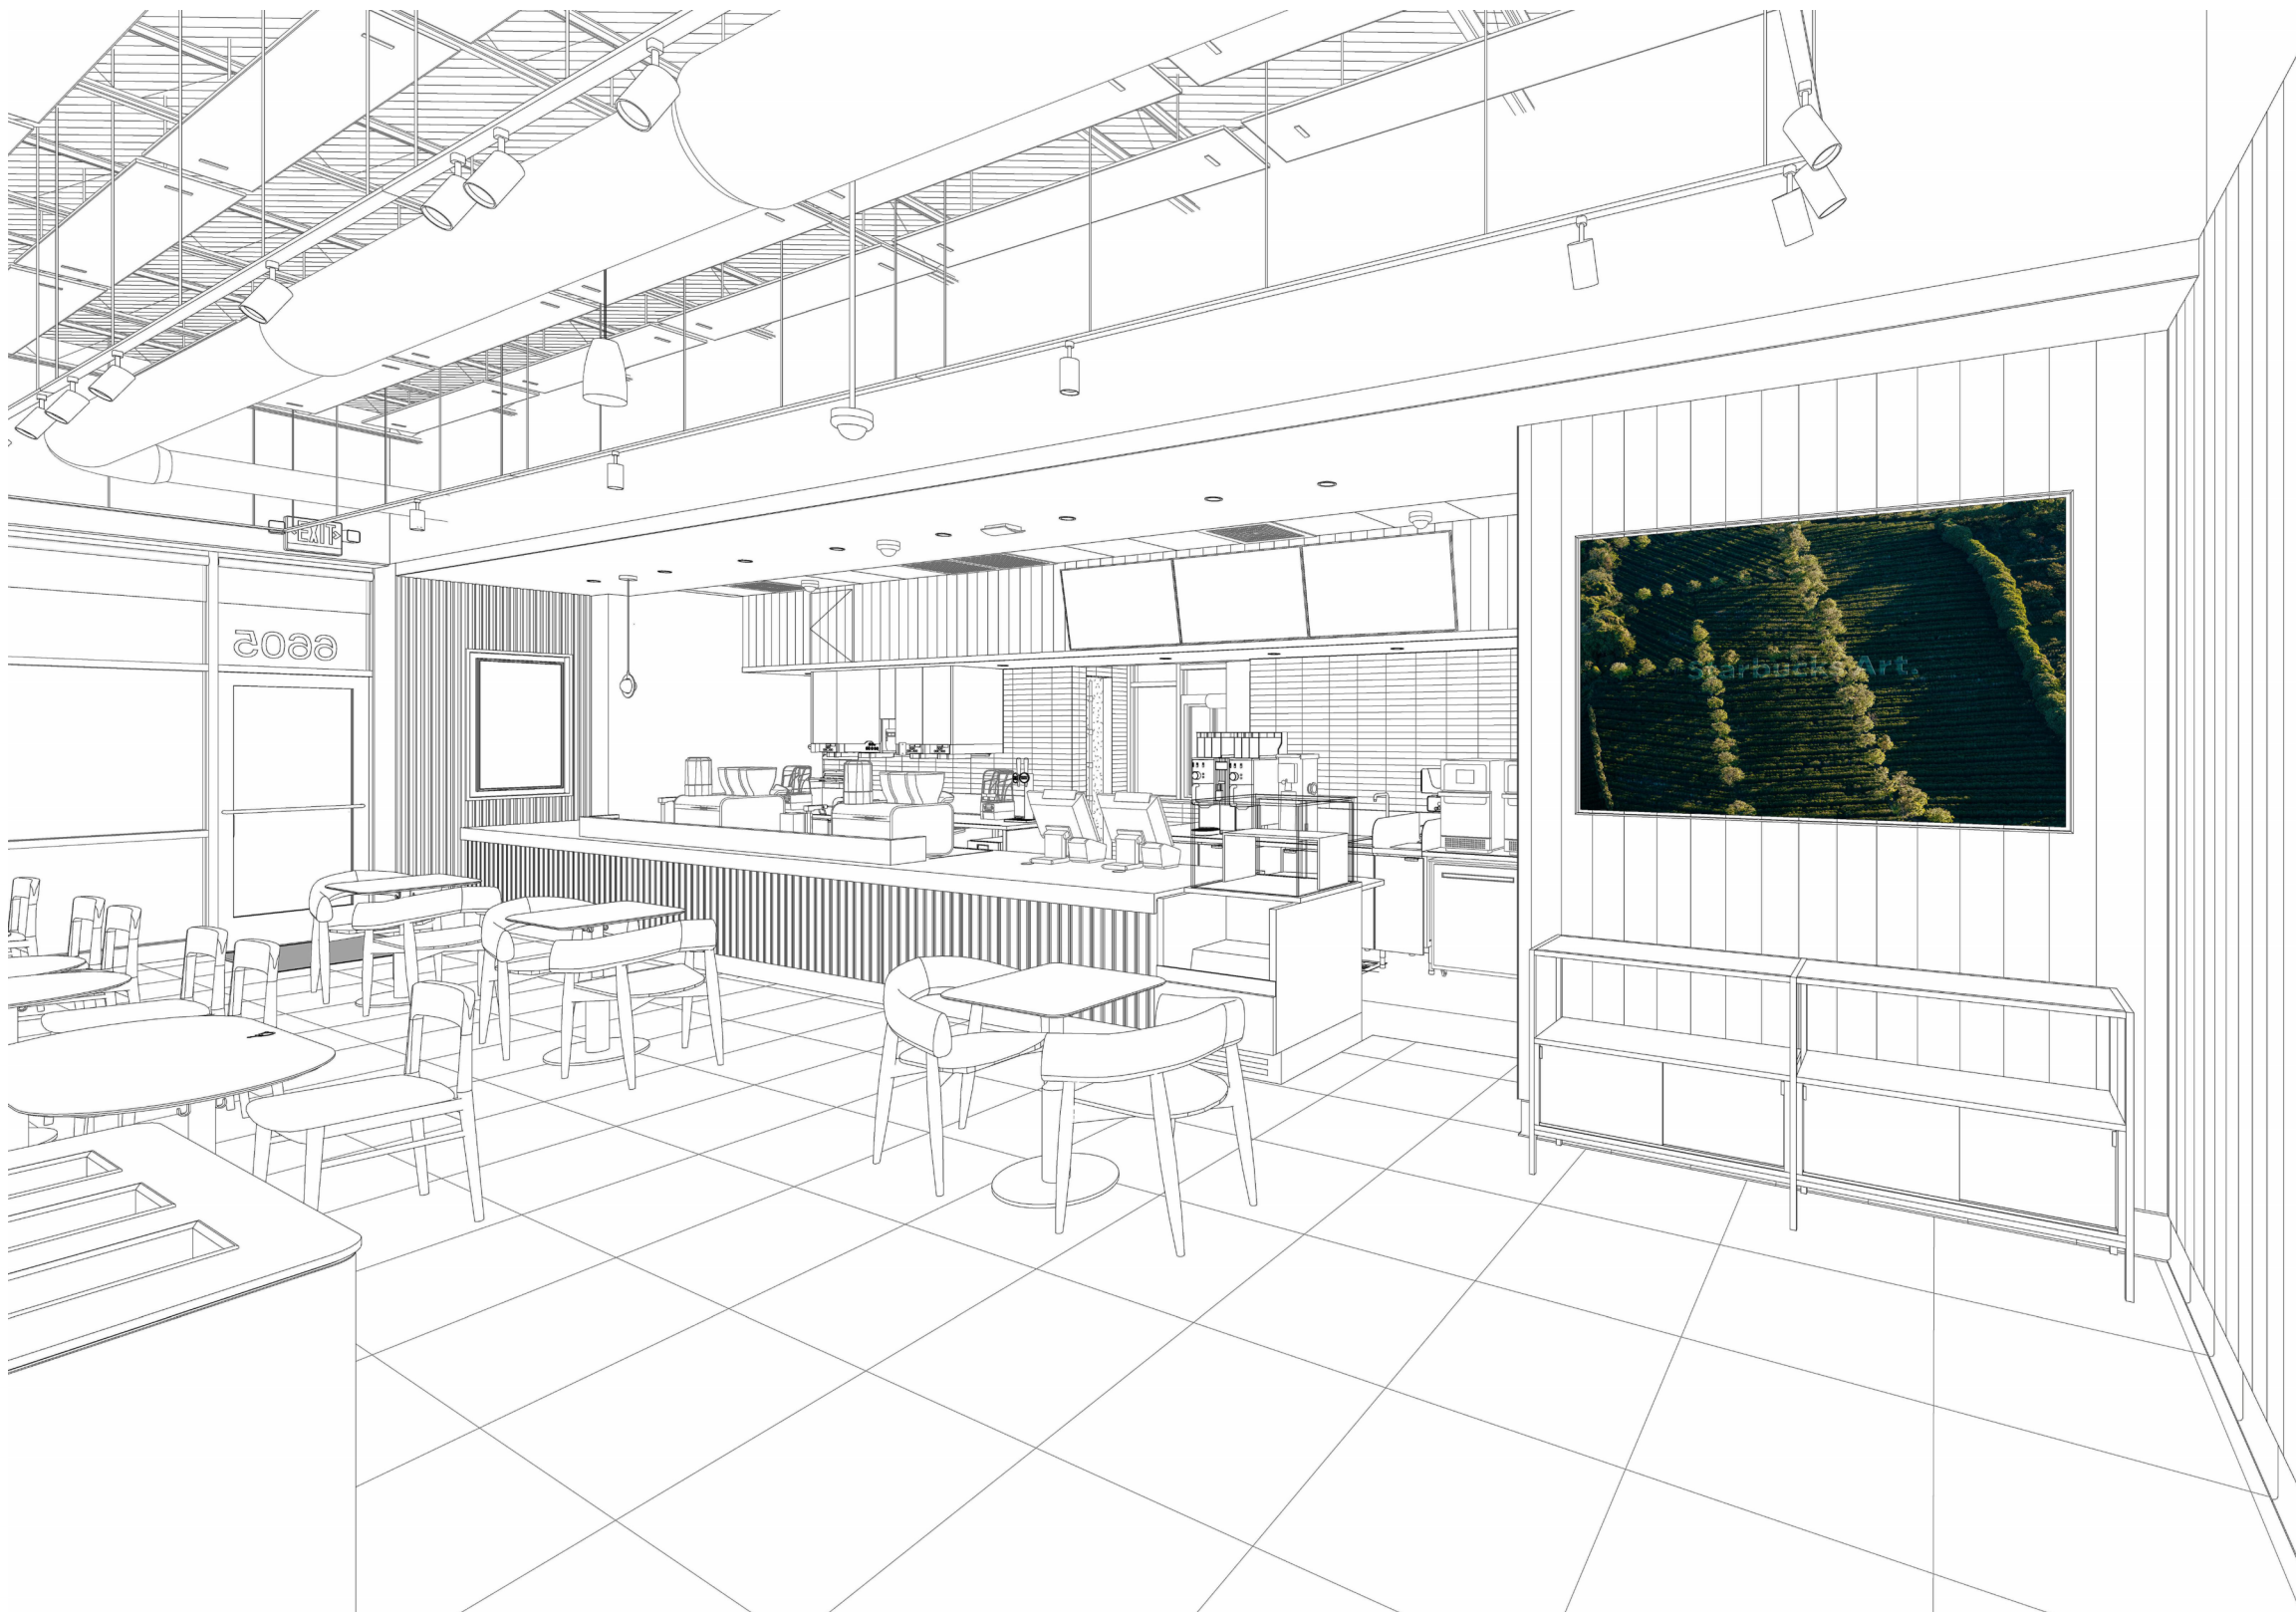

4 VIEW TOWARDS ENGINE AREA

NOTE: 3D VIEWS ARE FOR REFERENCE ONLY.
REFER TO DETAIL SHEETS FOR CONSTRUCTION.



© 2023 STARBUCKS COFFEE COMPANY

STARBUCKS®
2401 UTAH AVENUE SOUTH
SEATTLE, WASHINGTON 98134
(206) 318-1575


THESE DRAWINGS AND THE PROJECT MANUAL ARE CONFIDENTIAL AND SHALL REMAIN THE SOLE PROPERTY OF STARBUCKS CORPORATION, WHICH IS THE OWNER OF THE COPYRIGHT IN THIS WORK. THEY SHALL NOT BE REPRODUCED IN WHOLE OR IN PART, SHARED WITH THIRD PARTIES OR USED IN ANY MANNER ON OTHER PROJECTS OR EXTENSIONS TO THIS PROJECT WITHOUT THE PRIOR WRITTEN CONSENT OF STARBUCKS CORPORATION. THESE DRAWINGS AND SPECIFICATIONS ARE INTENDED TO EXPRESS DESIGN INTENT FOR A PROTOTYPICAL STARBUCKS STORE (WHICH IS SUBJECT TO CHANGE AT ANYTIME) AND DO NOT REFLECT ACTUAL SITE CONDITIONS. NEITHER PARTY SHALL HAVE ANY OBLIGATION NOR LIABILITY TO THE OTHER (EXCEPT STATED ABOVE) UNTIL A WRITTEN AGREEMENT IS FULLY EXECUTED BY BOTH PARTIES.

STARBUCKS TEMPLATE VERSION: i2023.10.23

Design Forum Architects Inc.

2050 Byers Rd
Miami, OH 45342
Tel: (614) 804-7700

Donald J. Rehman
Architect in Charge
License: AR0017303

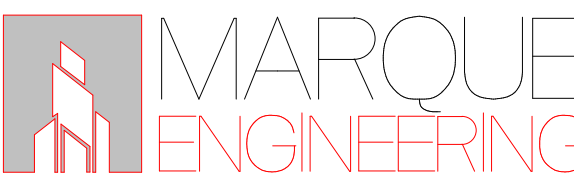

2230 PARK AVE, STE. 100, CINCINNATI, OH 45206
513.457.7131 - WWW.MARQUEENG.COM

FOR CONSTRUCTION

PROJECT NAME:
S SEMORAN BLVD & LEE VISTA BLVD

PROJECT ADDRESS:
**6605 S SEMORAN BLVD
ORLANDO, FL 32822**

STORE #: 9875
PROJECT #: 25630-101
ISSUE DATE: 03/04/2024
DESIGN MANAGER: MARTIN PEREZ
PRODUCTION DESIGNER: ANDY MCLOUD
CHECKED BY: DONALD REHMAN

Revision Schedule			
Rev	Date	By	Description


SHEET TITLE:
PERSPECTIVE VIEWS

SCALE: NO SCALE

SHEET NUMBER:

I-205

\\file-day.ad.changeupinc.com\Client\StarbucksArchitecture\Projects_2023\Florida\Semoran & Lee Vista -25630-101\25630-101_9875_S Semoran Blvd & Lee Vista Blvd, FL_2023.rvt 3/4/2024 2:39:59 PM

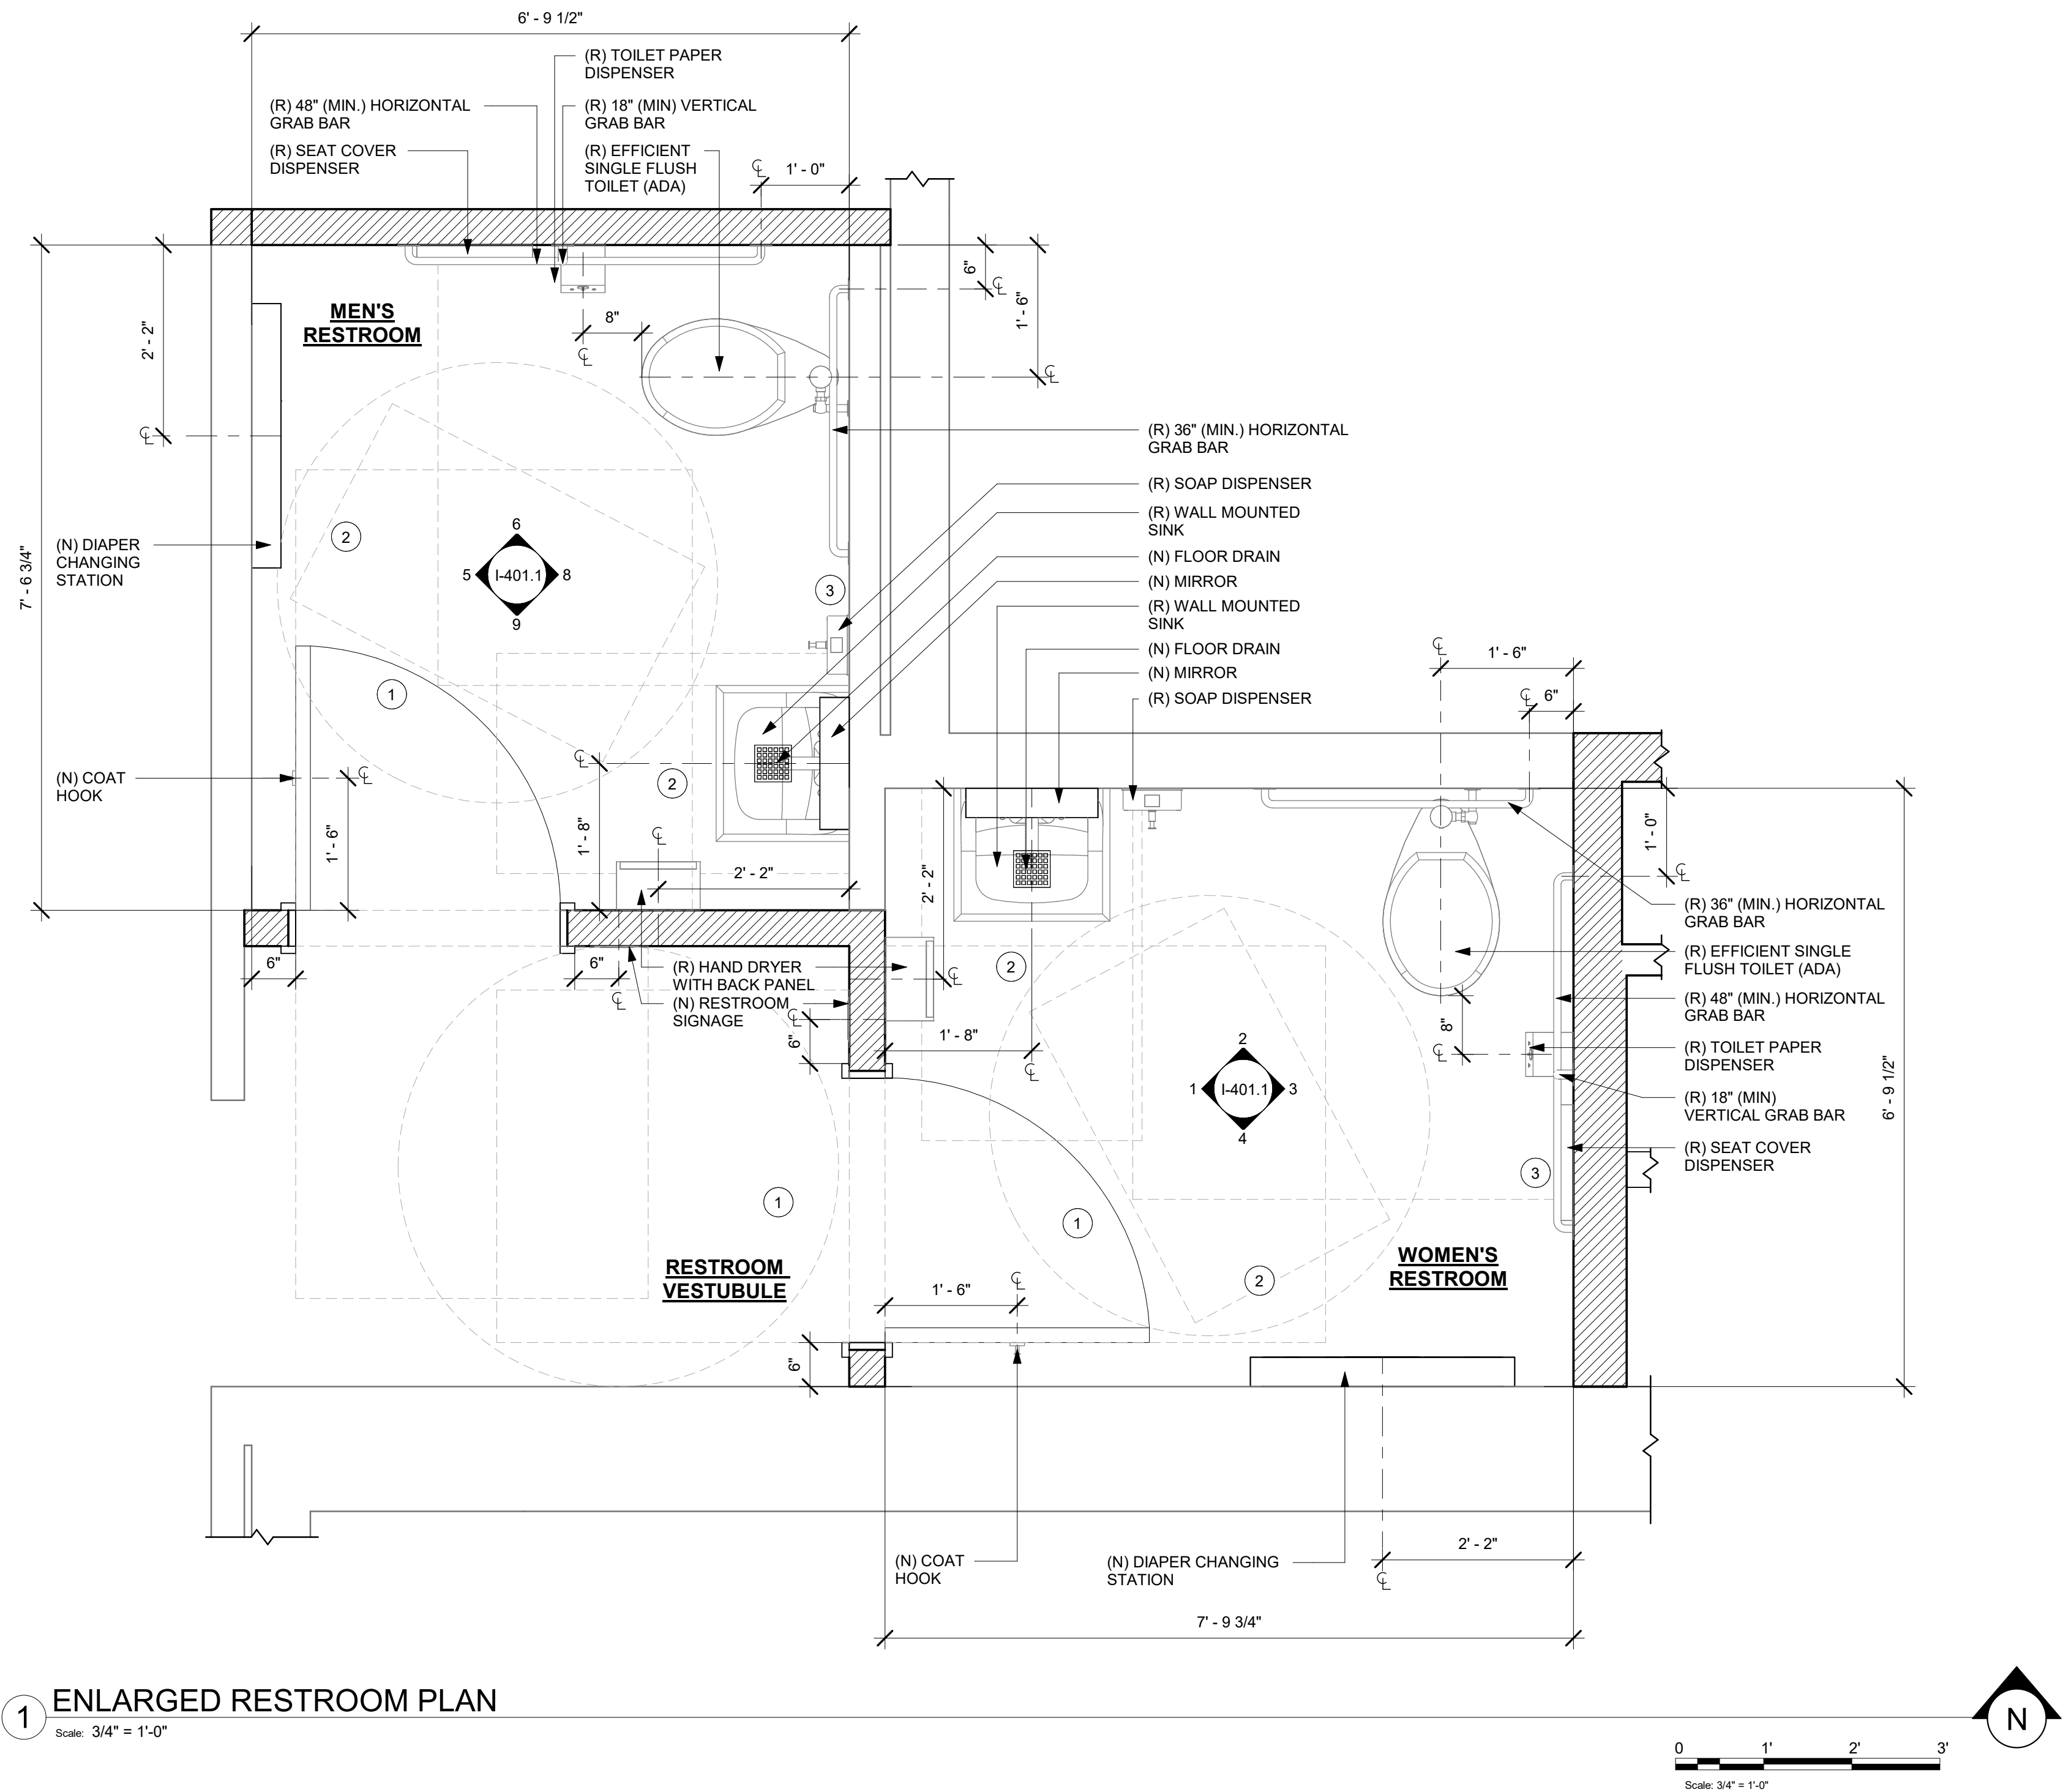

GENERAL NOTES

- GENERAL CONTRACTOR TO VERIFY ALL DIMENSIONS AND NOTIFY STARBUCKS CONSTRUCTION MANAGER OF ANY DISCREPANCIES PRIOR TO CONSTRUCTION.
- ALL DIMENSIONS ARE TO BE TAKEN FROM A DESIGNATED DATUM POINT.
- DIMENSIONS ARE TO FACE OF FINISHED SURFACE UNLESS OTHERWISE NOTED.
- DIAPER CHANGING STATION IS TO BE INSTALLED PER MANUFACTURER'S INSTRUCTIONS. UNIT IS TO BE FASTENED TO STRUCTURE AT ALL SIX CHASSIS ATTACHMENT POINTS.
- LOCATE DIAPER CHANGING STATION AS SHOWN TO ALLOW NECESSARY CLEARANCE FOR OPERATION OF ALL RESTROOM FIXTURES. LOCATION SHALL NOT IMPEDE ACCESS, EGRESS, OR DOOR SWING.
- ALL RESTROOM ACCESSORY MOUNTING HEIGHTS AND CLEARANCES SHALL COMPLY WITH THE ACCESSIBILITY REQUIREMENTS OF THE LOCAL JURISDICTION.

DIAPER CHANGING STATION NOTES

- CHANGING STATION IS TO BE INSTALLED PER MANUFACTURER'S INSTRUCTIONS. UNIT IS TO BE FASTENED TO STRUCTURE AT ALL SIX CHASSIS ATTACHMENT POINTS. STANDARD INSTALLATION IS ATTACHMENT TO WOOD STUDS AND/OR WOOD BLOCKING. FOR NON-STANDARD FRAMING CONDITIONS OTHER THAN CONCRETE, USE TOGGLER SNAPTOGGLE HEAVY DUTY TOGGLE BOLTS TO SECURELY ATTACH CHASSIS TO WALL. FOR CONCRETE WALLS, USE FISCHER S-PLUG FIXINGS TO ANCHOR FASTENERS. SUBSTITUTION OF FASTENERS OTHER THAN THE MANUFACTURER AND PRODUCT SPECIFIED IS NOT ALLOWED WITHOUT PRIOR APPROVAL. LOAD TEST AFTER INSTALLATION WITH 100 LB. WEIGHT FOR 15 MINUTES.
- LOCATE STATION AS SHOWN TO ALLOW NECESSARY CLEARANCE FOR OPERATION OF ALL RESTROOM FIXTURES. LOCATION SHALL NOT IMPEDE ACCESS, EGRESS, OR DOOR SWING. VERIFY ANY ALTERNATE LOCATION OR INSTALLATION APPROACH WITH STARBUCKS PROJECT LEAD.

KEYED NOTES

- 60" (1524MM) ADA TURNING DIAMETER.
- 30" (762MM) X 48" (1219MM) CLEAR FLOOR SPACE.
- RELOCATED 60" (1524MM) X 56" (1422MM) WATER CLOSET CLEAR FLOOR SPACE.

N - NEW
E - EXISTING
R - RELOCATED



STARBUCKS®
2401 UTAH AVENUE SOUTH
SEATTLE, WASHINGTON 98134
(206) 318-1575

THESE DRAWINGS AND THE PROJECT MANUAL ARE CONFIDENTIAL AND SHALL REMAIN THE SOLE PROPERTY OF STARBUCKS CORPORATION, WHICH IS THE OWNER OF THE COPYRIGHT IN THIS WORK. THEY SHALL NOT BE REPRODUCED IN WHOLE OR IN PART, SHARED WITH THIRD PARTIES OR USED IN ANY MANNER ON OTHER PROJECTS OR EXTENSIONS TO THIS PROJECT WITHOUT THE PRIOR WRITTEN CONSENT OF STARBUCKS CORPORATION. THESE DRAWINGS AND SPECIFICATIONS ARE INTENDED TO EXPRESS DESIGN INTENT FOR A PROTOTYPICAL STARBUCKS STORE (WHICH IS SUBJECT TO CHANGE AT ANYTIME) AND DO NOT REFLECT ACTUAL SITE CONDITIONS. NEITHER PARTY SHALL HAVE ANY OBLIGATION NOR LIABILITY TO THE OTHER (EXCEPT STATED ABOVE) UNTIL A WRITTEN AGREEMENT IS FULLY EXECUTED BY BOTH PARTIES.

STARBUCKS TEMPLATE VERSION: i2023.10.23

Design Forum Architects Inc.

2050 Byers Rd
Miami, FL 33136
Tel: (305) 804-7700

Donald J. Rethman
Architect In Charge
License: AR0017303



2230 PARK AVE, STE. 100, CINCINNATI, OH 45206
513.457.7131 - WWW.MARQUEENG.COM

FOR CONSTRUCTION

PROJECT NAME:
S SEMORAN BLVD & LEE VISTA BLVD


PROJECT ADDRESS:
**6605 S SEMORAN BLVD
ORLANDO, FL 32822**

STORE #: 9875
PROJECT #: 25630-101
ISSUE DATE: 03/04/2024
DESIGN MANAGER: MARTIN PEREZ
PRODUCTION DESIGNER: ANDY MCLOUD
CHECKED BY: DONALD RETHMAN


Revision Schedule			
Rev	Date	By	Description

SHEET TITLE:
ENLARGED RESTROOM PLAN
SCALE: 3/4" = 1'-0"


SHEET NUMBER:
I-401

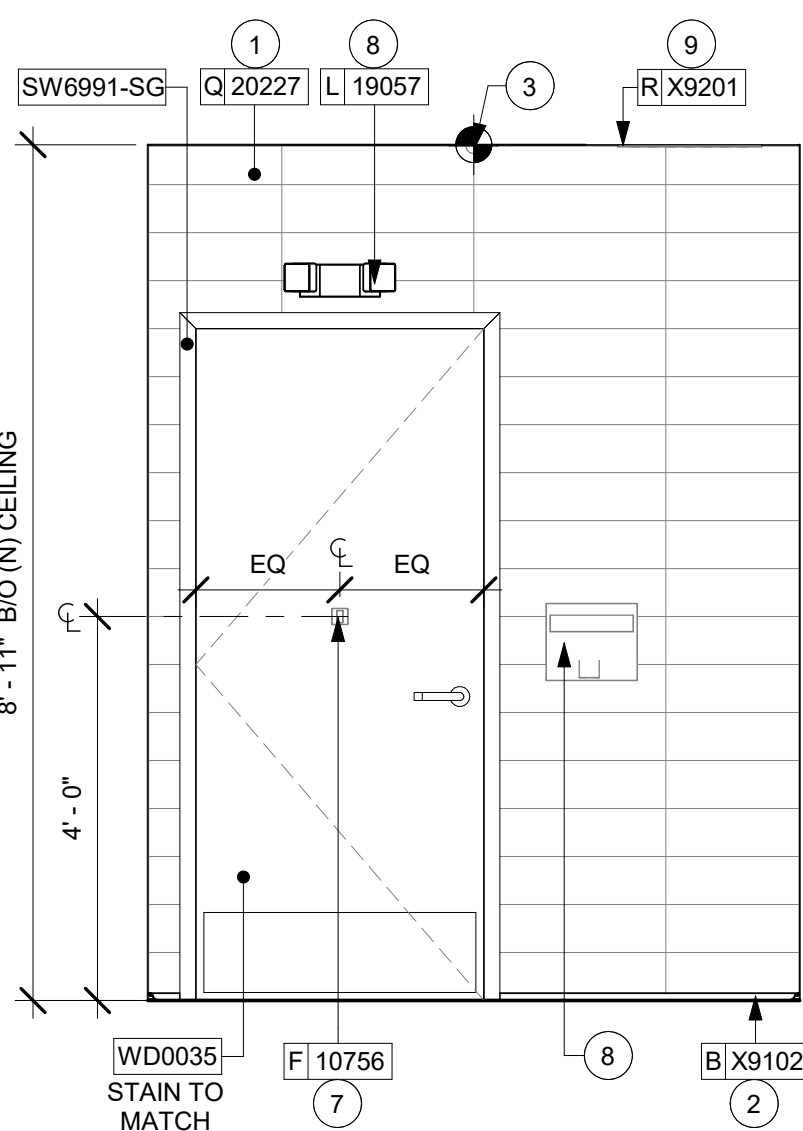


1 WOMEN'S RR - NORTH
Scale: 1/2" = 1'-0"

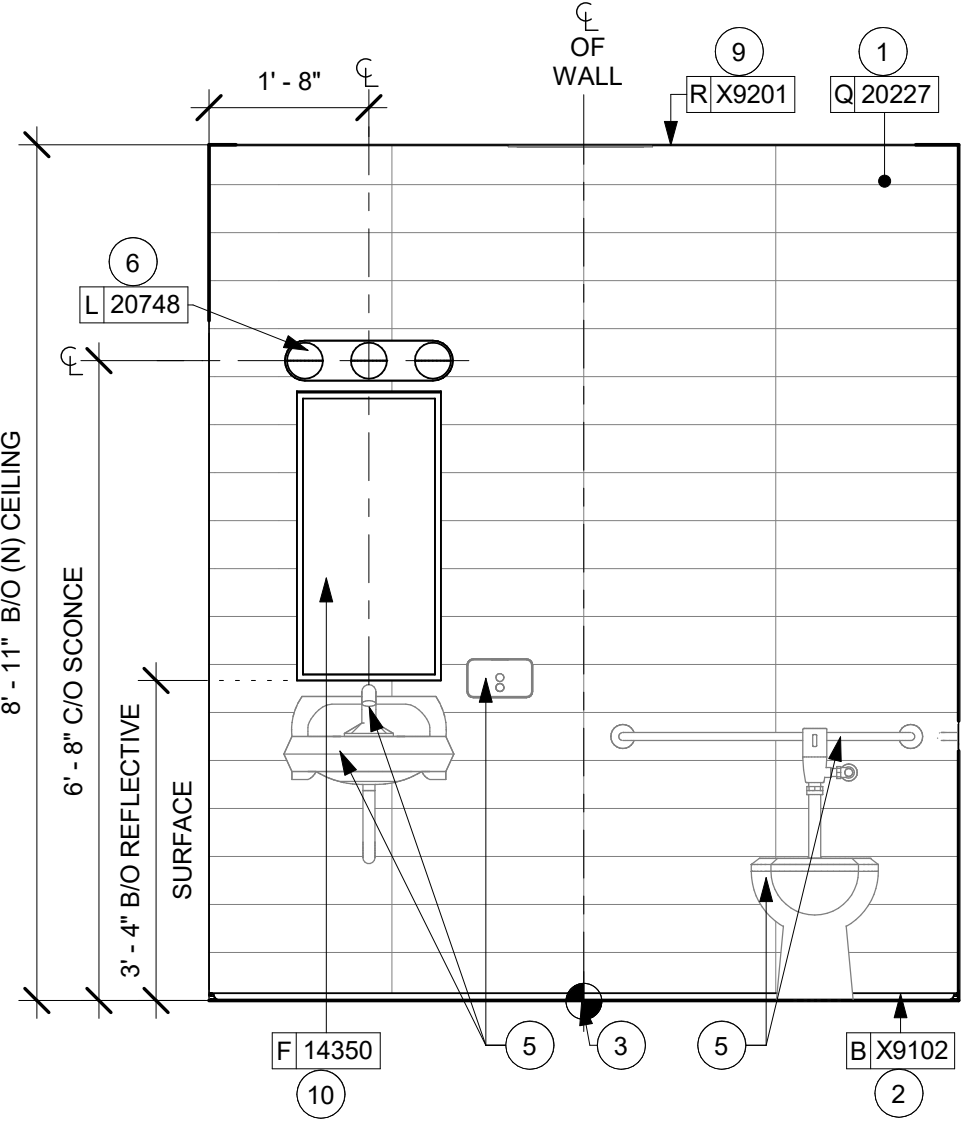


2 WOMEN'S RR - EAST
Scale: 1/2" = 1'-0"

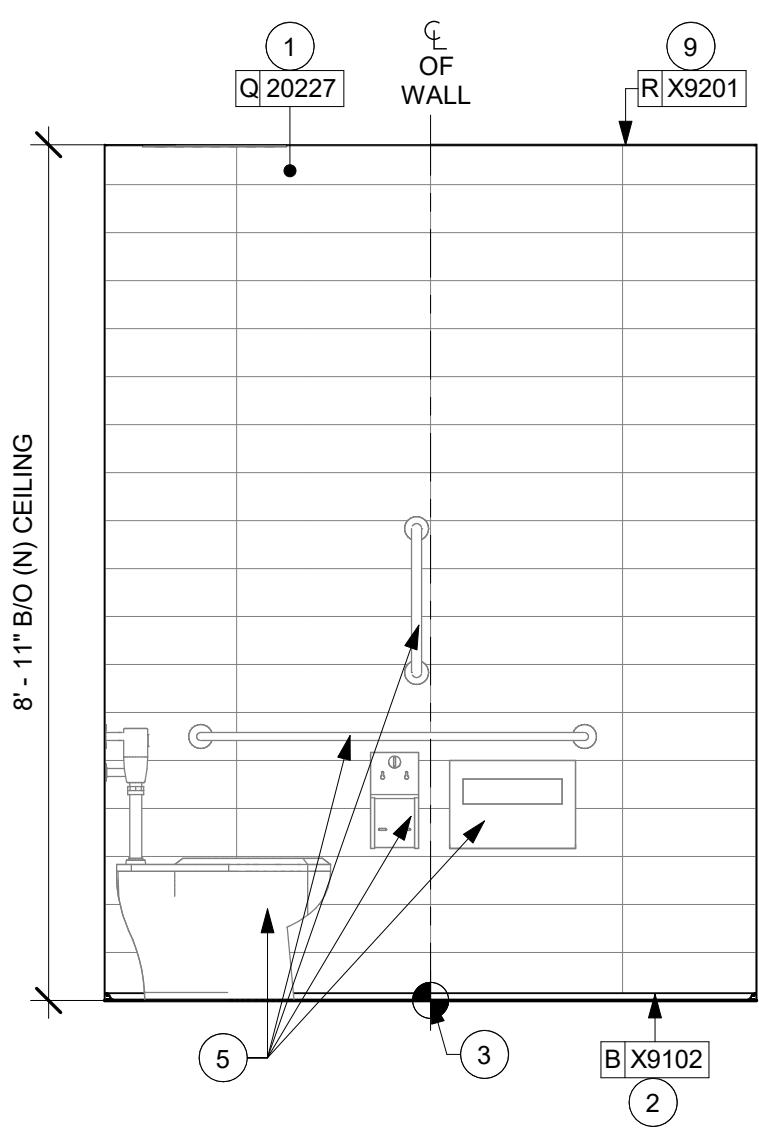


3 WOMEN'S RR - SOUTH
Scale: 1/2" = 1'-0"

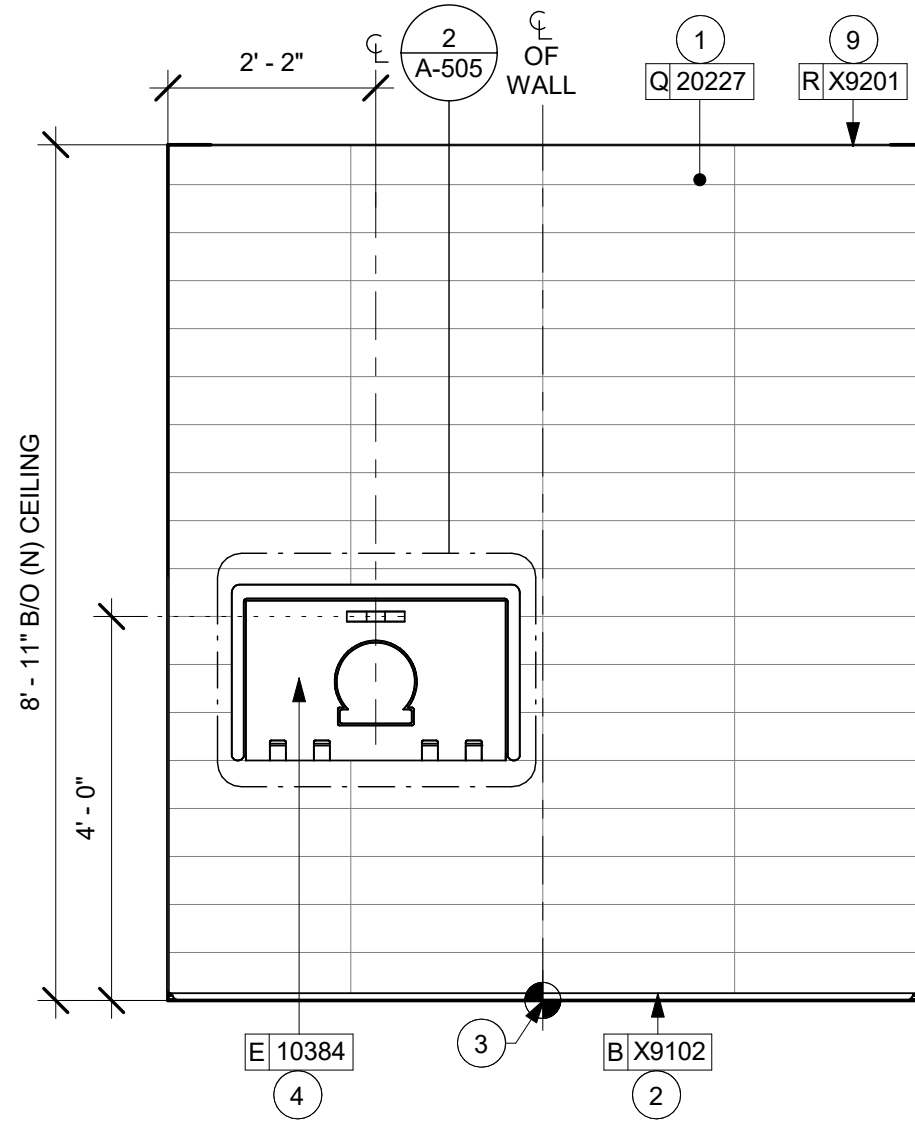


4 WOMEN'S RR - WEST
Scale: 1/2" = 1'-0"

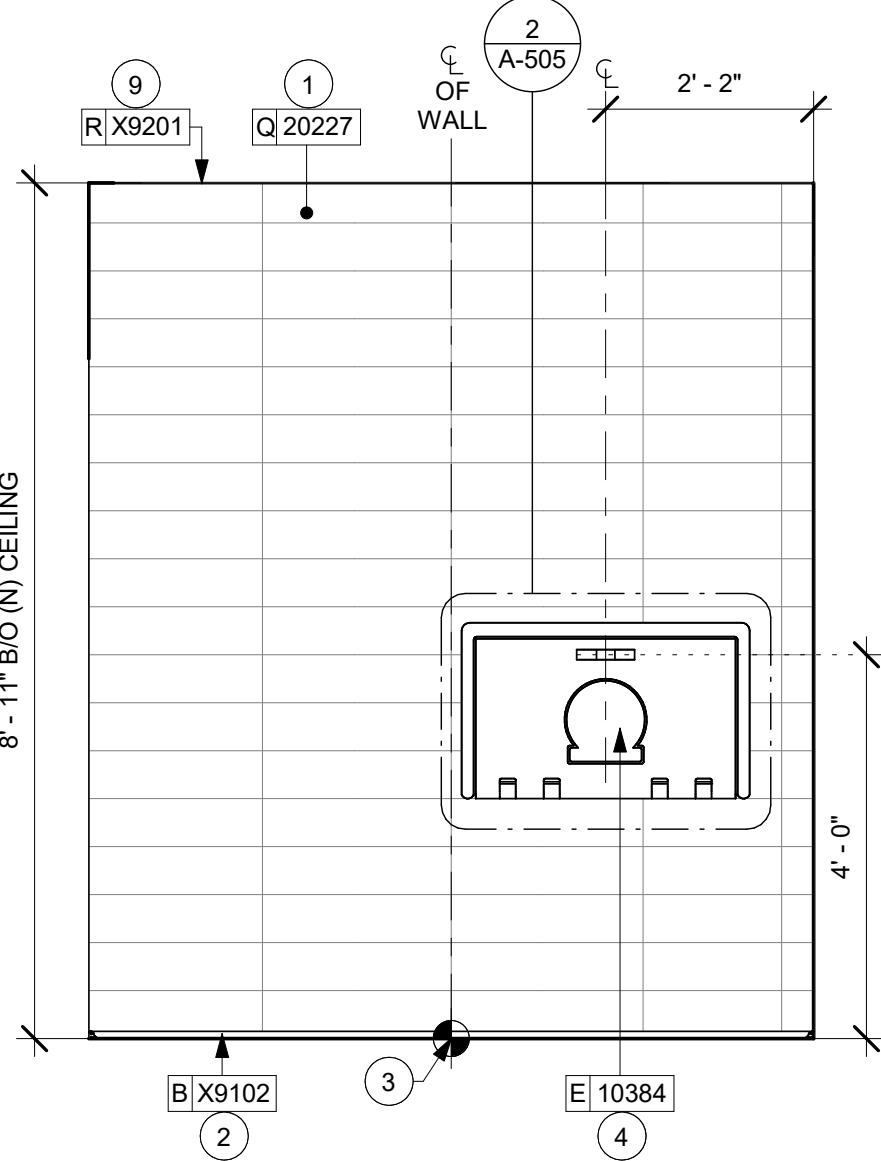


5 MEN'S RR - NORTH
Scale: 1/2" = 1'-0"

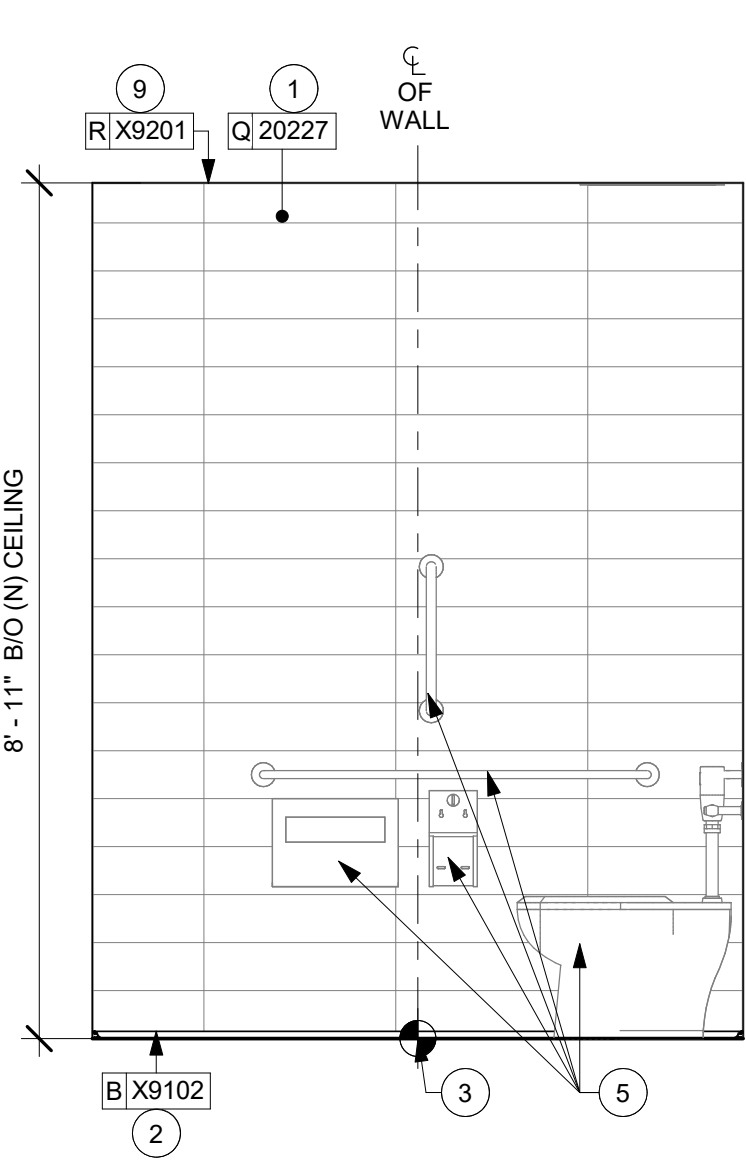


6 MEN'S RR - EAST
Scale: 1/2" = 1'-0"

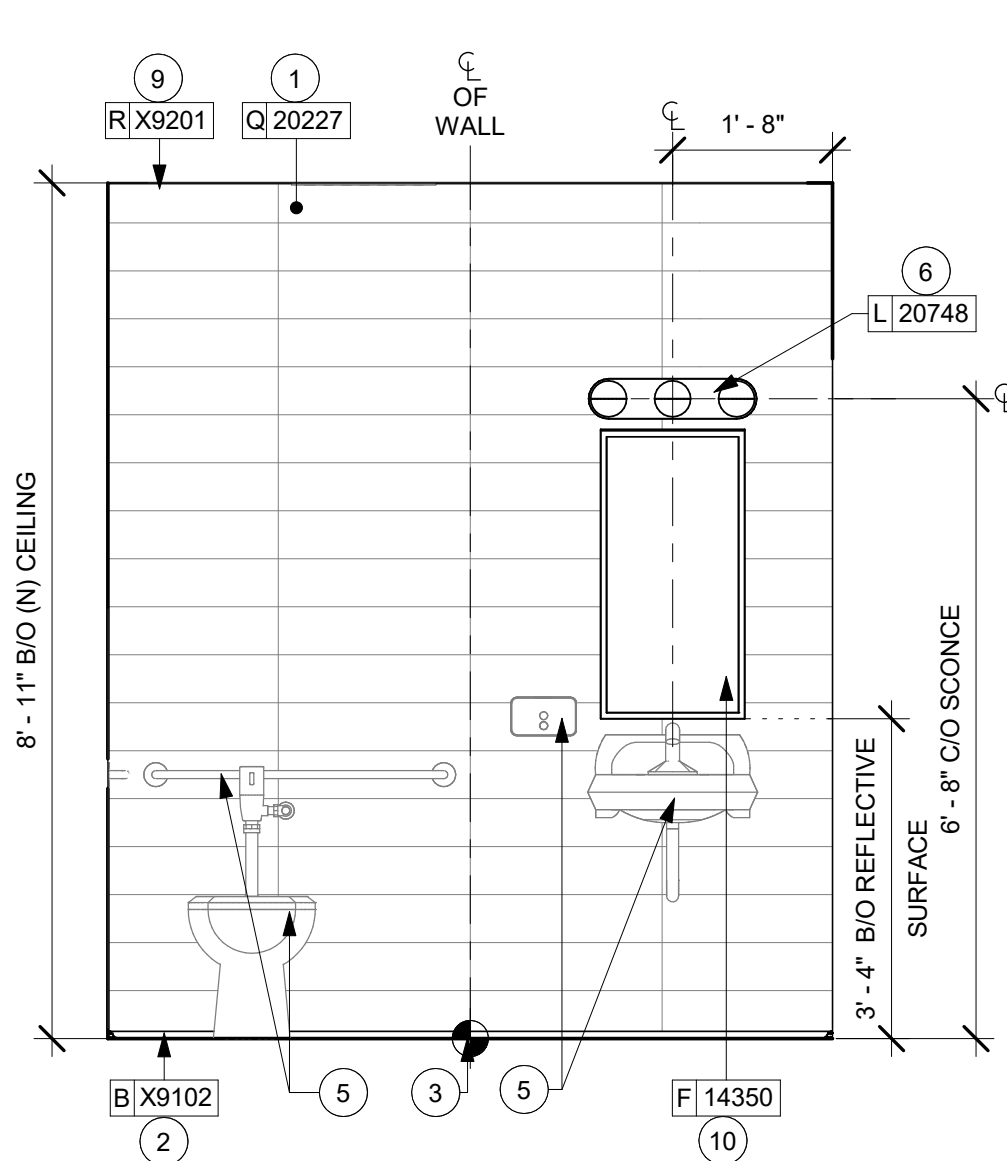

8 MEN'S RR - SOUTH
Scale: 1/2" = 1'-0"

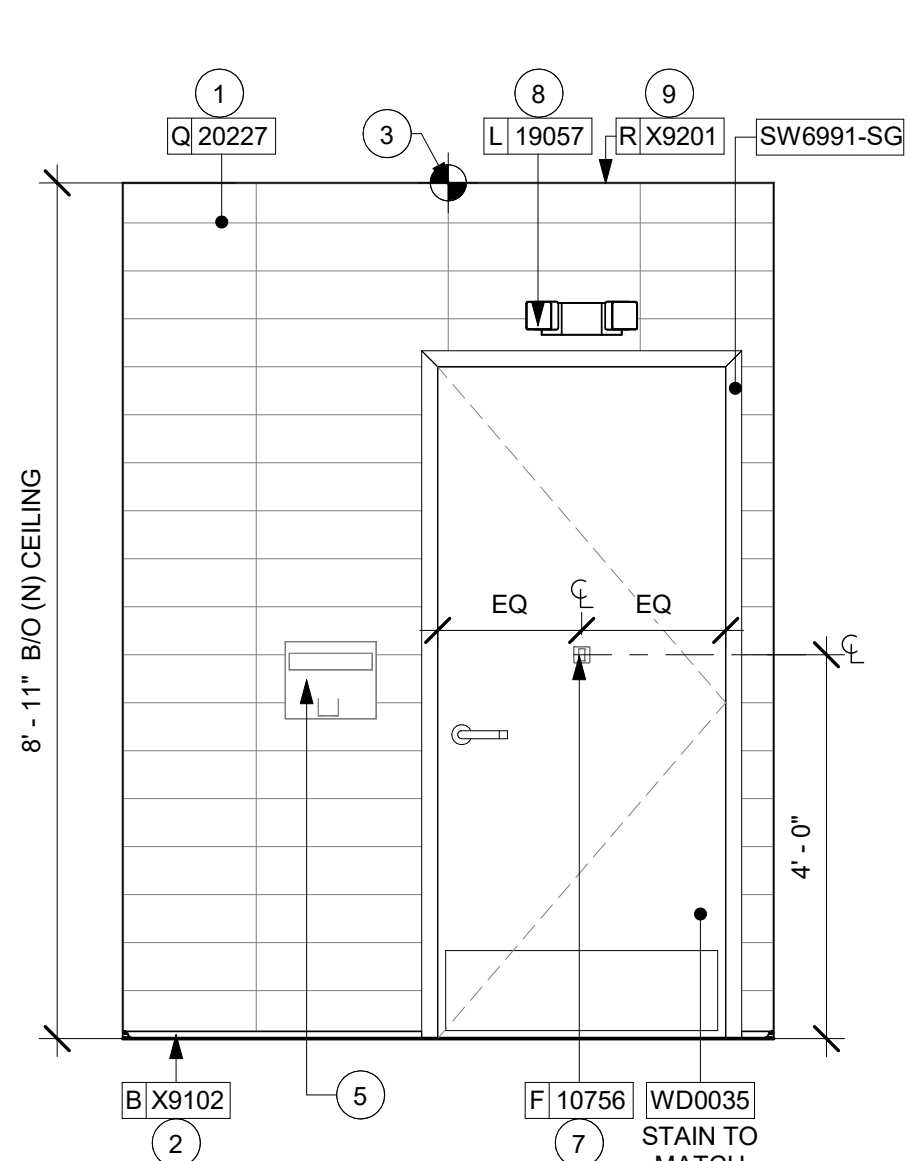

9 MEN'S RR - WEST
Scale: 1/2" = 1'-0"

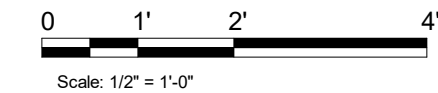

GENERAL NOTES

- GENERAL CONTRACTOR TO VERIFY ALL DIMENSIONS AND NOTIFY STARBUCKS CONSTRUCTION MANAGER OF ANY DISCREPANCIES PRIOR TO CONSTRUCTION.
- ALL DIMENSIONS ARE TO BE TAKEN FROM A DESIGNATED DATUM POINT.
- DIMENSIONS ARE TO FACE OF FINISHED SURFACE UNLESS OTHERWISE NOTED.
- DIAPER CHANGING STATION IS TO BE INSTALLED PER MANUFACTURER'S INSTRUCTIONS. UNIT IS TO BE FASTENED TO STRUCTURE AT ALL SIX CHASSIS ATTACHMENT POINTS.
- LOCATE DIAPER CHANGING STATION AS SHOWN TO ALLOW NECESSARY CLEARANCE FOR OPERATION OF ALL RESTROOM FIXTURES. LOCATION SHALL NOT IMPEDE ACCESS, EGRESS, OR DOOR SWING.
- ALL RESTROOM ACCESSORY MOUNTING HEIGHTS AND CLEARANCES SHALL COMPLY WITH THE ACCESSIBILITY REQUIREMENTS OF THE LOCAL JURISDICTION.

DIAPER CHANGING STATION NOTES

- CHANGING STATION IS TO BE INSTALLED PER MANUFACTURER'S INSTRUCTIONS. UNIT IS TO BE FASTENED TO STRUCTURE AT ALL SIX CHASSIS ATTACHMENT POINTS. STANDARD INSTALLATION IS ATTACHMENT TO WOOD STUDS AND/OR WOOD BLOCKING. FOR NON-STANDARD FRAMING CONDITIONS OTHER THAN CONCRETE, USE TOGGLER SHAPTOGGLE HEAVY DUTY TOGGLE BOLTS TO SECURELY ATTACH CHASSIS TO WALL. FOR CONCRETE WALLS, USE FISCHER S-PLUG FIXINGS TO ANCHOR FASTENERS. SUBSTITUTION OF FASTENERS OTHER THAN THE MANUFACTURER AND PRODUCT SPECIFIED IS NOT ALLOWED WITHOUT PRIOR APPROVAL. LOAD TEST AFTER INSTALLATION WITH 100 LB. WEIGHT FOR 15 MINUTES.
- LOCATE STATION AS SHOWN TO ALLOW NECESSARY CLEARANCE FOR OPERATION OF ALL RESTROOM FIXTURES. LOCATION SHALL NOT IMPEDE ACCESS, EGRESS, OR DOOR SWING. VERIFY ANY ALTERNATE LOCATION OR INSTALLATION APPROACH WITH STARBUCKS PROJECT LEAD.

KEYED NOTES

- INSTALL WALL TILE AT RESTROOMS AS INDICATED. SEE DETAIL ON SHEET A-505.
- INSTALL METAL SCHLUTER DILEX AHK COVE BASE AS INDICATED.
- TILE START POINT WHERE INDICATED.
- BABY CHANGING FIXTURE. GENERAL CONTRACTOR TO PROVIDE BLOCKING PER MANUFACTURER'S RECOMMENDATION.
- RELOCATED PLUMBING FIXTURES AND ACCESSORIES AS INDICATED.
- INSTALL NEW RESTROOM SCONCE AS INDICATED. REFER TO SHEET A-105 FOR MORE INFORMATION.
- INSTALL NEW COAT HOOK. MOUNT AT CENTERLINE OF DOOR.
- INSTALL NEW EMERGENCY LIGHT AS INDICATED.
- INSTALL JOLLY SCHLUTER TRIM AT T/O TILE AS INDICATED.
- CENTER MIRROR OVER LAVATORY. MOUNT AT 40" (1016MM) MAX. TO BOTTOM EDGE OF REFLECTIVE SURFACE.



© 2023 STARBUCKS COFFEE COMPANY

STARBUCKS®
2401 UTAH AVENUE SOUTH
SEATTLE, WASHINGTON 98134
(206) 318-1575

THESE DRAWINGS AND THE PROJECT MANUAL ARE CONFIDENTIAL AND SHALL REMAIN THE SOLE PROPERTY OF STARBUCKS CORPORATION, WHICH IS THE OWNER OF THE COPYRIGHT IN THIS WORK. THEY SHALL NOT BE REPRODUCED IN WHOLE OR IN PART, SHARED WITH THIRD PARTIES OR USED IN ANY MANNER ON OTHER PROJECTS OR EXTENSIONS TO THIS PROJECT WITHOUT THE PRIOR WRITTEN CONSENT OF STARBUCKS CORPORATION. THESE DRAWINGS AND SPECIFICATIONS ARE INTENDED TO EXPRESS DESIGN INTENT FOR A PROTOTYPICAL STARBUCKS STORE (WHICH IS SUBJECT TO CHANGE AT ANYTIME) AND DO NOT REFLECT ACTUAL SITE CONDITIONS. NEITHER PARTY SHALL HAVE ANY OBLIGATION NOR LIABILITY TO THE OTHER (EXCEPT STATED ABOVE) UNTIL A WRITTEN AGREEMENT IS FULLY EXECUTED BY BOTH PARTIES.

STARBUCKS TEMPLATE VERSION: i2023.10.23

Design Forum Architects Inc.

2050 Byers Rd
Miami, OH 45342
Tel: (614) 804-7700

Donald J. Reihman
Architect In Charge
License: AR0017303



2230 PARK AVE, STE. 100, CINCINNATI, OH 45206
513.457.7131 - WWW.MARQUEENG.COM

FOR CONSTRUCTION

PROJECT NAME:
S SEMORAN BLVD & LEE VISTA BLVD

PROJECT ADDRESS:
**6605 S SEMORAN BLVD
ORLANDO, FL 32822**


STORE #: 9875
PROJECT #: 25630-101
ISSUE DATE: 03/04/2024
DESIGN MANAGER: MARTIN PEREZ
PRODUCTION DESIGNER: ANDY MCLOUD
CHECKED BY: DONALD REHMAN

Revision Schedule			
Rev	Date	By	Description


SHEET TITLE:
ENLARGED RESTROOM ELEVATIONS
SCALE: 1/2" = 1'-0"

SHEET NUMBER:
I-401.1


3/4/2024 2:40:02 PM \\file-day.ad.changepinc.com\Client\StarbucksArchitecture\Projects_2023\Florida\Semoran & Lee Vista -25630-10\25630-101_9875_S Semoran Blvd & Lee Vista Blvd, FL_2023.rvt

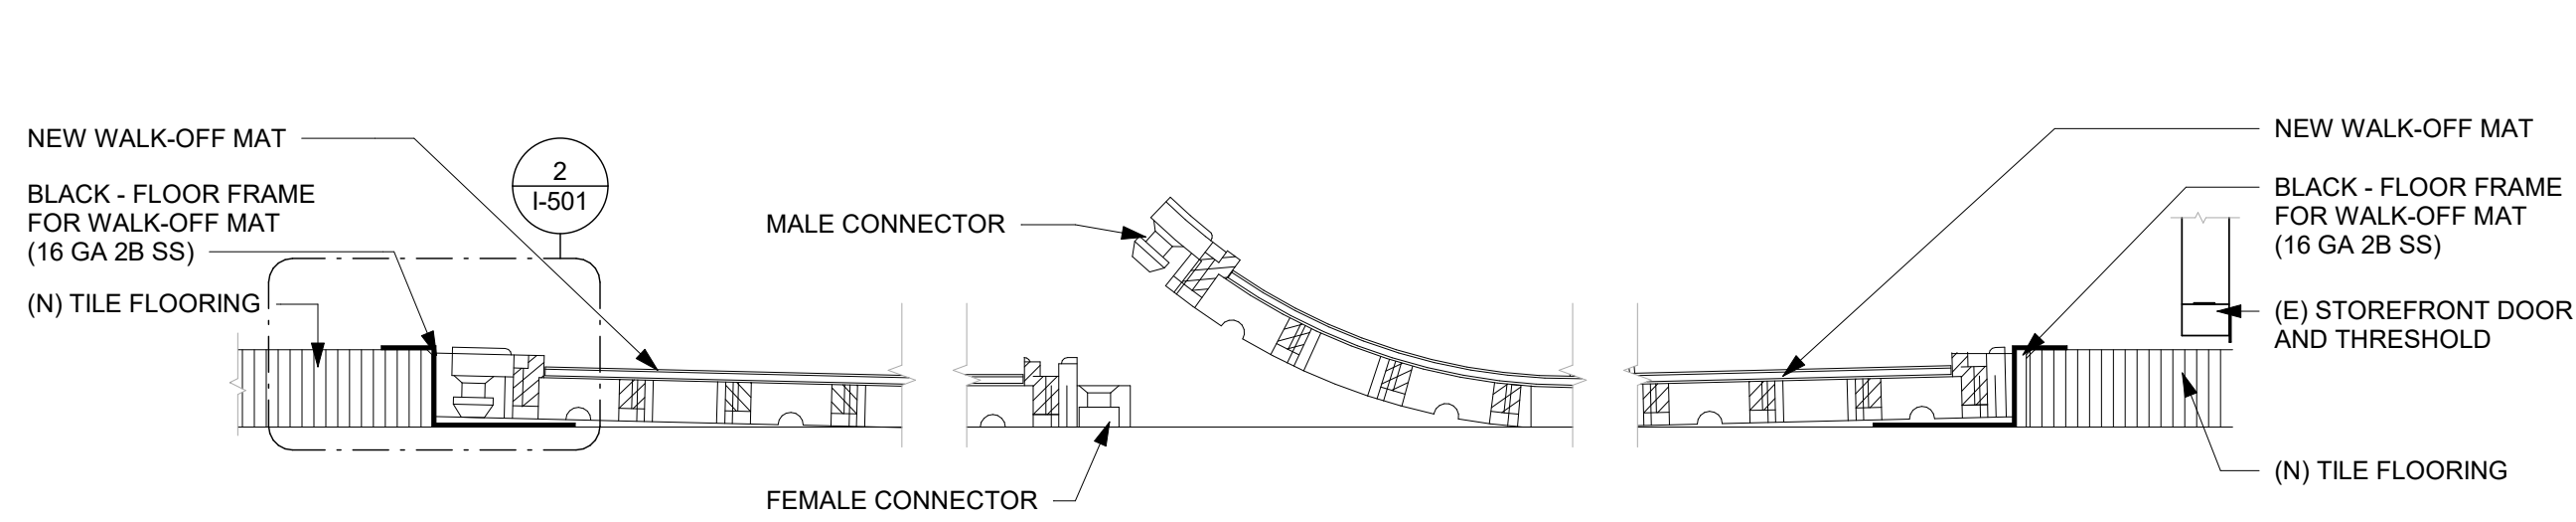


1 TRANSITION - TILE TO WALK-OFF MAT
Scale: 1" = 1'-0"

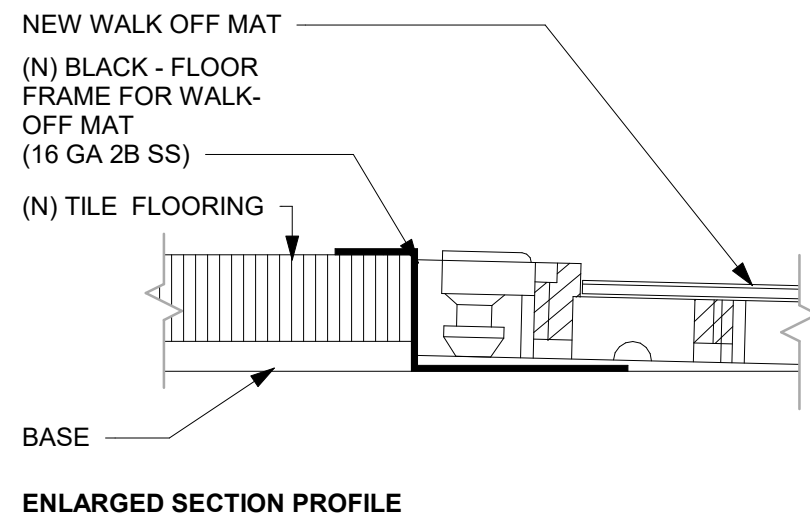


2 ENLARGED SECTION PROFILE
Scale: 1 1/2" = 1'-0"

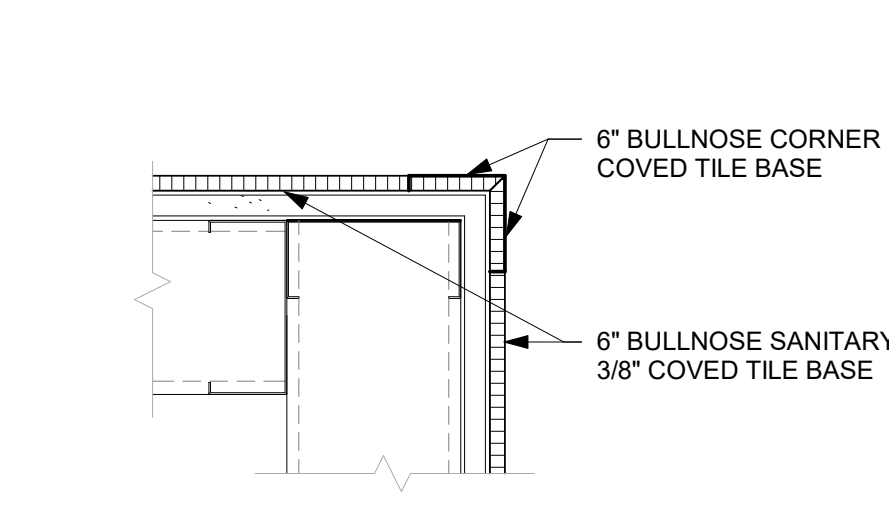


3 TILE BASE AT OUTSIDE CORNER
Scale: 3" = 1'-0"

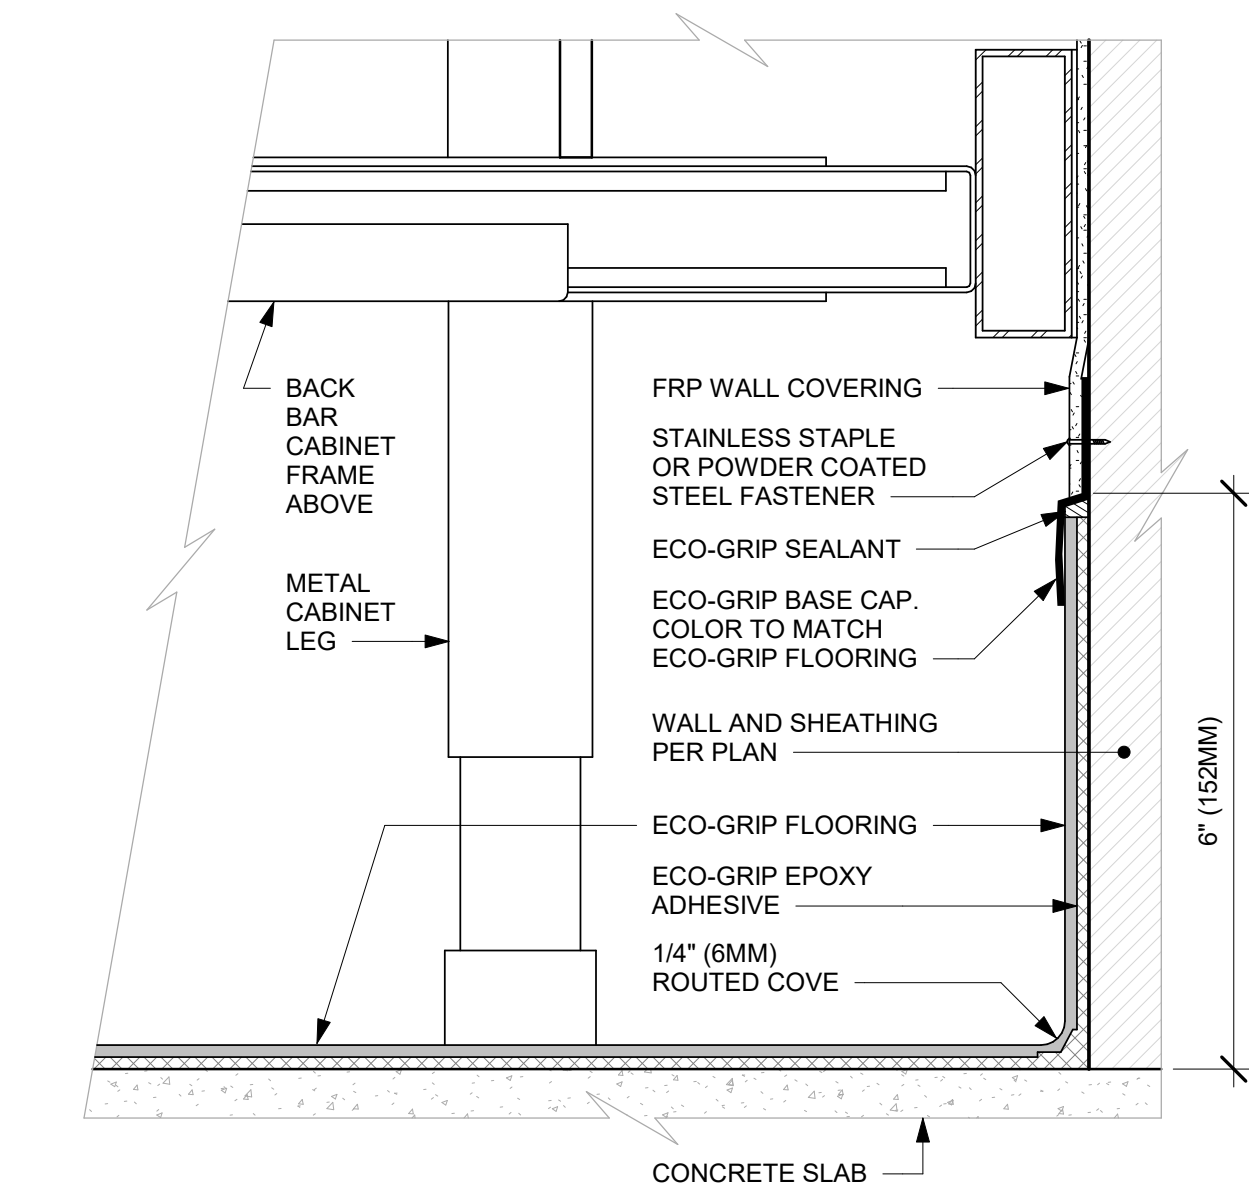


4 ECO-GRIP AC BACK BAR CABINET ON LEGS
Scale: 6" = 1'-0"

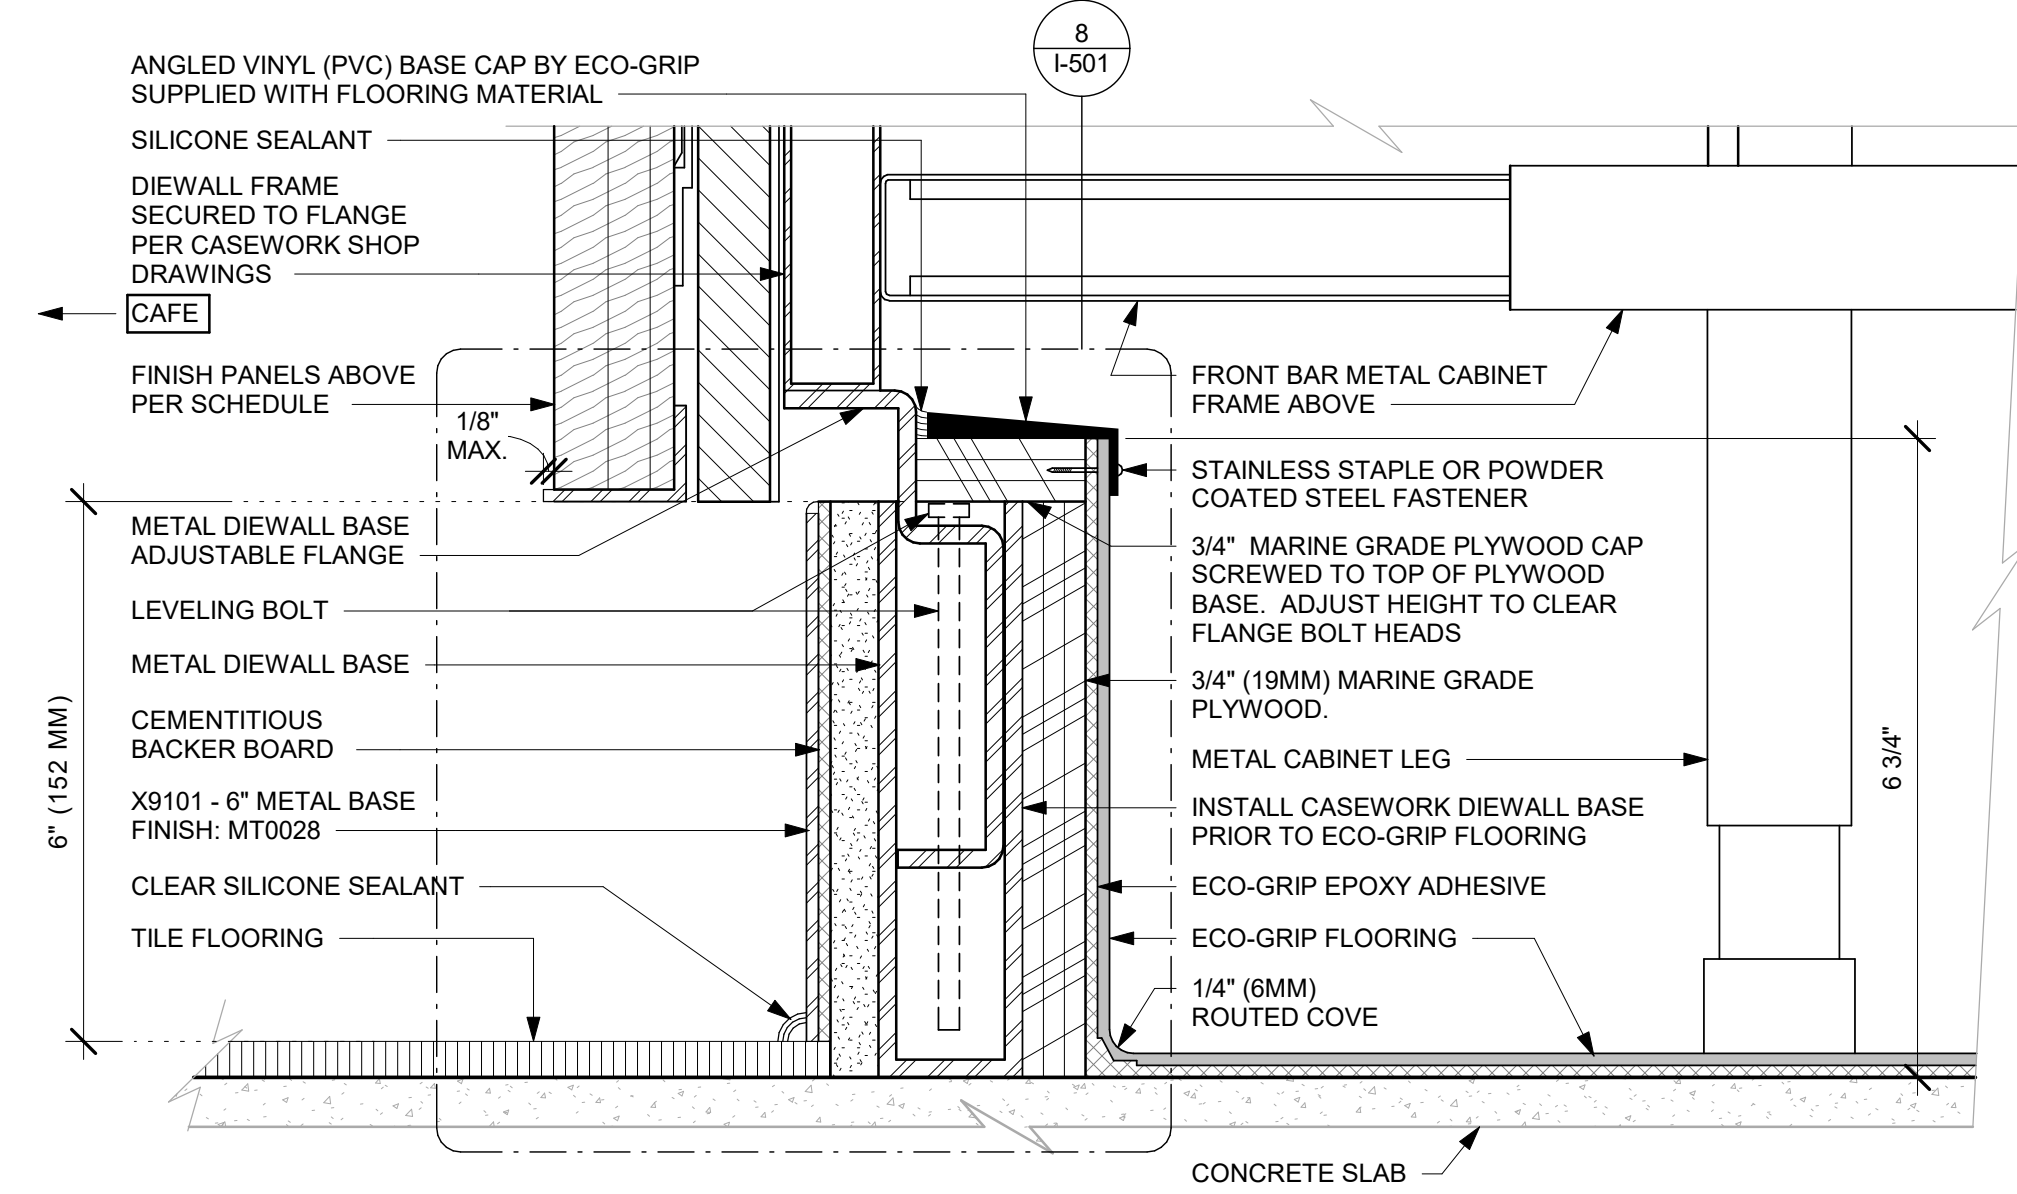


5 TILE BASE AC FRONT BAR CABINET ON LEGS
Scale: 6" = 1'-0"

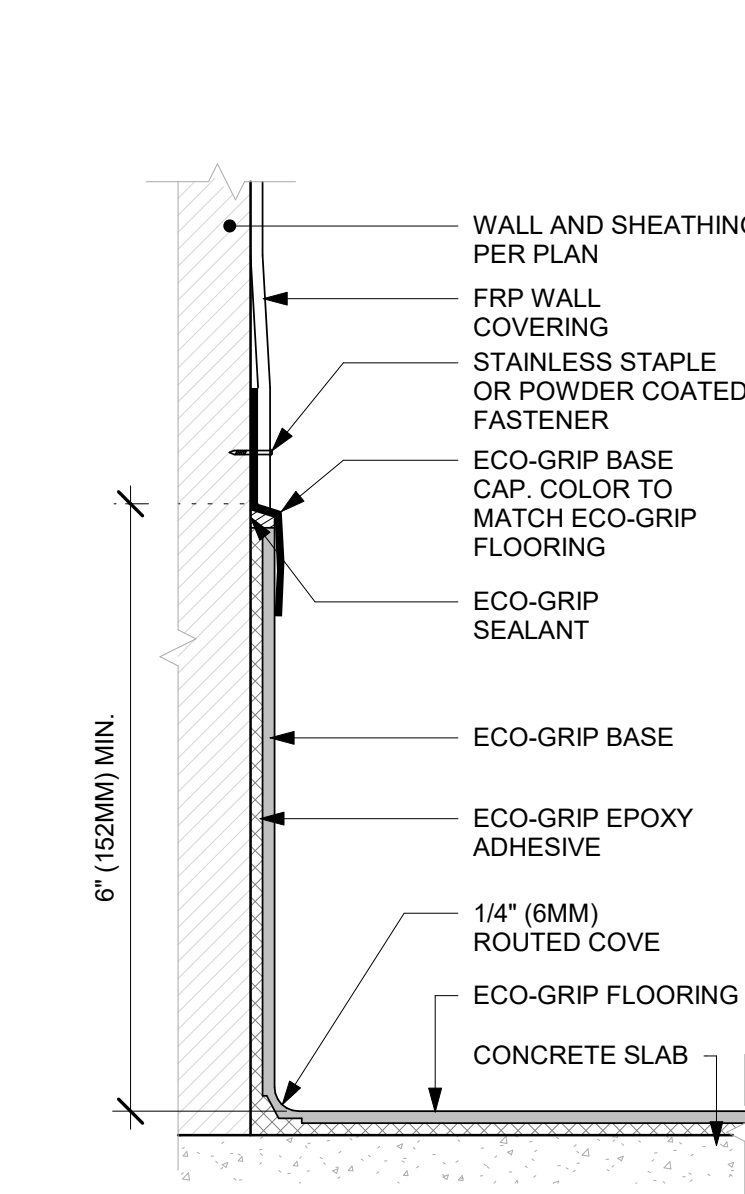


6 ECO-GRIP BASE CAP WITH FRP
Scale: 6" = 1'-0"

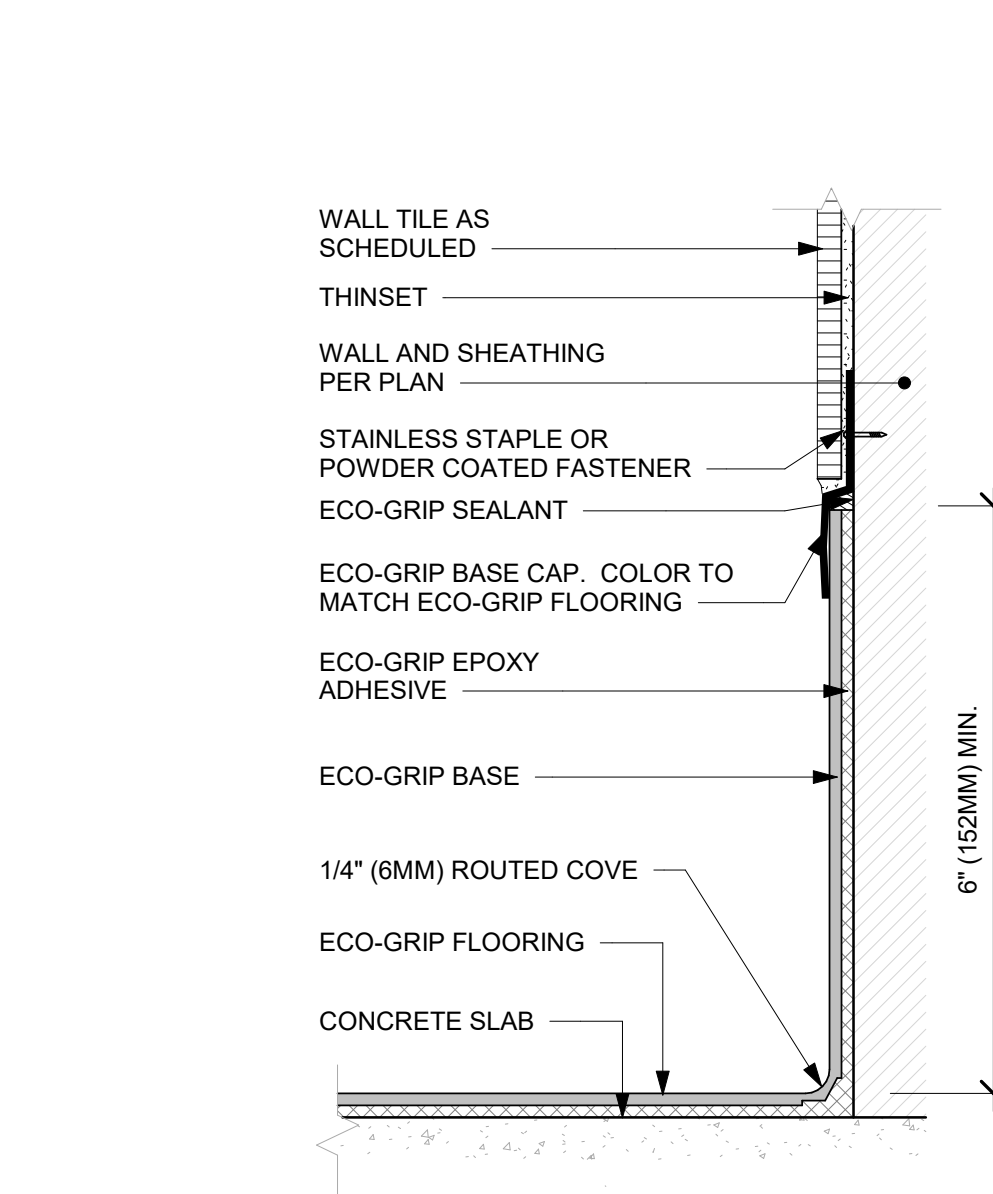


7 ECO-GRIP BASE CAP WITH TILED WALL
Scale: 6" = 1'-0"

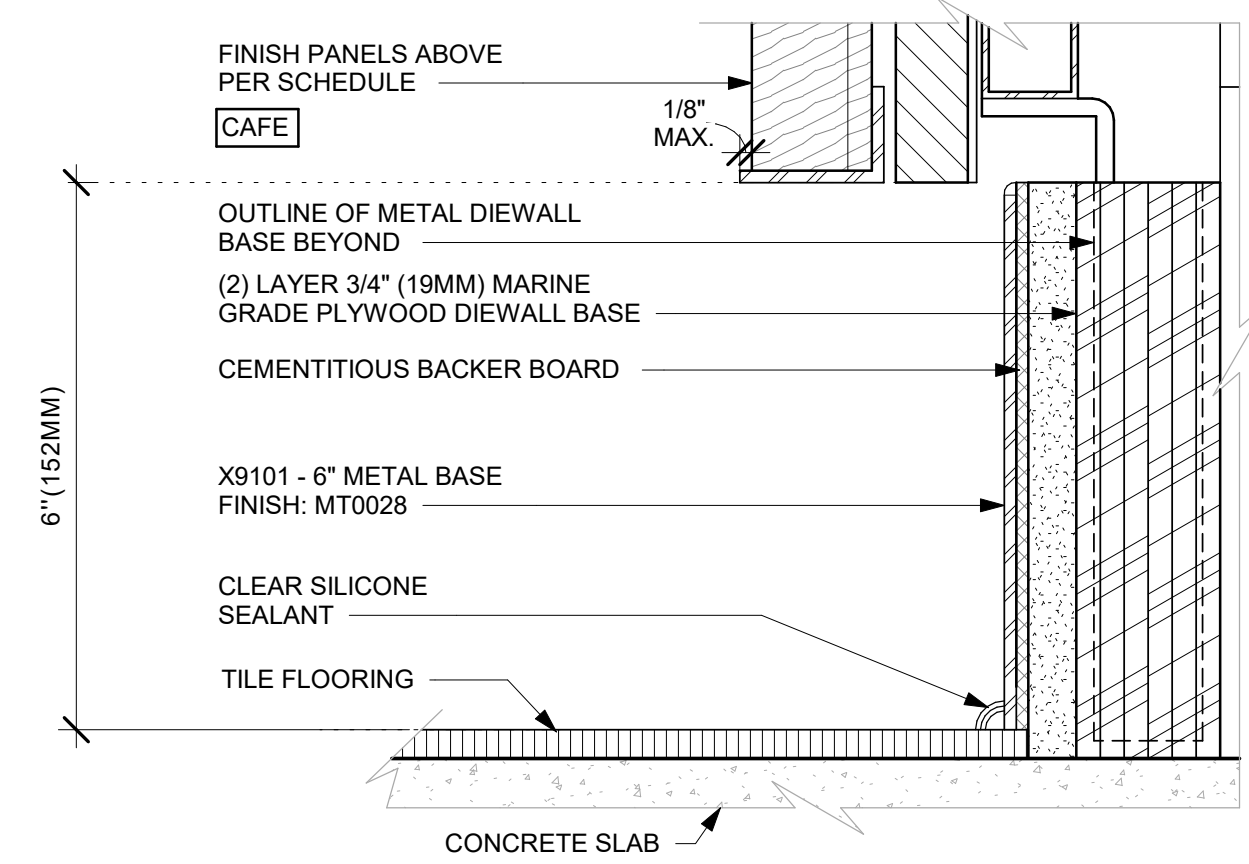


8 AC FRONT BAR CABINET PLYWOOD DIEWALL BASE
Scale: 6" = 1'-0"

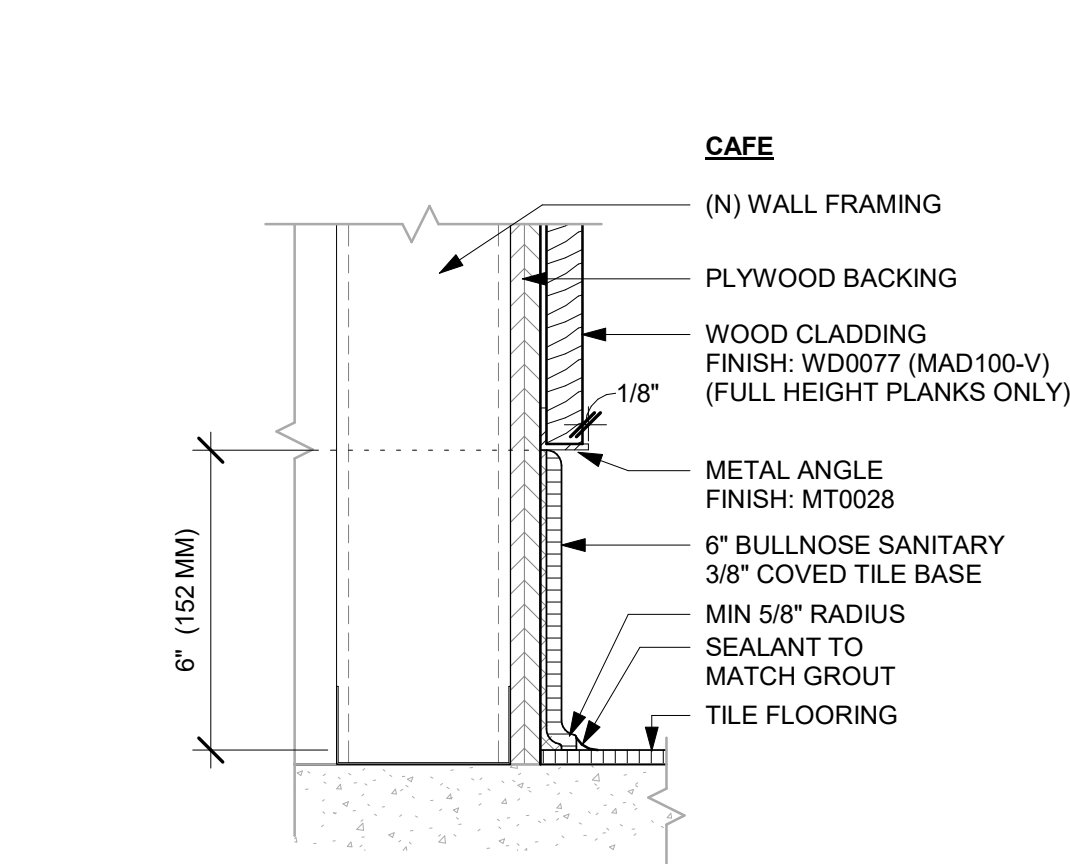


9 TILE BASE AT WOOD CLADDING
Scale: 3" = 1'-0"

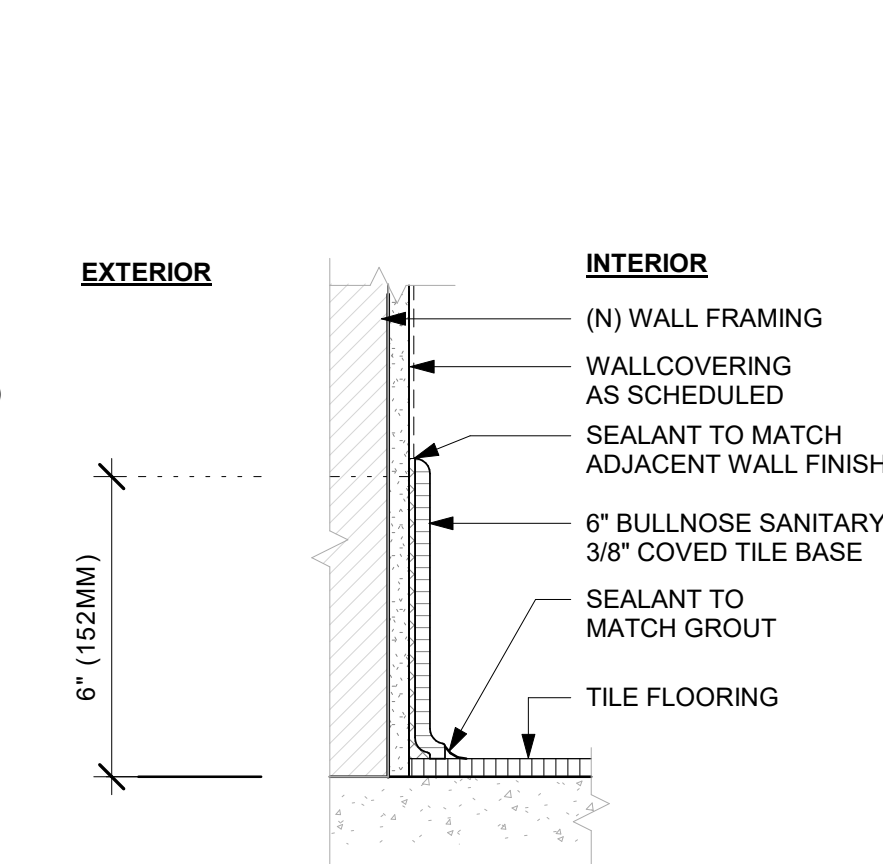


10 TILE BASE AT EXTERIOR WALL
Scale: 3" = 1'-0"

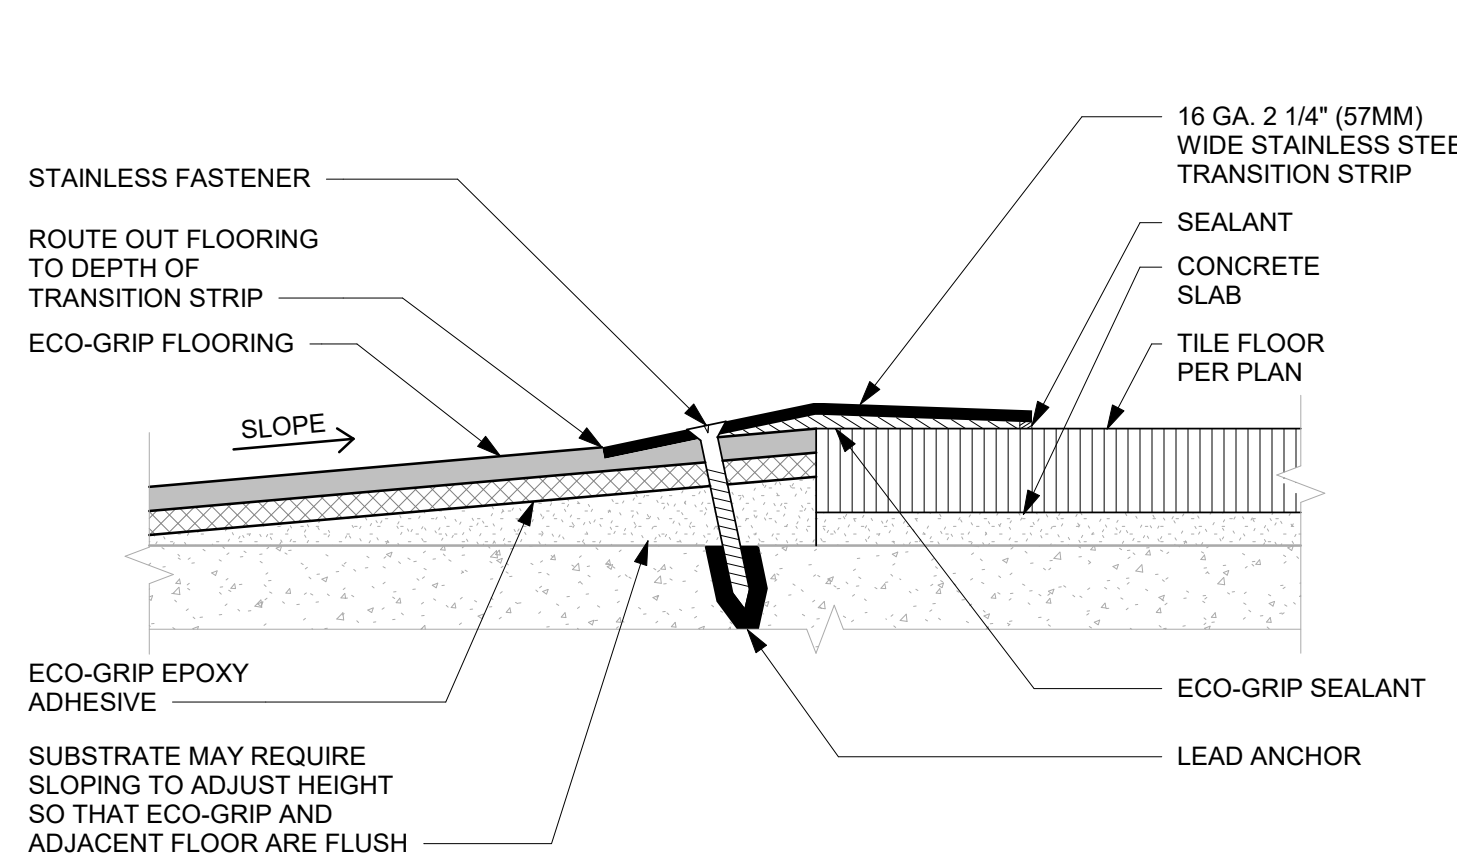

11 ECO-GRIP TO TILE TRANSITION AT FOOT TRAFFIC AREA
Scale: 12" = 1'-0"

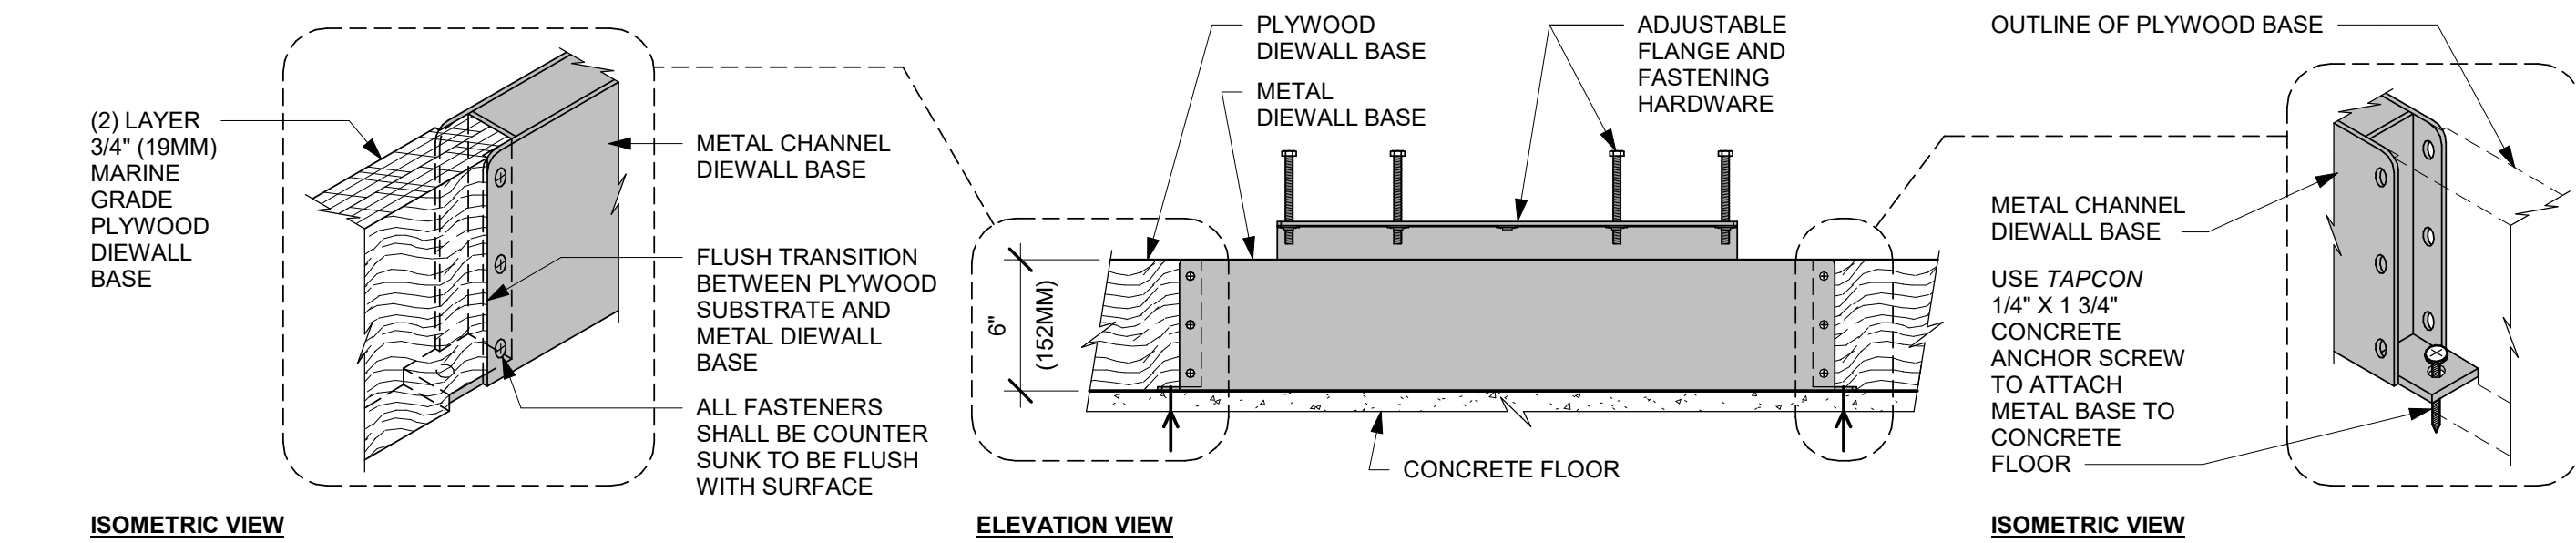

12 AC FRONT BAR DIEWALL METAL TO WOOD BASE TRANSITION
Scale: 1 1/2" = 1'-0"

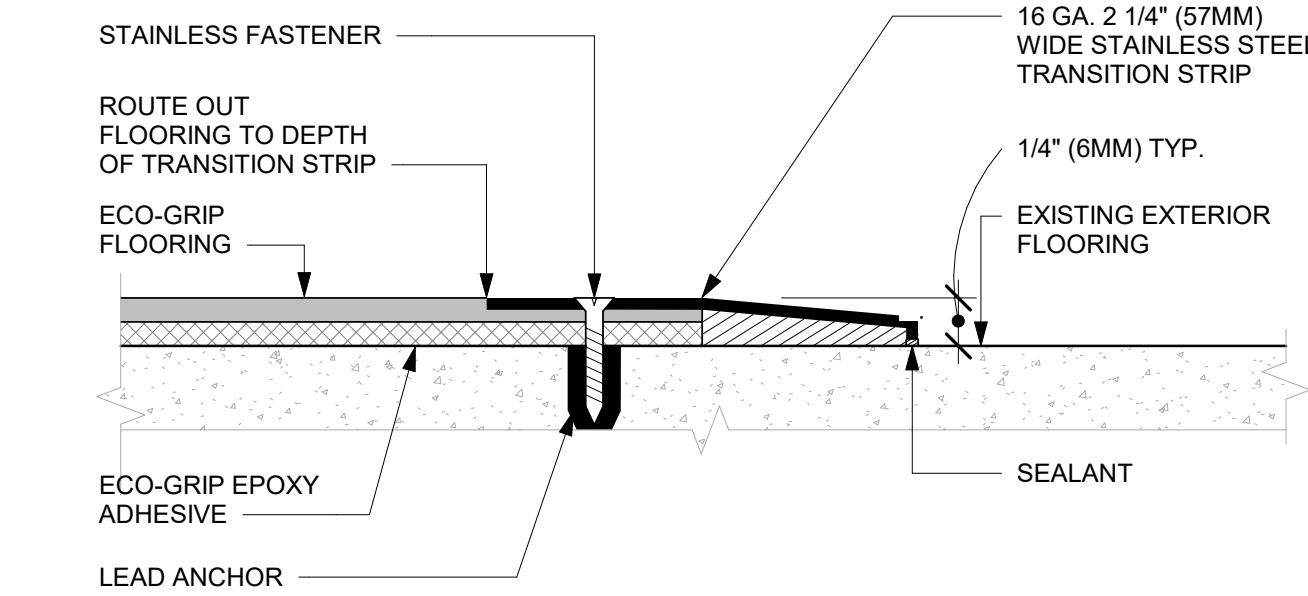

13 ECO-GRIP TO (E) CONCRETE TRANSITION
Scale: 12" = 1'-0"



STARBUCKS
2401 UTAH AVENUE SOUTH
SEATTLE, WASHINGTON 98134
(206) 318-1575

THESE DRAWINGS AND THE PROJECT MANUAL ARE CONFIDENTIAL AND SHALL REMAIN THE SOLE PROPERTY OF STARBUCKS CORPORATION, WHICH IS THE OWNER OF THE COPYRIGHT IN THIS WORK. THEY SHALL NOT BE REPRODUCED IN WHOLE OR IN PART, SHARED WITH THIRD PARTIES OR USED IN ANY MANNER ON OTHER PROJECTS OR EXTENSIONS TO THIS PROJECT WITHOUT THE PRIOR WRITTEN CONSENT OF STARBUCKS CORPORATION. THESE DRAWINGS AND SPECIFICATIONS ARE INTENDED TO EXPRESS DESIGN INTENT FOR A PROTOTYPICAL STARBUCKS STORE (WHICH IS SUBJECT TO CHANGE AT ANYTIME) AND DO NOT REFLECT ACTUAL SITE CONDITIONS. NEITHER PARTY SHALL HAVE ANY OBLIGATION NOR LIABILITY TO THE OTHER (EXCEPT STATED ABOVE) UNTIL A WRITTEN AGREEMENT IS FULLY EXECUTED BY BOTH PARTIES.

STARBUCKS TEMPLATE VERSION: i2023.10.23

Design Forum Architects Inc.

2050 Byers Rd
Miami, FL 33134
Tel: (844) 804-7700

MARQUE ENGINEERING
2230 PARK AVE, STE. 100, CINCINNATI, OH 45206
513.457.7131 - WWW.MARQUEENG.COM

FOR CONSTRUCTION

PROJECT NAME:
S SEMORAN BLVD & LEE VISTA BLVD

PROJECT ADDRESS:
**6605 S SEMORAN BLVD
ORLANDO, FL 32822**

STORE #: 9875
PROJECT #: 25630-101
ISSUE DATE: 03/04/2024
DESIGN MANAGER: MARTIN PEREZ
PRODUCTION DESIGNER: ANDY MCLOUD
CHECKED BY: DONALD RETHMAN

Revision Schedule				
Rev	Date	By	Description	



SHEET TITLE:
FLOOR FINISH DETAILS

SCALE: AS SHOWN

SHEET NUMBER:



I-501

\\file-day.ad.changeupinc.com\Client\StarbucksArchitecture\Projects_2023\Florida\Semoran & Lee Vista -25630-101\25630-101_9875_S Semoran Blvd & Lee Vista Blvd, FL_2023.rvt 3/4/2024 2:40:04 PM

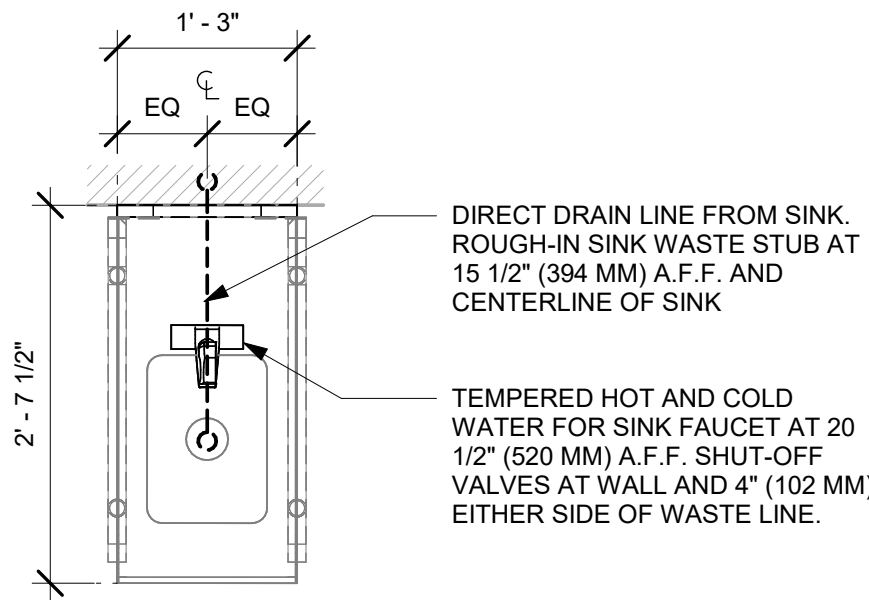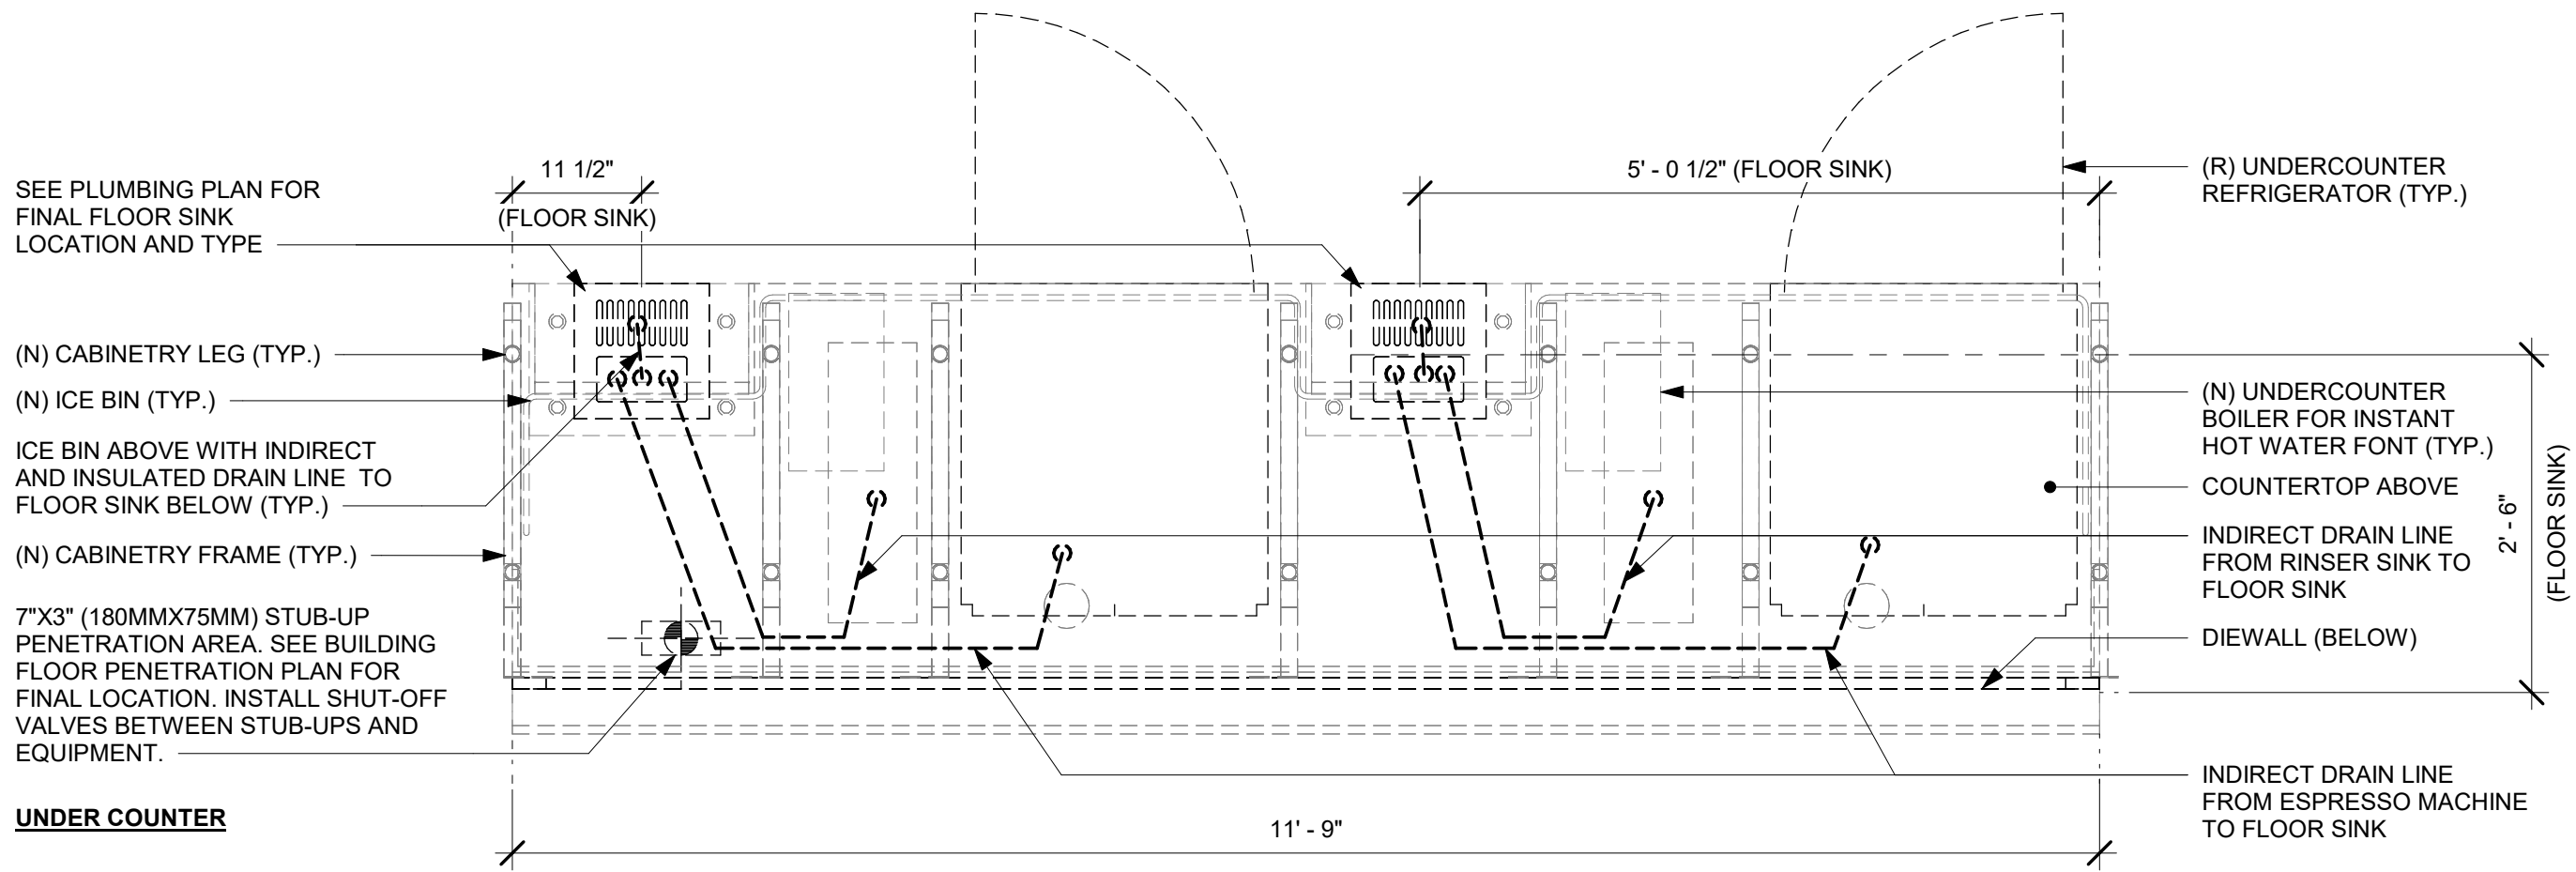



2 HAND SINK - PLUMBING FOR REFERENCE ONLY

Scale: 3/4" = 1'-0"

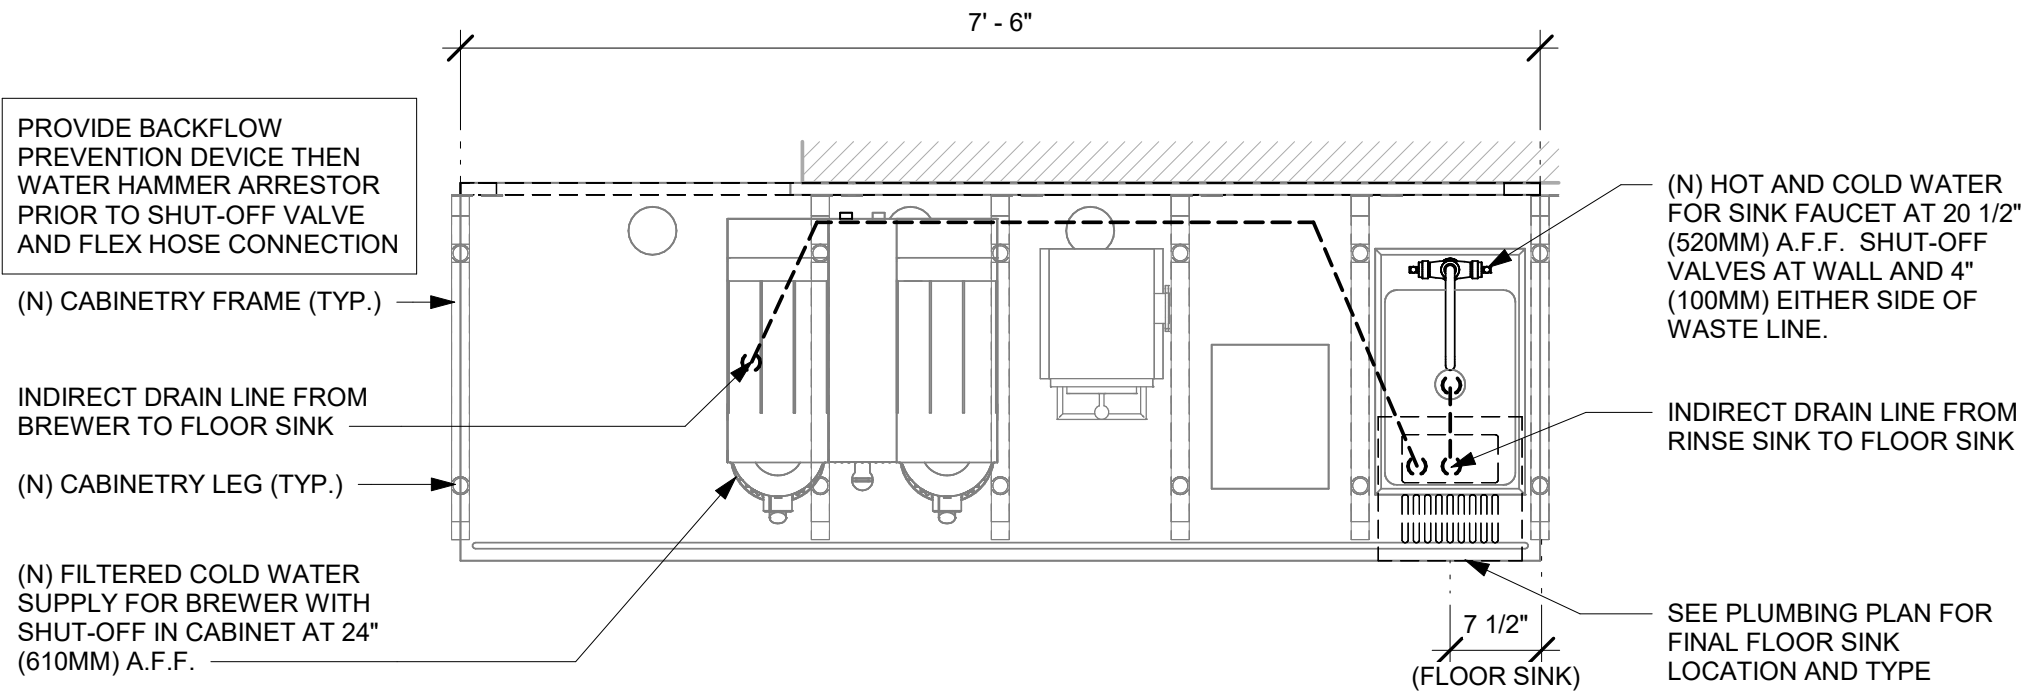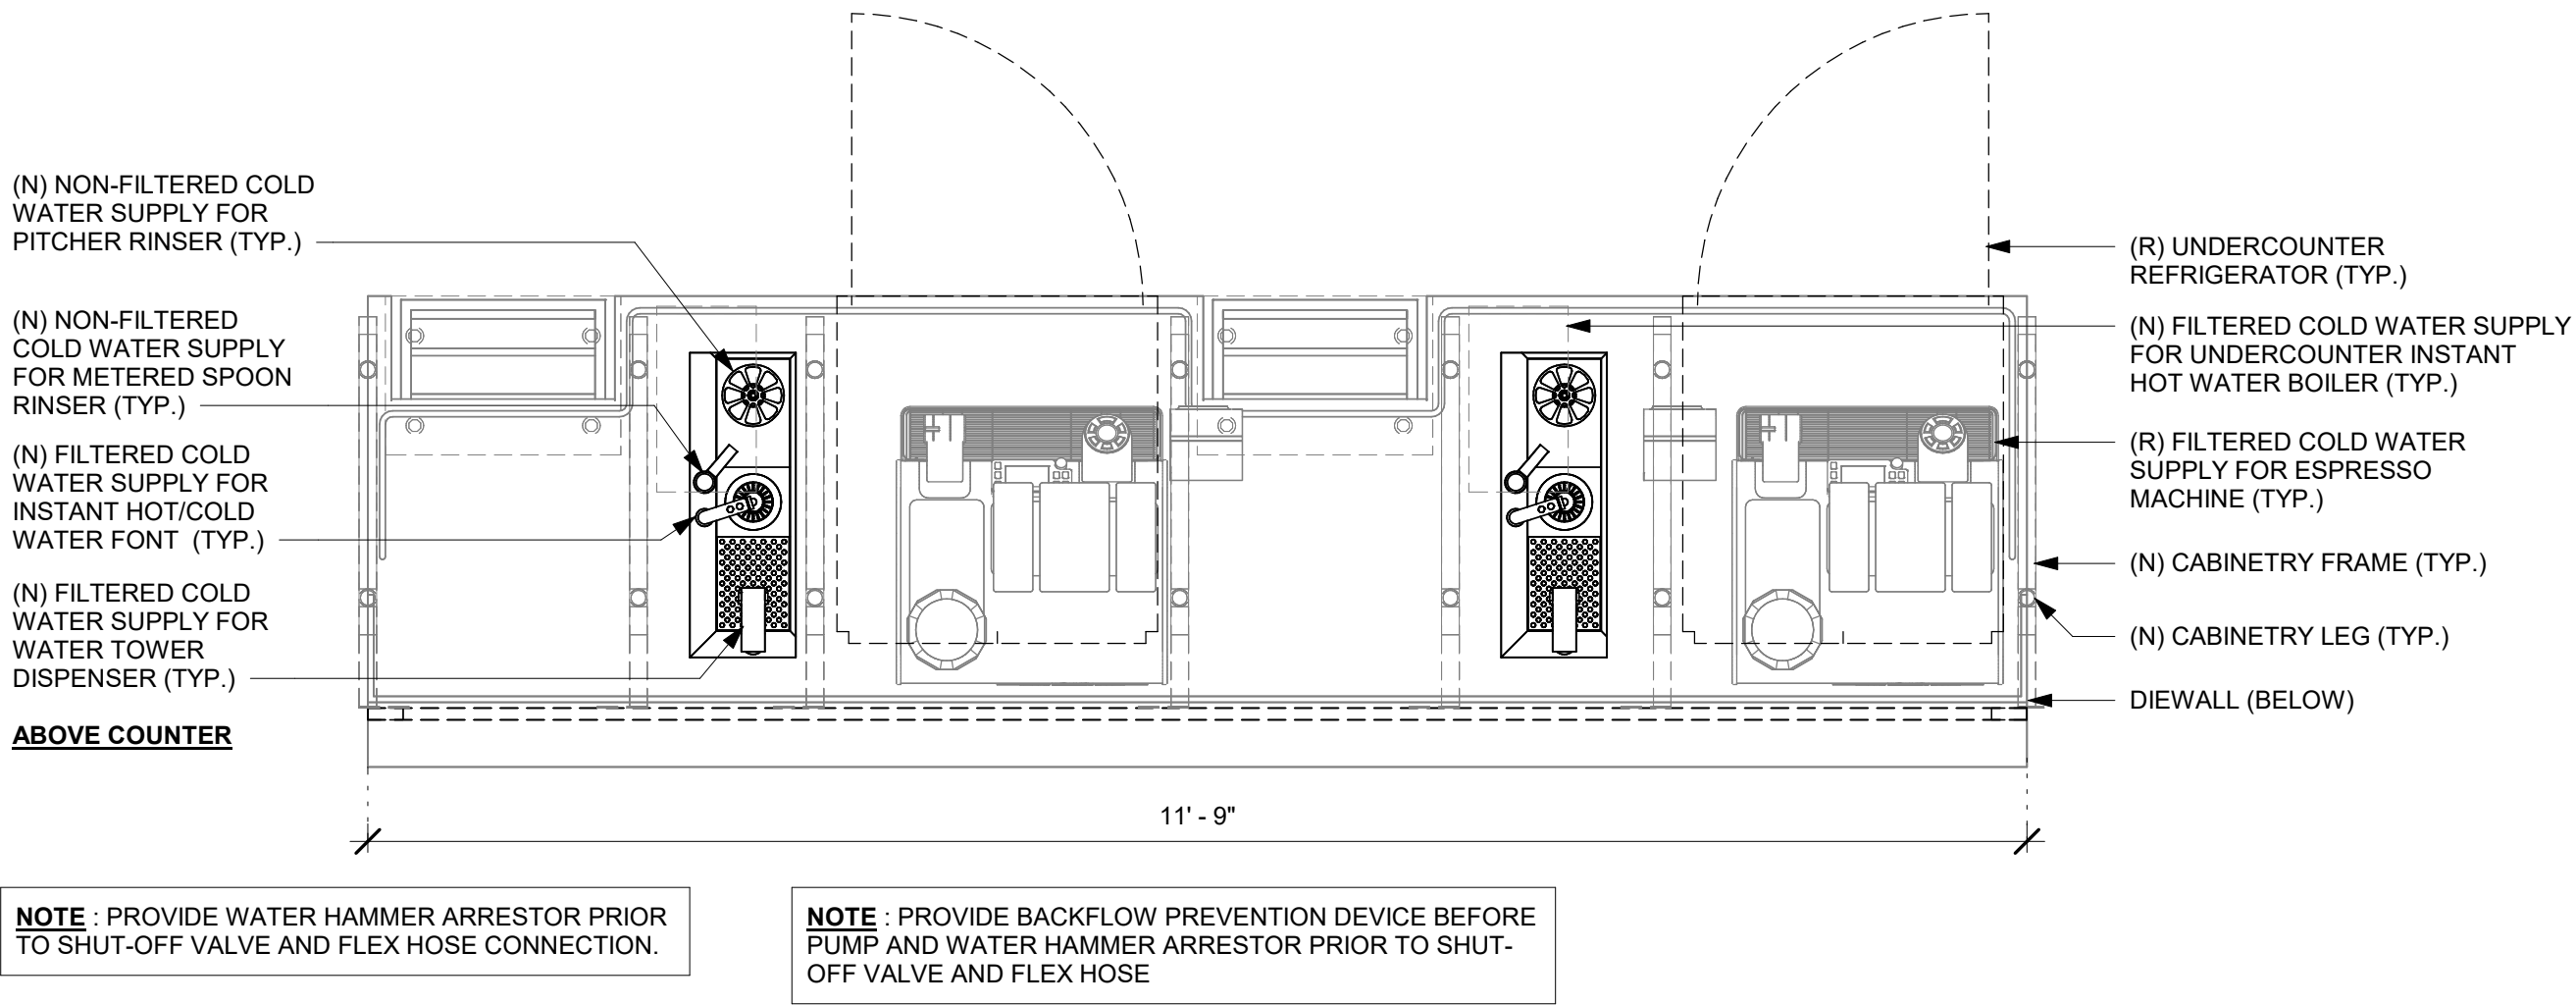

1 ESPRESSO - PLUMBING FOR REFERENCE ONLY

Scale: 3/4" = 1'-0"

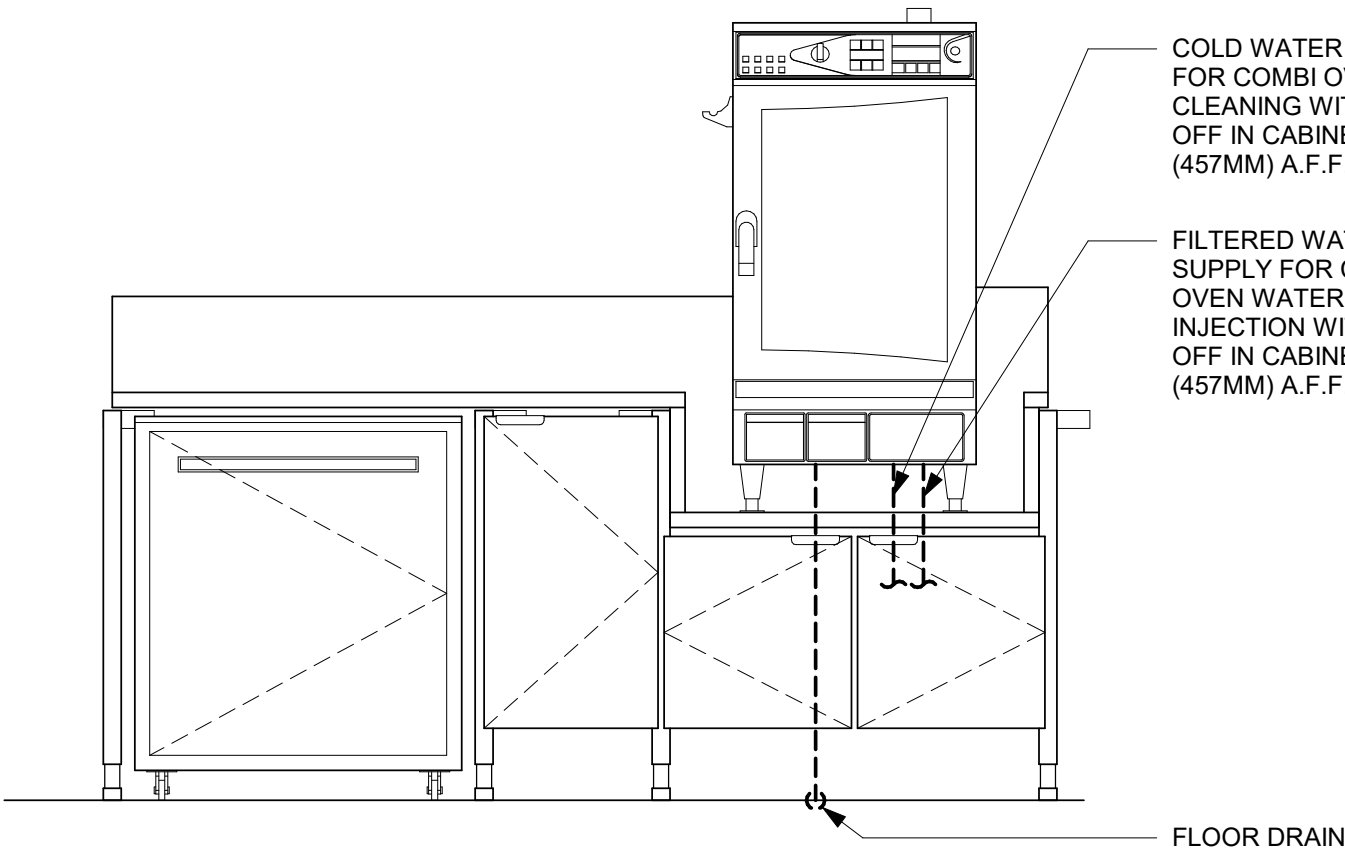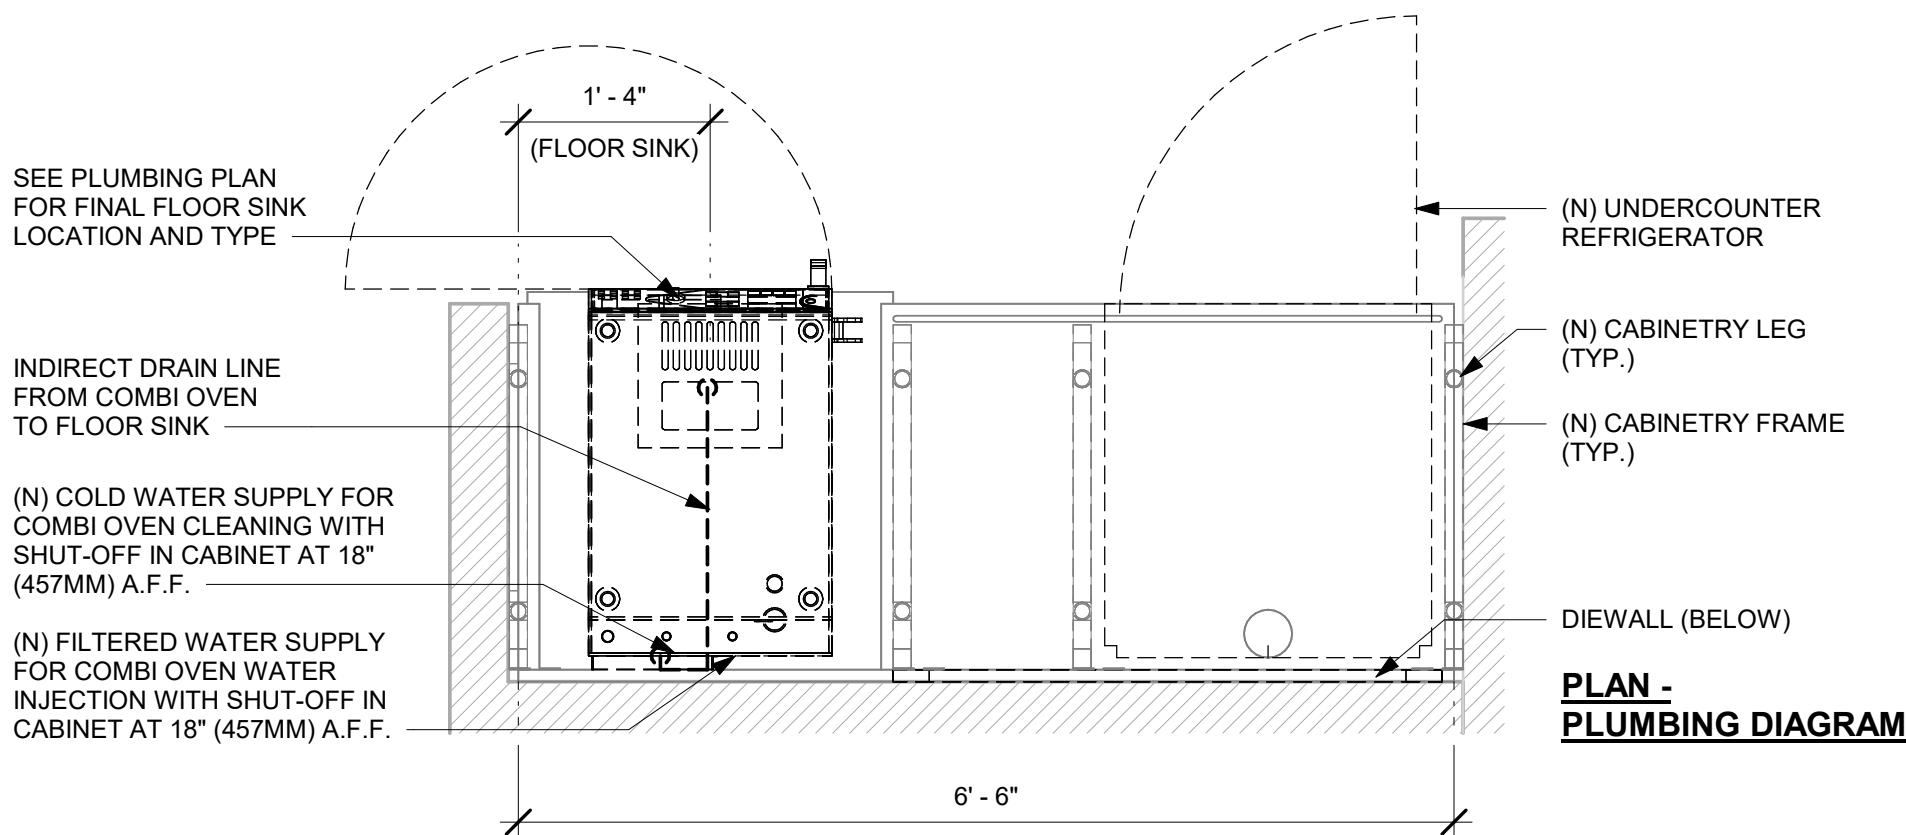


3 BREW - PLUMBING FOR REFERENCE ONLY

Scale: 3/4" = 1'-0"

4 WRM - PLUMBING FOR REFERENCE ONLY

Scale: 3/4" = 1'-0"

FOR CONSTRUCTION



© 2023 STARBUCKS COFFEE COMPANY

STARBUCKS®
2401 UTAH AVENUE SOUTH
SEATTLE, WASHINGTON 98134
(206) 318-1575

THESE DRAWINGS AND THE PROJECT MANUAL ARE CONFIDENTIAL AND SHALL REMAIN THE SOLE PROPERTY OF STARBUCKS CORPORATION, WHICH IS THE OWNER OF THE COPYRIGHT IN THIS WORK. THEY SHALL NOT BE REPRODUCED IN WHOLE OR IN PART, SHARED WITH THIRD PARTIES OR USED IN ANY MANNER ON OTHER PROJECTS OR EXTENSIONS TO THIS PROJECT WITHOUT THE PRIOR WRITTEN CONSENT OF STARBUCKS CORPORATION. THESE DRAWINGS AND SPECIFICATIONS ARE INTENDED TO EXPRESS DESIGN INTENT FOR A PROTOTYPICAL STARBUCKS STORE (WHICH IS SUBJECT TO CHANGE AT ANYTIME) AND DO NOT REFLECT ACTUAL SITE CONDITIONS. NEITHER PARTY SHALL HAVE ANY OBLIGATION NOR LIABILITY TO THE OTHER (EXCEPT STATED ABOVE) UNTIL A WRITTEN AGREEMENT IS FULLY EXECUTED BY BOTH PARTIES.

STARBUCKS TEMPLATE VERSION: i2023.10.23

Design Forum Architects Inc.
2050 Byers Rd
Miamisburg, OH 45342
Tel: (844) 804-7700

Donald J. Reihman
Architect In Charge
License: AR0017303

MARQUE ENGINEERING
2230 PARK AVE, STE. 100, CINCINNATI, OH 45206
513.457.7131 - WWW.MARQUEENG.COM

PROJECT NAME:
S SEMORAN BLVD & LEE VISTA BLVD

PROJECT ADDRESS:
**6605 S SEMORAN BLVD
ORLANDO, FL 32822**

STORE #: 9875
PROJECT #: 25630-101
ISSUE DATE: 03/04/2024
DESIGN MANAGER: MARTIN PEREZ
PRODUCTION DESIGNER: ANDY MCLOUD
CHECKED BY: DONALD REHMAN

Revision Schedule			
Rev	Date	By	Description



SHEET TITLE:
INTERIOR DETAILS

SCALE: 3/4" = 1'-0"

SHEET NUMBER:
I-503


\\file-day.ad.changepinc.com\Client\StarbucksArchitecture\Projects_2023\Florida\Semoran & Lee Vista - 25630-10\25630-101_9875_S Semoran Blvd & Lee Vista Blvd, FL_2023.rvt

3/4/2024 2:40:05 PM

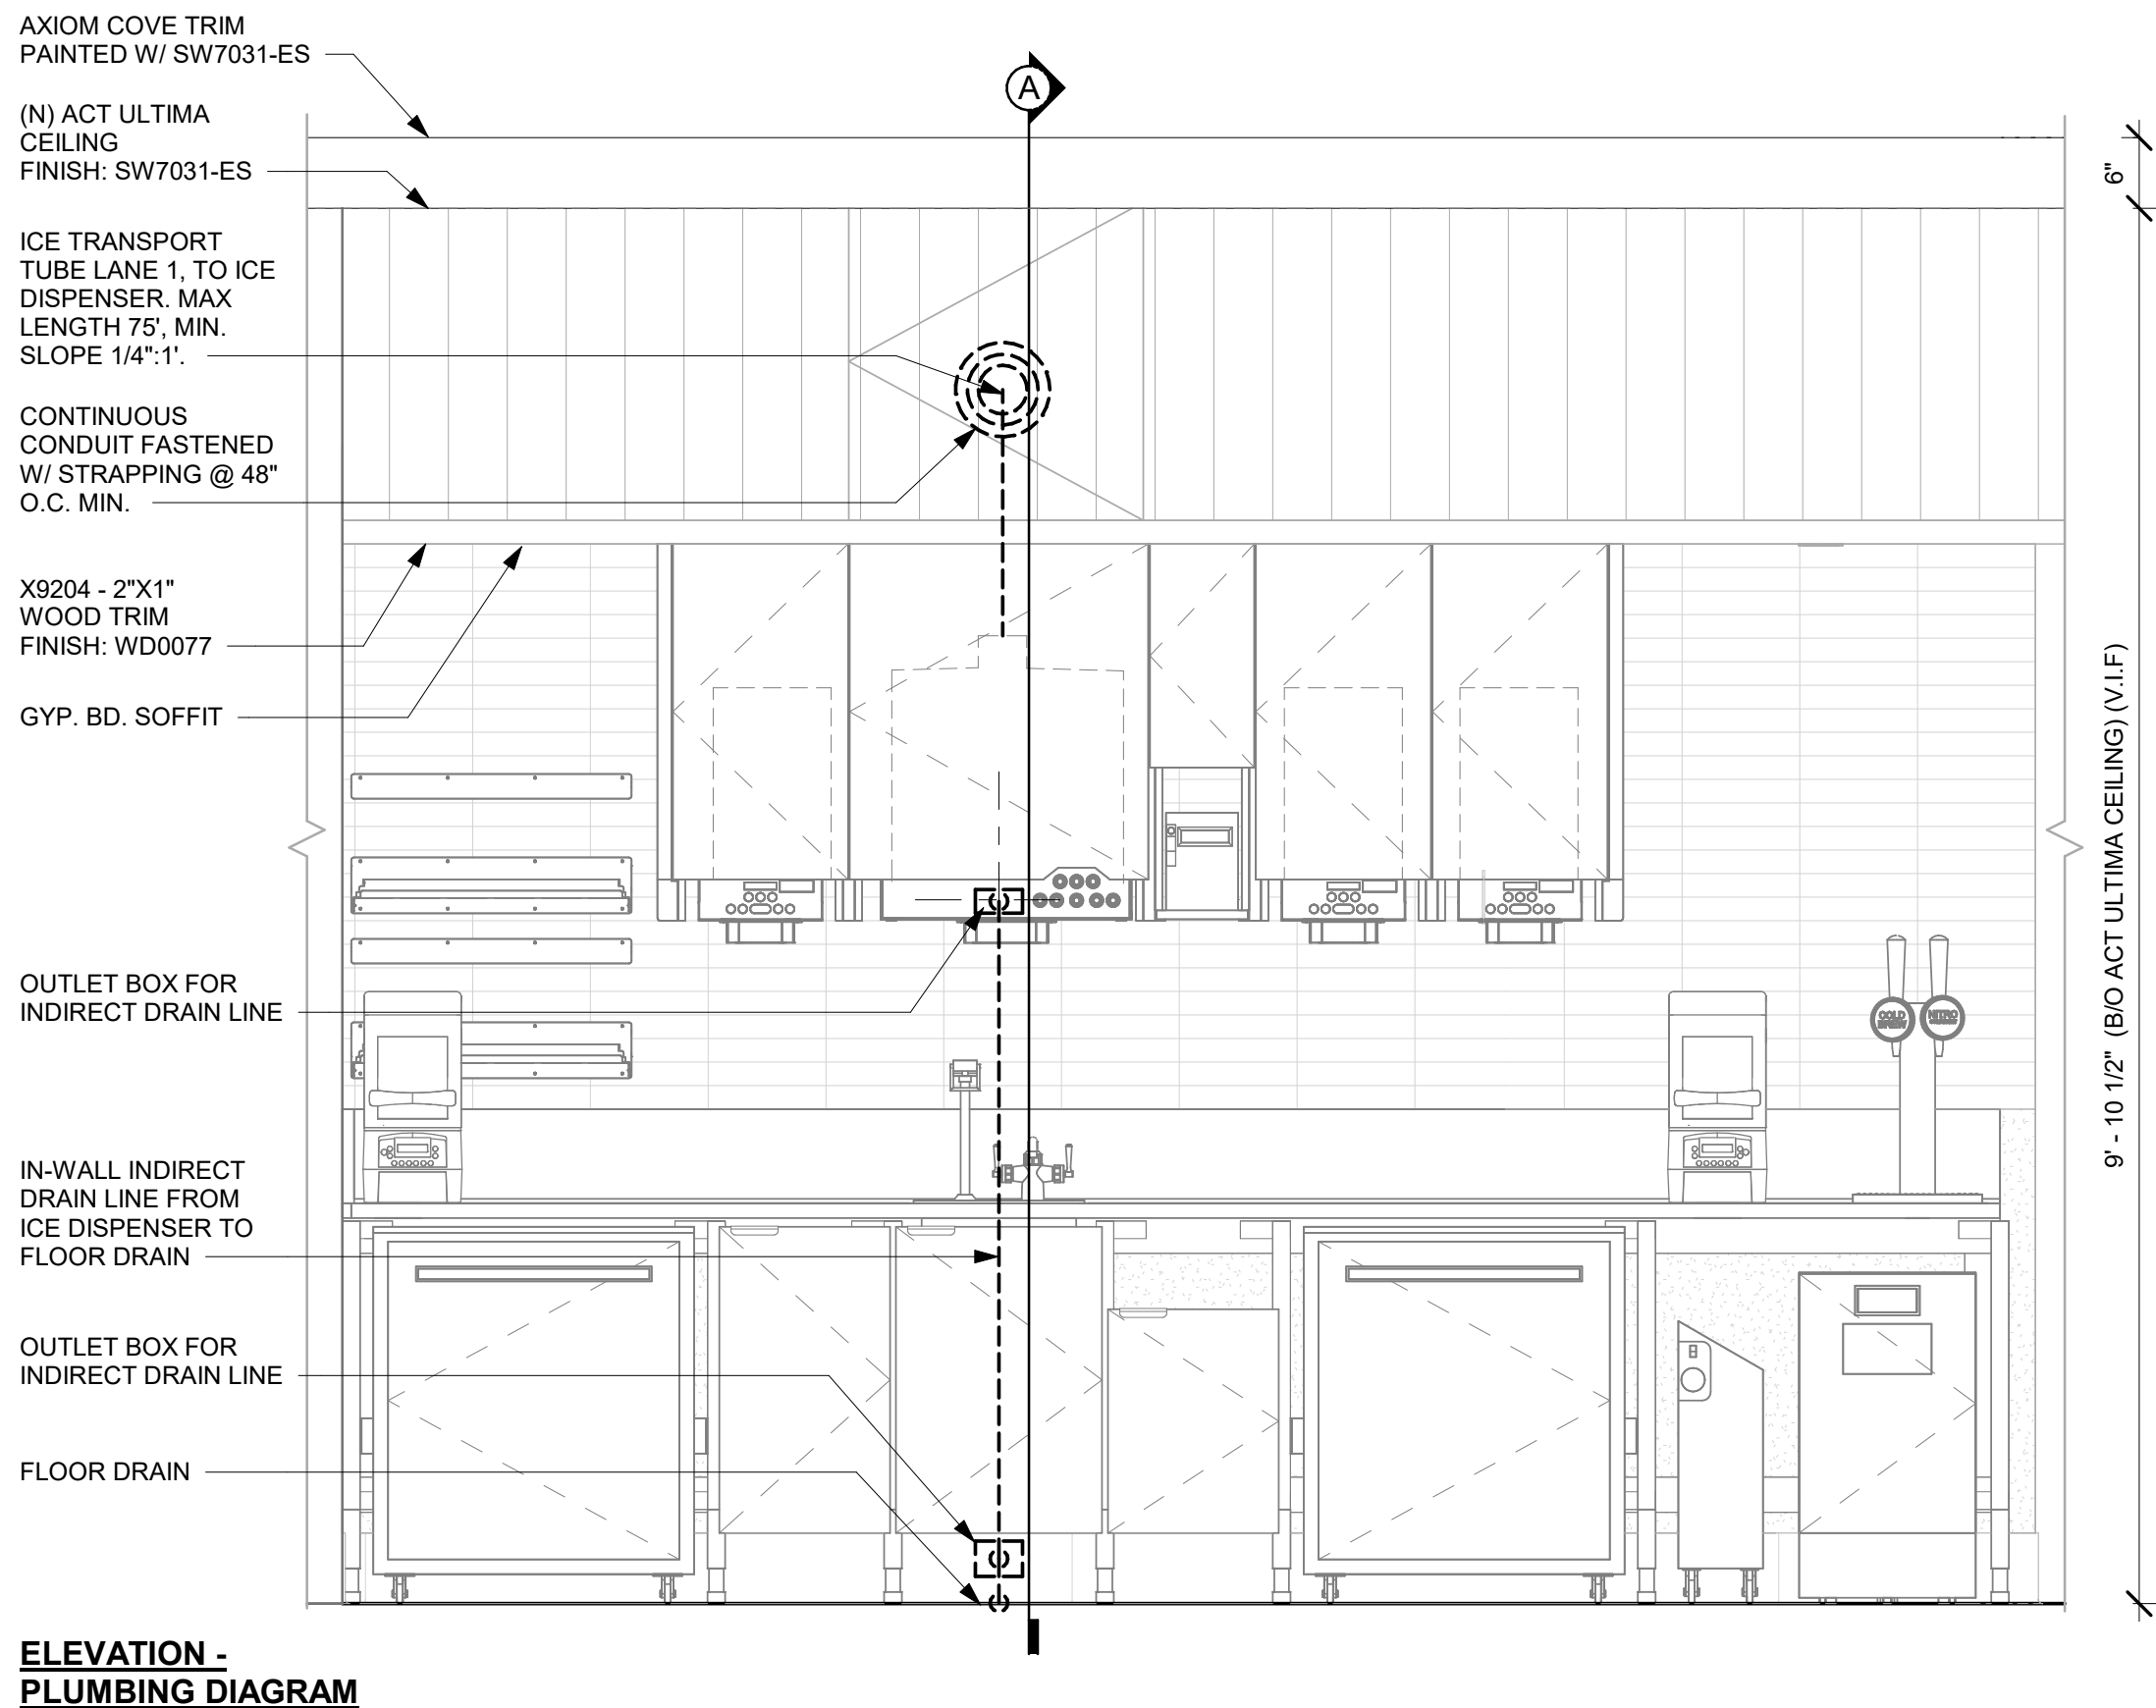
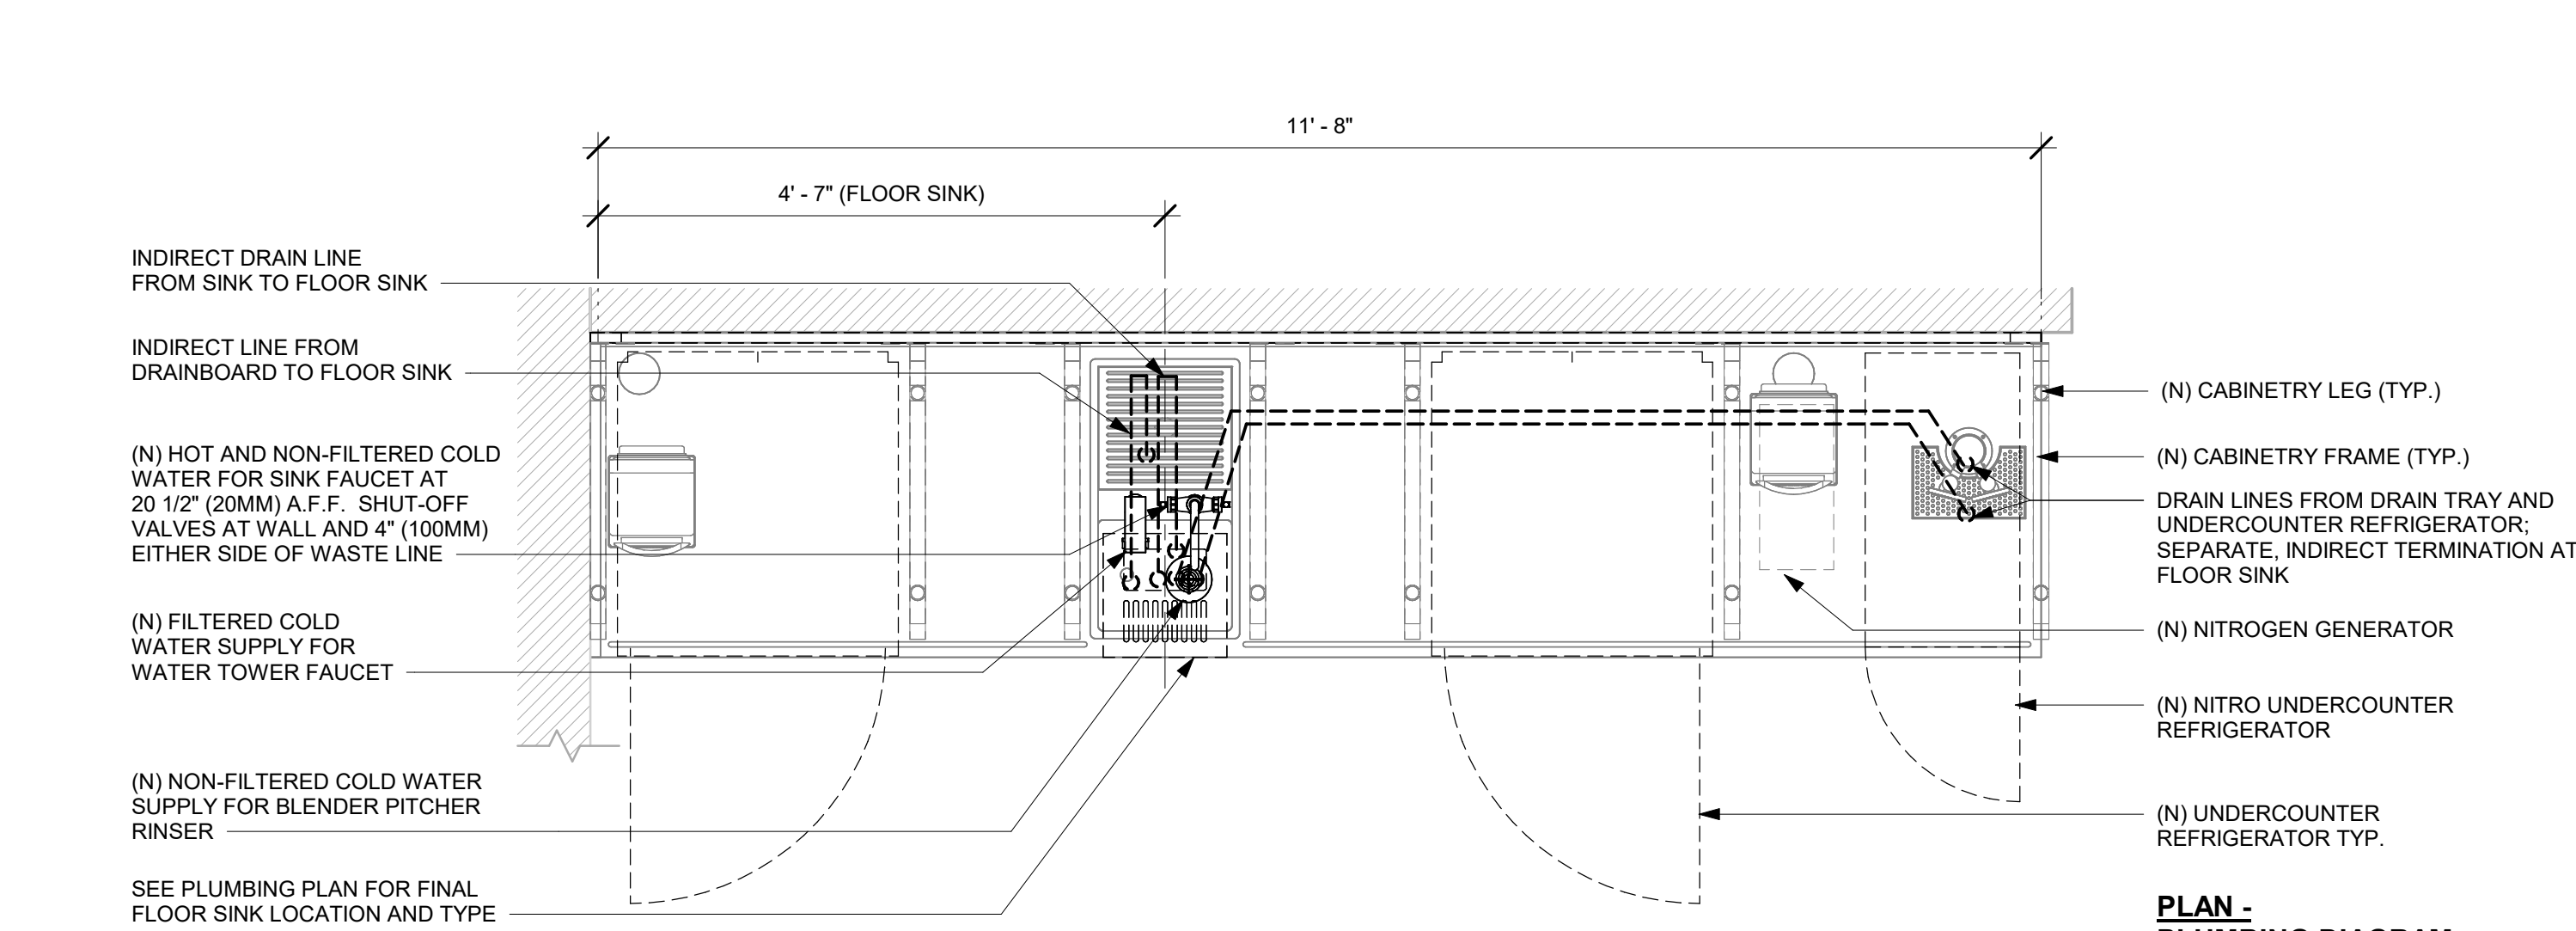


1 CBE - PLUMBING FOR REFERENCE ONLY

Scale: 3/4" = 1'-0"

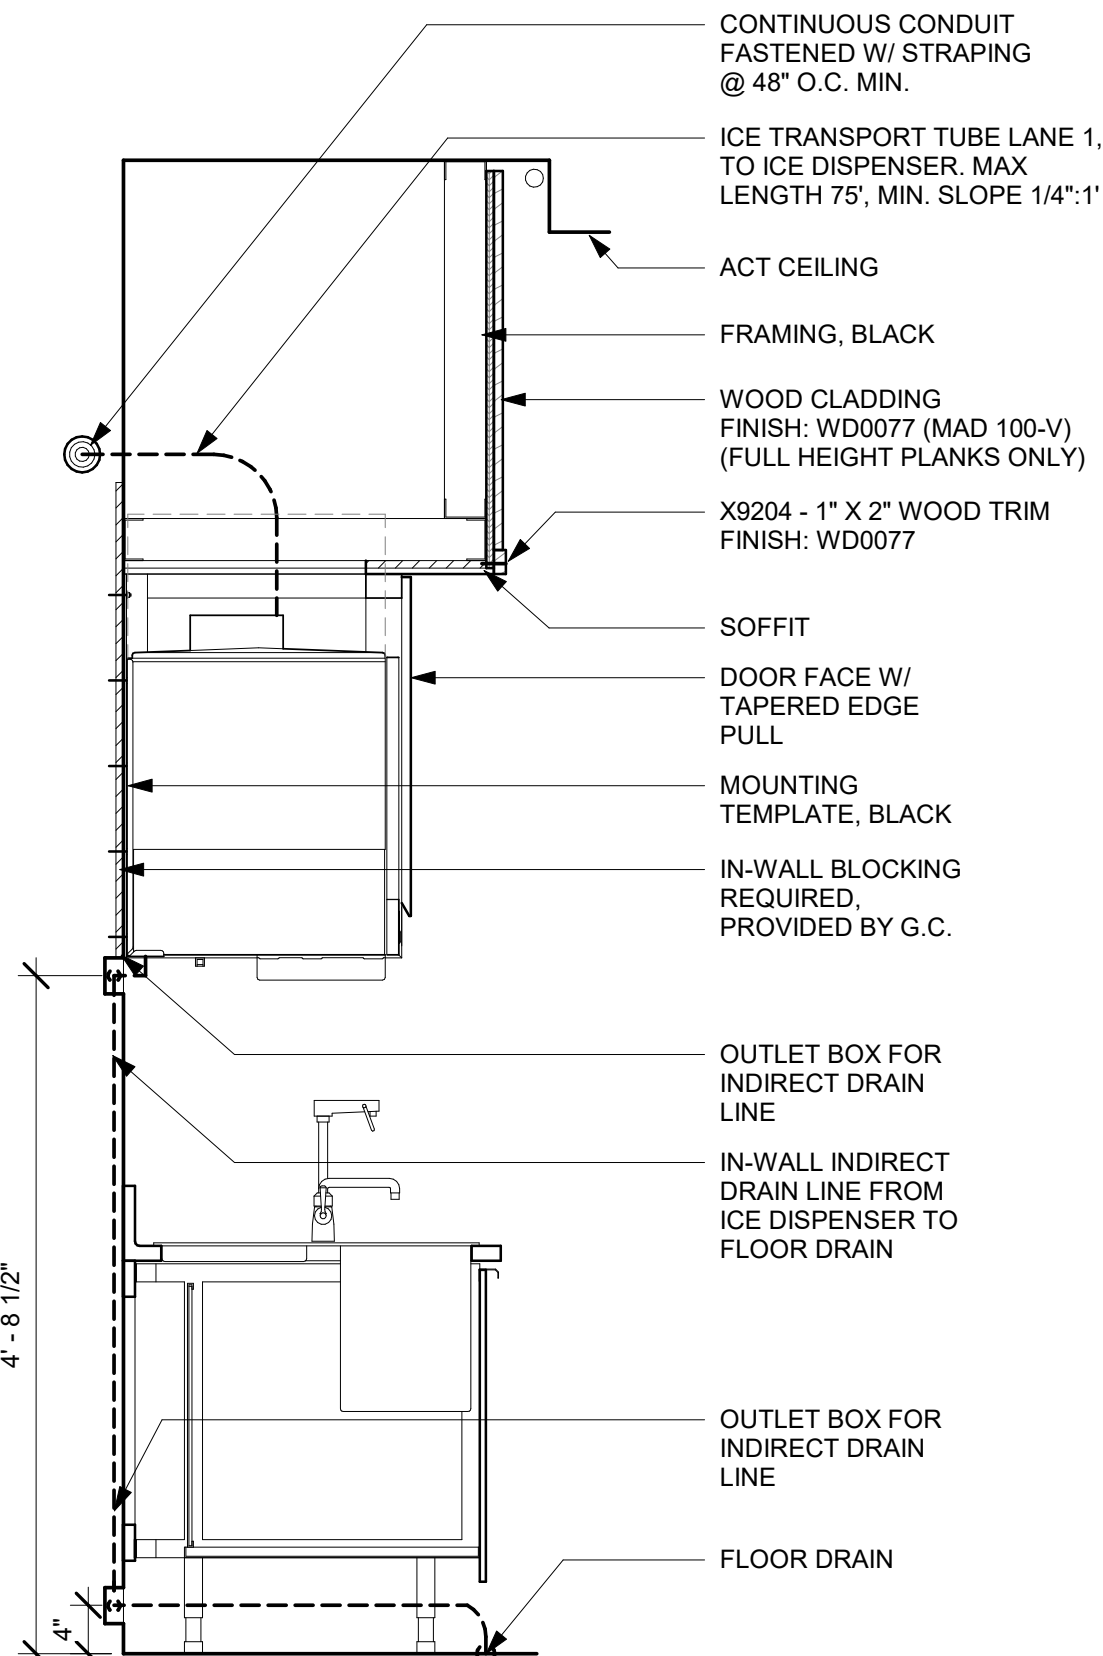

SECTION A - PLUMBING DIAGRAM

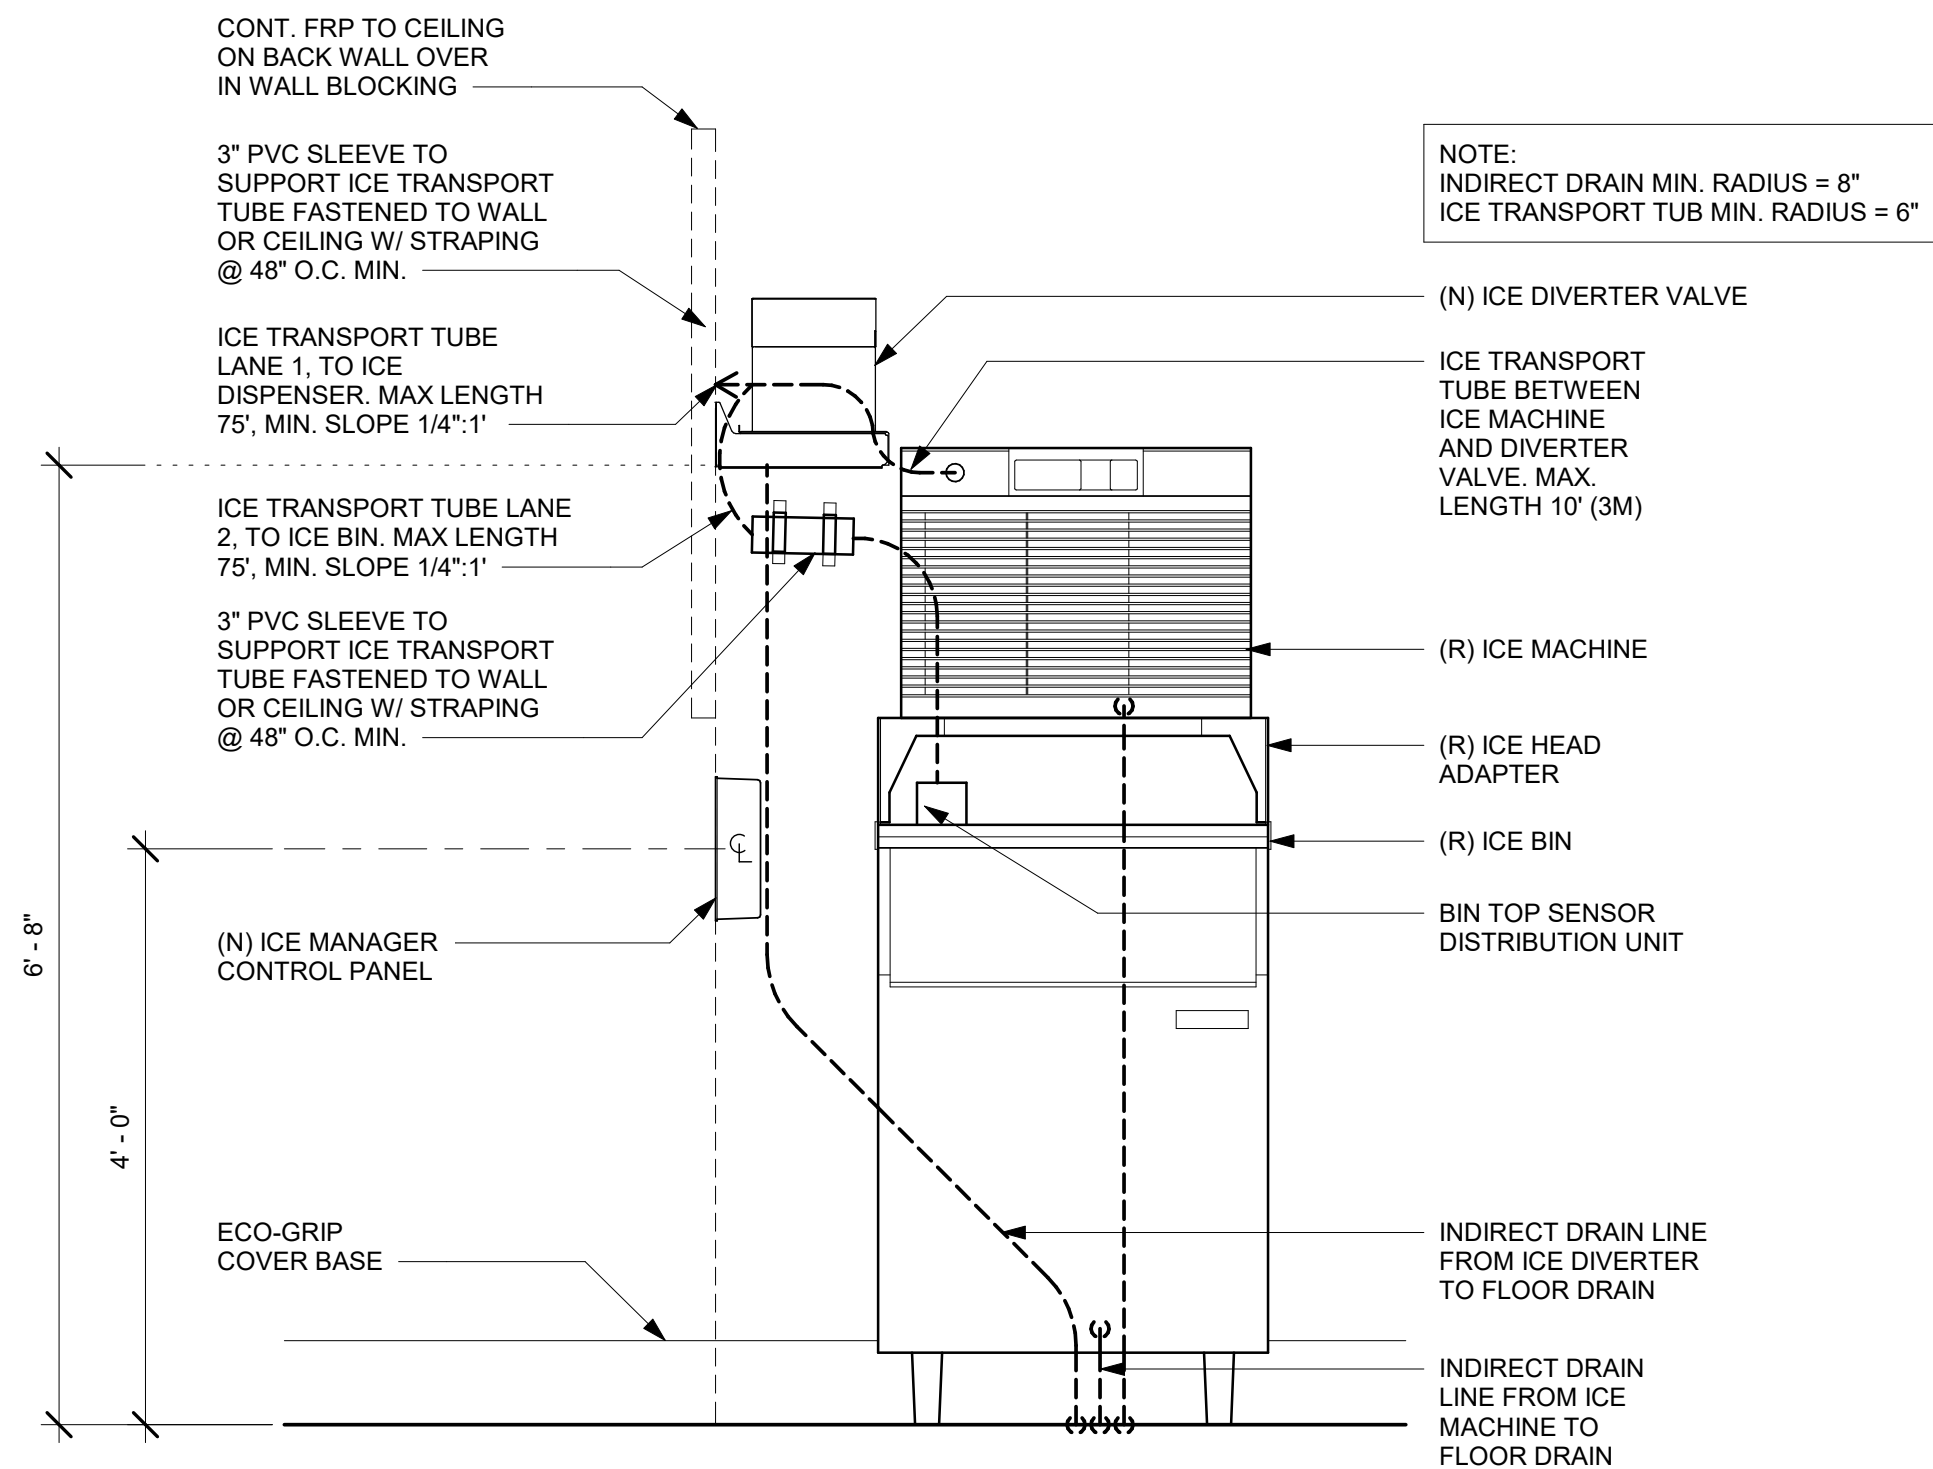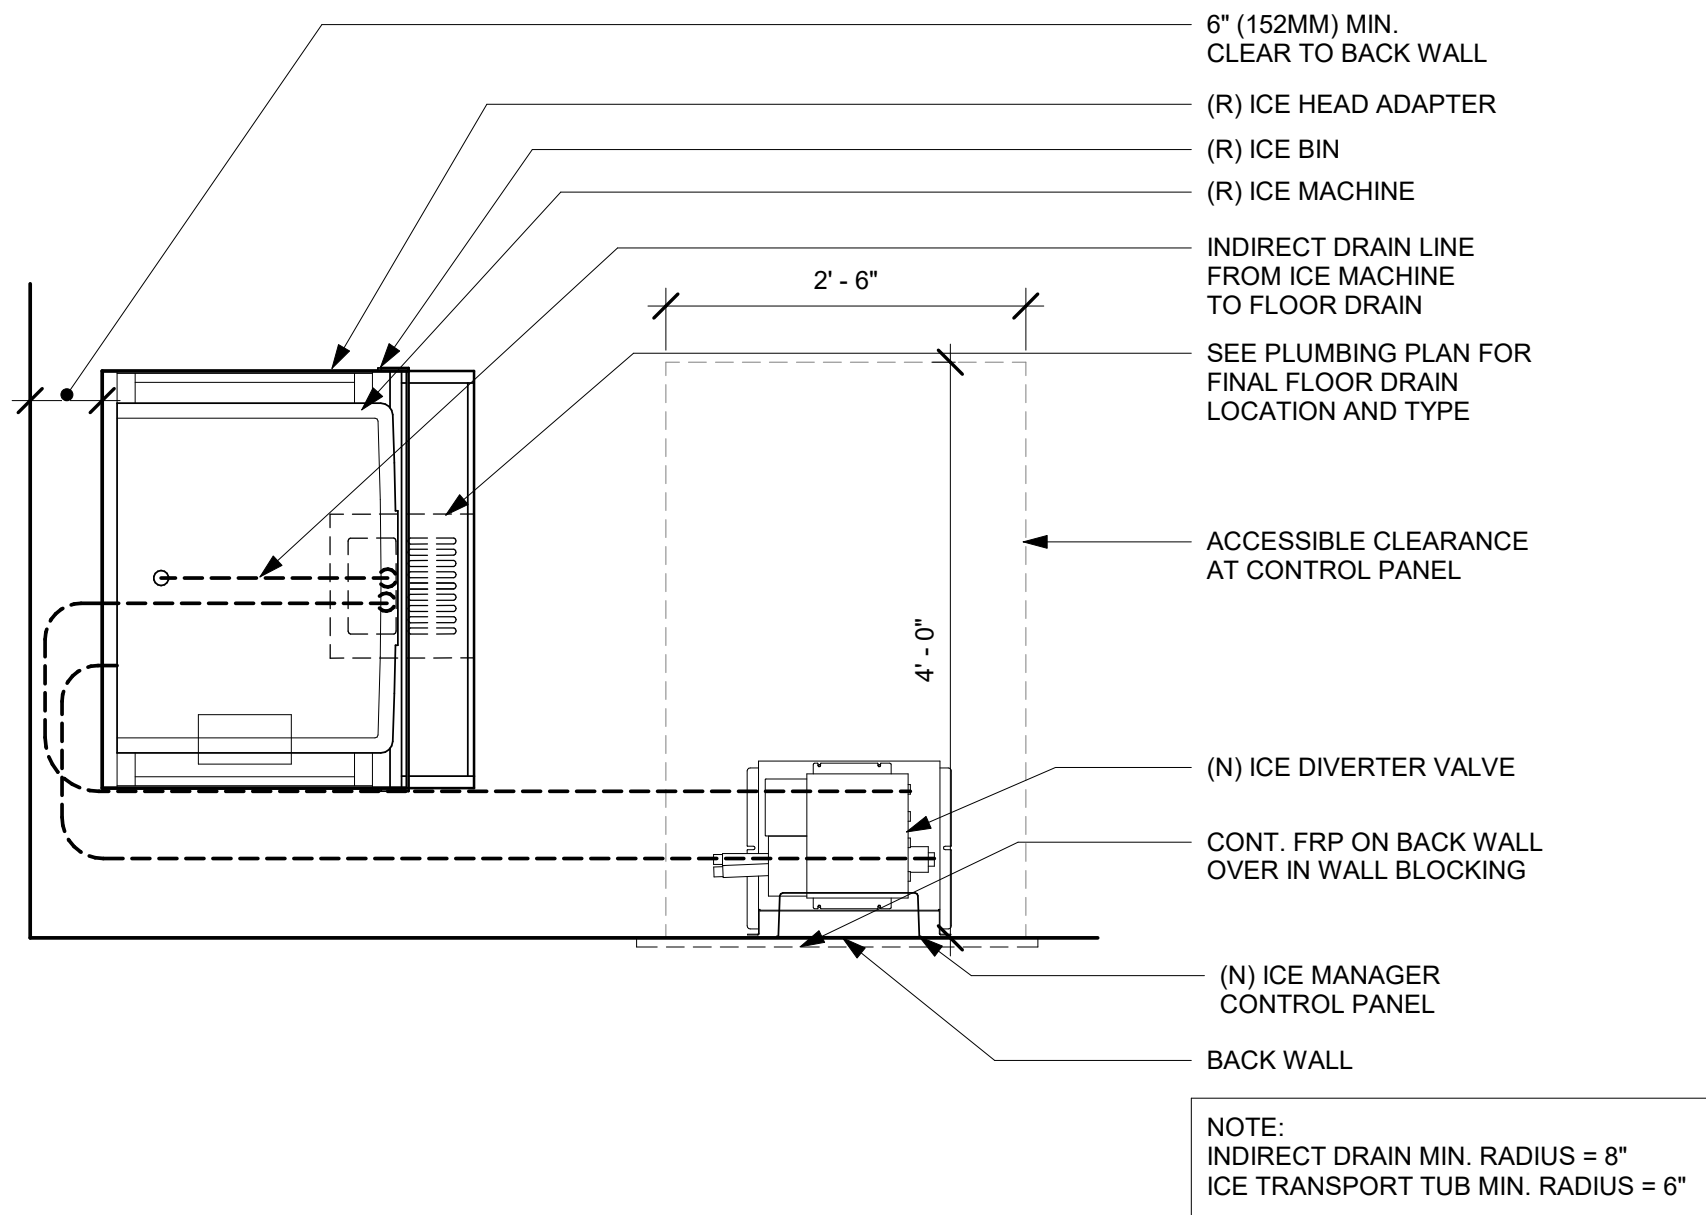

2 NUGGET ICE - PLUMBING FOR REFERENCE ONLY

Scale: 3/4" = 1'-0"



© 2023 STARBUCKS COFFEE COMPANY

STARBUCKS®
2401 UTAH AVENUE SOUTH
SEATTLE, WASHINGTON 98134
(206) 318-1575

THESE DRAWINGS AND THE PROJECT MANUAL ARE CONFIDENTIAL AND SHALL REMAIN THE SOLE PROPERTY OF STARBUCKS CORPORATION, WHICH IS THE OWNER OF THE COPYRIGHT IN THIS WORK. THEY SHALL NOT BE REPRODUCED IN WHOLE OR IN PART, SHARED WITH THIRD PARTIES OR USED IN ANY MANNER ON OTHER PROJECTS OR EXTENSIONS TO THIS PROJECT WITHOUT THE PRIOR WRITTEN CONSENT OF STARBUCKS CORPORATION. THESE DRAWINGS AND SPECIFICATIONS ARE INTENDED TO EXPRESS DESIGN INTENT FOR A PROTOTYPICAL STARBUCKS STORE (WHICH IS SUBJECT TO CHANGE AT ANYTIME) AND DO NOT REFLECT ACTUAL SITE CONDITIONS. NEITHER PARTY SHALL HAVE ANY OBLIGATION NOR LIABILITY TO THE OTHER (EXCEPT STATED ABOVE) UNTIL A WRITTEN AGREEMENT IS FULLY EXECUTED BY BOTH PARTIES.

STARBUCKS TEMPLATE VERSION: i2023.10.23

Design Forum Architects Inc.

2050 Byers Rd
Miami, FL 33136
Tel: (305) 804-7700

Donald J. Rehman
Architect in Charge
License: AR0017303

MARQUE ENGINEERING
2230 PARK AVE, STE. 100, CINCINNATI, OH 45206
513.457.7131 - WWW.MARQUEENG.COM

FOR CONSTRUCTION

PROJECT NAME:
S SEMORAN BLVD & LEE VISTA BLVD

PROJECT ADDRESS:
**6605 S SEMORAN BLVD
ORLANDO, FL 32822**

STORE #: 9875
PROJECT #: 25630-101
ISSUE DATE: 03/04/2024
DESIGN MANAGER: MARTIN PEREZ
PRODUCTION DESIGNER: ANDY MCLOUD
CHECKED BY: DONALD REHMAN


Revision Schedule			
Rev	Date	By	Description

SHEET TITLE:
INTERIOR DETAILS

SCALE: 3/4" = 1'-0"

SHEET NUMBER:
I-504


\\file-day.ad.changeupinc.com\Client\StarbucksArchitecture\Projects_2023\Florida\Semoran & Lee Vista -25630-10\125630-101_9875_S Semoran Blvd & Lee Vista Blvd, FL_2023.rvt 3/4/2024 2:40:06 PM

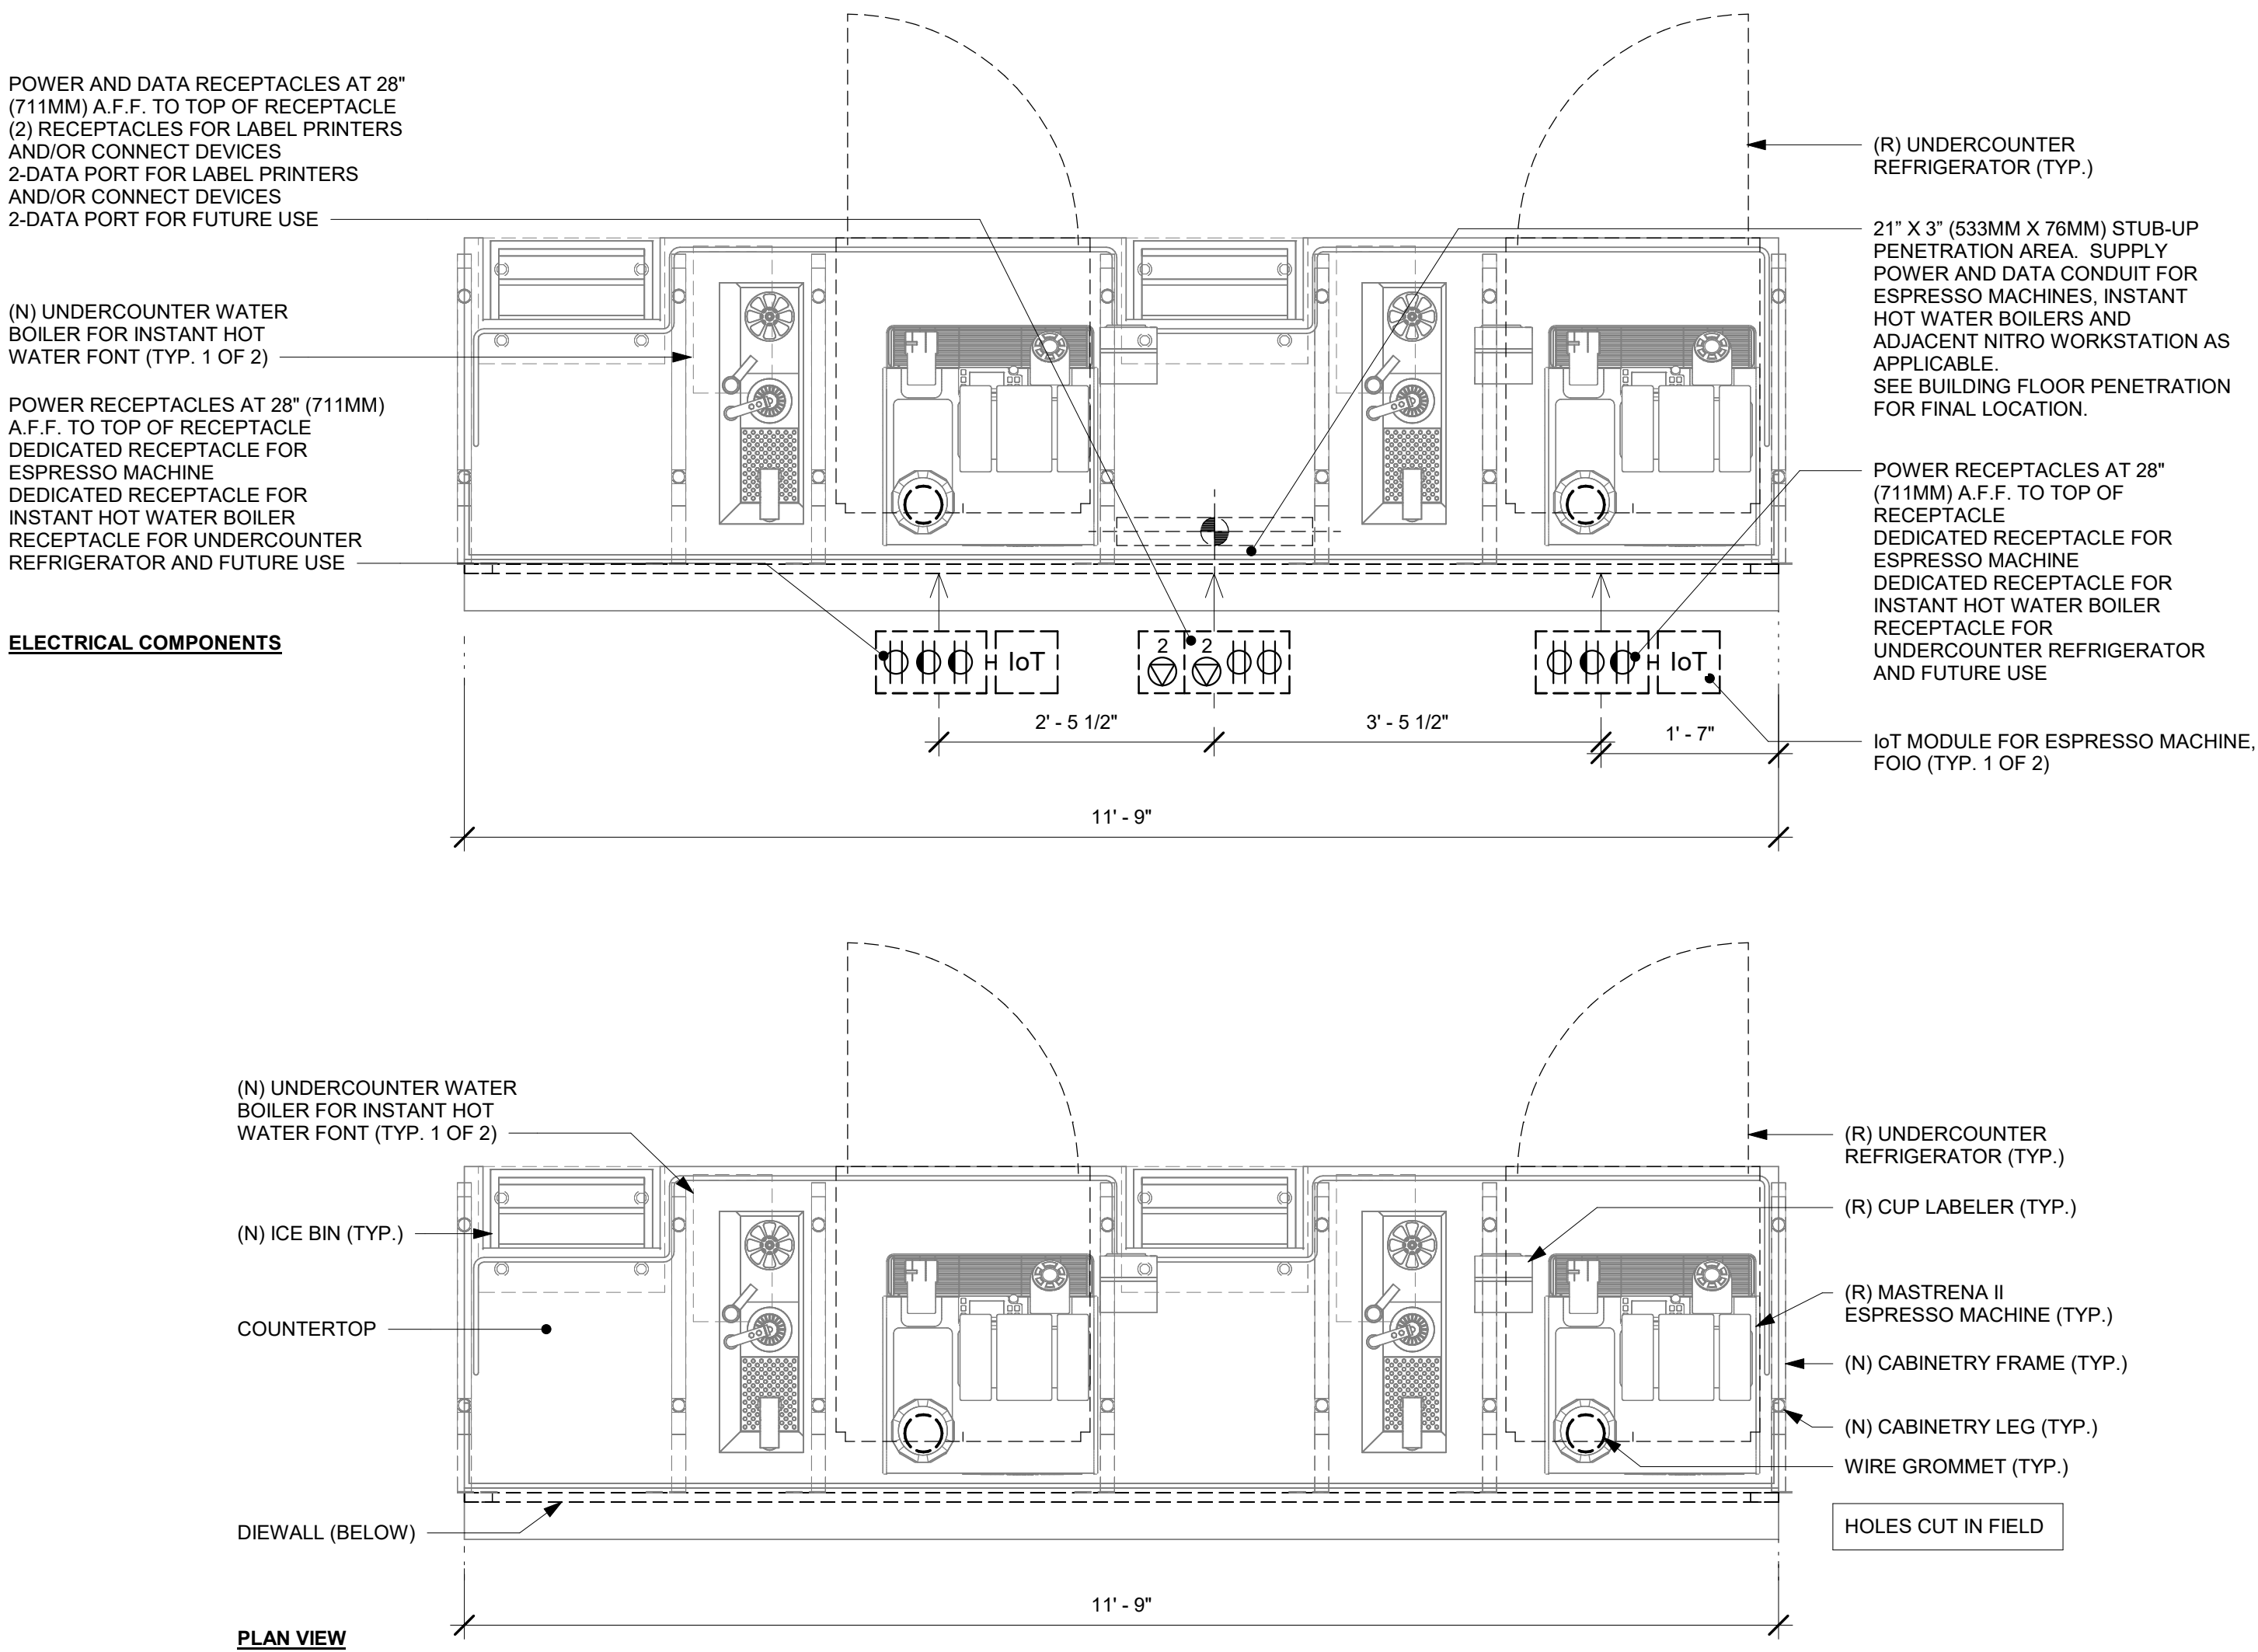

1 ESPRESSO - ELECTRICAL FOR REFERENCE ONLY


Scale: 3/4" = 1'-0"

NOTE:
GENERIC DETAIL IS FOR INFORMATION AND COORDINATION ONLY; ENGINEER TO MODIFY AS APPROPRIATE

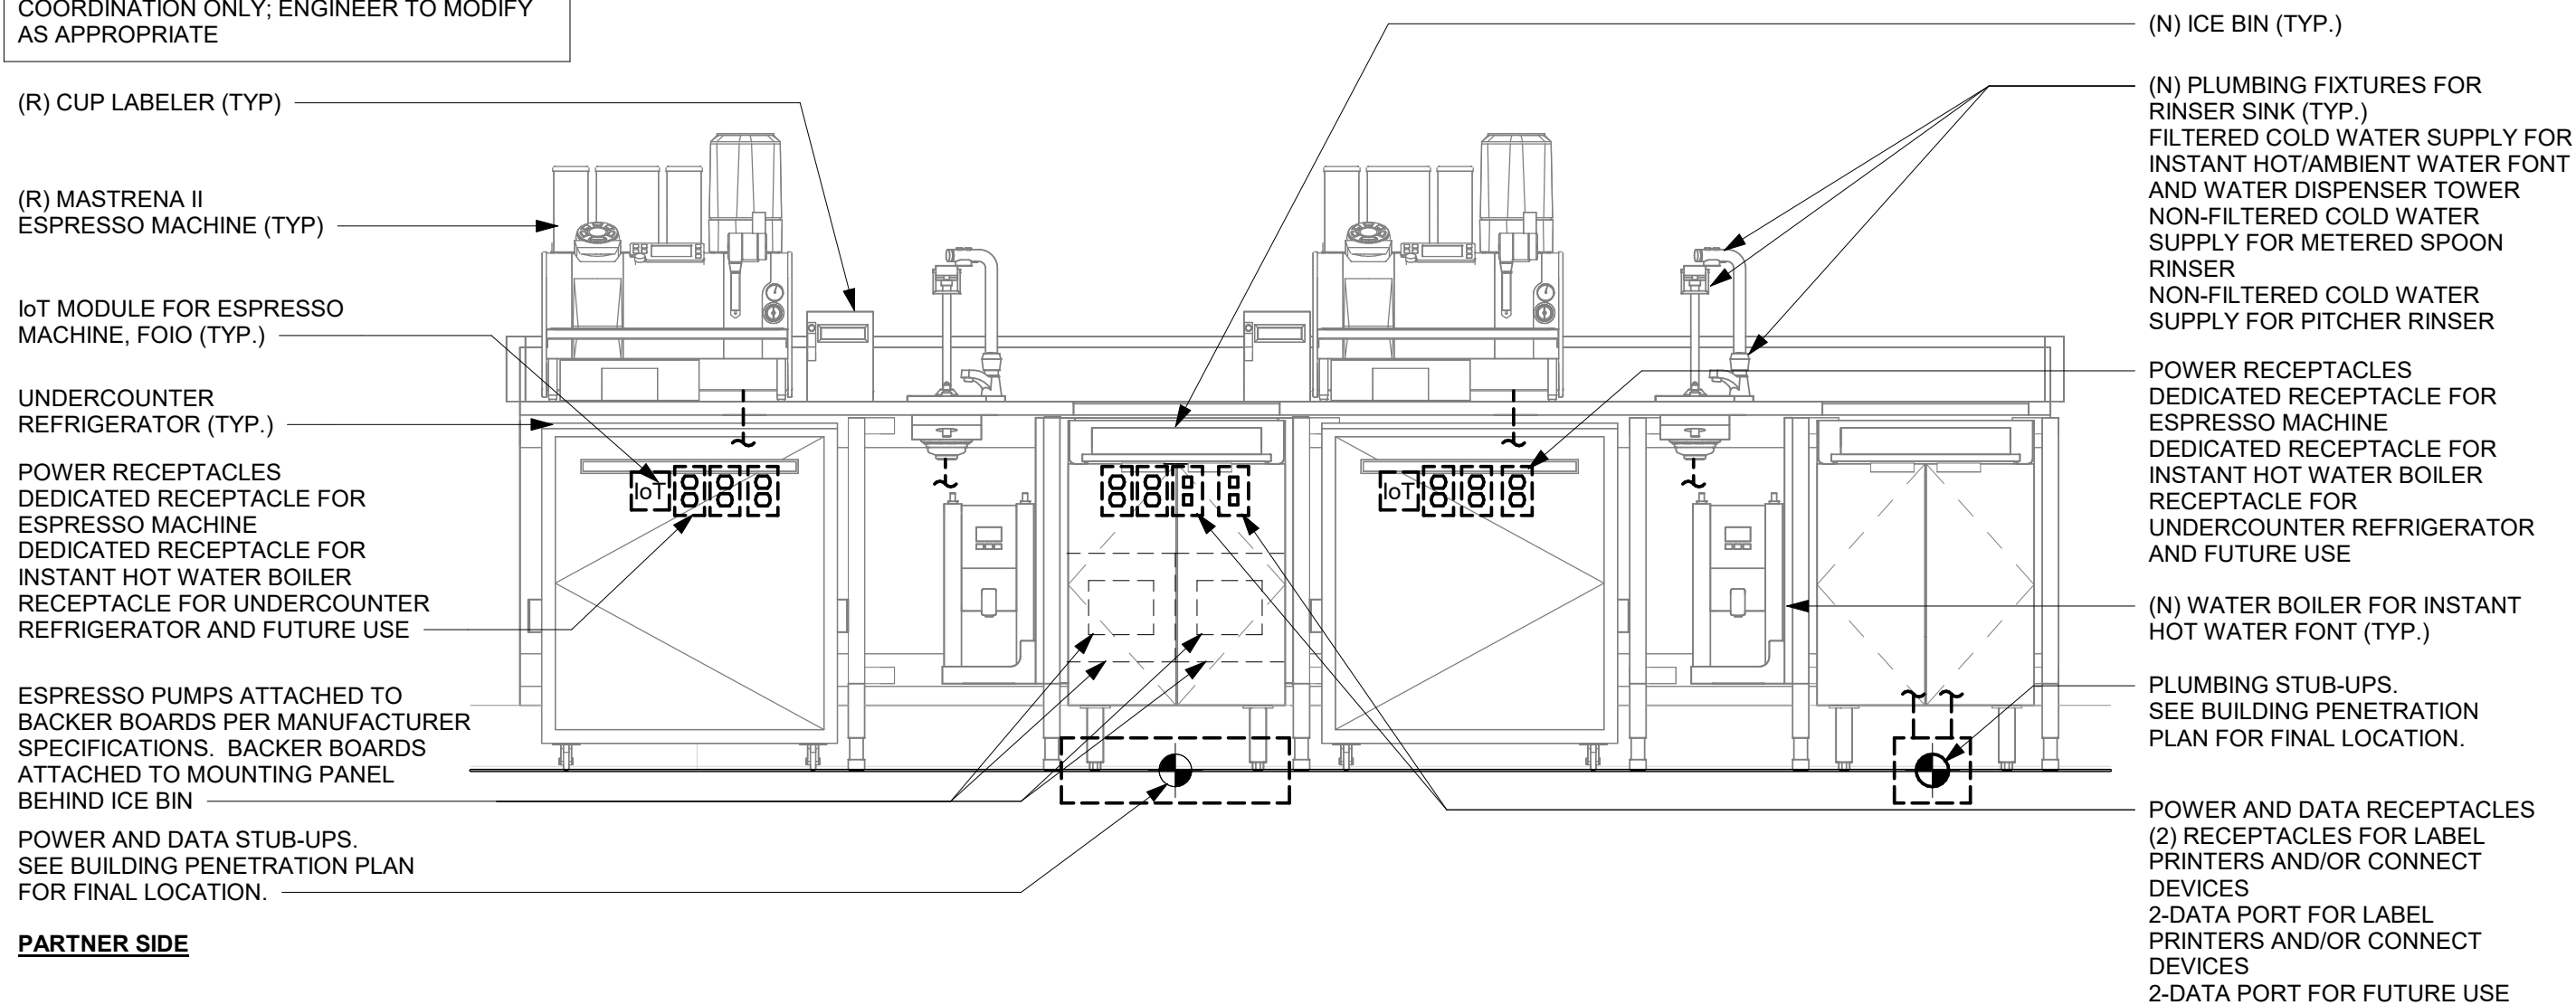

3 GENERIC METRO BAR MEP DIAGRAM

Scale: 3/4" = 1'-0"

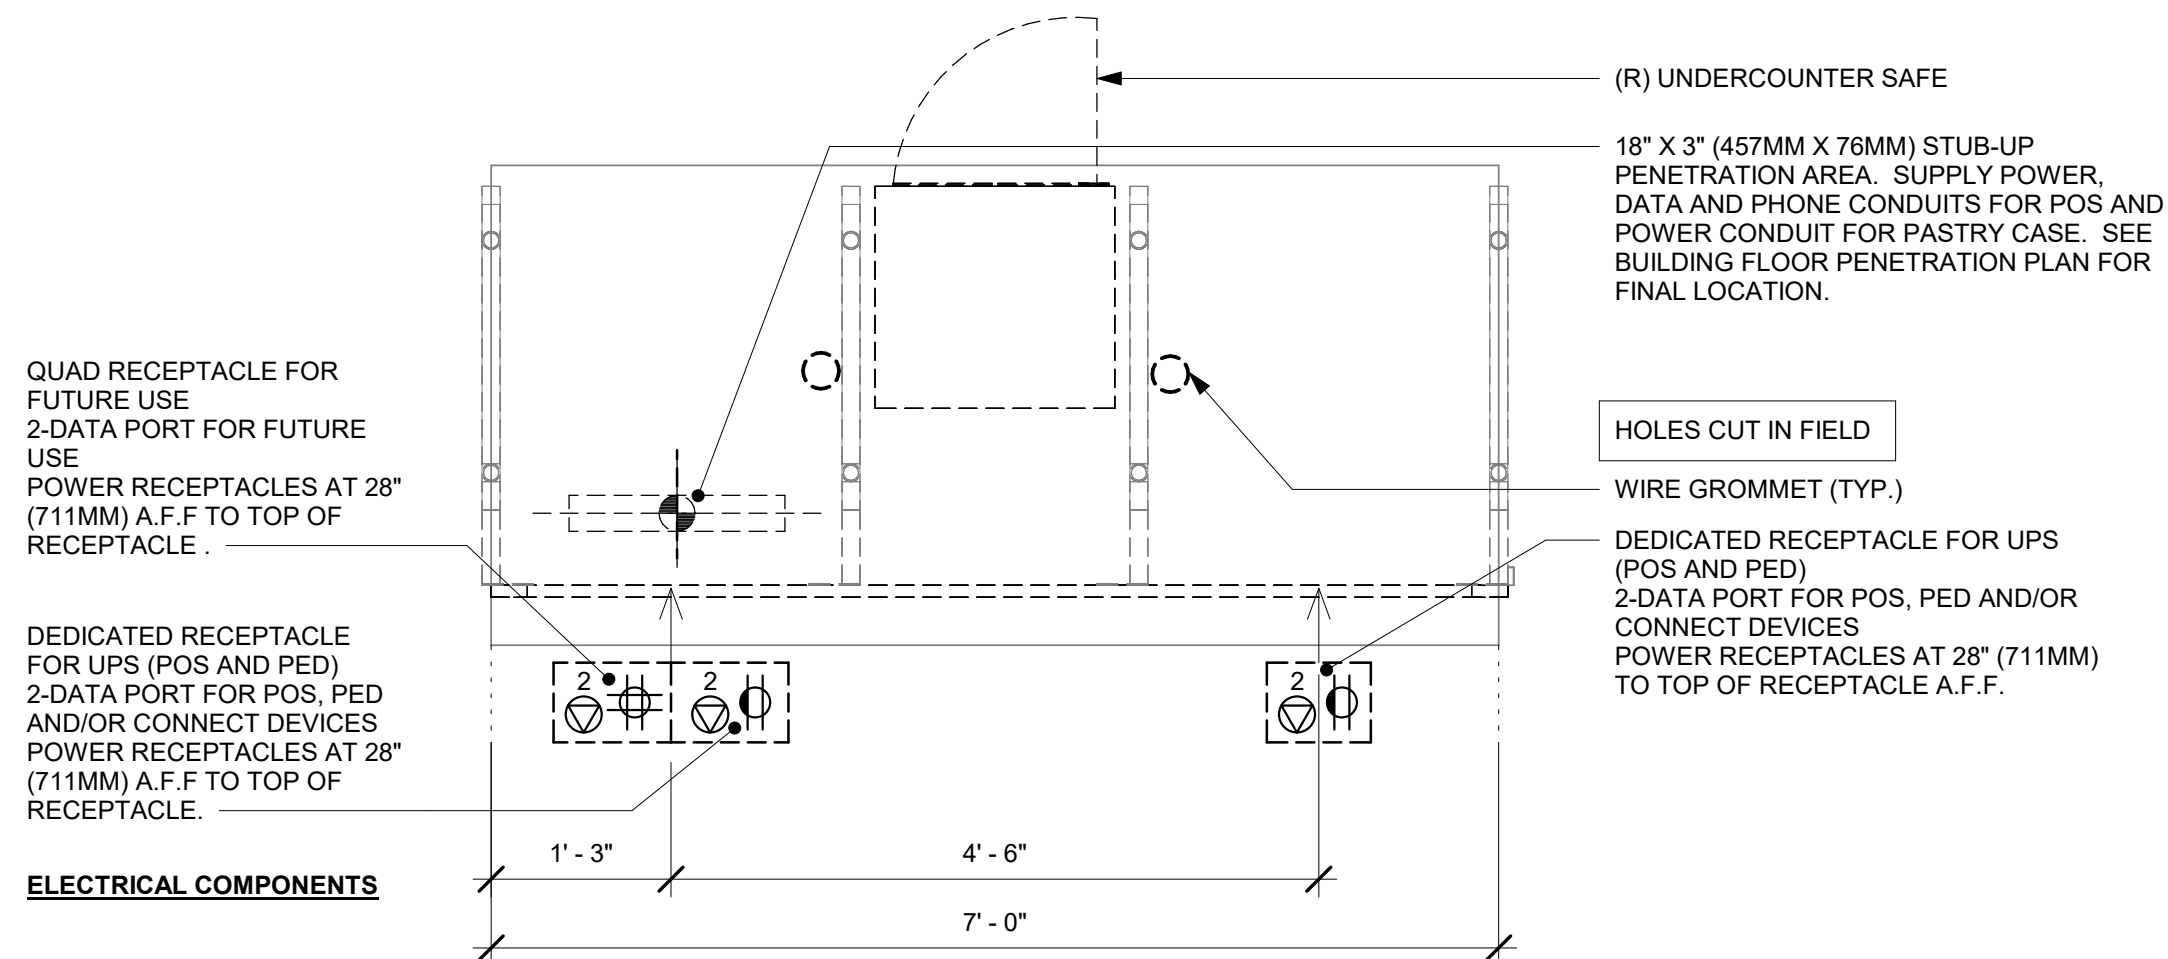


ELECTRICAL COMPONENTS

PLAN VIEW

2 POS - ELECTRICAL FOR REFERENCE ONLY

Scale: 3/4" = 1'-0"

NOTE:
GENERIC DETAIL IS FOR INFORMATION AND COORDINATION ONLY; ENGINEER TO MODIFY AS APPROPRIATE

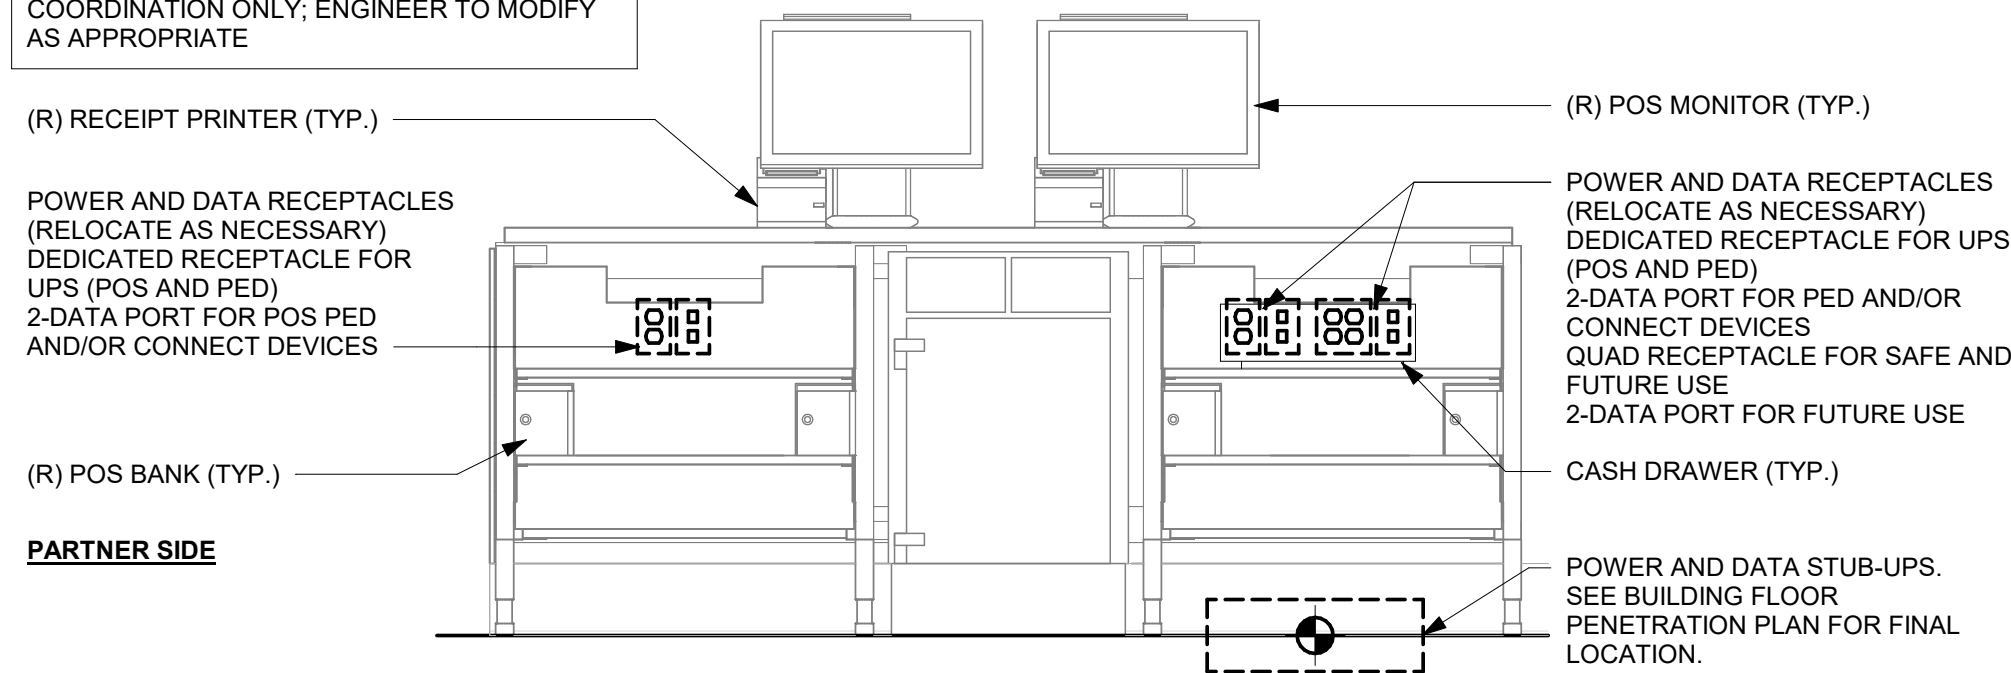

PARTNER SIDE

4 DOUBLE POS MEP DIAGRAM FOR REFERENCE ONLY

Scale: 3/4" = 1'-0"

FOR CONSTRUCTION



© 2023 STARBUCKS COFFEE COMPANY

STARBUCKS®
2401 UTAH AVENUE SOUTH
SEATTLE, WASHINGTON 98134
(206) 318-1575


THESE DRAWINGS AND THE PROJECT MANUAL ARE CONFIDENTIAL AND SHALL REMAIN THE SOLE PROPERTY OF STARBUCKS CORPORATION, WHICH IS THE OWNER OF THE COPYRIGHT IN THIS WORK. THEY SHALL NOT BE REPRODUCED IN WHOLE OR IN PART, SHARED WITH THIRD PARTIES OR USED IN ANY MANNER ON OTHER PROJECTS OR EXTENSIONS TO THIS PROJECT WITHOUT THE PRIOR WRITTEN CONSENT OF STARBUCKS CORPORATION. THESE DRAWINGS AND SPECIFICATIONS ARE INTENDED TO EXPRESS DESIGN INTENT FOR A PROTOTYPICAL STARBUCKS STORE (WHICH IS SUBJECT TO CHANGE AT ANYTIME) AND DO NOT REFLECT ACTUAL SITE CONDITIONS. NEITHER PARTY SHALL HAVE ANY OBLIGATION NOR LIABILITY TO THE OTHER (EXCEPT STATED ABOVE) UNTIL A WRITTEN AGREEMENT IS FULLY EXECUTED BY BOTH PARTIES.

STARBUCKS TEMPLATE VERSION: i2023.10.23

Design Forum Architects Inc.

2050 Byers Rd
Miamisburg, OH 45342
Tel: (844) 804-7700

Donald J. Reihman
Architect In Charge
License: AR0017303

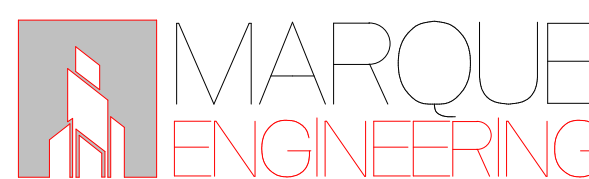

2230 PARK AVE, STE. 100, CINCINNATI, OH 45206
513.457.7131 - WWW.MARQUEENG.COM

PROJECT NAME:
S SEMORAN BLVD & LEE VISTA BLVD

PROJECT ADDRESS:
**6605 S SEMORAN BLVD
ORLANDO, FL 32822**

STORE #: 9875
PROJECT #: 25630-101
ISSUE DATE: 03/04/2024
DESIGN MANAGER: MARTIN PEREZ
PRODUCTION DESIGNER: ANDY MCLOUD
CHECKED BY: DONALD RETHMAN

Revision Schedule				
Rev	Date	By	Description	


SHEET TITLE:
INTERIOR DETAILS

SCALE: 3/4" = 1'-0"


SHEET NUMBER:

I-505


\\file-day.ad.changeupinc.com\Client\StarbucksArchitecture\Projects_2023\Florida\Semoran & Lee Vista -25630-101\25630-101_9875_S Semoran Blvd & Lee Vista Blvd, FL_2023.rvt 3/4/2024 2:40:08 PM

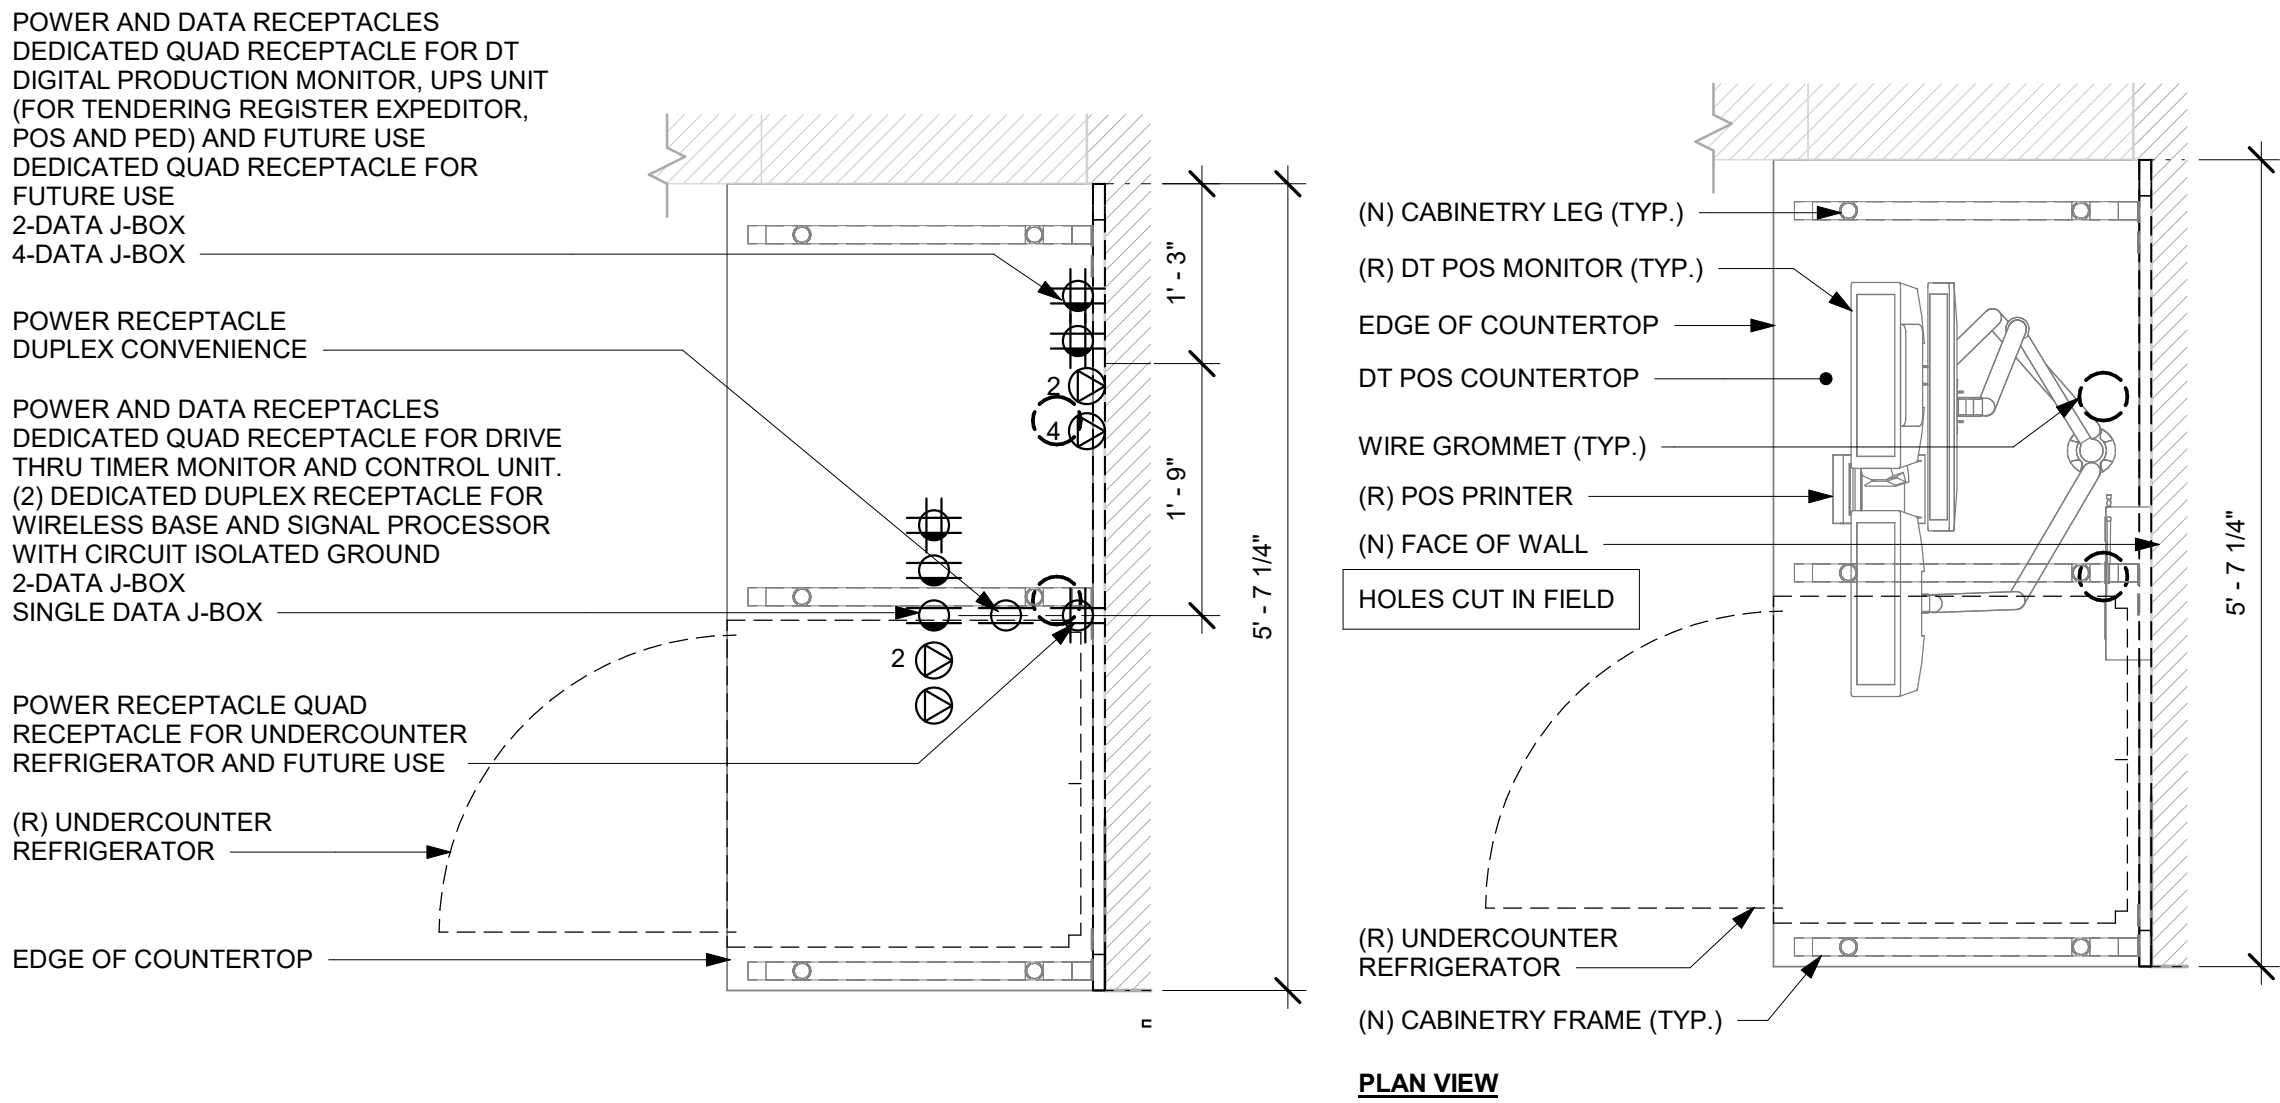


1 DT POS - ELECTRICAL FOR REFERENCE ONLY
Scale: 3/4" = 1'-0"

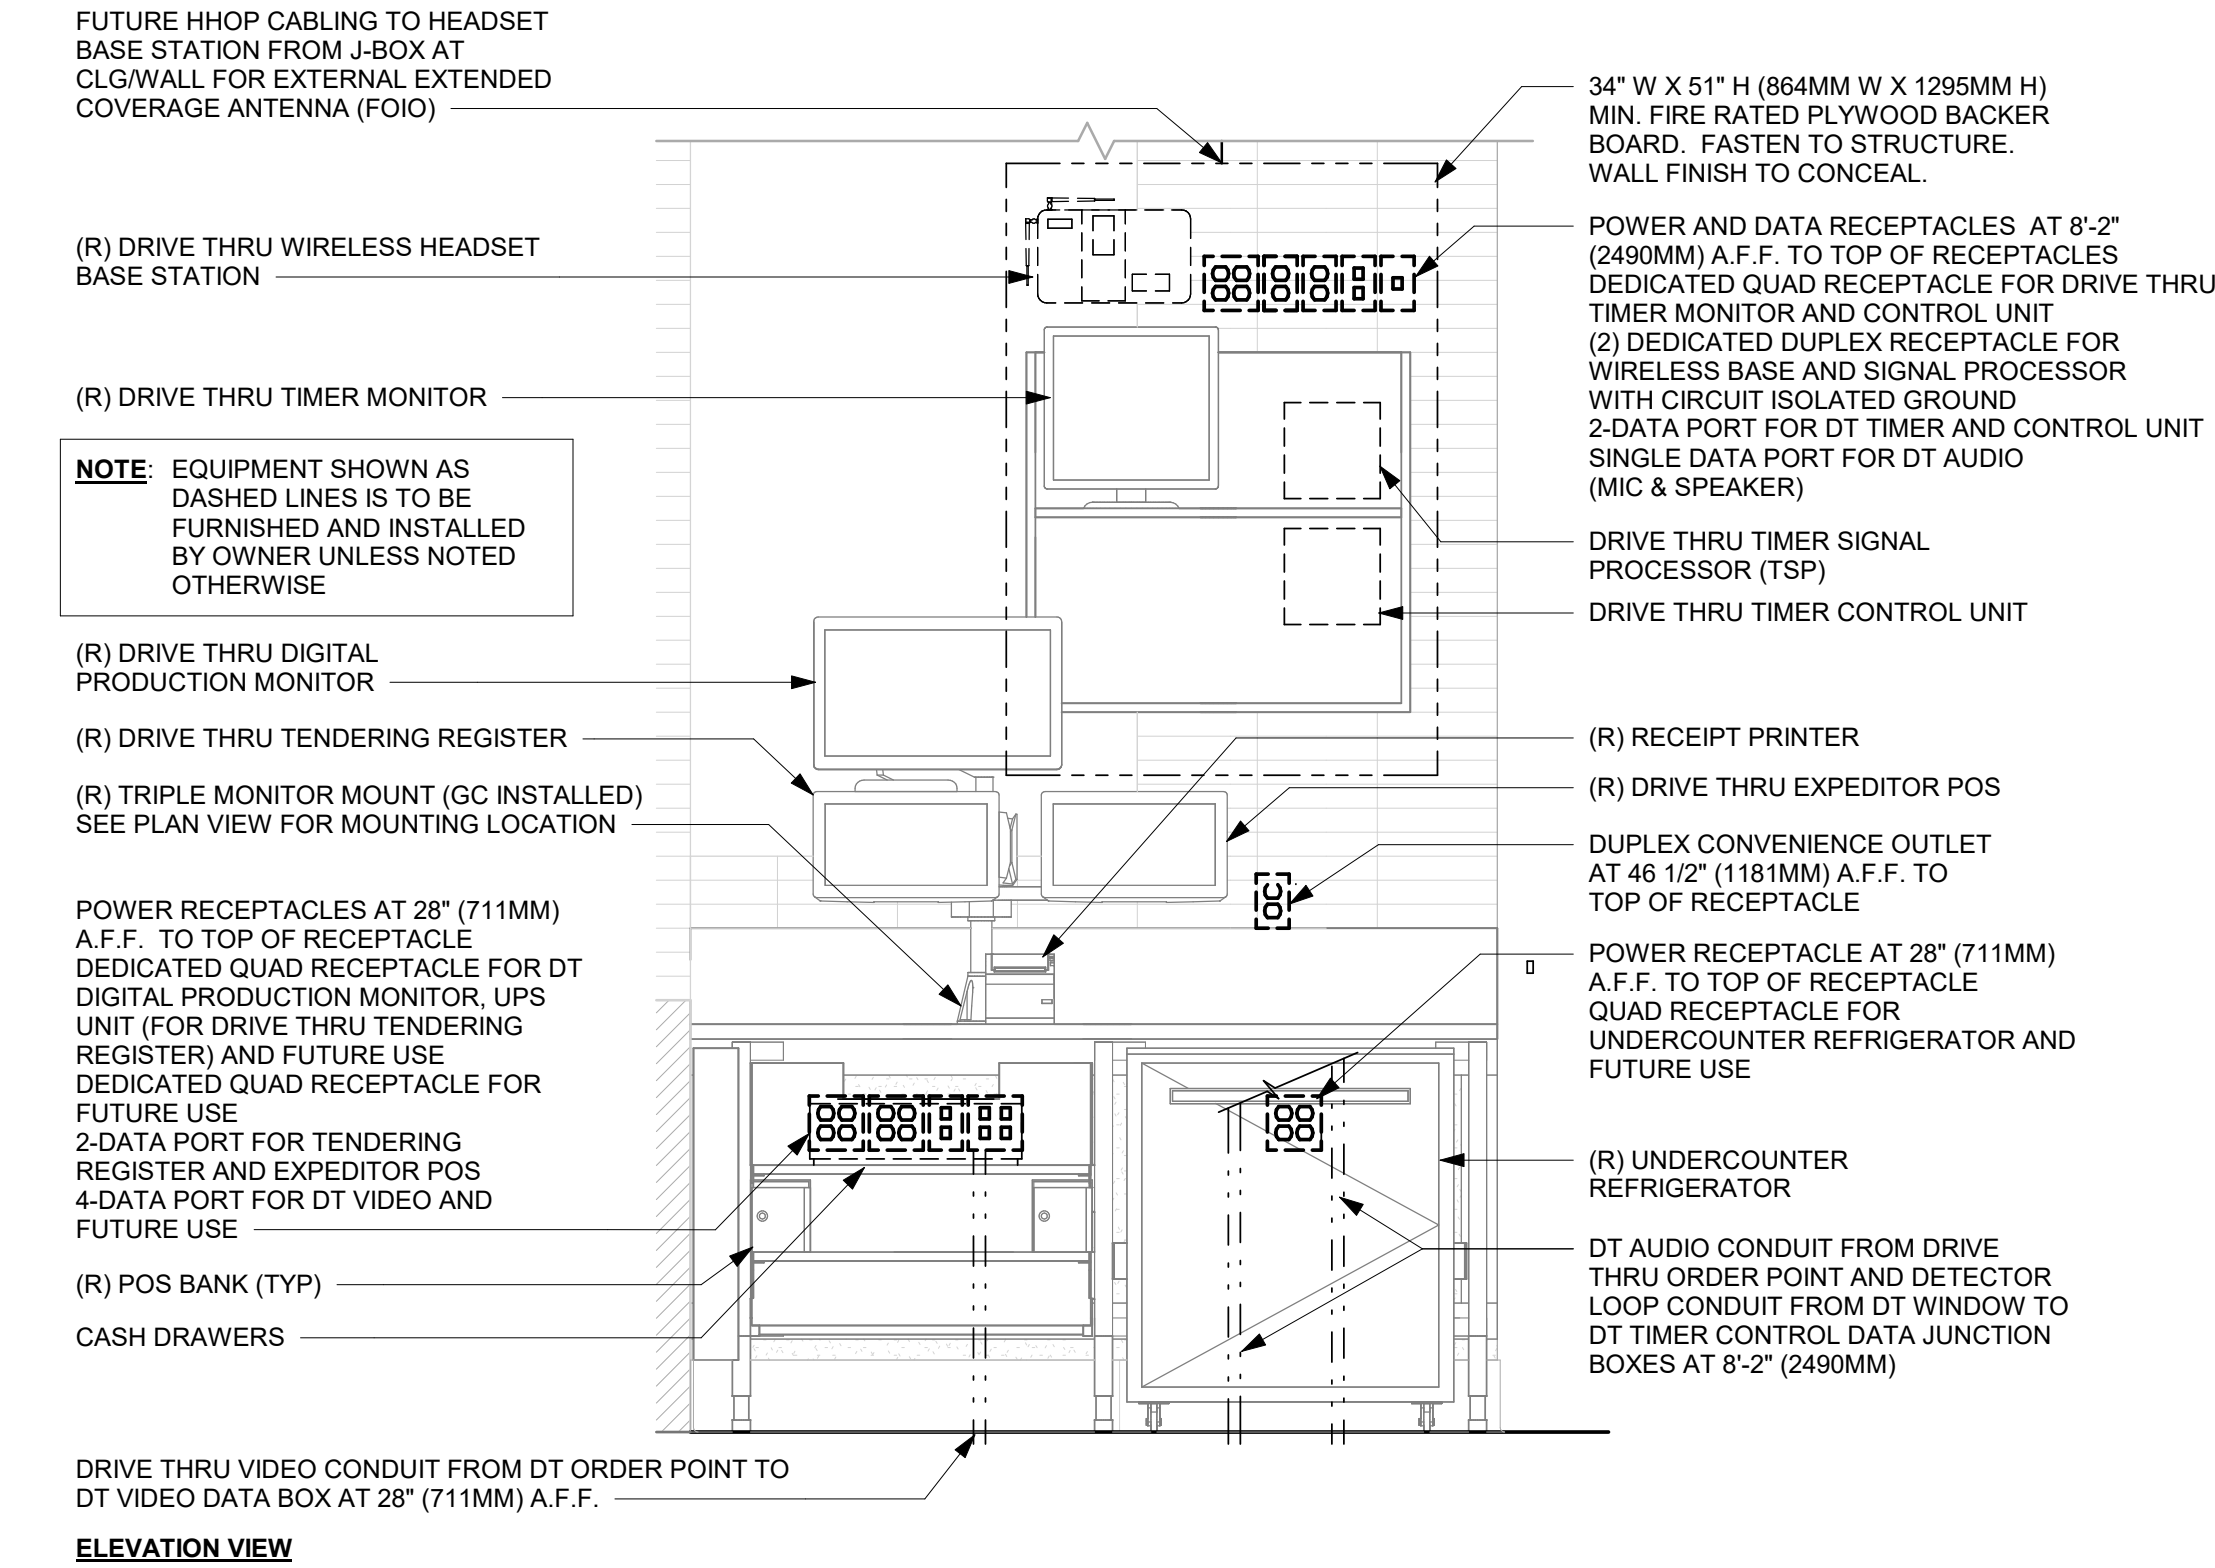


3 DRIVE - THRU POS DIAGRAM FOR REFERENCE ONLY
Scale: 3/4" = 1'-0"

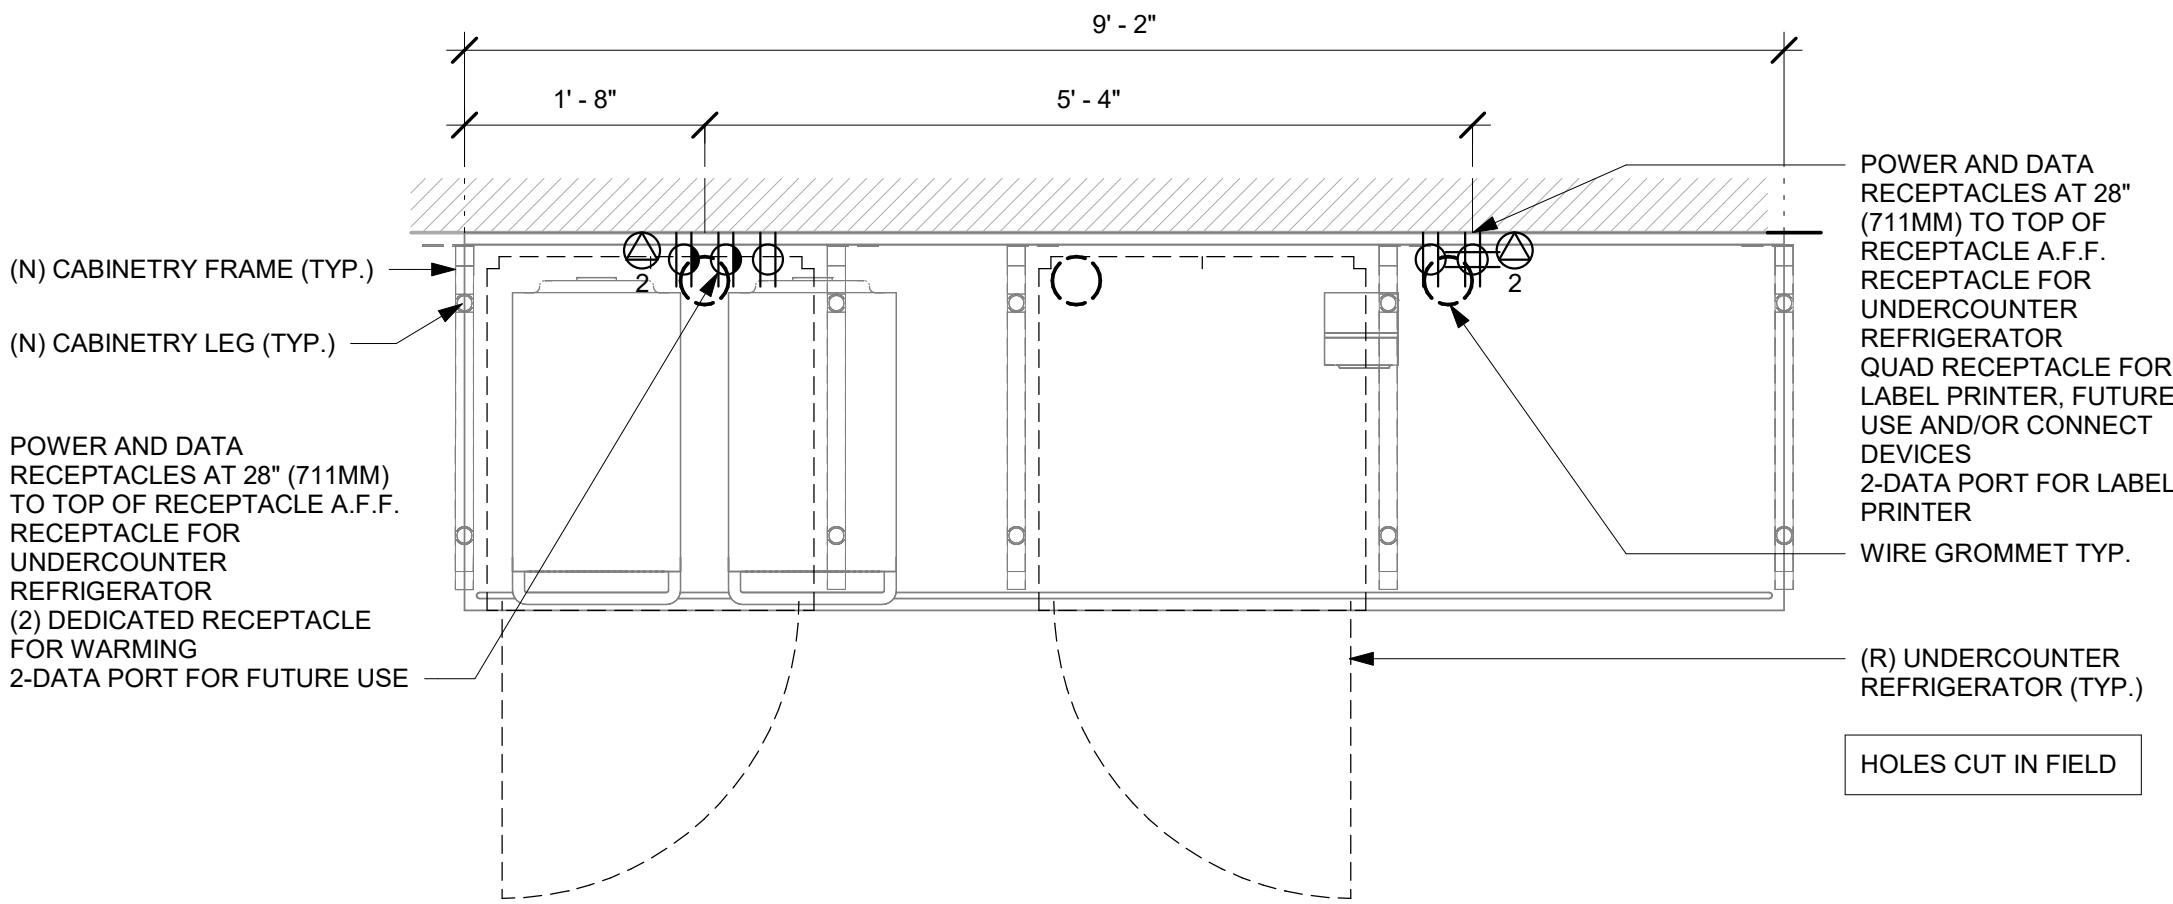


2 WARMING - ELECTRICAL FOR REFERENCE ONLY
Scale: 3/4" = 1'-0"

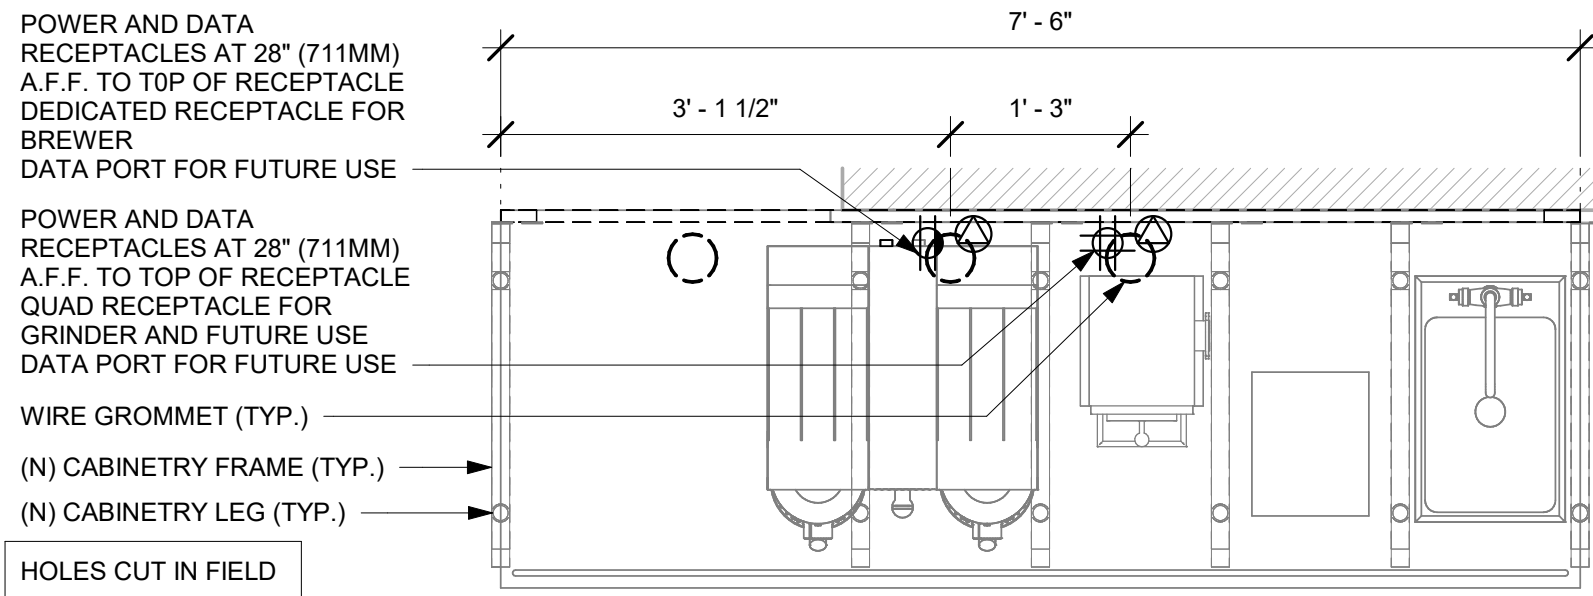


4 BREW - ELECTRICAL FOR REFERENCE ONLY
Scale: 3/4" = 1'-0"

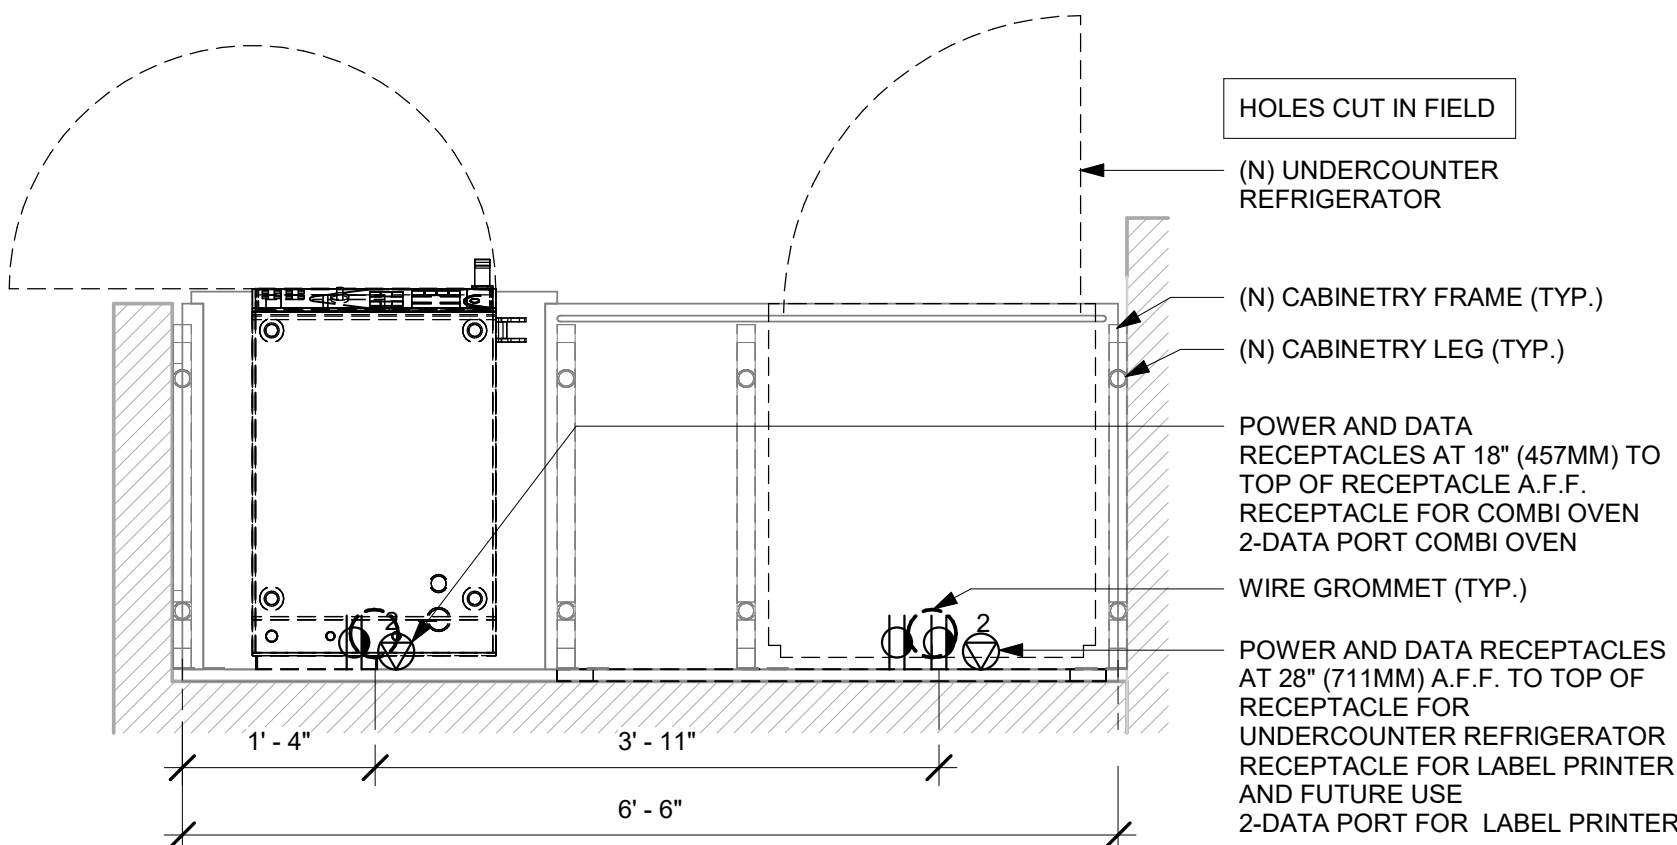

**PLAN -
ELECTRICAL DIAGRAM**

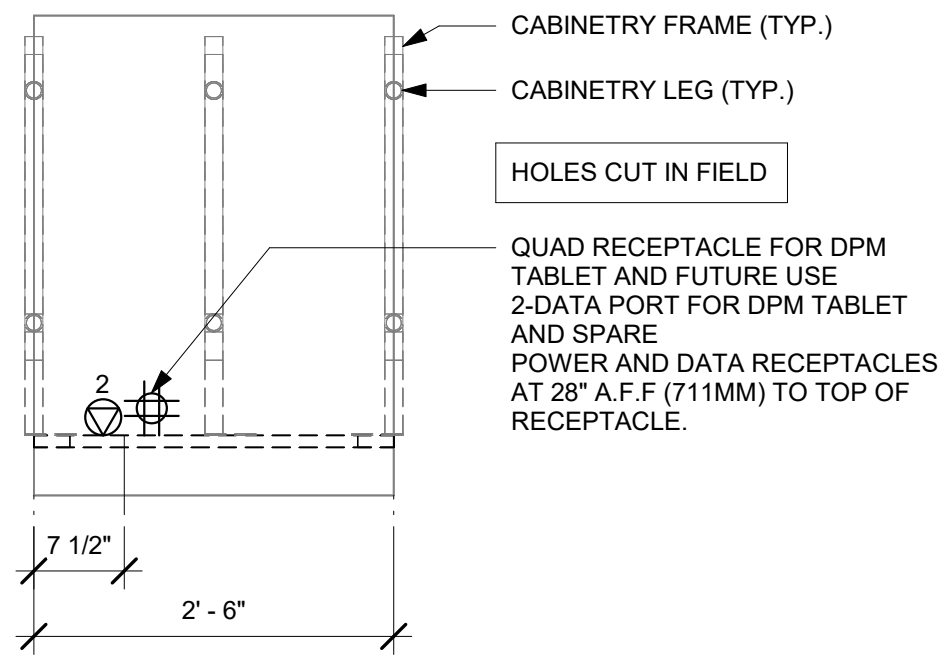

5 MOP - ELECTRICAL FOR REFERENCE ONLY
Scale: 3/4" = 1'-0"

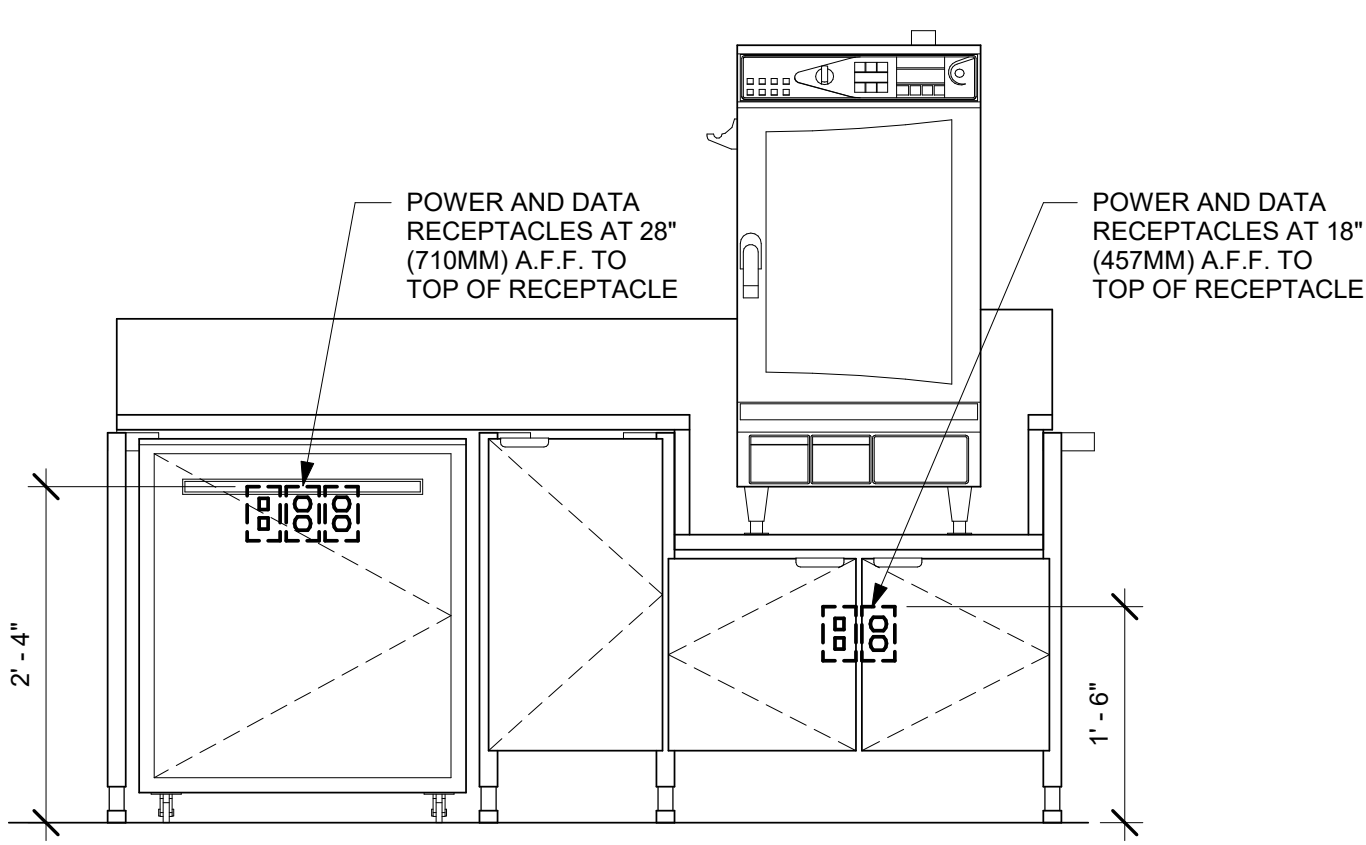

**ELEVATION -
ELECTRICAL DIAGRAM**

6 WRM - ELECTRICAL FOR REFERENCE ONLY
Scale: 3/4" = 1'-0"



© 2023 STARBUCKS COFFEE COMPANY

STARBUCKS®
2401 UTAH AVENUE SOUTH
SEATTLE, WASHINGTON 98134
(206) 318-1575

THESE DRAWINGS AND THE PROJECT MANUAL ARE CONFIDENTIAL AND SHALL REMAIN THE SOLE PROPERTY OF STARBUCKS CORPORATION, WHICH IS THE OWNER OF THE COPYRIGHT IN THIS WORK. THEY SHALL NOT BE REPRODUCED IN WHOLE OR IN PART, SHARED WITH THIRD PARTIES OR USED IN ANY MANNER ON OTHER PROJECTS OR EXTENSIONS TO THIS PROJECT WITHOUT THE PRIOR WRITTEN CONSENT OF STARBUCKS CORPORATION. THESE DRAWINGS AND SPECIFICATIONS ARE INTENDED TO EXPRESS DESIGN INTENT FOR A PROTOTYPICAL STARBUCKS STORE (WHICH IS SUBJECT TO CHANGE AT ANYTIME) AND DO NOT REFLECT ACTUAL SITE CONDITIONS. NEITHER PARTY SHALL HAVE ANY OBLIGATION NOR LIABILITY TO THE OTHER (EXCEPT STATED ABOVE) UNTIL A WRITTEN AGREEMENT IS FULLY EXECUTED BY BOTH PARTIES.

STARBUCKS TEMPLATE VERSION: i2023.10.23

**Design Forum
Architects Inc.**

2050 Byers Rd
Miami, OH 45342
Tel: (844) 804-7700

Donald J. Rehman
Architect In Charge
License: AR0017303

**MARQUE
ENGINEERING**
2230 PARK AVE, STE. 100, CINCINNATI, OH 45206
513.457.7131 - WWW.MARQUEENG.COM

FOR CONSTRUCTION

PROJECT NAME:
**S SEMORAN BLVD &
LEE VISTA BLVD**

PROJECT ADDRESS:
**6605 S SEMORAN BLVD
ORLANDO, FL 32822**

STORE #: 9875
PROJECT #: 25630-101
ISSUE DATE: 03/04/2024
DESIGN MANAGER: MARTIN PEREZ
PRODUCTION DESIGNER: ANDY MCLOUD
CHECKED BY: DONALD REHMAN


Revision Schedule			
Rev	Date	By	Description

SHEET TITLE:
INTERIOR DETAILS


SCALE: 3/4" = 1'-0"

SHEET NUMBER:
I-506


\\file-day.ad.changeupinc.com\Client\StarbucksArchitecture\Projects_2023\Florida\S Semoran & Lee Vista -25630-101\25630-101_9875_S Semoran Blvd & Lee Vista Blvd, FL_2023.rvt 3/4/2024 2:40:09 PM

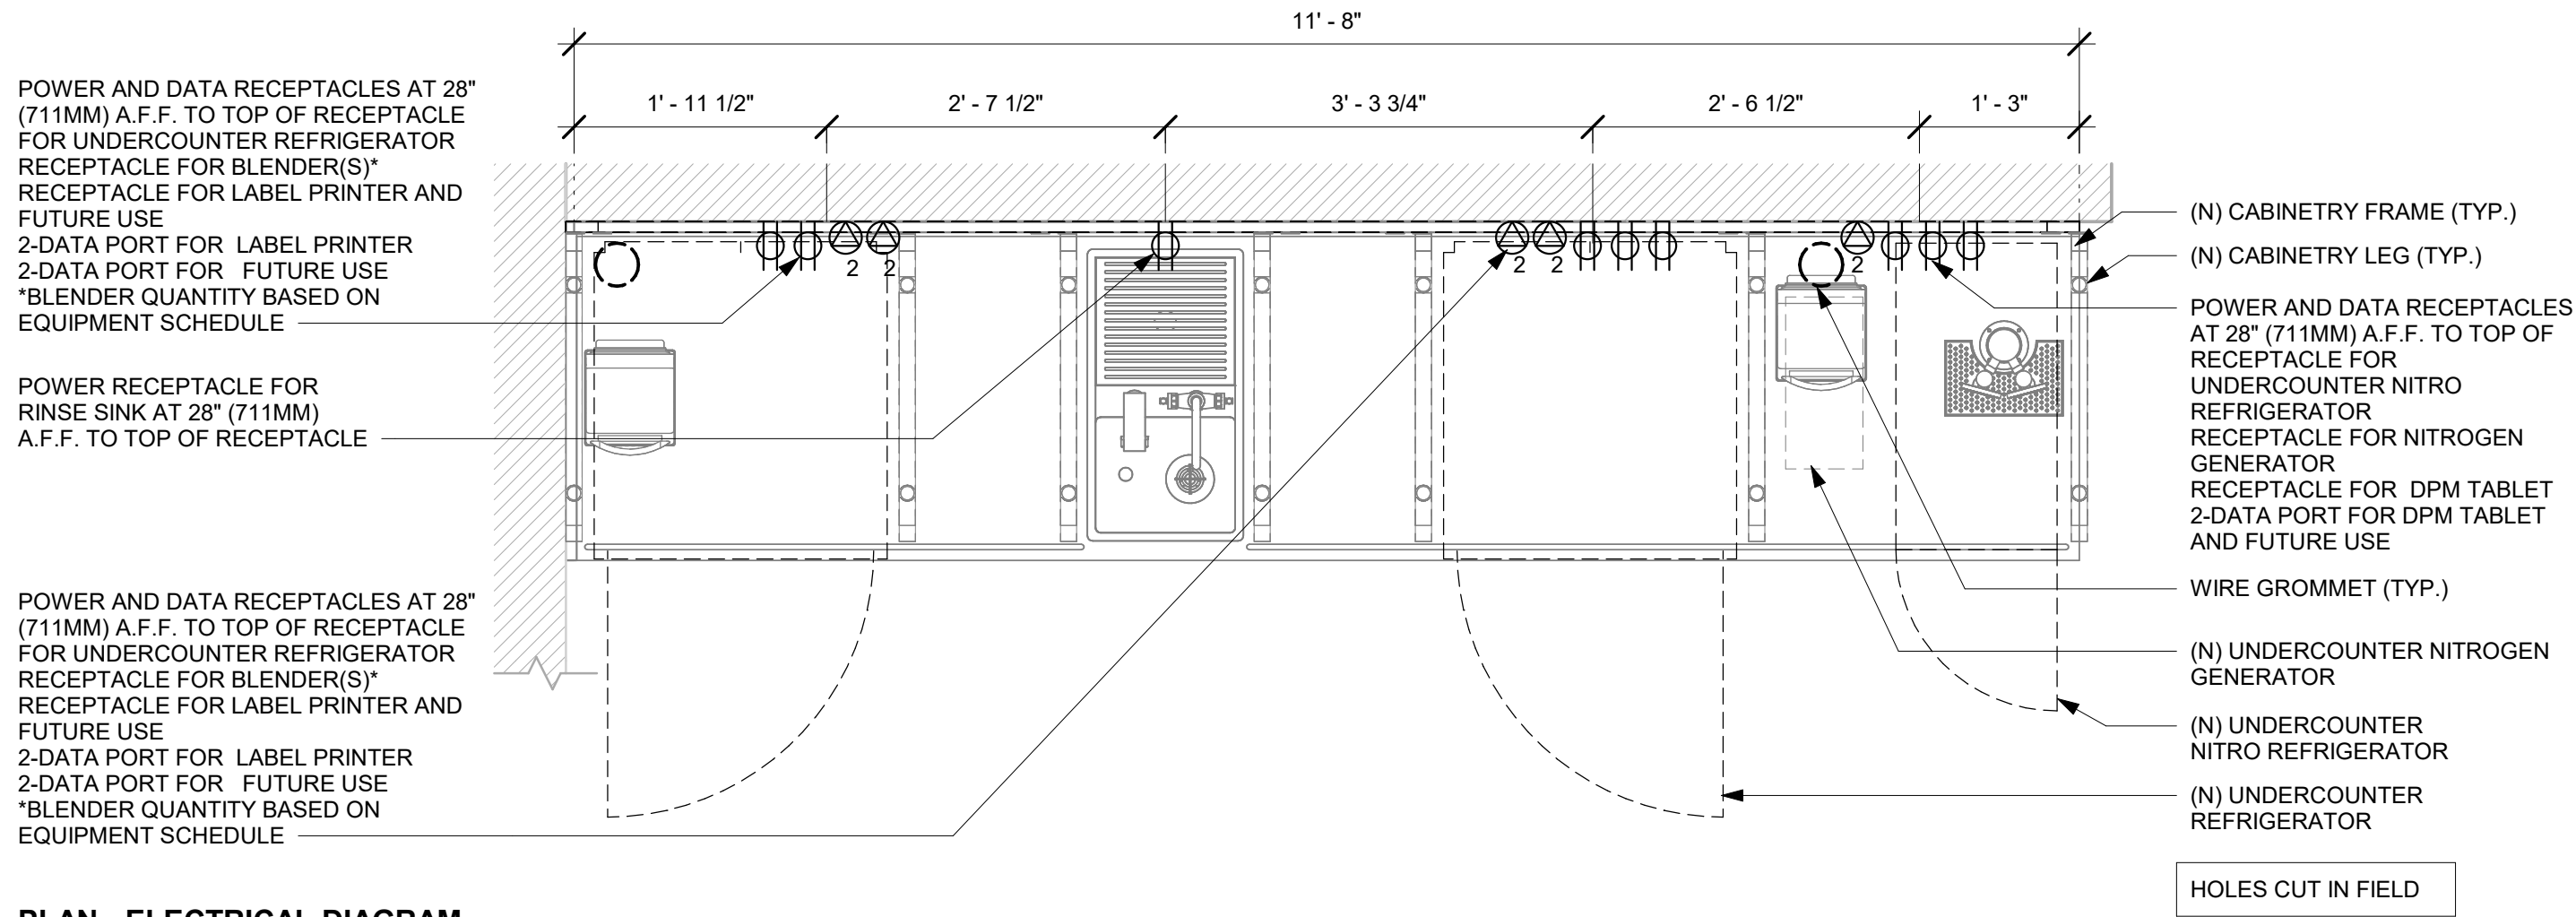



PLAN - ELECTRICAL DIAGRAM

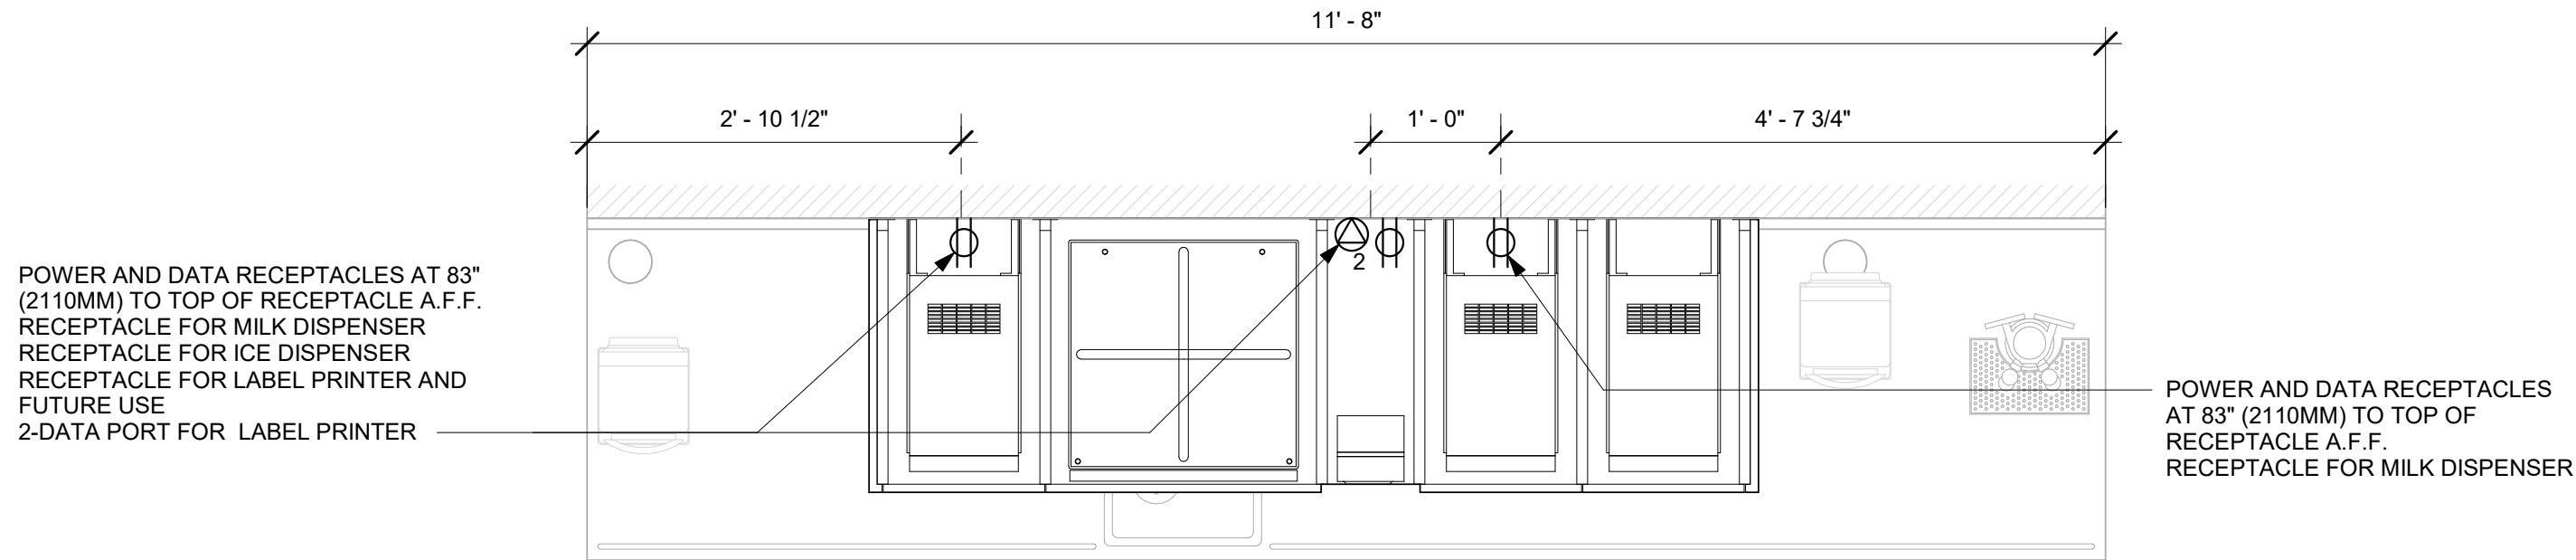

PLAN - UPPER ELECTRICAL DIAGRAM

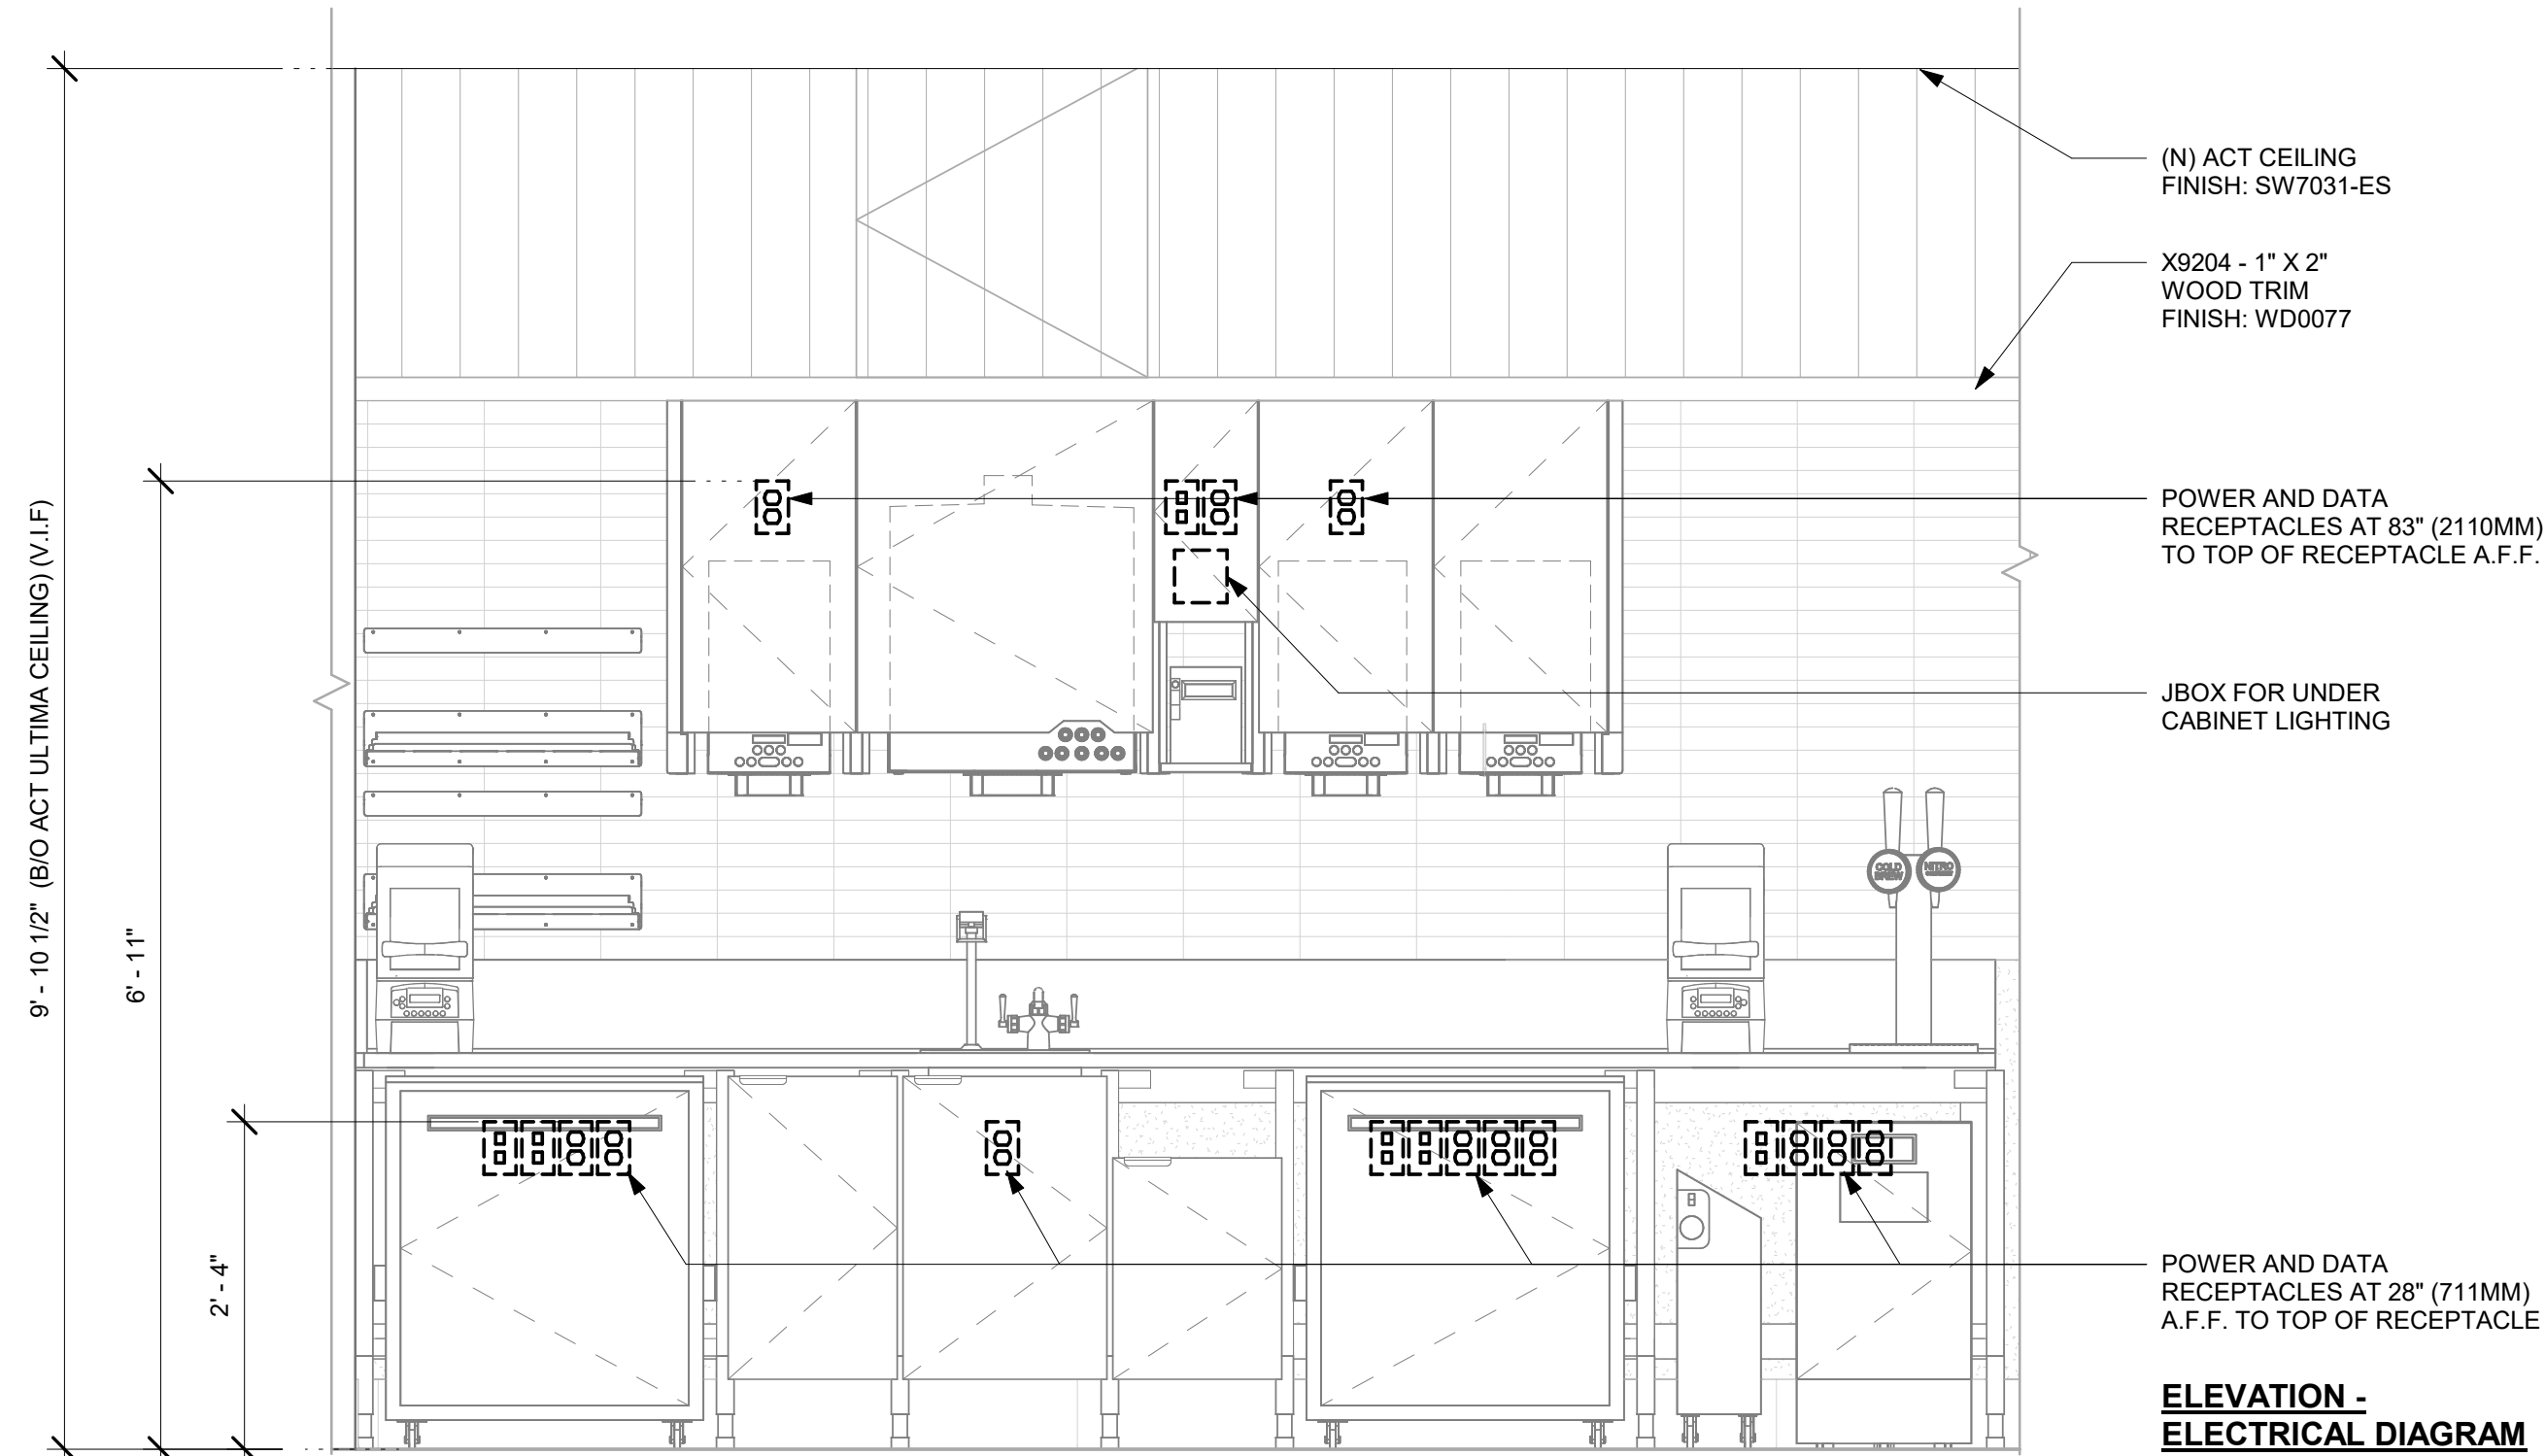

1 CBE - ELECTRICAL FOR REFERENCE ONLY

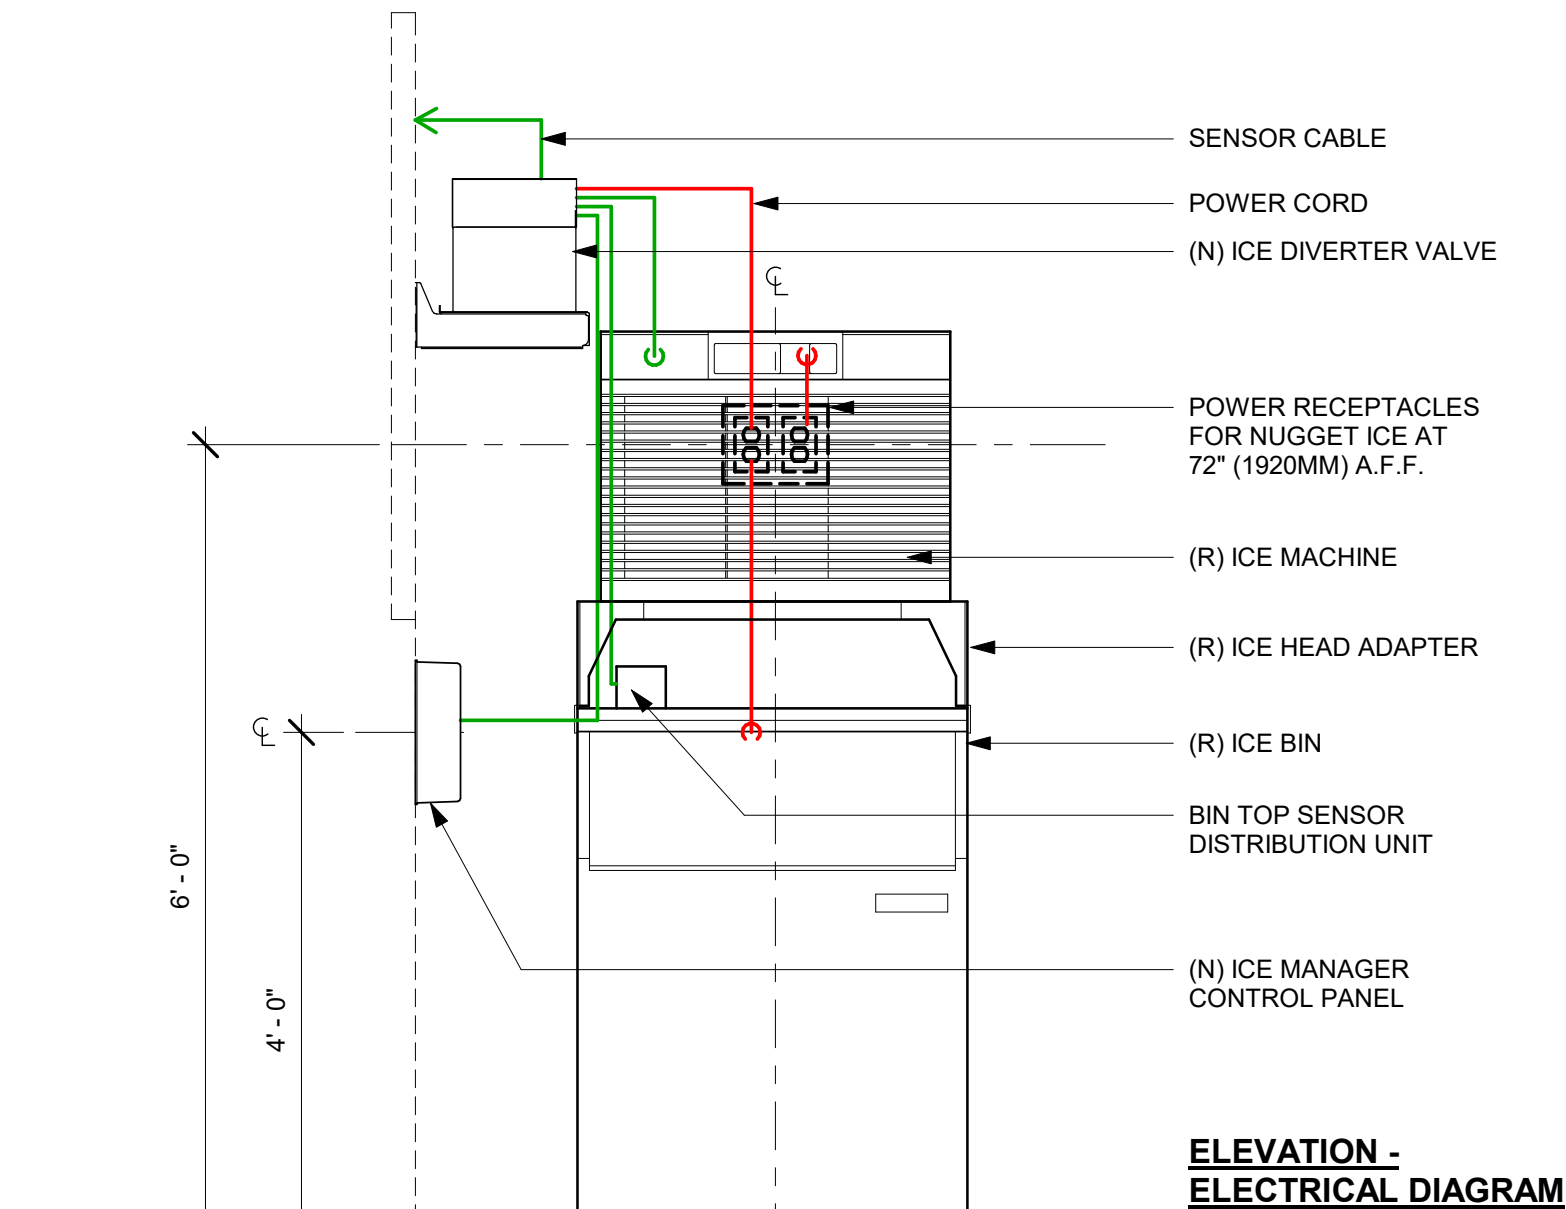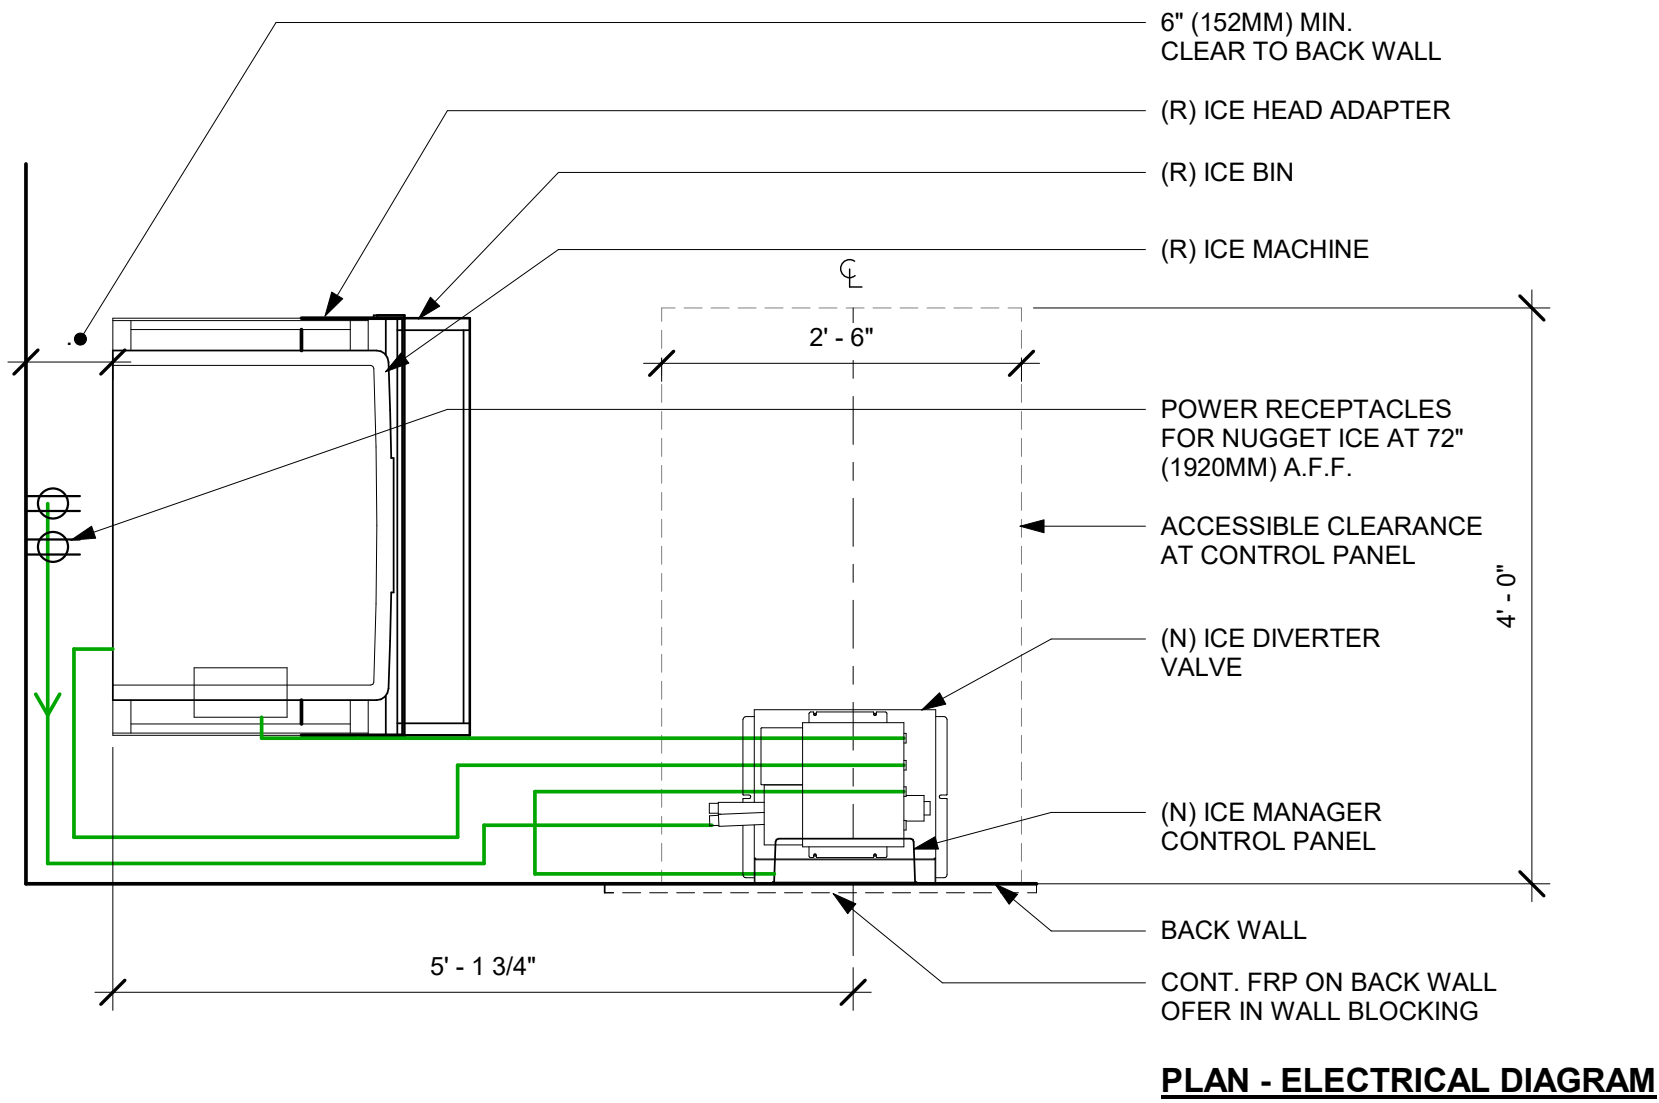

2 NUGGET ICE - ELECTRICAL FOR REFERENCE ONLY



STARBUCKS®
2401 UTAH AVENUE SOUTH
SEATTLE, WASHINGTON 98134
(206) 318-1575

THESE DRAWINGS AND THE PROJECT MANUAL ARE CONFIDENTIAL AND SHALL REMAIN THE SOLE PROPERTY OF STARBUCKS CORPORATION, WHICH IS THE OWNER OF THE COPYRIGHT IN THIS WORK. THEY SHALL NOT BE REPRODUCED IN WHOLE OR IN PART, SHARED WITH THIRD PARTIES OR USED IN ANY MANNER ON OTHER PROJECTS OR EXTENSIONS TO THIS PROJECT WITHOUT THE PRIOR WRITTEN CONSENT OF STARBUCKS CORPORATION. THESE DRAWINGS AND SPECIFICATIONS ARE INTENDED TO EXPRESS DESIGN INTENT FOR A PROTOTYPICAL STARBUCKS STORE (WHICH IS SUBJECT TO CHANGE AT ANYTIME) AND DO NOT REFLECT ACTUAL SITE CONDITIONS. NEITHER PARTY SHALL HAVE ANY OBLIGATION NOR LIABILITY TO THE OTHER (EXCEPT STATED ABOVE) UNTIL A WRITTEN AGREEMENT IS FULLY EXECUTED BY BOTH PARTIES.

STARBUCKS TEMPLATE VERSION: i2023.10.23

Design Forum Architects Inc.

2050 Byers Rd
Miami, FL 33136
Tel: (844) 804-7700

Donald J. Rehman
Architect In Charge
License: AR0017303

MARQUE ENGINEERING
2230 PARK AVE, STE. 100, CINCINNATI, OH 45206
513.457.7131 - WWW.MARQUEENG.COM

FOR CONSTRUCTION

PROJECT NAME:
S SEMORAN BLVD & LEE VISTA BLVD

PROJECT ADDRESS:
**6605 S SEMORAN BLVD
ORLANDO, FL 32822**

STORE #: 9875
PROJECT #: 25630-101
ISSUE DATE: 03/04/2024
DESIGN MANAGER: MARTIN PEREZ
PRODUCTION DESIGNER: ANDY MCLOUD
CHECKED BY: DONALD RETHMAN

Revision Schedule			
Rev	Date	By	Description


SHEET TITLE:
INTERIOR DETAILS

SCALE: 3/4" = 1'-0"

SHEET NUMBER:


I-507

\\file-day.ad.changeupinc.com\Client\StarbucksArchitecture\Projects_2023\Florida\Semoran & Lee Vista -25630-10\25630-101_9875_S Semoran Blvd & Lee Vista Blvd, FL_2023.rvt 3/4/2024 2:40:09 PM

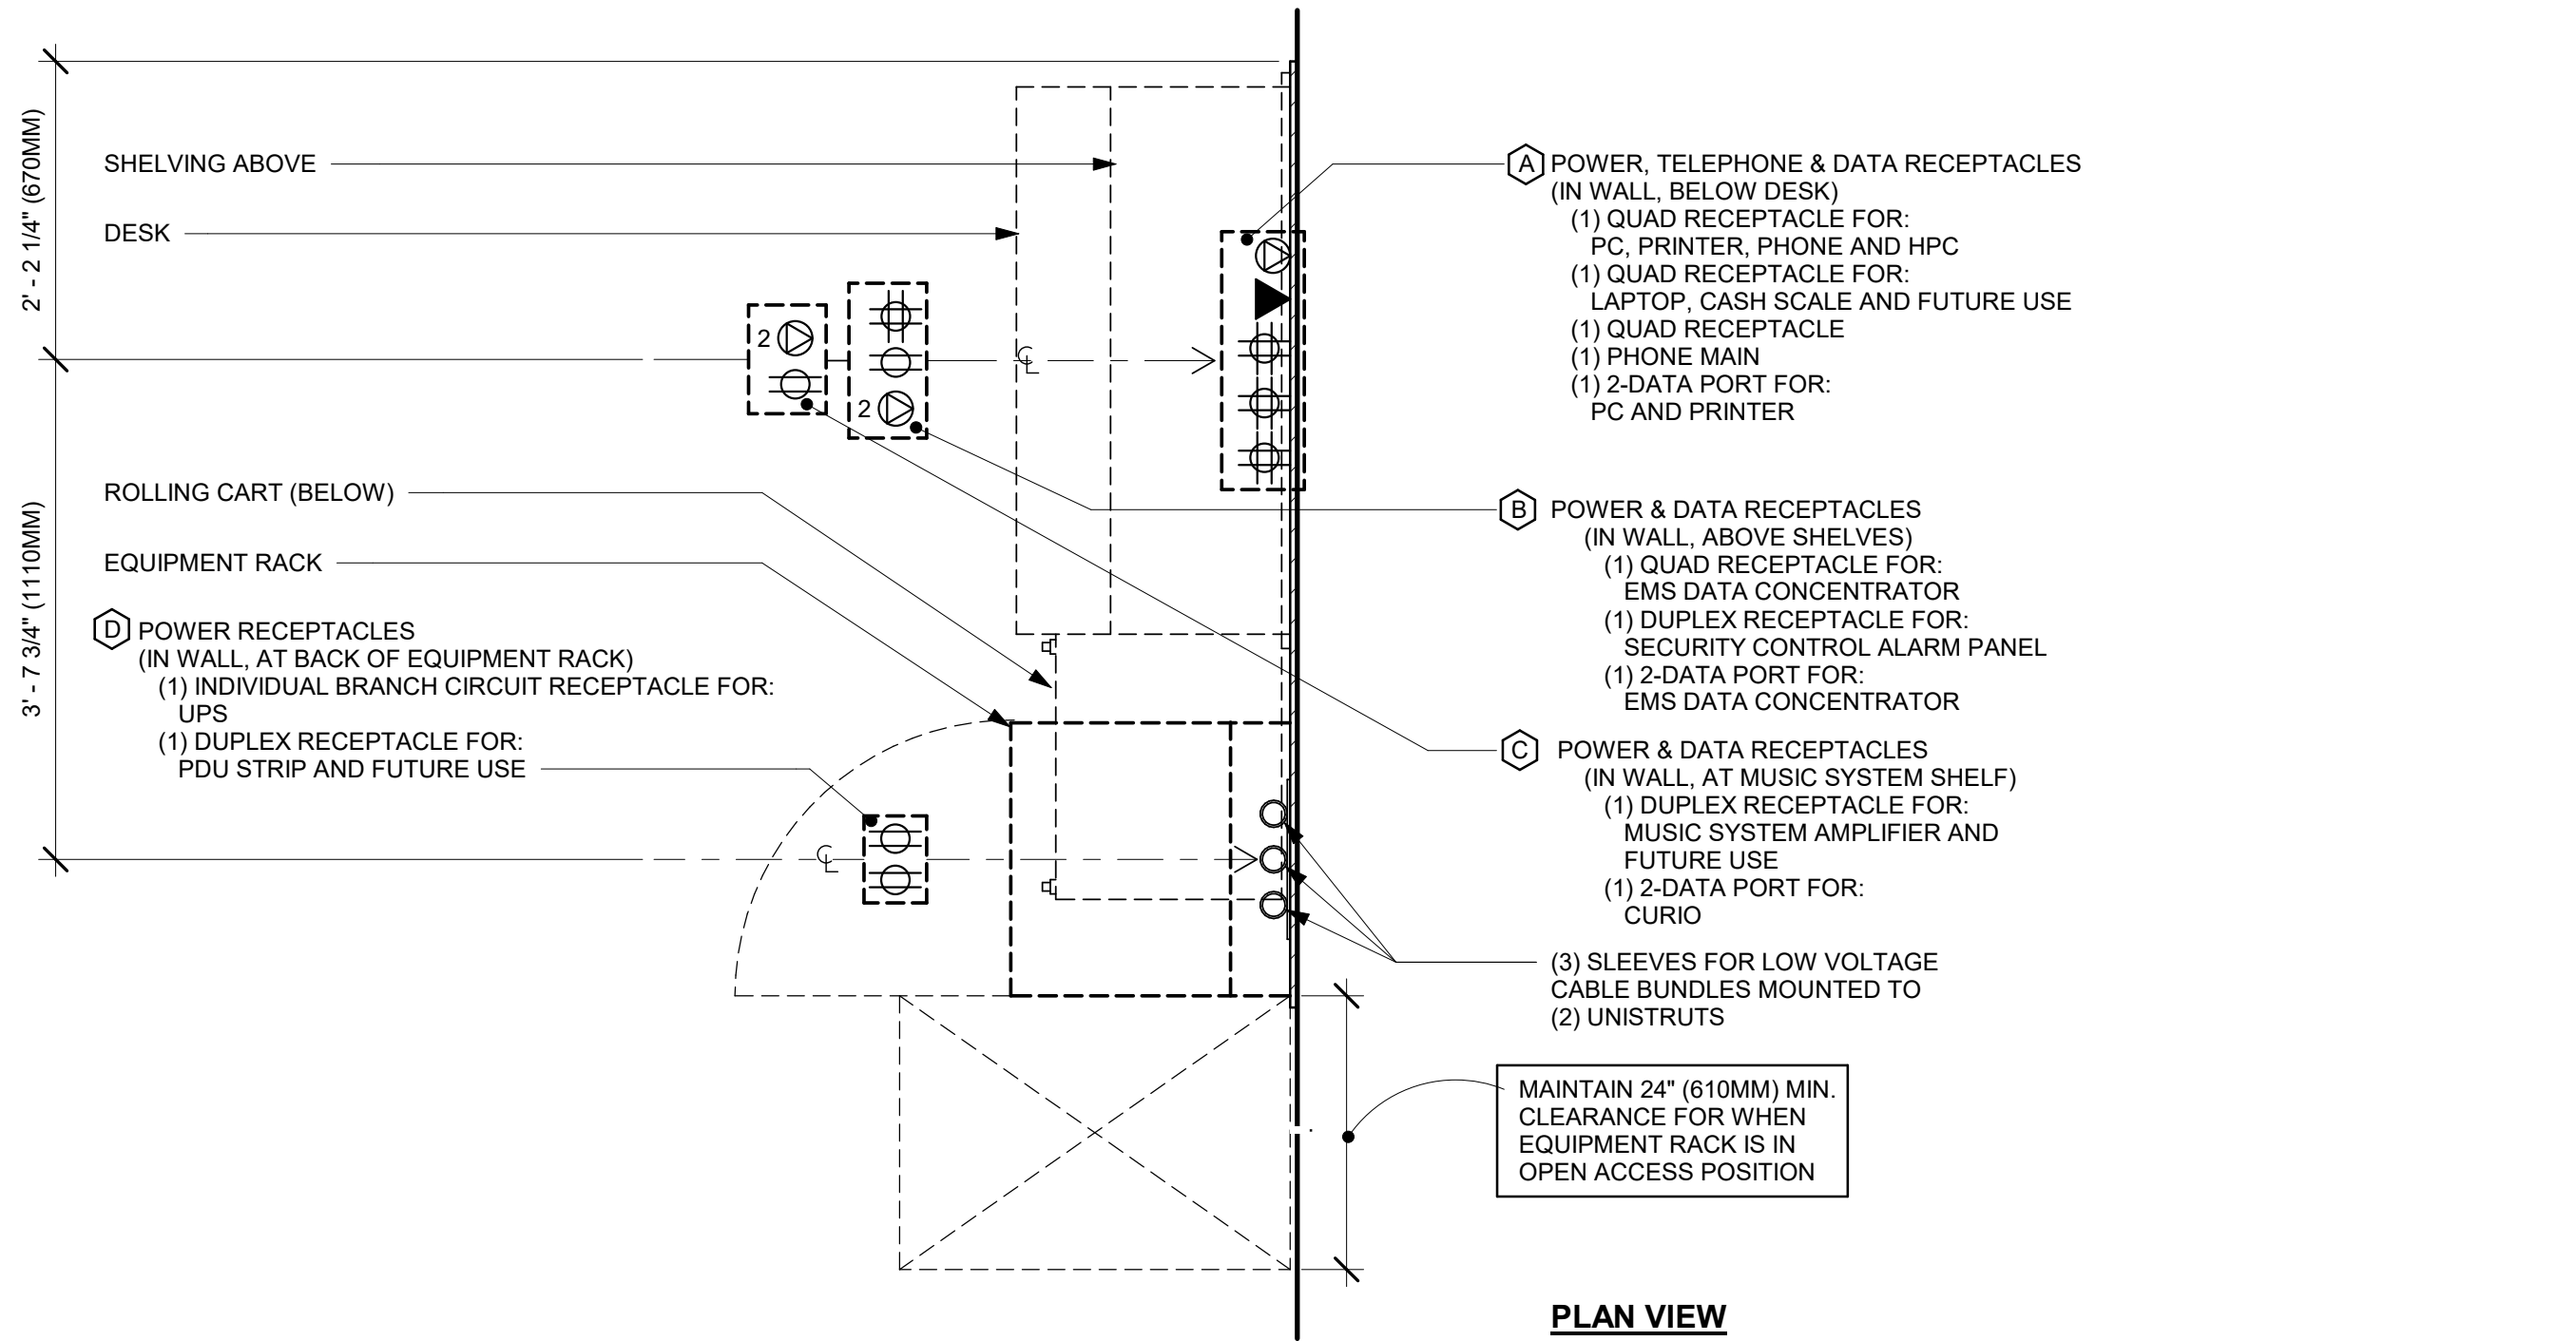

PLAN VIEW

LOW VOLTAGE CABLE BUNDLES		
① MUSIC PLAY NETWORK SPEAKERS	② SECURITY SECURITY PANEL FUTURE USE	③ POS HIGH SPEED INTERNET DEMARC EXTENSION POS LAN DT TIMER

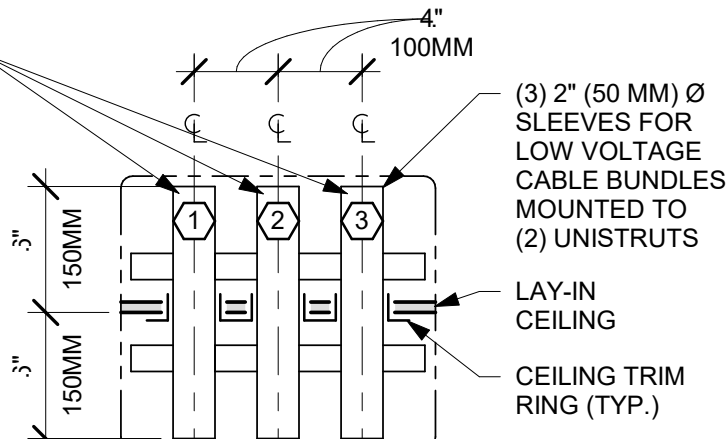

ENLARGED VIEW

CEILING HEIGHT SHOWN AT 120" (3048MM). REFER TO REFLECTED CEILING PLAN(S) FOR ACTUAL HEIGHT.

IOT GATEWAY
SECURITY CONTROL ALARM PANEL
EMS DATA CONCENTRATOR.
ALLOW 2" (50 MM) IN. CLEAR ABOVE
DEMARC, IF REQUIRED

WIRELESS MODEM AT 84" (2130 MM) A.F.F. STARBUCKS VENDOR TO DETERMINE OPTIMAL DEVICE LOCATION

POWER AND DATA RECEPTACLES AT 80" (2030MM) A.F.F. TO CENTER OF GROUPING. SEE NOTE 'B' ABOVE FOR DESCRIPTION

WALL MOUNTED SHELVING UNIT ATTACHED TO BACKER BOARD

POWER AND DATA RECEPTACLES AT 80" (2030MM) A.F.F. TO CENTER OF GROUPING. SEE NOTE 'C' ABOVE FOR DESCRIPTION.

MUSIC SYSTEM PLAYER AND AMPLIFIER (FURNISHED BY OWNER, INSTALLED WITH SPEAKER SYSTEM BY GC) ON 14" DEEP (355MM) SHELF ONLY (MIN.) (NOT IN EQUIP. RACK).

HOME PHONE CONNECT (HPC)
CORDLESS 1 LINE PHONE

OFFICE PC
DESK
LAPTOP

IPOD TOUCH CHARGING CRADLE

POWER, TELEPHONE & DATA RECEPTACLES AT 12" (305MM) A.F.F. TO CENTER OF GROUPING. SEE NOTE 'A' ABOVE FOR DESCRIPTION

MINI GROUND BAR FOR EQUIPMENT RACK. GC TO COORDINATE RACK GROUNDING TO BAR WITH #6 GROUND WIRE AND PER JURISDICTIONAL REQUIREMENTS
MOUNT GROUND BAR AT 86" (2185 MM) A.F.F.

MAINTAIN 24" (305 MM) MIN. CLEAR FOR EQUIP. RACK IN OPEN ACCESS POSITION) ACCESS. SEE PLAN VIEW ABOVE

POWER & DATA RECEPTACLES AT 69 1/2" (1765 MM) A.F.F. TO CENTER OF GROUPING. SEE NOTE 'D' ABOVE FOR DESCRIPTION.

MOUNT EQUIPMENT RACK AT 56" (1420 MM) A.F.F.

EQUIPMENT RACK WALL MOUNTED TO STRUCTURE BY STARBUCKS VENDOR (GC TO COORDINATE INSTALLATION). GROUND RACK PER MFR'S ASSEMBLY INSTRUCTIONS. SEE EQUIPMENT RACK SCHEDULE BELOW FOR EQUIPMENT INCLUDED WITHIN.

SECURITY MONITOR MOUNTED ON MONITOR ARM (ATTACHED TO BACKER BOARD).

SECURE KEY BOX
PRINTER

CASH SCALE
83" W X 96" H (2110MM W X 2440MM H) MIN. 3/4" FIRE RATED PLYWOOD BACKER BOARD. FASTEN TO STRUCTURE TO HOLD MIN. 350 PSF. PAINTABLE SURFACE ON ROOM SIDE & FINISH AS SCHEDULED.

ROLLING CART


ELEVATION VIEW

NOTE: EQUIPMENT SHOWN AS DASHED LINES IS TO BE FURNISHED AND INSTALLED BY OWNER UNLESS NOTED OTHERWISE.

EQUIPMENT RACK SCHEDULE		
UPS	NETWORK SWITCH	SECURITY RECORDER (NVR)
IPS EQUIPMENT	PATCH PANEL	SECURITY KEYBOARD
ROUTER	PRODUCTION CONTROLLER DEVICES	



1 MANAGER DESK (NEW) AND EQUIPMENT RACK RIGHT- ELECTRICAL

Scale: 3/4" = 1'-0"

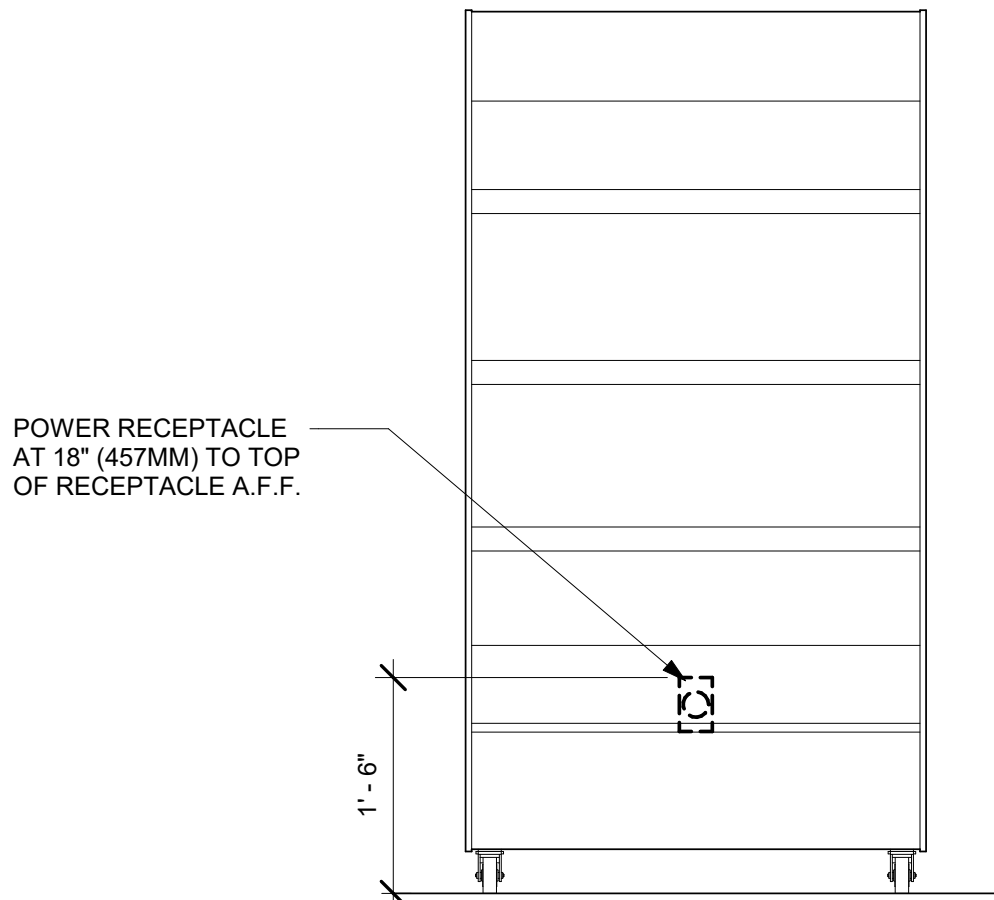


2 WARMING WALL 1000 ELECTRICAL

Scale: 3/4" = 1'-0"

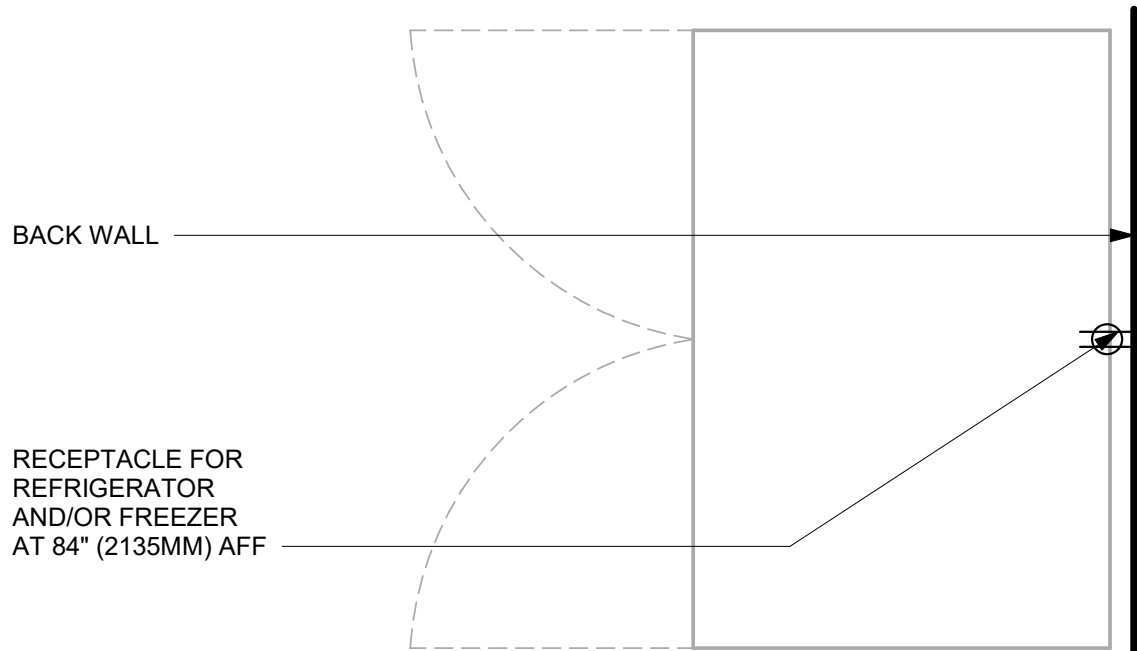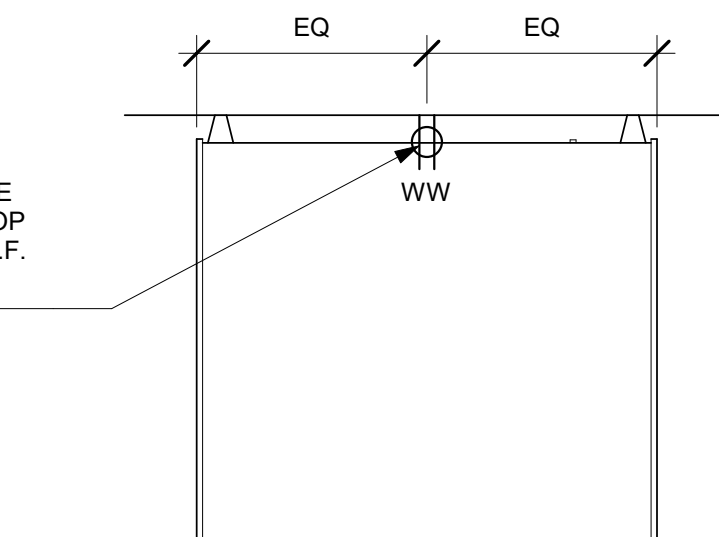


3 REFRIGERATOR/FREEZER - ELECTRICAL

Scale: 3/4" = 1'-0"

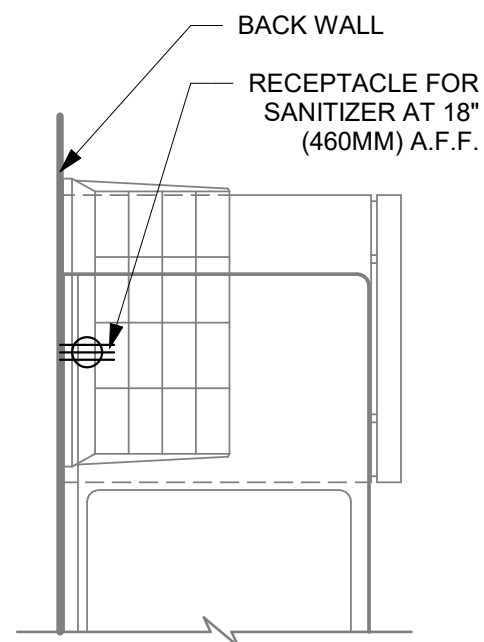

4 SANITIZING WORKSTATION - ELECTRICAL

Scale: 3/4" = 1'-0"

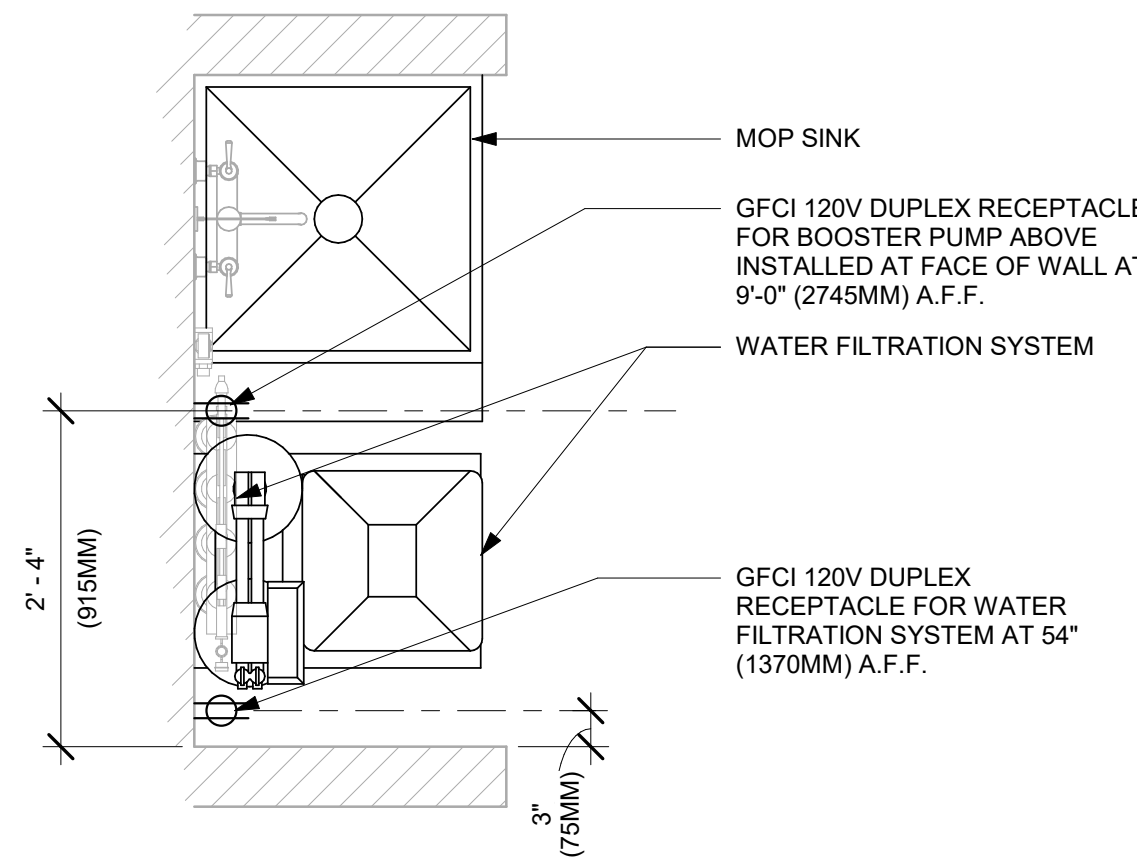

5 WATER FILTRATION - CONFIGURATION II

Scale: 3/4" = 1'-0"



© 2023 STARBUCKS COFFEE COMPANY

STARBUCKS®
2401 UTAH AVENUE SOUTH
SEATTLE, WASHINGTON 98134
(206) 318-1575


THESE DRAWINGS AND THE PROJECT MANUAL ARE CONFIDENTIAL AND SHALL REMAIN THE SOLE PROPERTY OF STARBUCKS CORPORATION, WHICH IS THE OWNER OF THE COPYRIGHT IN THIS WORK. THEY SHALL NOT BE REPRODUCED IN WHOLE OR IN PART, SHARED WITH THIRD PARTIES OR USED IN ANY MANNER ON OTHER PROJECTS OR EXTENSIONS TO THIS PROJECT WITHOUT THE PRIOR WRITTEN CONSENT OF STARBUCKS CORPORATION. THESE DRAWINGS AND SPECIFICATIONS ARE INTENDED TO EXPRESS DESIGN INTENT FOR A PROTOTYPICAL STARBUCKS STORE (WHICH IS SUBJECT TO CHANGE AT ANYTIME) AND DO NOT REFLECT ACTUAL SITE CONDITIONS. NEITHER PARTY SHALL HAVE ANY OBLIGATION NOR LIABILITY TO THE OTHER (EXCEPT STATED ABOVE) UNTIL A WRITTEN AGREEMENT IS FULLY EXECUTED BY BOTH PARTIES.

STARBUCKS TEMPLATE VERSION: i2023.10.23

Design Forum Architects Inc.

2050 Byers Rd
Miamisburg, OH 45342
Tel: (844) 804-7700

Donald J. Rehmman
Architect In Charge
License: AR0017303

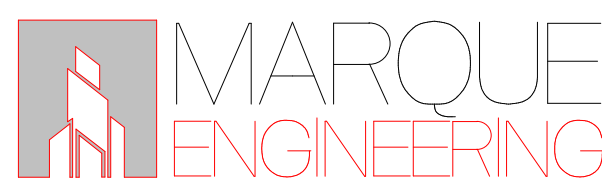

2230 PARK AVE, STE. 100, CINCINNATI, OH 45206
513.457.7131 - WWW.MARQUEENG.COM

FOR CONSTRUCTION

PROJECT NAME:
S SEMORAN BLVD & LEE VISTA BLVD

PROJECT ADDRESS:
**6605 S SEMORAN BLVD
ORLANDO, FL 32822**

STORE #: 9875
PROJECT #: 25630-101
ISSUE DATE: 03/04/2024
DESIGN MANAGER: MARTIN PEREZ
PRODUCTION DESIGNER: ANDY MCLOUD
CHECKED BY: DONALD RETHMAN

Revision Schedule			
Rev	Date	By	Description

SHEET TITLE:
INTERIOR DETAILS


SCALE: 3/4" = 1'-0"

SHEET NUMBER:

I-508


\\file-day.ad.changeupinc.com\Client\StarbucksArchitecture\Projects_2023\Florida\Semoran & Lee Vista - 25630-10\25630-101_9875_S Semoran Blvd & Lee Vista Blvd, FL_2023.rvt 3/4/2024 2:40:10 PM

NOTE:
SHOP DRAWINGS TO BE APPROVED BY
SB DESIGNER PRIOR TO FABRICATION.

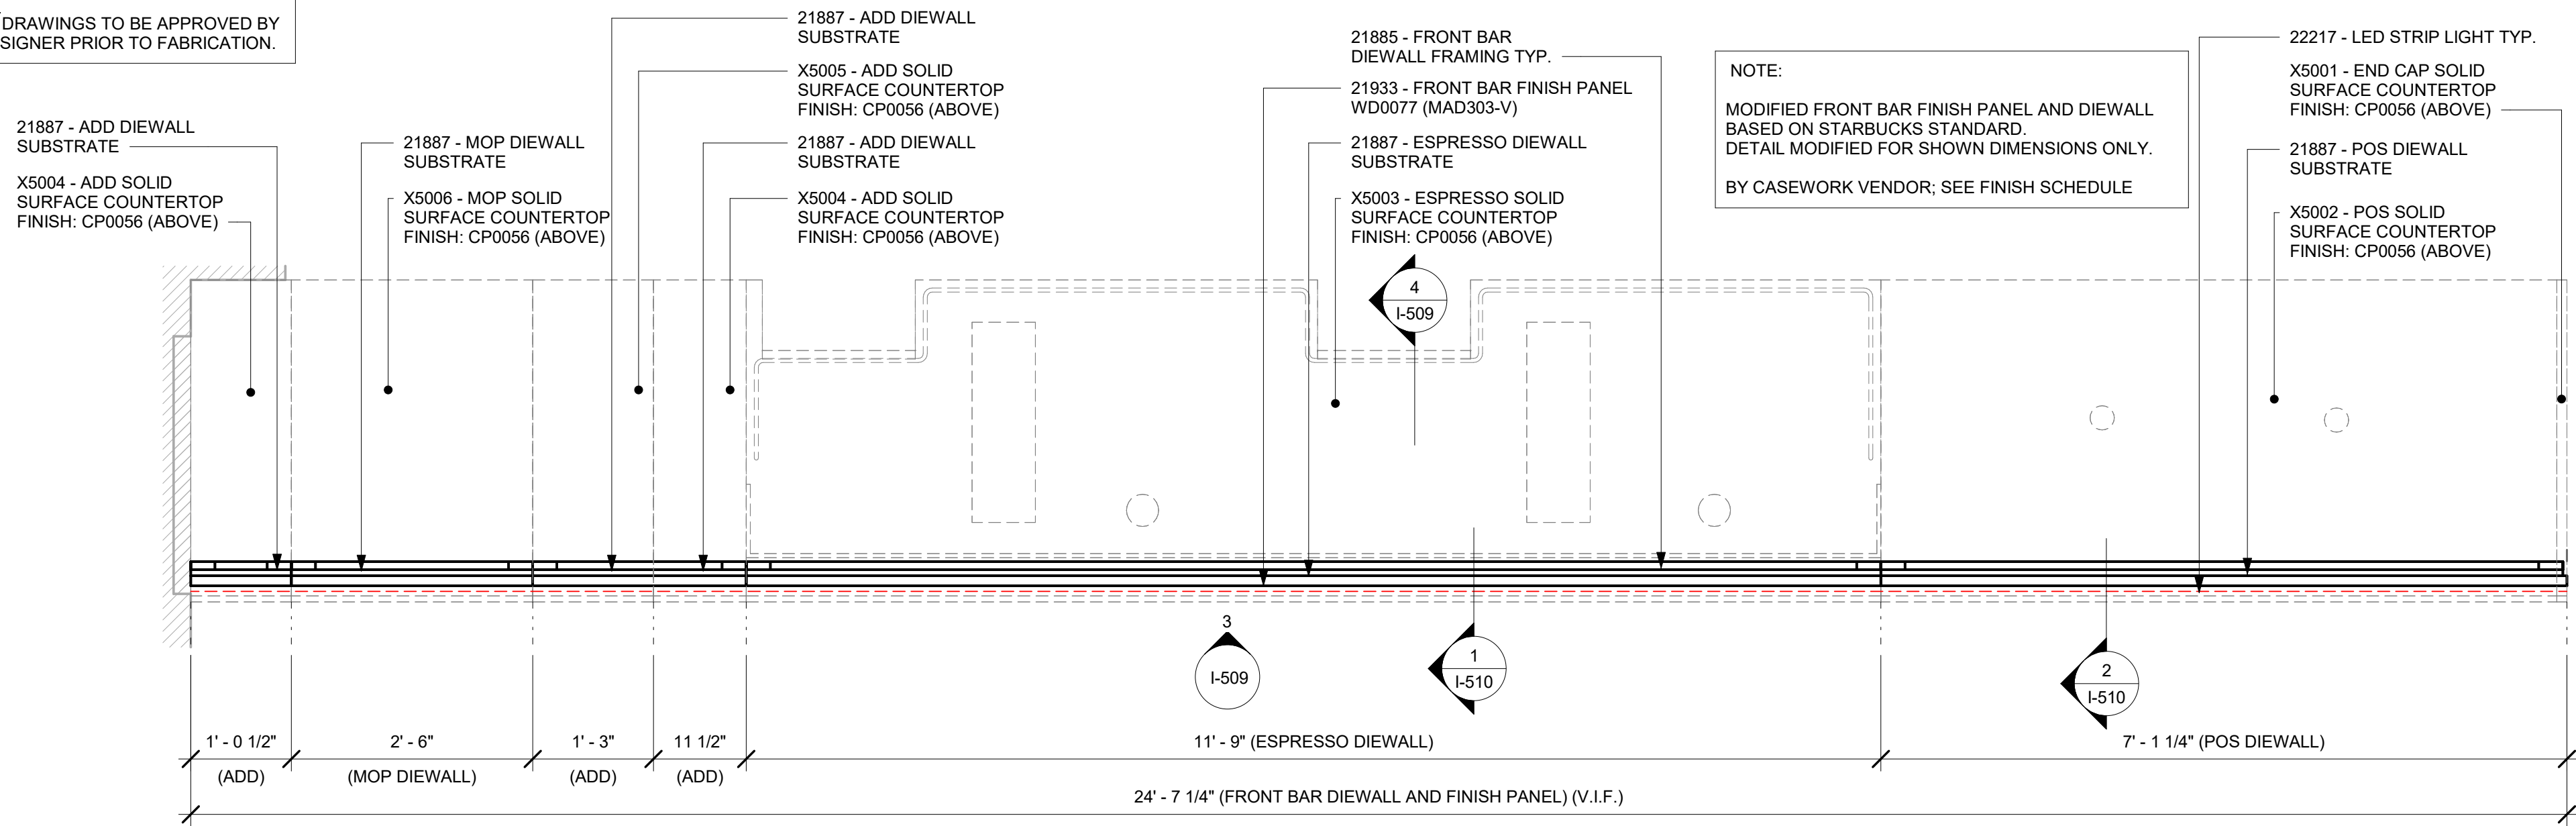


1 FRONT BAR - DIEWALL AND FINISH PANEL - PLAN

Scale: 3/4" = 1'-0"

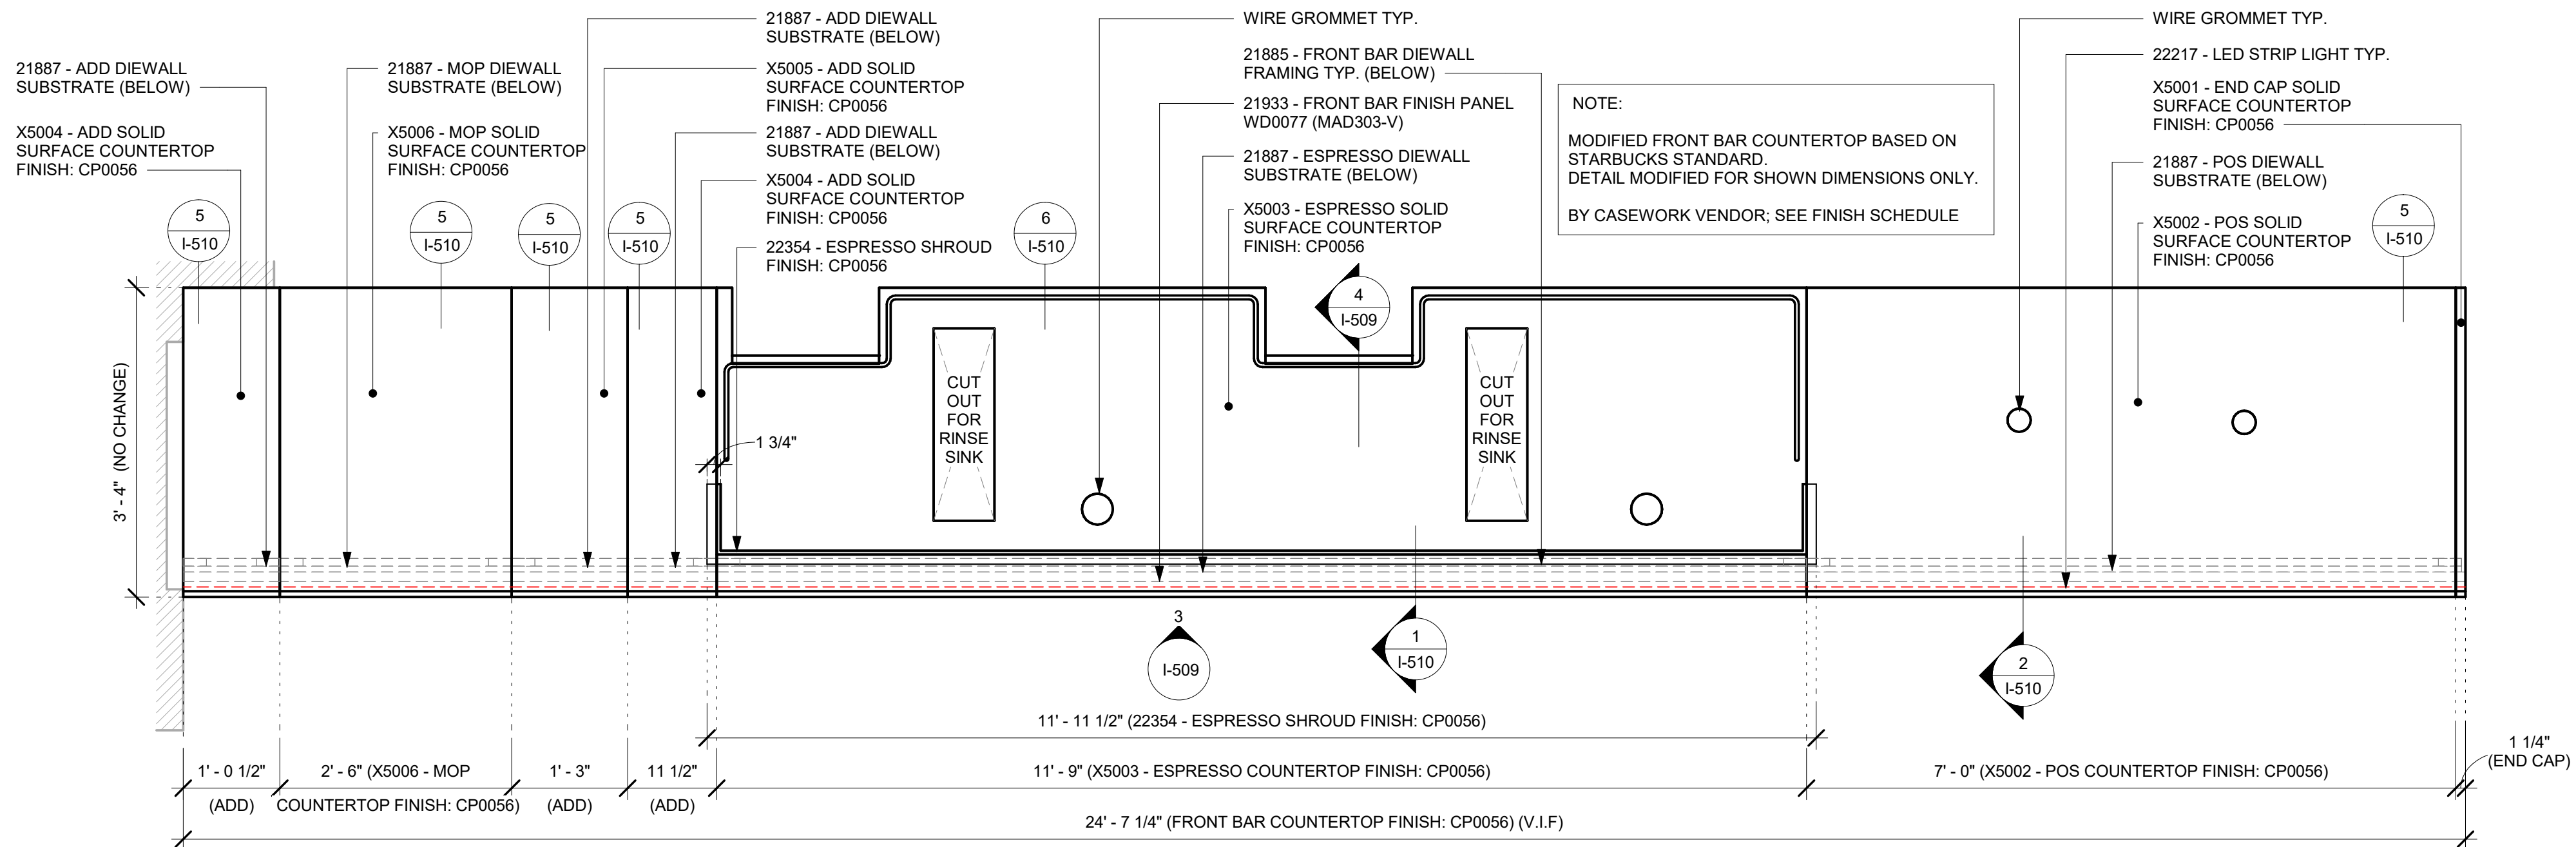

2 FRONT BAR COUNTERTOP - PLAN

Scale: 3/4" = 1'-0"

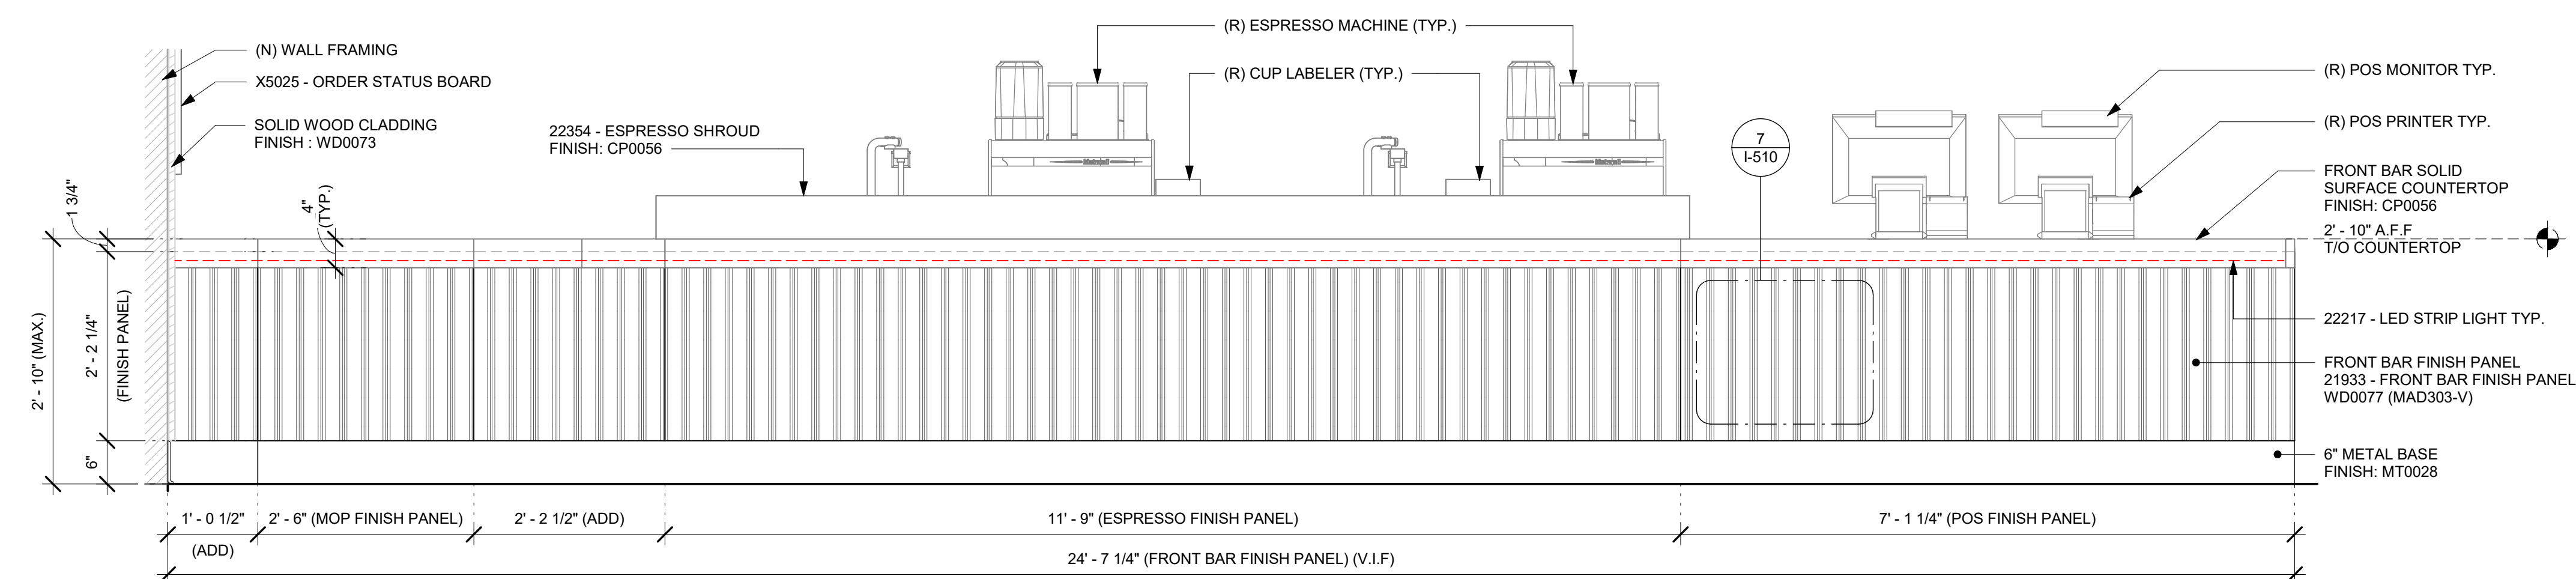

3 FRONT BAR FINISH PANEL - ELEVATION

Scale: 3/4" = 1'-0"

- NOTES:**
- LOCATE PUMP WITHIN CORD LENGTH LIMIT. ORIENT WITH PUMP HEAD LEFT, RIGHT AND AT BOTTOM. LOOSEN PUMP HEAD CLAMP, ROTATE AND RE-TIGHTEN AS REQUIRED PER ORIENTATION TO PROVIDE FRONT ACCESS TO FLOW. ADJUSTMENT WITHIN CORD LENGTH LIMIT.
 - USE LOCKTITE ON ISOLATOR THREADS. DO NOT OVER TIGHTEN.
 - LOOSEN PUMP HEAD CLAMP, ROTATE AND RE-TIGHTEN AS REQUIRED FOR PUMP ORIENTATION.
 - EACH BACKER BOARD'S ASSEMBLY COMPONENTS INCLUDE:
 - (1) BACKER BOARDS
 - (4) TENETS, 1/4-20 VENDOR MOUNTED
 - (8) WOOD SCREWS #8 1-1/4" (32MM)
 - (4) NEOPRENE ISOLATORS, KARMAN RUBBER, K84-60
 - NEOPRENE
 - (4) LOCK NUTS, 1/4-20 NYLON
 - (4) WASHERS, 1/4" (7MM) FLAT

STEEL SUPPORT FRAME PER CASEWORK SHOP DRAWINGS

23.685" H X 12" W (602MM X 305MM),
3/4" MARINE GRADE PLYWOOD
BACKER BOARD SECURED TO
STEEL FRAME WITH THRU BOLTS
AND SILICONE ADHESIVE PER
CASEWORK SHOP DRAWINGS

SEE NOTES ABOVE
FOR ASSEMBLY ITEMS

PUMP ATTACHED TO BACKER BOARD
WITH ASSEMBLY COMPONENTS

10"x10" (250MM X 250MM) BACKER BOARD.
ATTACH TO PLYWOOD SUBSTRATE WITH
SILICONE ADHESIVE AND WOOD SCREWS.
SILICONE PERIMETER.

FINISHED FLOOR

ADAPTABLE CASEWORK DETAIL

4 ESPRESSO PUMP MOUNTED AT CABINET

Scale: 1 1/2" = 1'-0"



© 2023 STARBUCKS COFFEE COMPANY

STARBUCKS®
2401 UTAH AVENUE SOUTH
SEATTLE, WASHINGTON 98134
(206) 318-1575

THESE DRAWINGS AND THE PROJECT MANUAL ARE CONFIDENTIAL AND SHALL REMAIN THE SOLE PROPERTY OF STARBUCKS CORPORATION, WHICH IS THE OWNER OF THE COPYRIGHT IN THIS WORK. THEY SHALL NOT BE REPRODUCED IN WHOLE OR IN PART, SHARED WITH THIRD PARTIES OR USED IN ANY MANNER ON OTHER PROJECTS OR EXTENSIONS TO THIS PROJECT WITHOUT THE PRIOR WRITTEN CONSENT OF STARBUCKS CORPORATION. THESE DRAWINGS AND SPECIFICATIONS ARE INTENDED TO EXPRESS INTENT FOR A PROTOTYPICAL STARBUCKS STORE (WHICH IS SUBJECT TO CHANGE AT ANYTIME) AND DO NOT REFLECT ACTUAL SITE CONDITIONS. NEITHER PARTY SHALL HAVE ANY OBLIGATION NOR LIABILITY TO THE OTHER (EXCEPT STATED ABOVE) UNTIL A WRITTEN AGREEMENT IS FULLY EXECUTED BY BOTH PARTIES.

STARBUCKS TEMPLATE VERSION: i2023.10.23

**Design Forum
Architects Inc.**

2050 Byers Rd
Miami, OH 45342
Tel: (844) 804-7700

Donald J. Rehman
Architect in Charge
License: AR0017303



2230 PARK AVE, STE. 100, CINCINNATI, OH 45206
513.457.7131 - WWW.MARQUEENG.COM

FOR CONSTRUCTION

PROJECT NAME:
**S SEMORAN BLVD &
LEE VISTA BLVD**

PROJECT ADDRESS:
**6605 S SEMORAN BLVD
ORLANDO, FL 32822**

STORE #: 9875
PROJECT #: 25630-101
ISSUE DATE: 03/04/2024
DESIGN MANAGER: MARTIN PEREZ
PRODUCTION DESIGNER: ANDY MCLOUD
CHECKED BY: DONALD REHMAN

Revision Schedule			
Rev	Date	By	Description

SHEET TITLE:
INTERIOR DETAILS


SCALE: AS SHOWN

SHEET NUMBER:


I-509

3/4/2024 2:40:11 PM
\\file-day.ad.changepinc.com\Client\StarbucksArchitecture\Projects\ 2023\Floida\S Semoran & Lee Vista - 25630-101\25630-101 9875 S Semoran Blvd & Lee Vista Blvd, FL 2023.nv


3 ESPRESSO SHROUD DETAIL

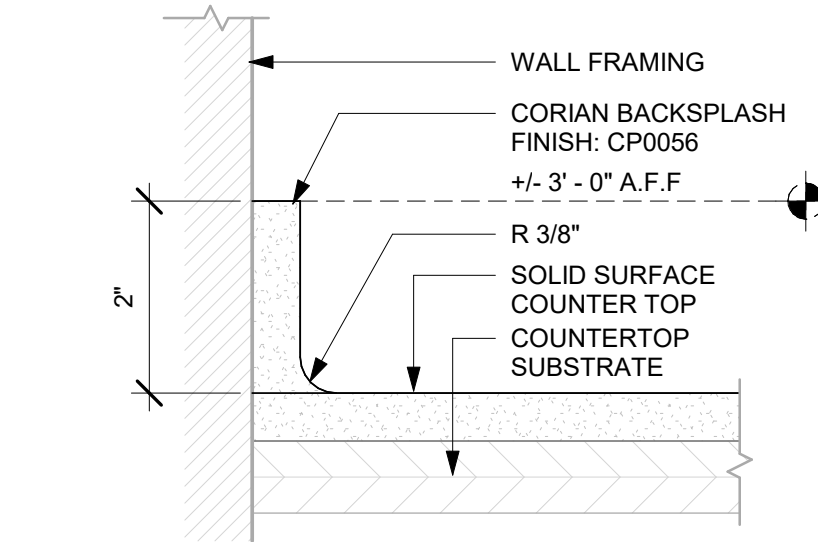


4 2" BACKSPLASH DETAIL AT DT
Scale: 6" = 1'-0"

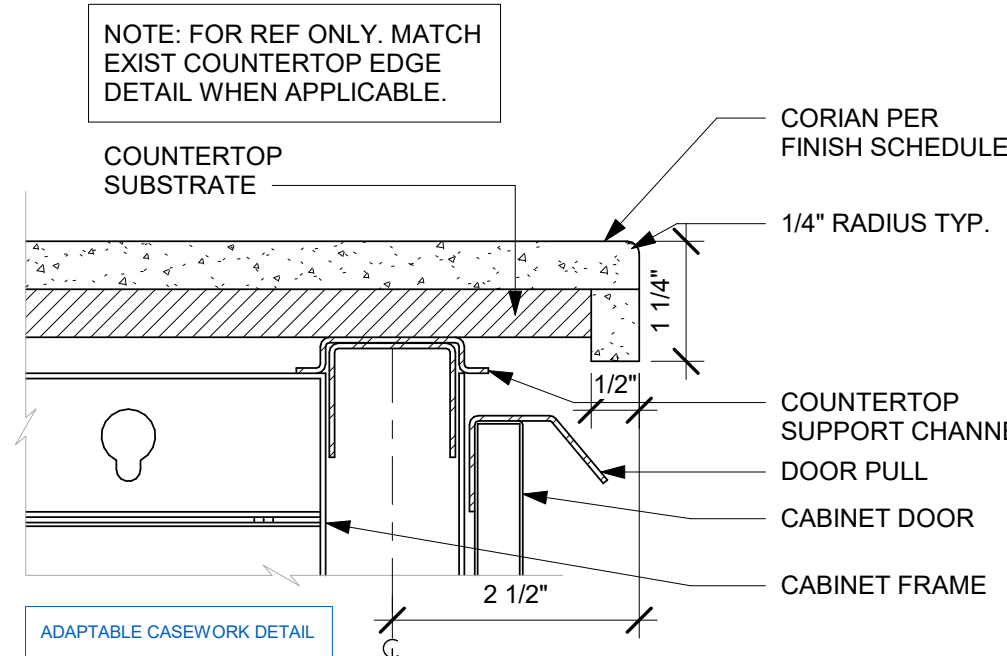


5 TYP. CORIAN EDGE - FRONTLINE
Scale: 6" = 1'-0"

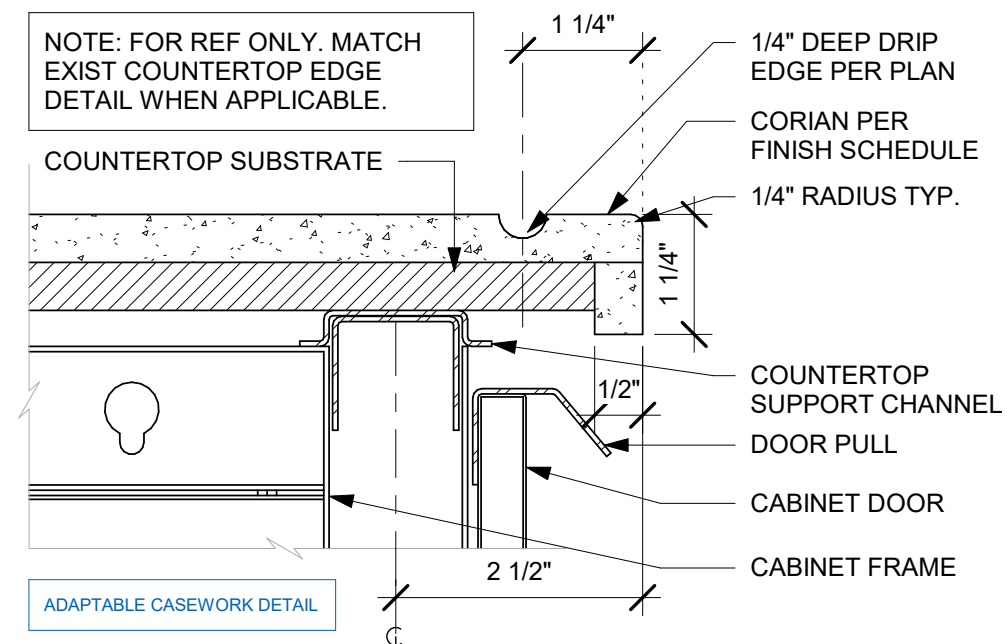


6 TYP. CORIAN DRIP EDGE - FRONTLINE
Scale: 6" = 1'-0"

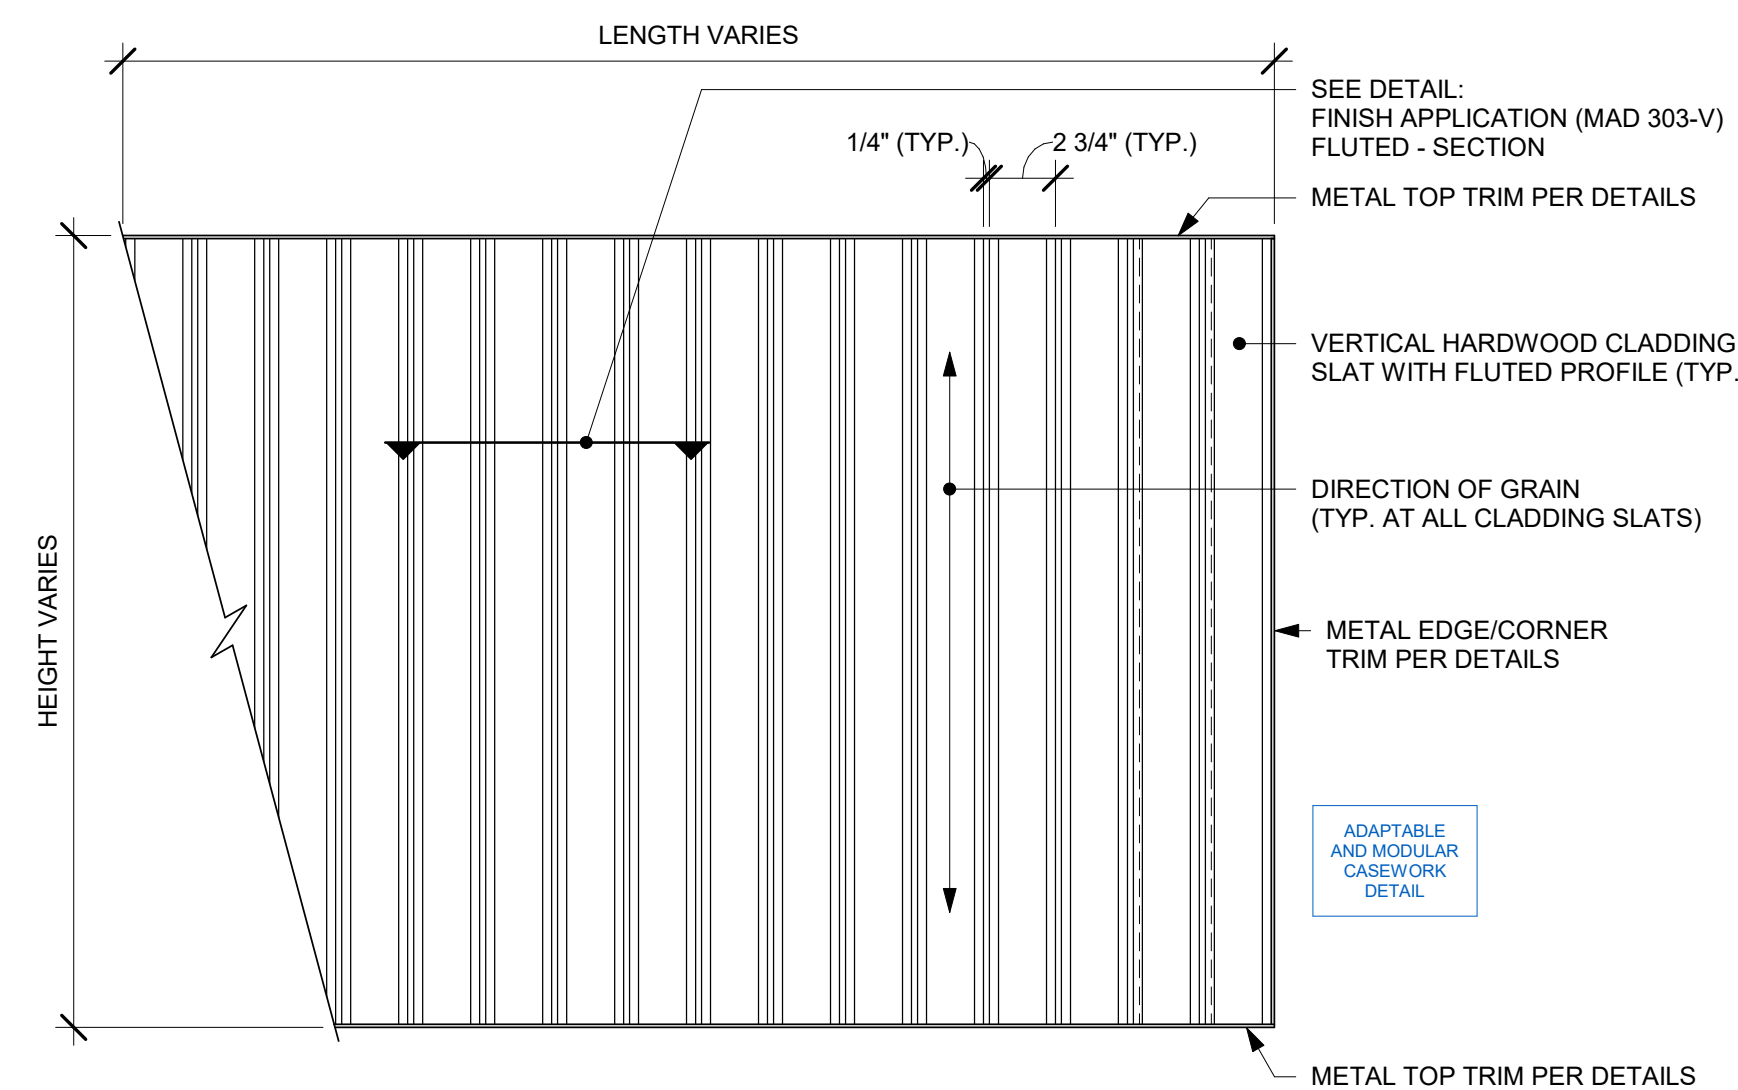


7 FINISH APPLICATION (MAD 303-V) FLUTED - ELEVATION
Scale: 1 1/2" = 1'-0"

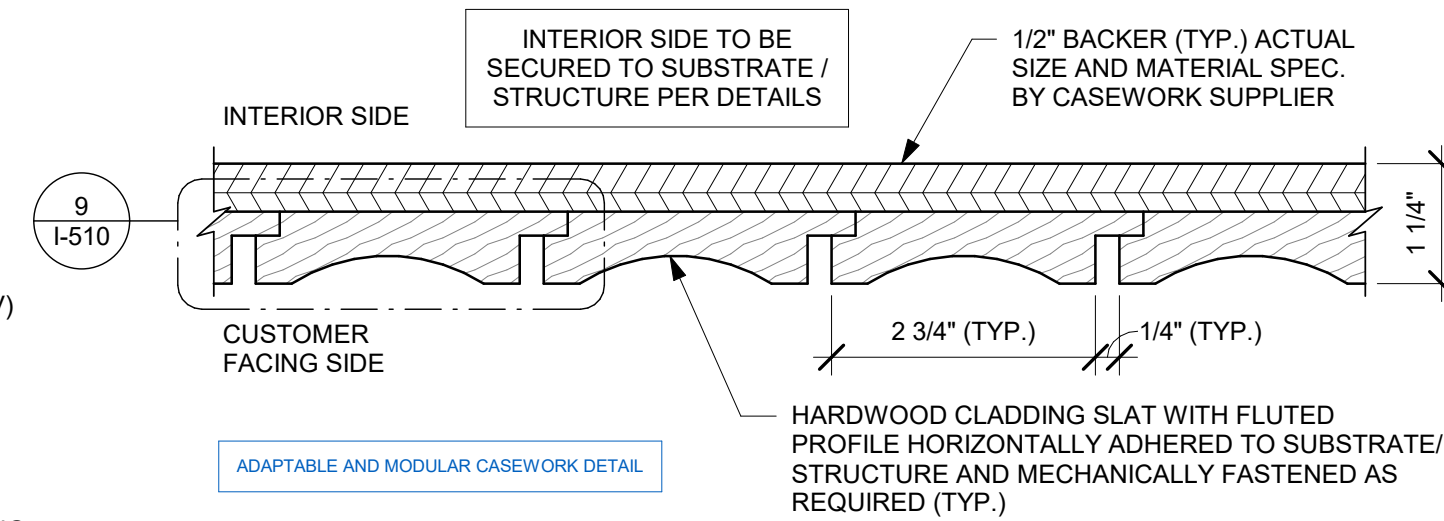


8 FINISH APPLICATION (MAD 303-V) FLUTED - SECTION
Scale: 6" = 1'-0"

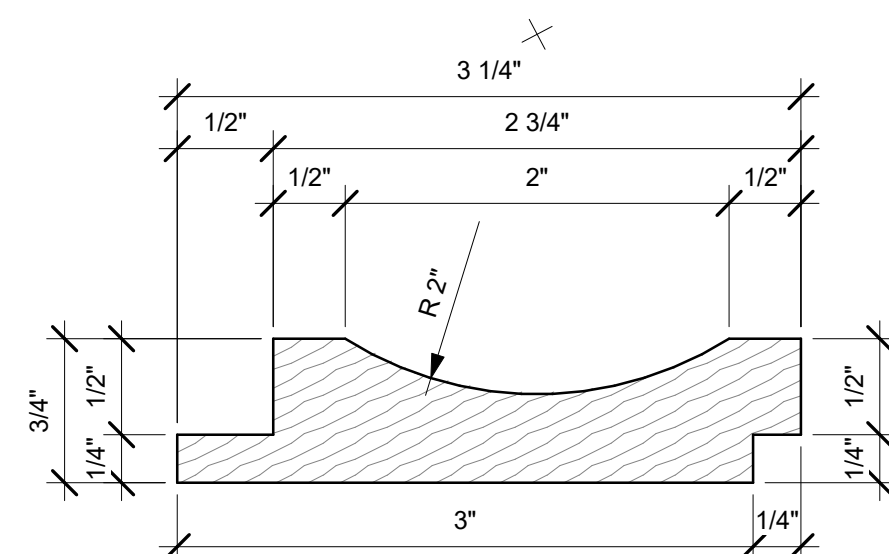


FLUTED HARDWOOD SLAT

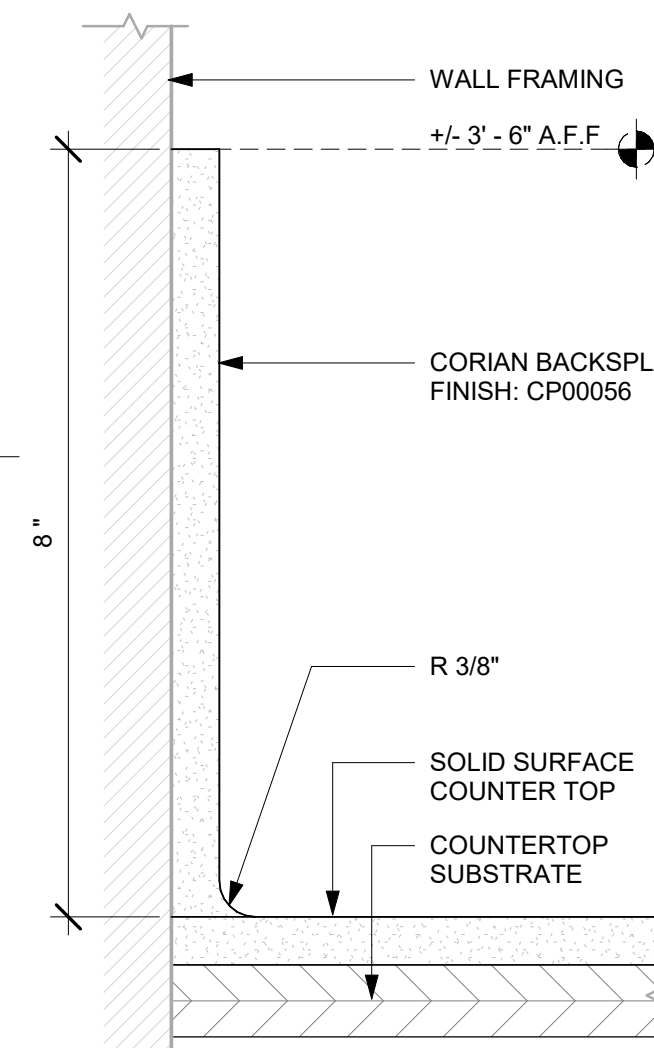

10 8" BACKSPLASH DETAIL
Scale: 6" = 1'-0"

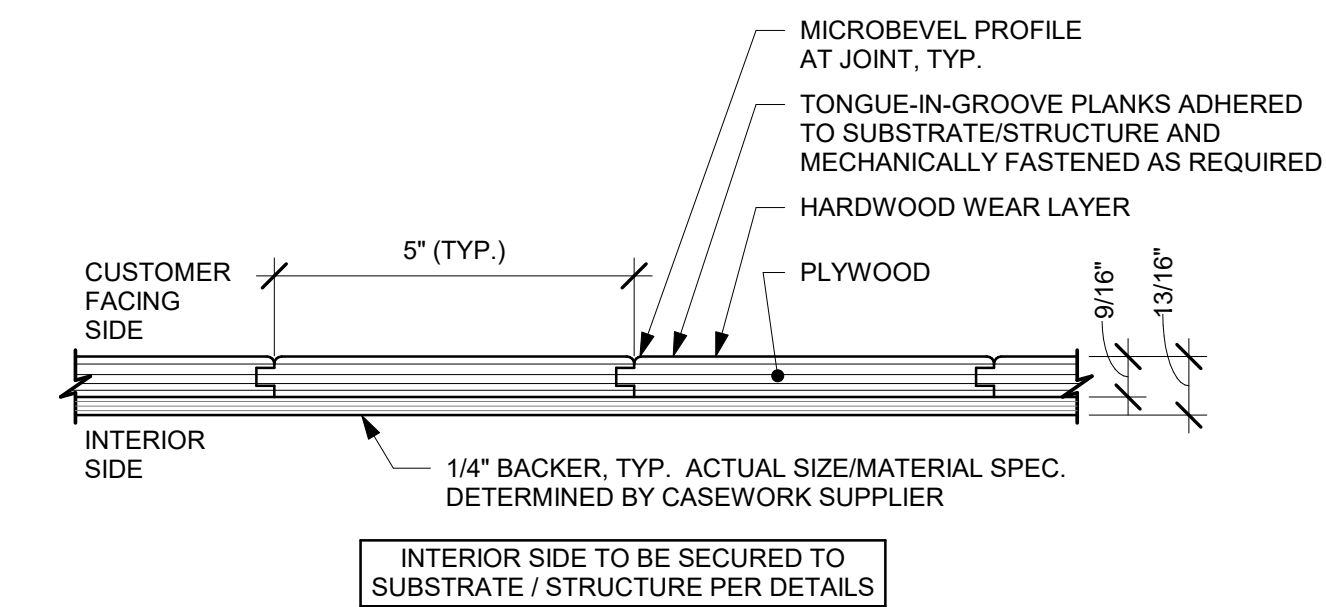

(A) ENLARGED SECTION PROFILE
NOT TO SCALE

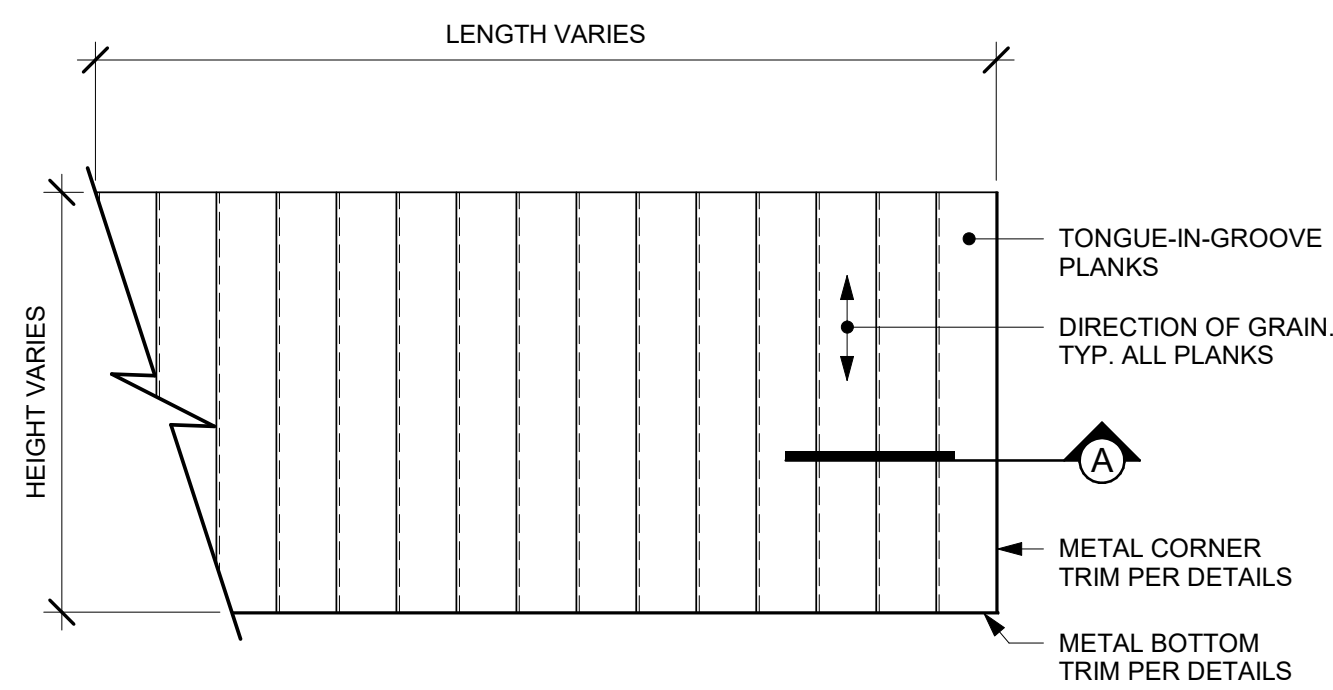

ELEVATION

11 FINISH APPLICATION (MAD 100-V) FIXED WIDTH WIDE PLANK
Scale: $3/4" = 1'-0"$



© 2023 STARBUCKS COFFEE COMPANY

STARBUCKS®
2401 UTAH AVENUE SOUTH
SEATTLE, WASHINGTON 98134
(206) 318-1575


THESE DRAWINGS AND THE PROJECT MANUAL ARE CONFIDENTIAL AND SHALL REMAIN THE SOLE PROPERTY OF STARBUCKS CORPORATION, WHICH IS THE OWNER OF THE COPYRIGHT IN THIS WORK. THEY SHALL NOT BE REPRODUCED (IN WHOLE OR IN PART), SHARED WITH THIRD PARTIES OR USED IN ANY MANNER ON OTHER PROJECTS OR EXTENSIONS TO THIS PROJECT WITHOUT THE PRIOR WRITTEN CONSENT OF STARBUCKS CORPORATION. THESE DRAWINGS AND SPECIFICATIONS ARE INTENDED TO EXPRESS DESIGN INTENT FOR A PROTOTYPICAL STARBUCKS STORE (WHICH IS SUBJECT TO CHANGE AT ANYTIME) AND DO NOT REFLECT ACTUAL SITE CONDITIONS. NEITHER PARTY SHALL HAVE ANY OBLIGATION NOR LIABILITY TO THE OTHER (EXCEPT STATED ABOVE) UNTIL A WRITTEN AGREEMENT IS FULLY EXECUTED BY BOTH PARTIES.

STARBUCKS TEMPLATE VERSION: i2023.10.23

**Design Forum
Architects Inc.**

2050 Byers Rd
 Miamisburg, OH 45342
 Tel: (844) 804-7700

Donald J. Rethman
Architect In Charge
License: AR0017303

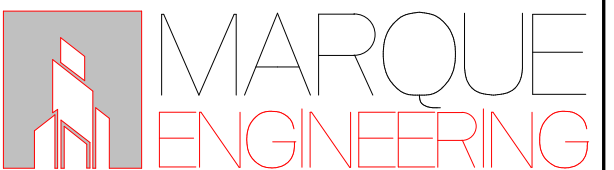

FOR CONSTRUCTION

PROJECT NAME:
**S SEMORAN BLVD &
LEE VISTA BLVD**

PROJECT ADDRESS:
6605 S SEMORAN BLVD
ORLANDO, FL 32822

STORE #:	9875
PROJECT #:	25630-101
ISSUE DATE:	03/04/2024
DESIGN MANAGER:	MARTIN PEREZ
PRODUCTION DESIGNER:	ANDY MCLOUD
CHECKED BY:	DONALD RETHMAN

Revision Schedule			
Rev	Date	By	Description


SHEET TITLE:
INTERIOR DETAILS

SCALE: AS SHOWN


SHEET NUMBER:

I-510


NOTE:
SHOP DRAWINGS TO BE APPROVED BY
SB DESIGNER PRIOR TO FABRICATION.

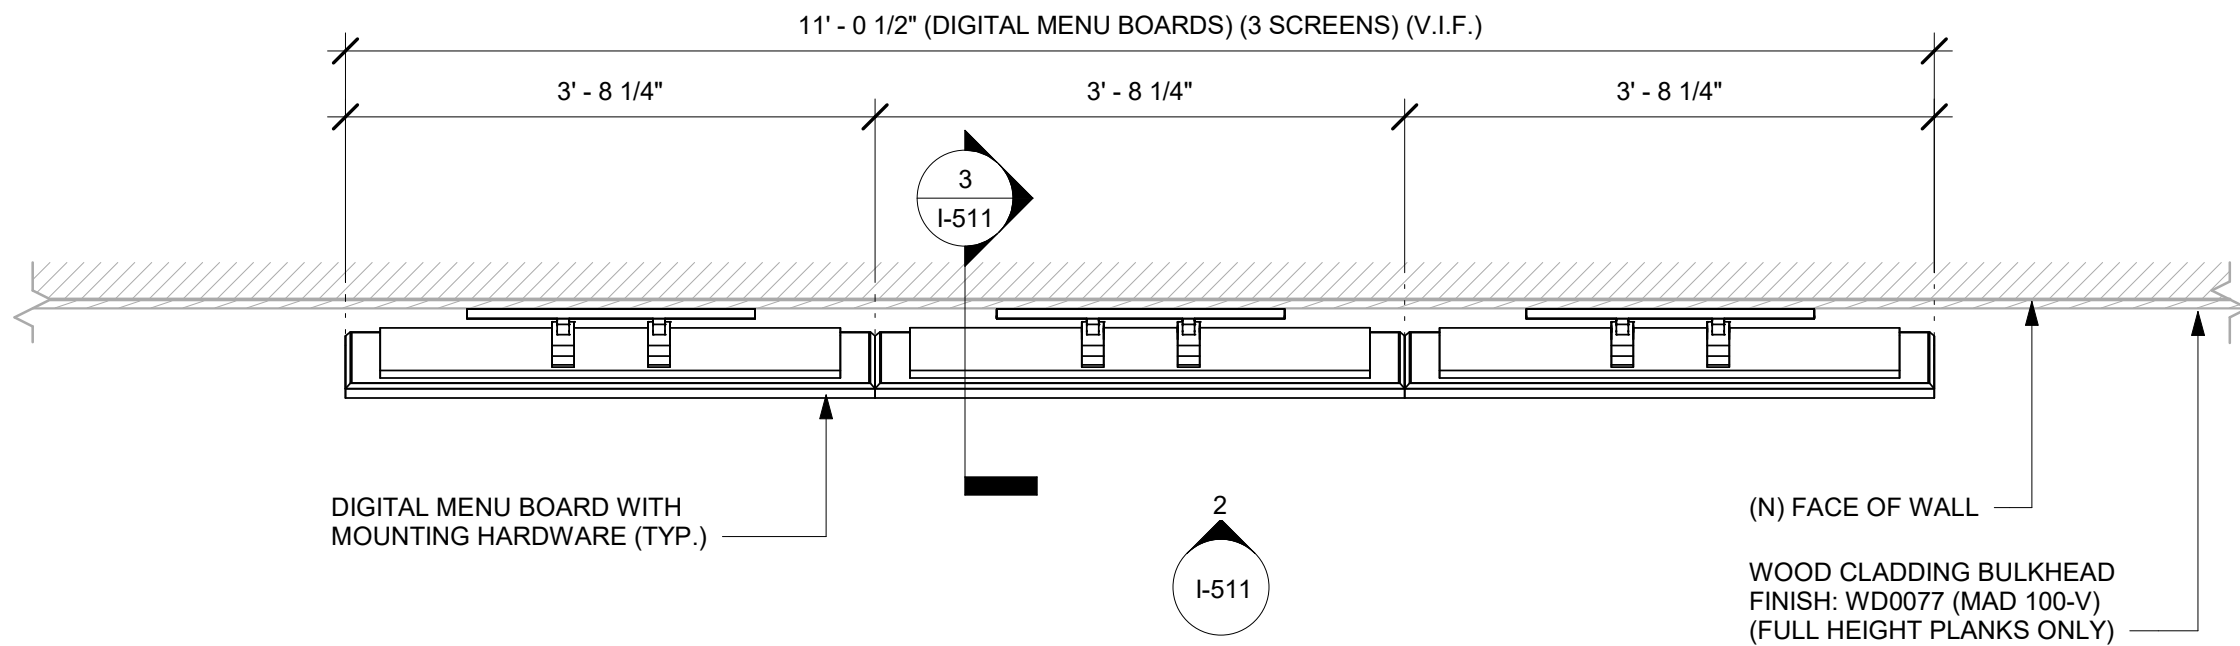


1 DIGITAL MENU BOARD - PLAN
Scale: 3/4" = 1'-0"

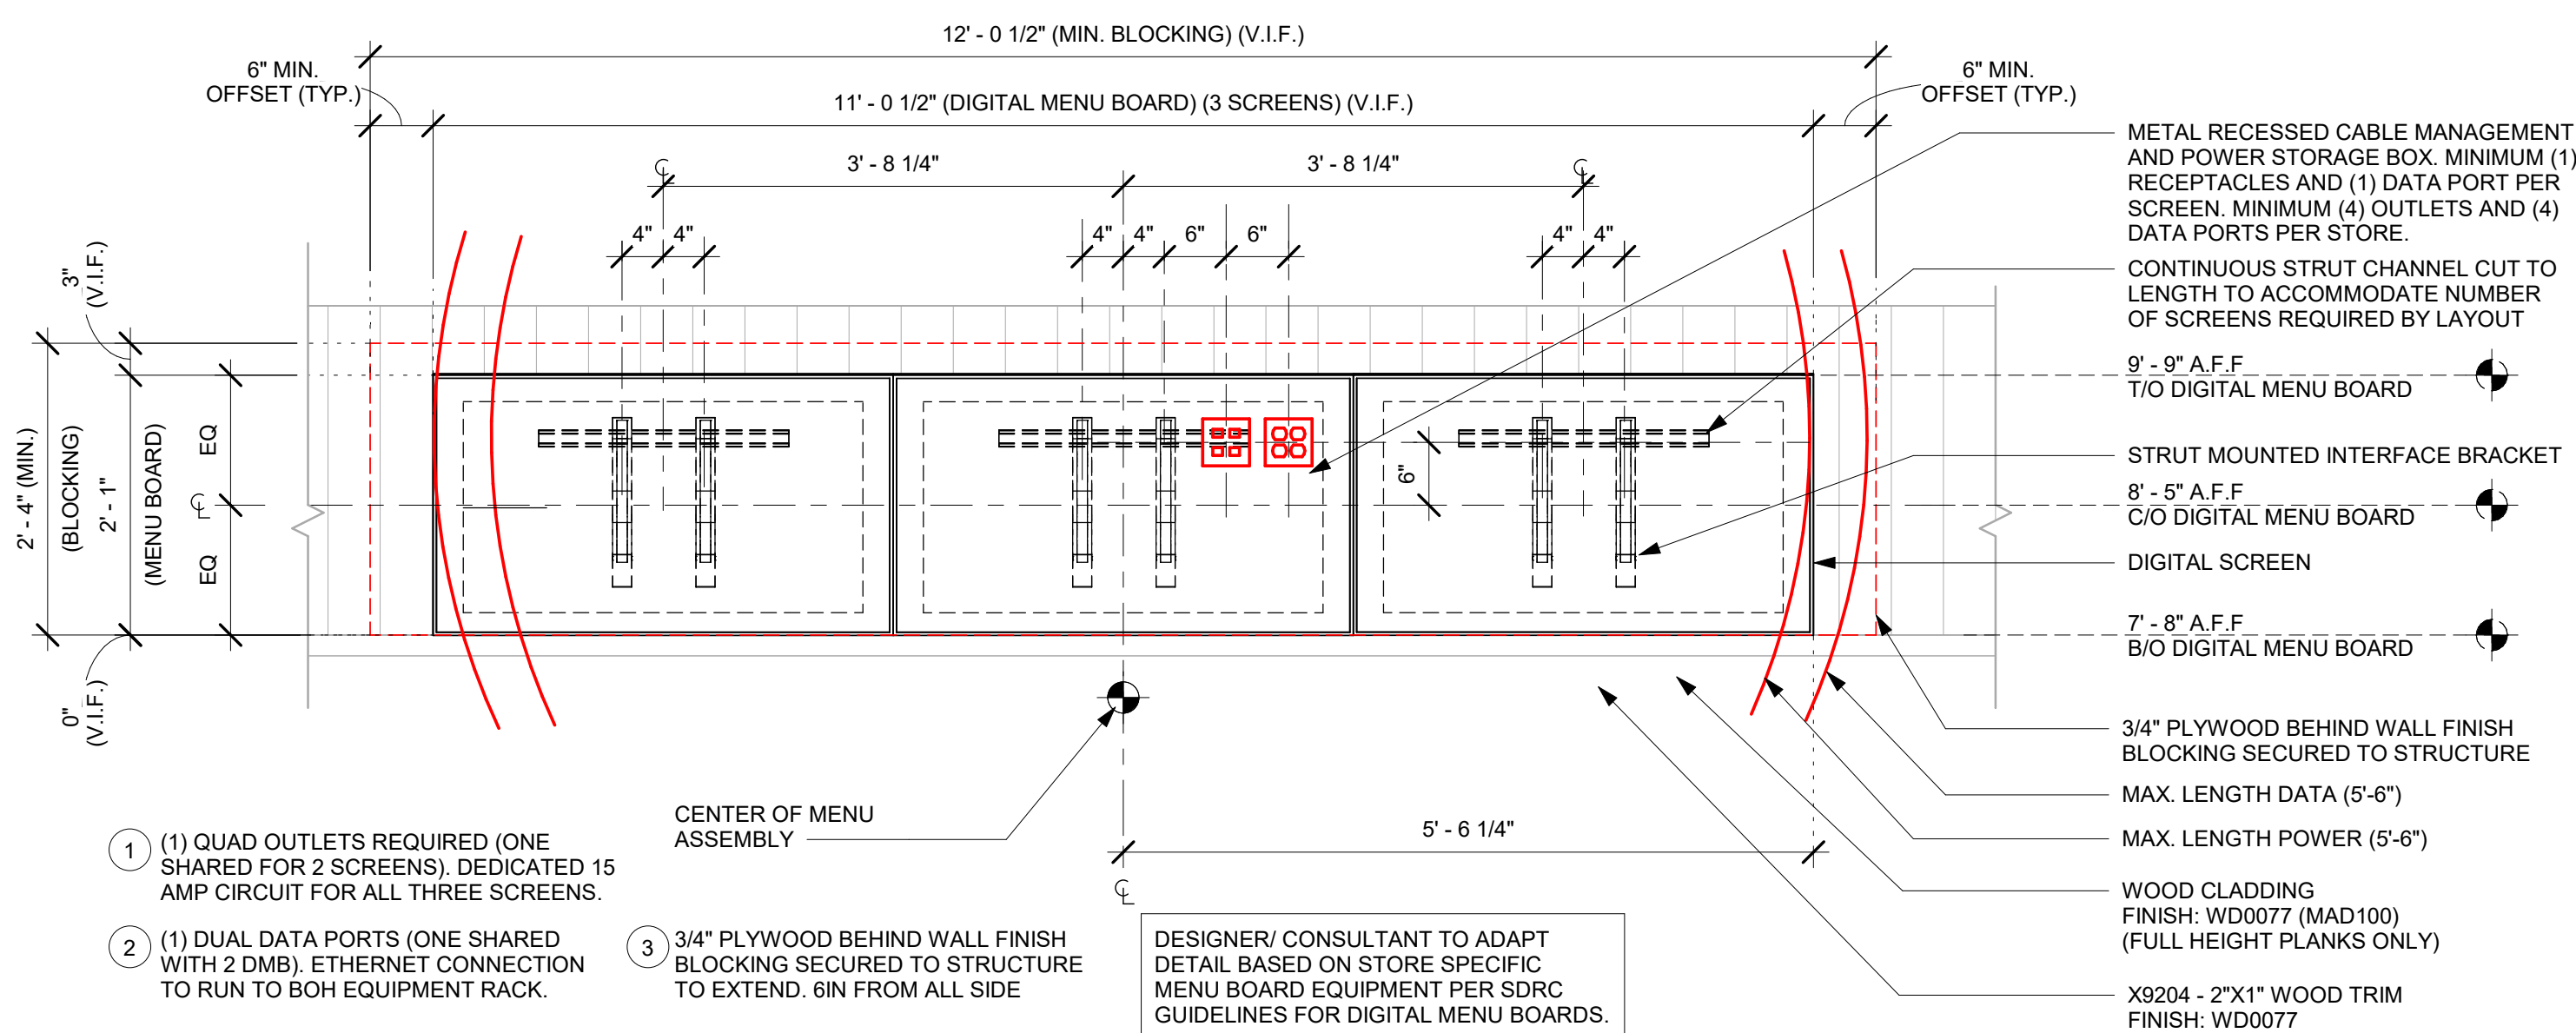


2 DIGITAL MENU BOARD - ELEVATION
Scale: 3/4" = 1'-0"

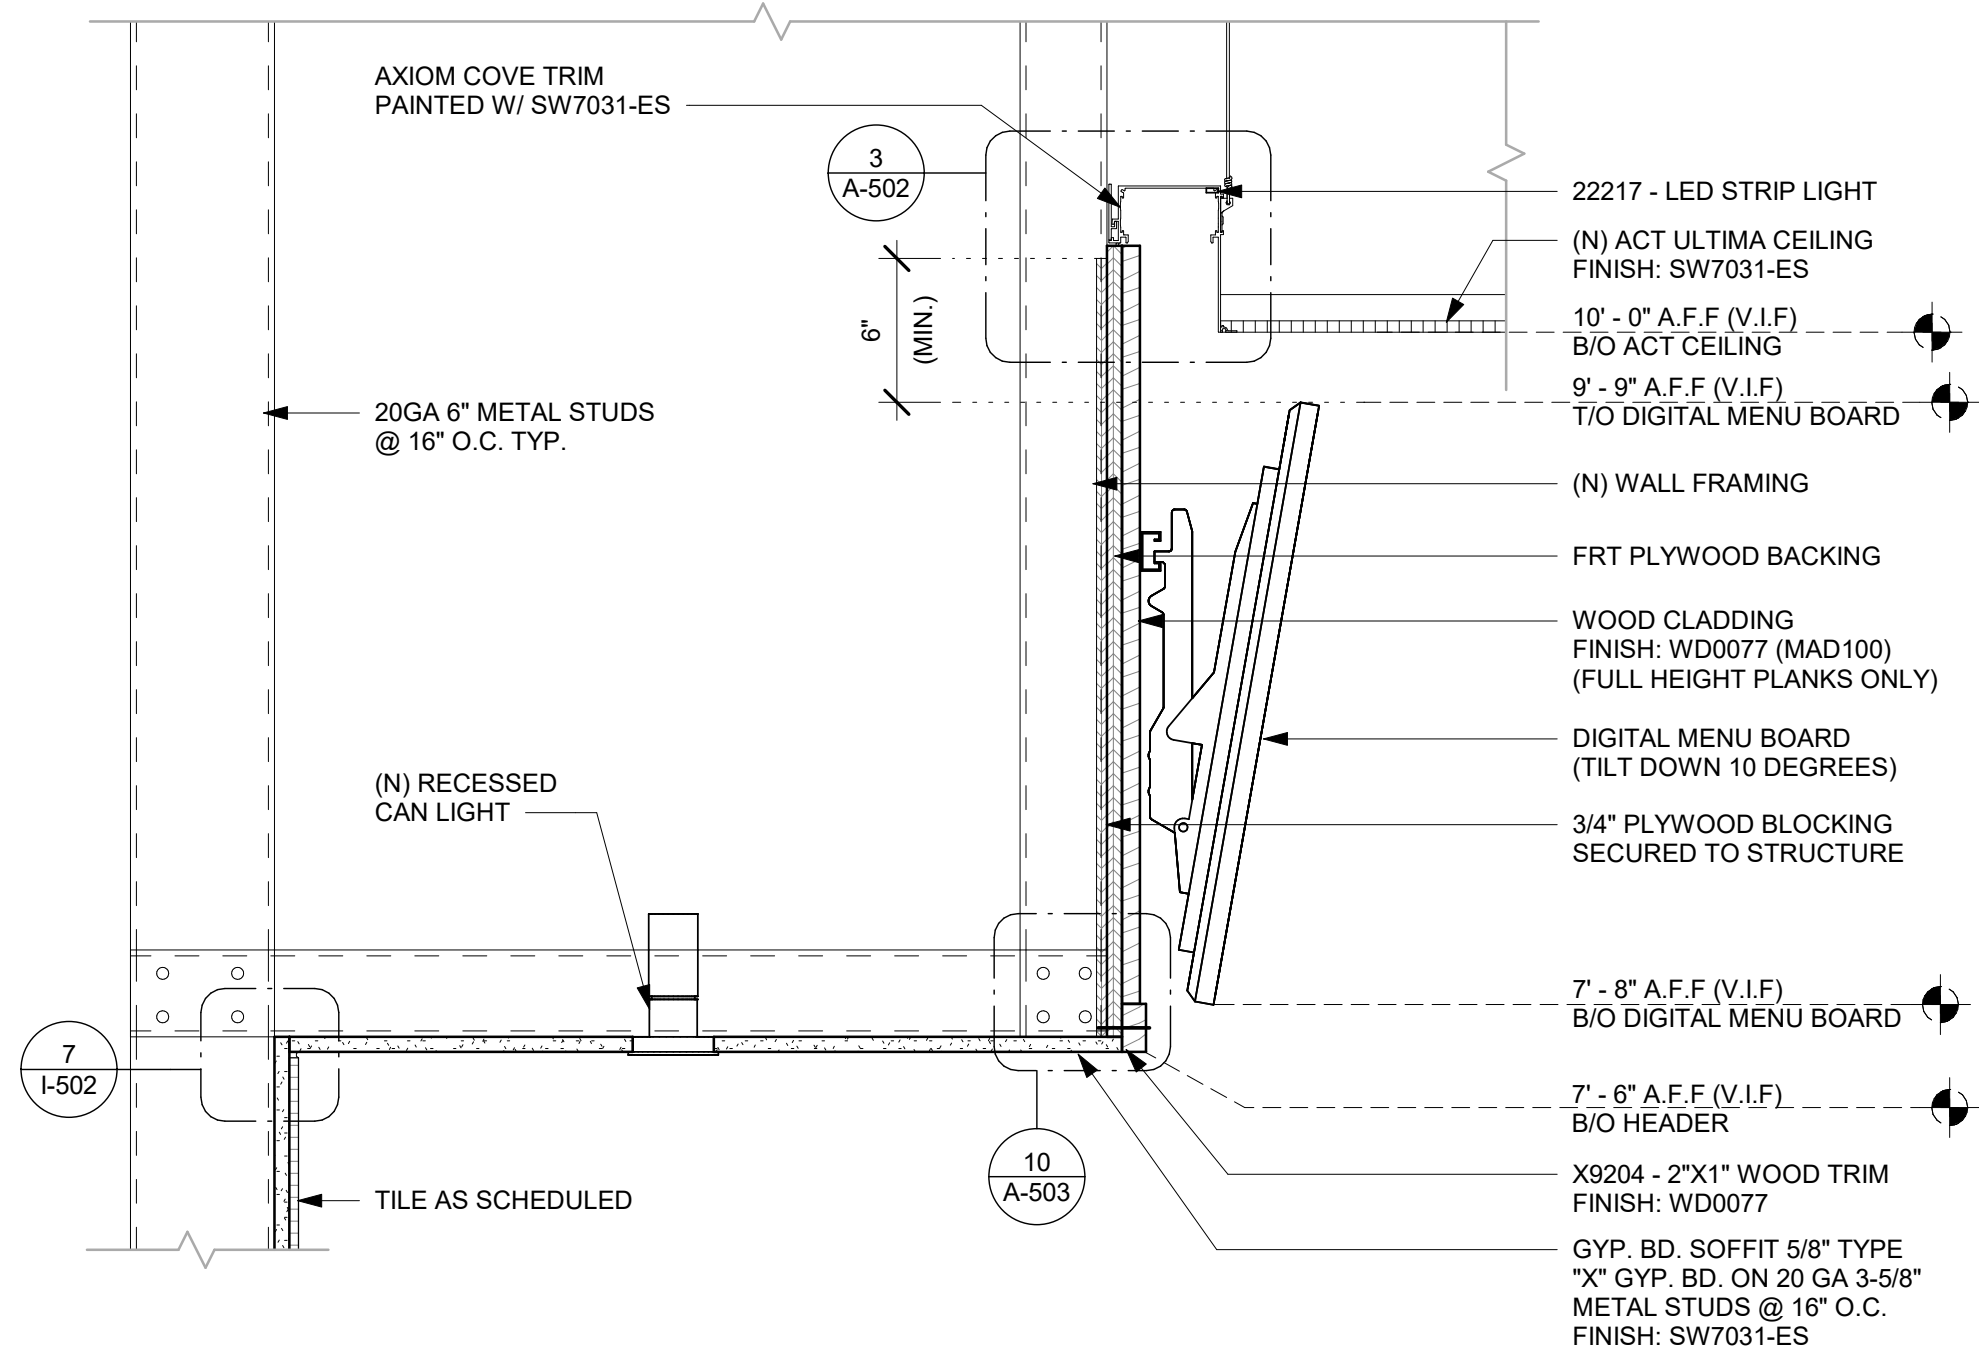


3 DIGITAL MENU BOARD - SECTION
Scale: 1 1/2" = 1'-0"

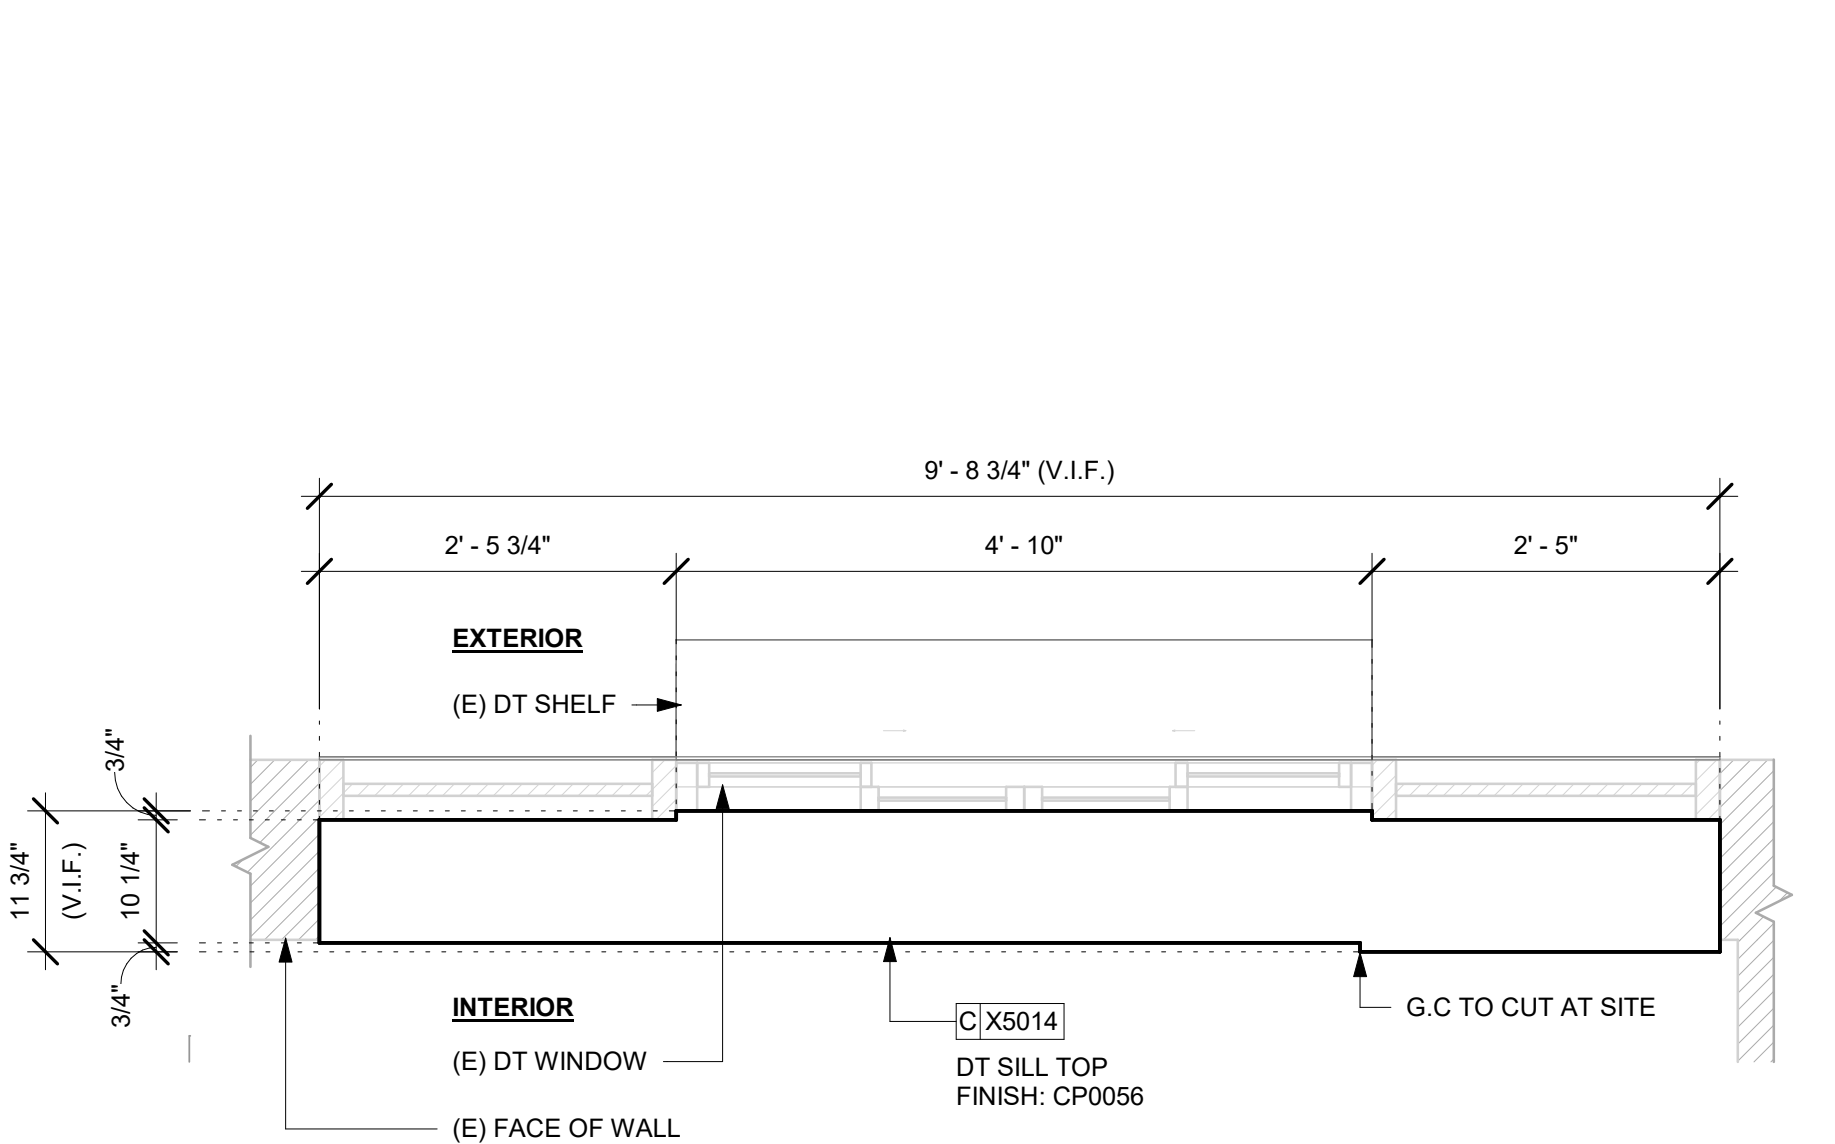

4 X5014 - DT SILL TOP - PLAN
Scale: 3/4" = 1'-0"

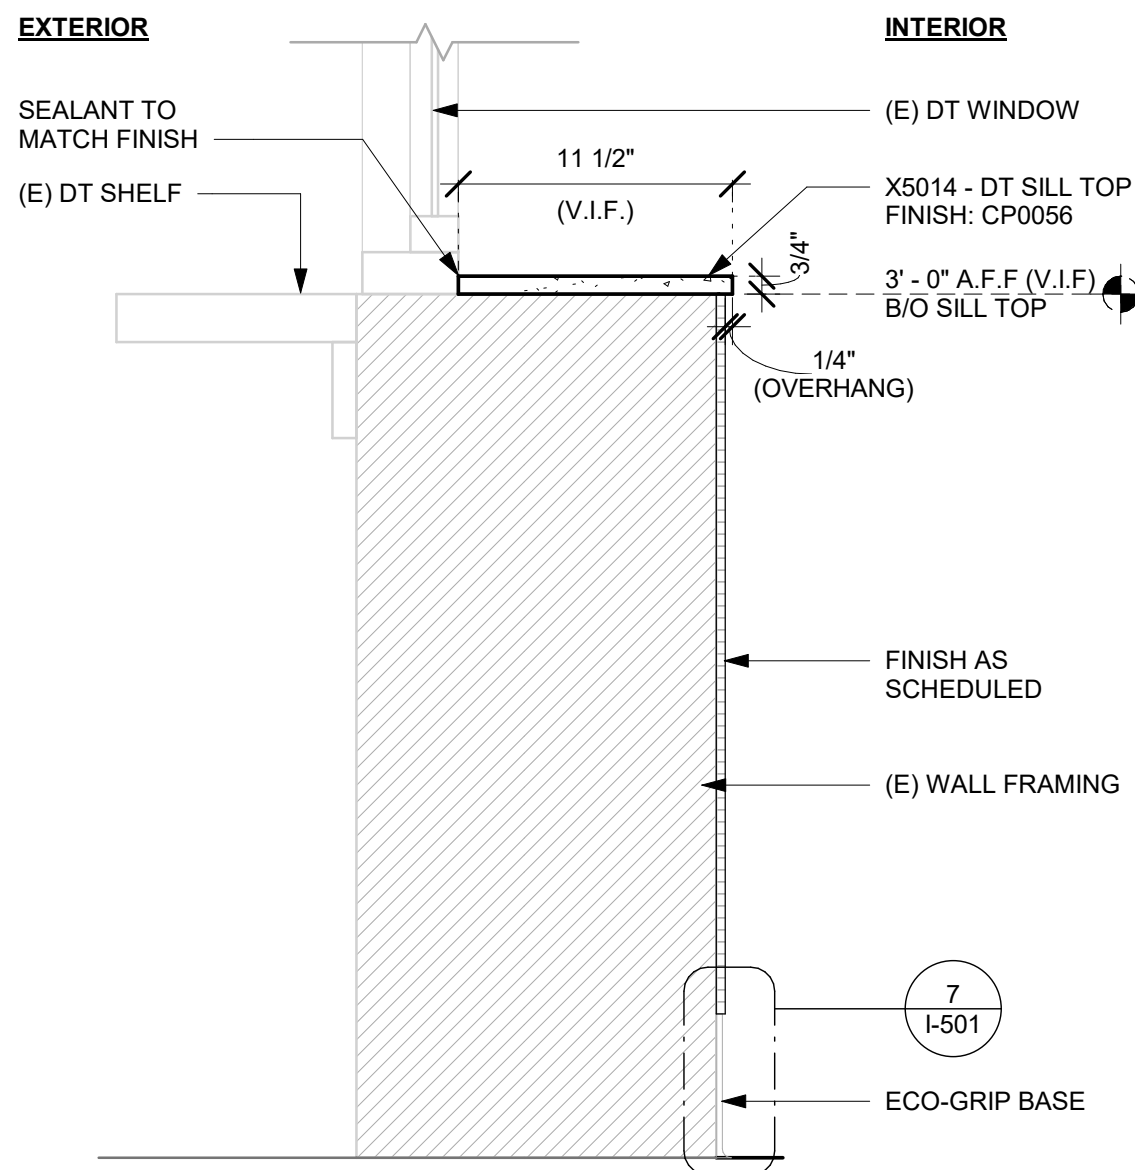

5 X5014 - DT SILL TOP - SECTION
Scale: 1 1/2" = 1'-0"

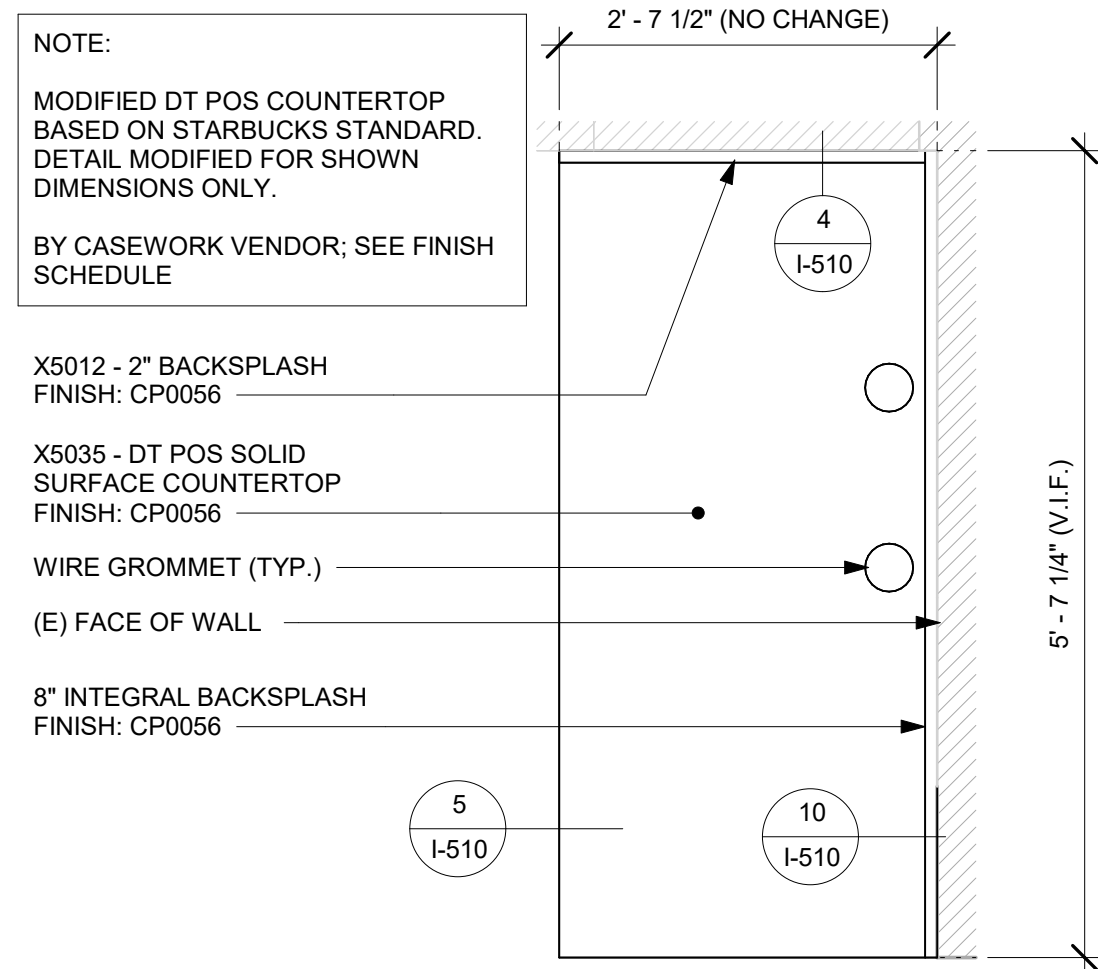

6 X5035 - DT POS COUNTERTOP - PLAN
Scale: 3/4" = 1'-0"



STARBUCKS®
2401 UTAH AVENUE SOUTH
SEATTLE, WASHINGTON 98134
(206) 318-1575

THESE DRAWINGS AND THE PROJECT MANUAL ARE CONFIDENTIAL AND SHALL REMAIN THE SOLE PROPERTY OF STARBUCKS CORPORATION, WHICH IS THE OWNER OF THE COPYRIGHT IN THIS WORK. THEY SHALL NOT BE REPRODUCED IN WHOLE OR IN PART, SHARED WITH THIRD PARTIES OR USED IN ANY MANNER ON OTHER PROJECTS OR EXTENSIONS TO THIS PROJECT WITHOUT THE PRIOR WRITTEN CONSENT OF STARBUCKS CORPORATION. THESE DRAWINGS AND SPECIFICATIONS ARE INTENDED TO EXPRESS THE INTENT FOR A PROTOTYPICAL STARBUCKS STORE (WHICH IS SUBJECT TO CHANGE AT ANYTIME) AND DO NOT REFLECT ACTUAL SITE CONDITIONS. NEITHER PARTY SHALL HAVE ANY OBLIGATION NOR LIABILITY TO THE OTHER (EXCEPT STATED ABOVE) UNTIL A WRITTEN AGREEMENT IS FULLY EXECUTED BY BOTH PARTIES.

STARBUCKS TEMPLATE VERSION: i2023.10.23

Design Forum Architects Inc.

2050 Byers Rd
Miami, OH 45342
Tel: (644) 804-7700

Donald J. Reithman
Architect In Charge
License: AR0017303



2230 PARK AVE, STE. 100, CINCINNATI, OH 45206
513.457.7131 - WWW.MARQUEENG.COM

FOR CONSTRUCTION

PROJECT NAME:
S SEMORAN BLVD & LEE VISTA BLVD

PROJECT ADDRESS:
**6605 S SEMORAN BLVD
ORLANDO, FL 32822**

STORE #: 9875
PROJECT #: 25630-101
ISSUE DATE: 03/04/2024
DESIGN MANAGER: MARTIN PEREZ
PRODUCTION DESIGNER: ANDY MCLOUD
CHECKED BY: DONALD REITHMAN

Revision Schedule			
Rev	Date	By	Description

SHEET TITLE:
INTERIOR DETAILS


SCALE: AS SHOWN

SHEET NUMBER:

I-511


\\file-day.ad.changeupinc.com\Client\StarbucksArchitecture\Projects_2023\Florida\Semoran & Lee Vista -25630-10125630-101_9875_S Semoran Blvd & Lee Vista Blvd, FL_2023.rvt 3/4/2024 2:40:13 PM

NOTE:
SHOP DRAWINGS TO BE APPROVED BY
SB DESIGNER PRIOR TO FABRICATION.

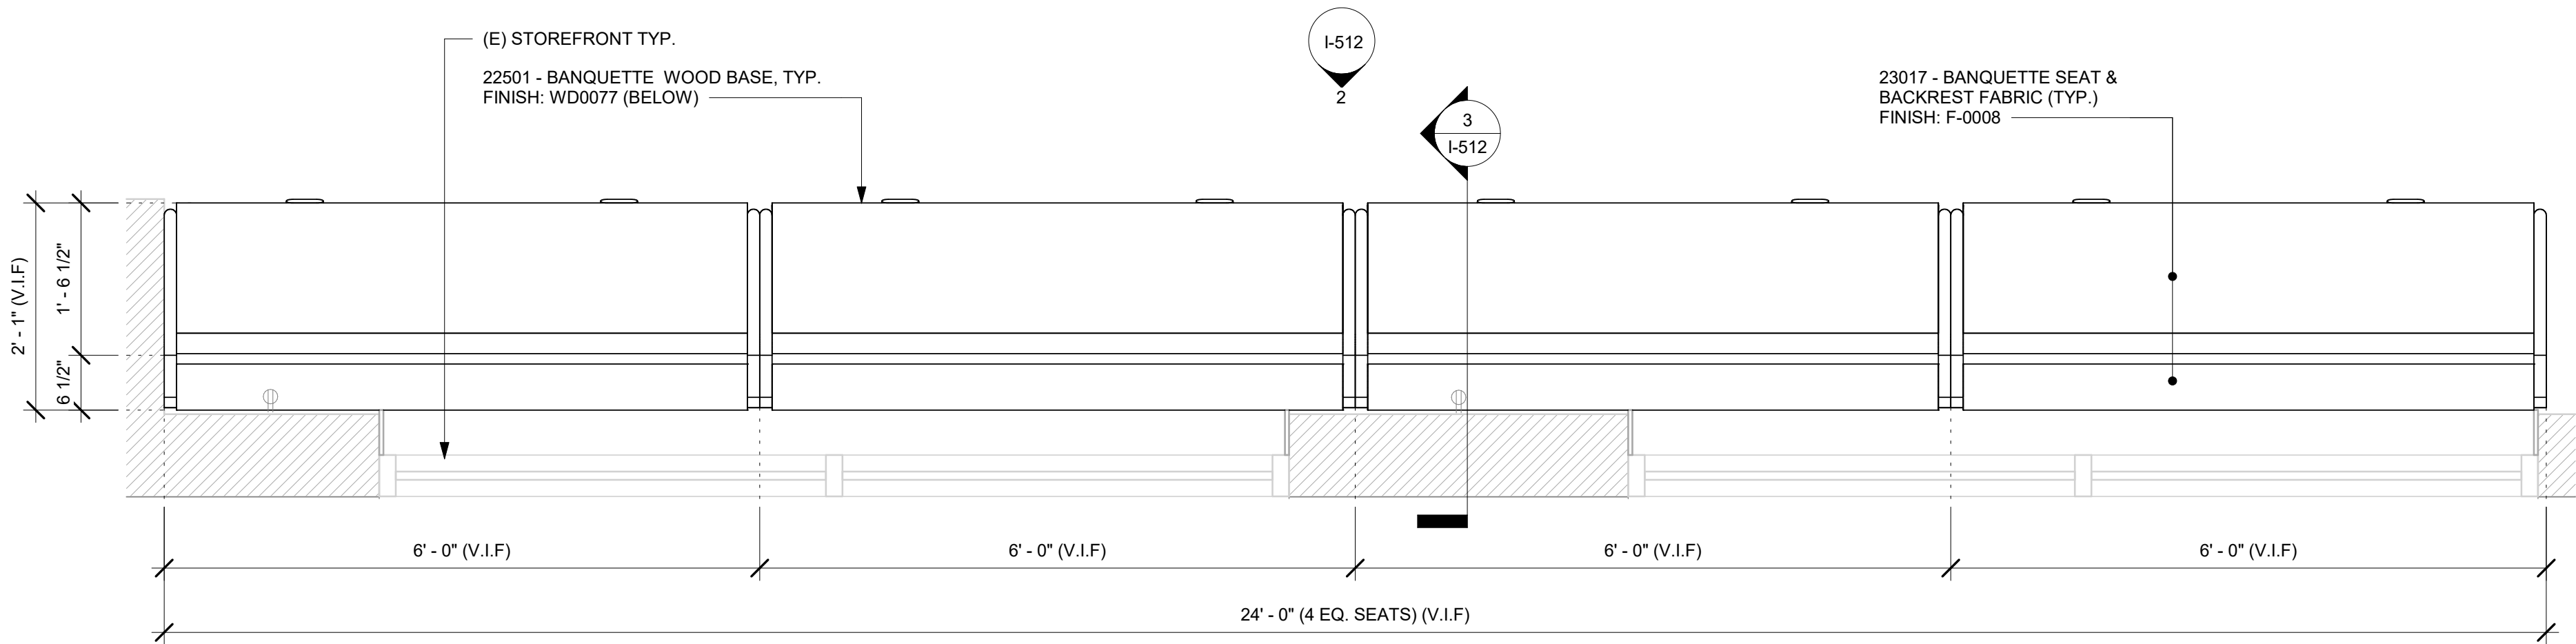


1 BANQUETTE - PLAN

Scale: 3/4" = 1'-0"

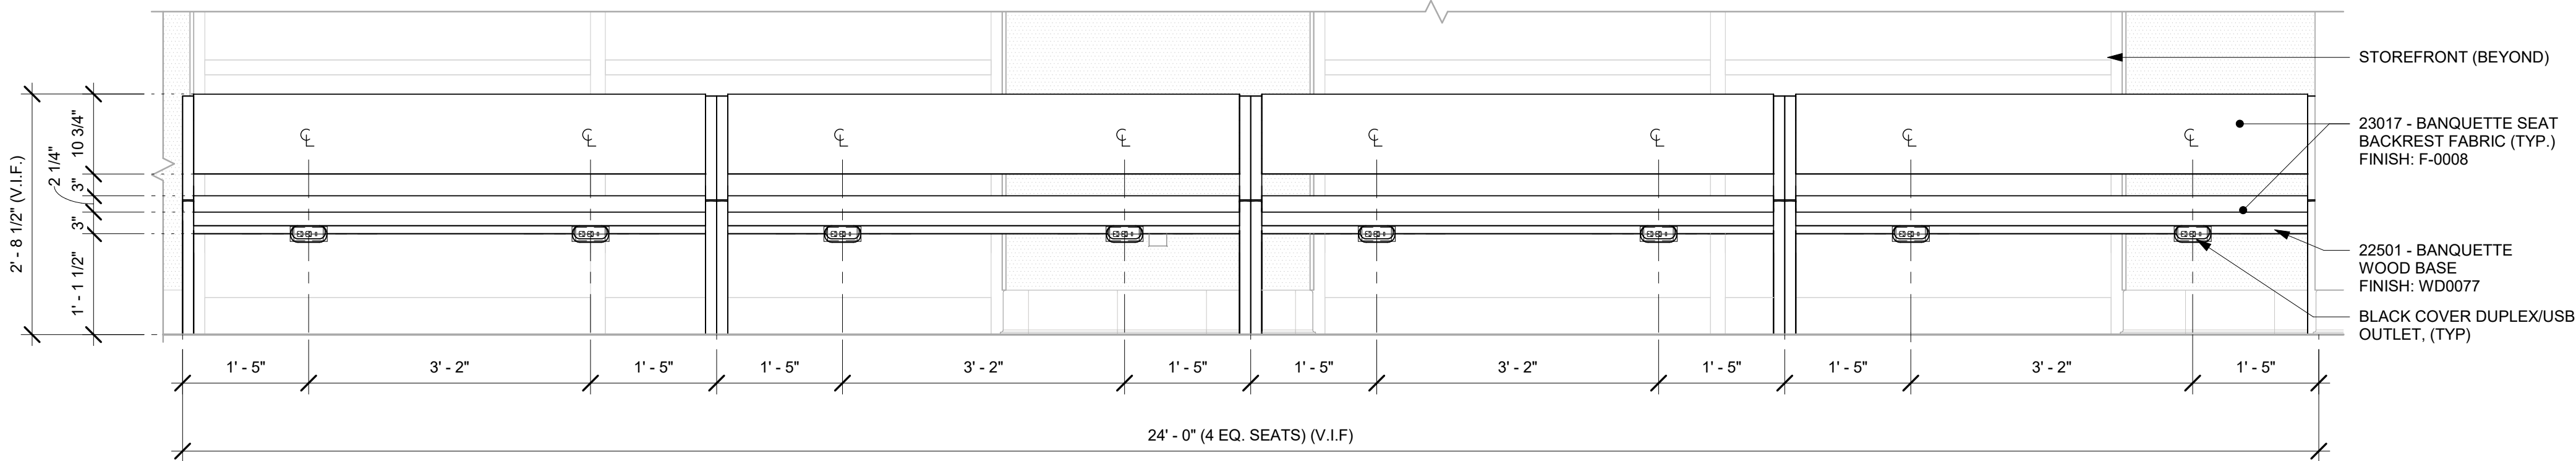

2 BANQUETTE - ELEVATION

Scale: 3/4" = 1'-0"

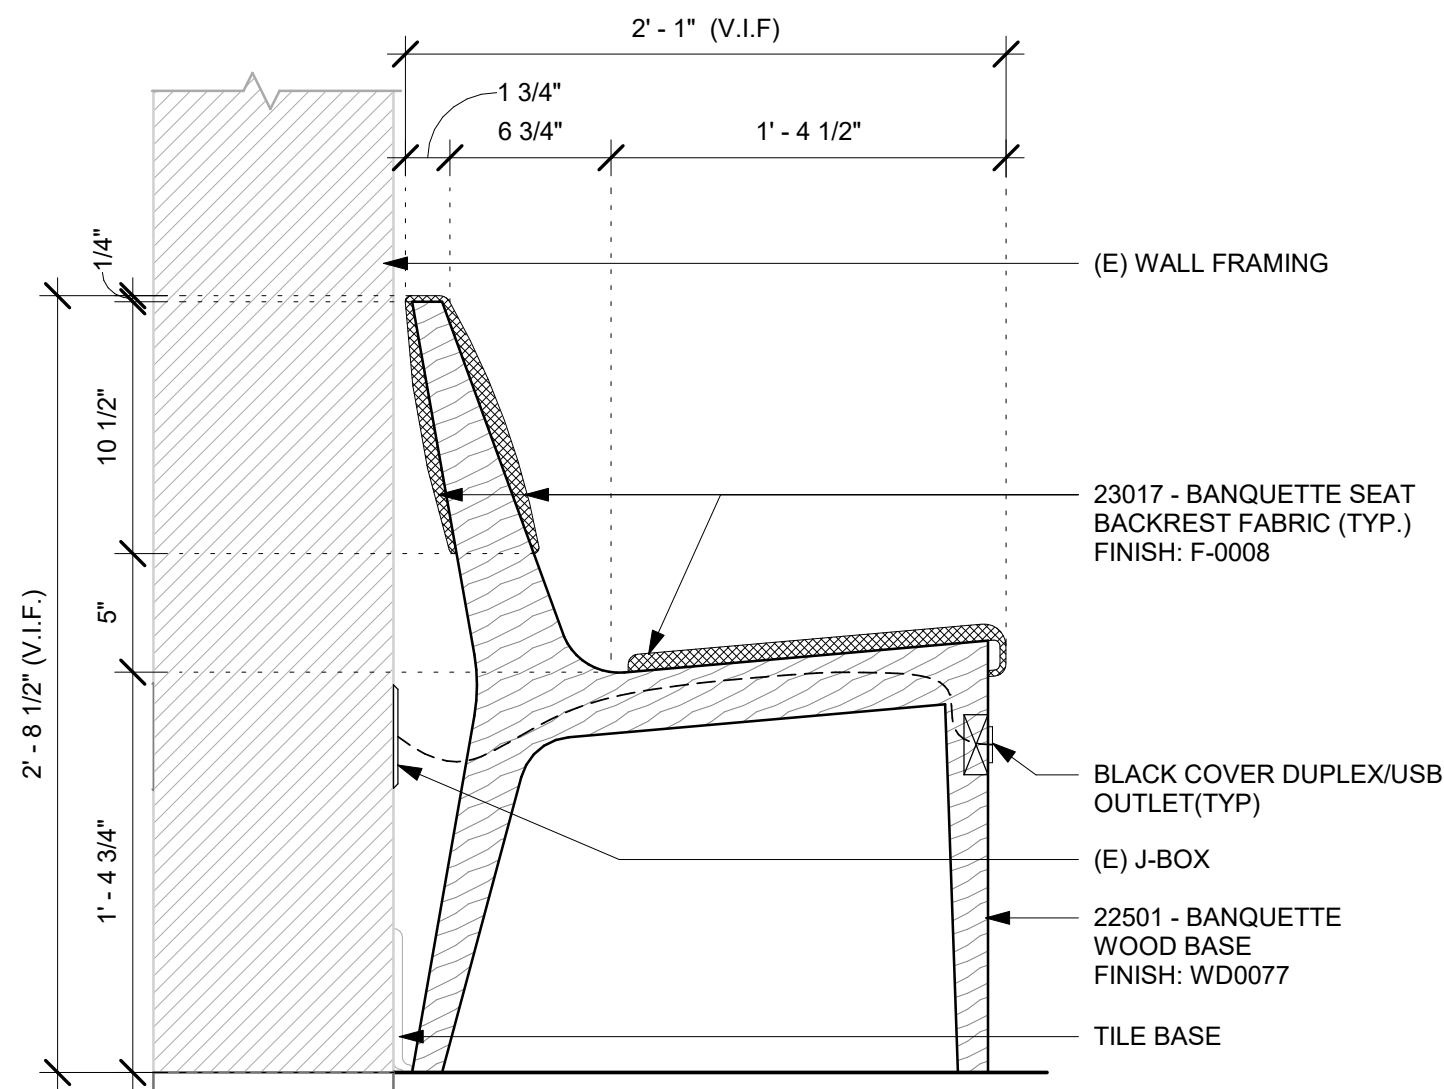

3 BANQUETTE - SECTION

Scale: 1 1/2" = 1'-0"

FOR CONSTRUCTION



© 2023 STARBUCKS COFFEE COMPANY

STARBUCKS®
2401 UTAH AVENUE SOUTH
SEATTLE, WASHINGTON 98134
(206) 318-1575

THESE DRAWINGS AND THE PROJECT MANUAL ARE CONFIDENTIAL AND SHALL REMAIN THE SOLE PROPERTY OF STARBUCKS CORPORATION, WHICH IS THE OWNER OF THE COPYRIGHT IN THIS WORK. THEY SHALL NOT BE REPRODUCED IN WHOLE OR IN PART, SHARED WITH THIRD PARTIES OR USED IN ANY MANNER ON OTHER PROJECTS OR EXTENSIONS TO THIS PROJECT WITHOUT THE PRIOR WRITTEN CONSENT OF STARBUCKS CORPORATION. THESE DRAWINGS AND SPECIFICATIONS ARE INTENDED TO EXPRESS DESIGN INTENT FOR A PROTOTYPICAL STARBUCKS STORE (WHICH IS SUBJECT TO CHANGE AT ANYTIME) AND DO NOT REFLECT ACTUAL SITE CONDITIONS. NEITHER PARTY SHALL HAVE ANY OBLIGATION NOR LIABILITY TO THE OTHER (EXCEPT STATED ABOVE) UNTIL A WRITTEN AGREEMENT IS FULLY EXECUTED BY BOTH PARTIES.

STARBUCKS TEMPLATE VERSION: i2023.10.23

Design Forum Architects Inc.

2050 Byers Rd
Miamisburg, OH 45342
Tel: (844) 804-7700

Donald J. Reihman
Architect In Charge
License: AR0017303



2230 PARK AVE, STE. 100, CINCINNATI, OH 45206
513.457.7131 - WWW.MARQUEENG.COM

PROJECT NAME:
S SEMORAN BLVD & LEE VISTA BLVD

PROJECT ADDRESS:
**6605 S SEMORAN BLVD
ORLANDO, FL 32822**

STORE #: 9875
PROJECT #: 25630-101
ISSUE DATE: 03/04/2024
DESIGN MANAGER: MARTIN PEREZ
PRODUCTION DESIGNER: ANDY MCLOUD
CHECKED BY: DONALD RETHMAN

Revision Schedule			
Rev	Date	By	Description


SHEET TITLE:
INTERIOR DETAILS

SCALE: AS SHOWN


SHEET NUMBER:
I-512

\\file-day.ad.changeupinc.com\Client\StarbucksArchitecture\Projects_2023\Florida\Semoran & Lee Vista -25630-101\25630-101_9875_S Semoran Blvd & Lee Vista Blvd, FL_2023.rvt 3/4/2024 2:40:14 PM


NOTE:
SHOP DRAWINGS TO BE APPROVED BY
SB DESIGNER PRIOR TO FABRICATION.

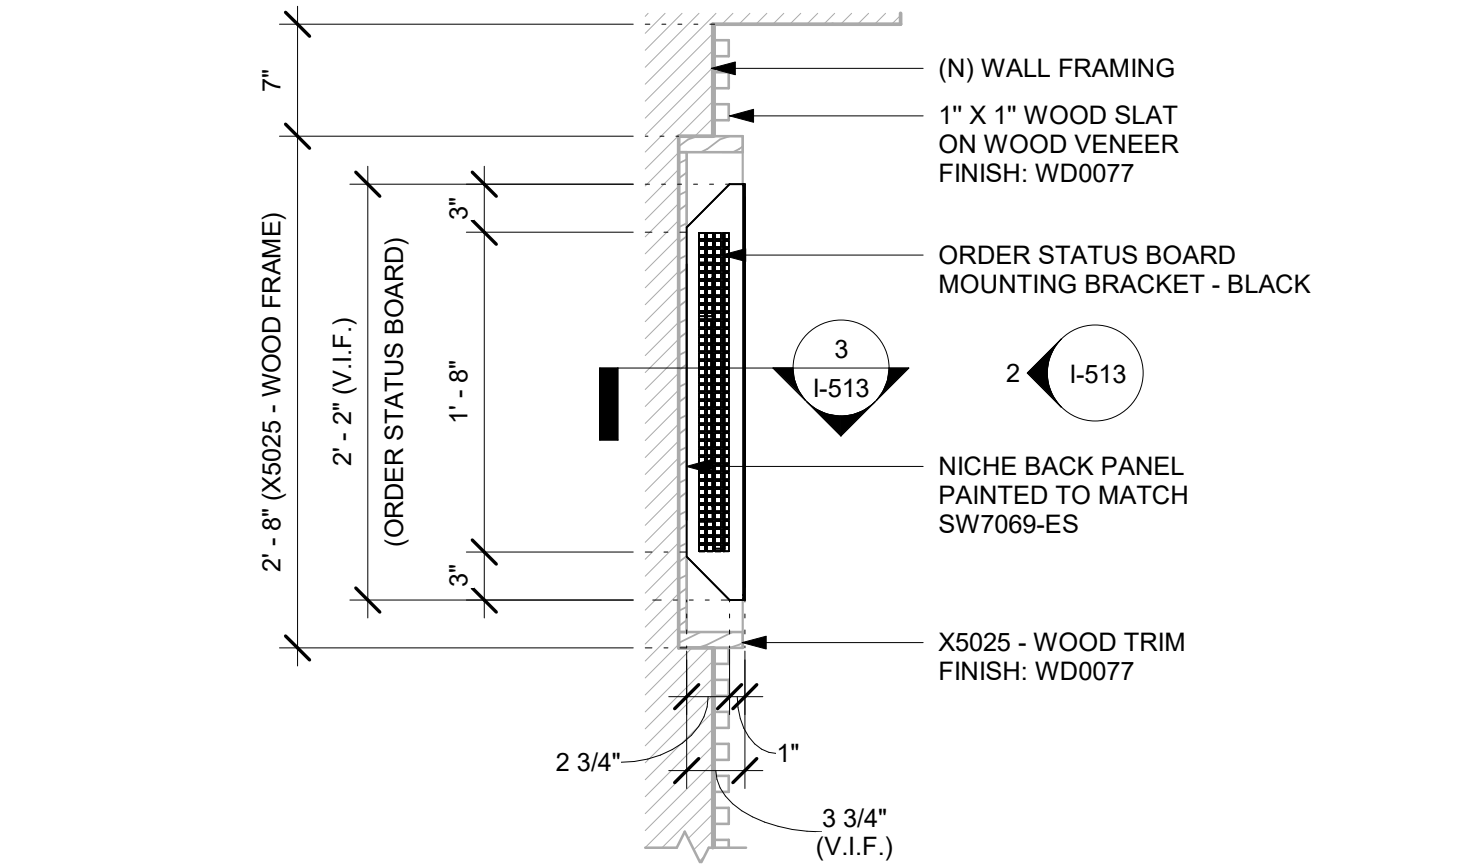


1 ORDER STATUS BOARD - PLAN
Scale: 1" = 1'-0"

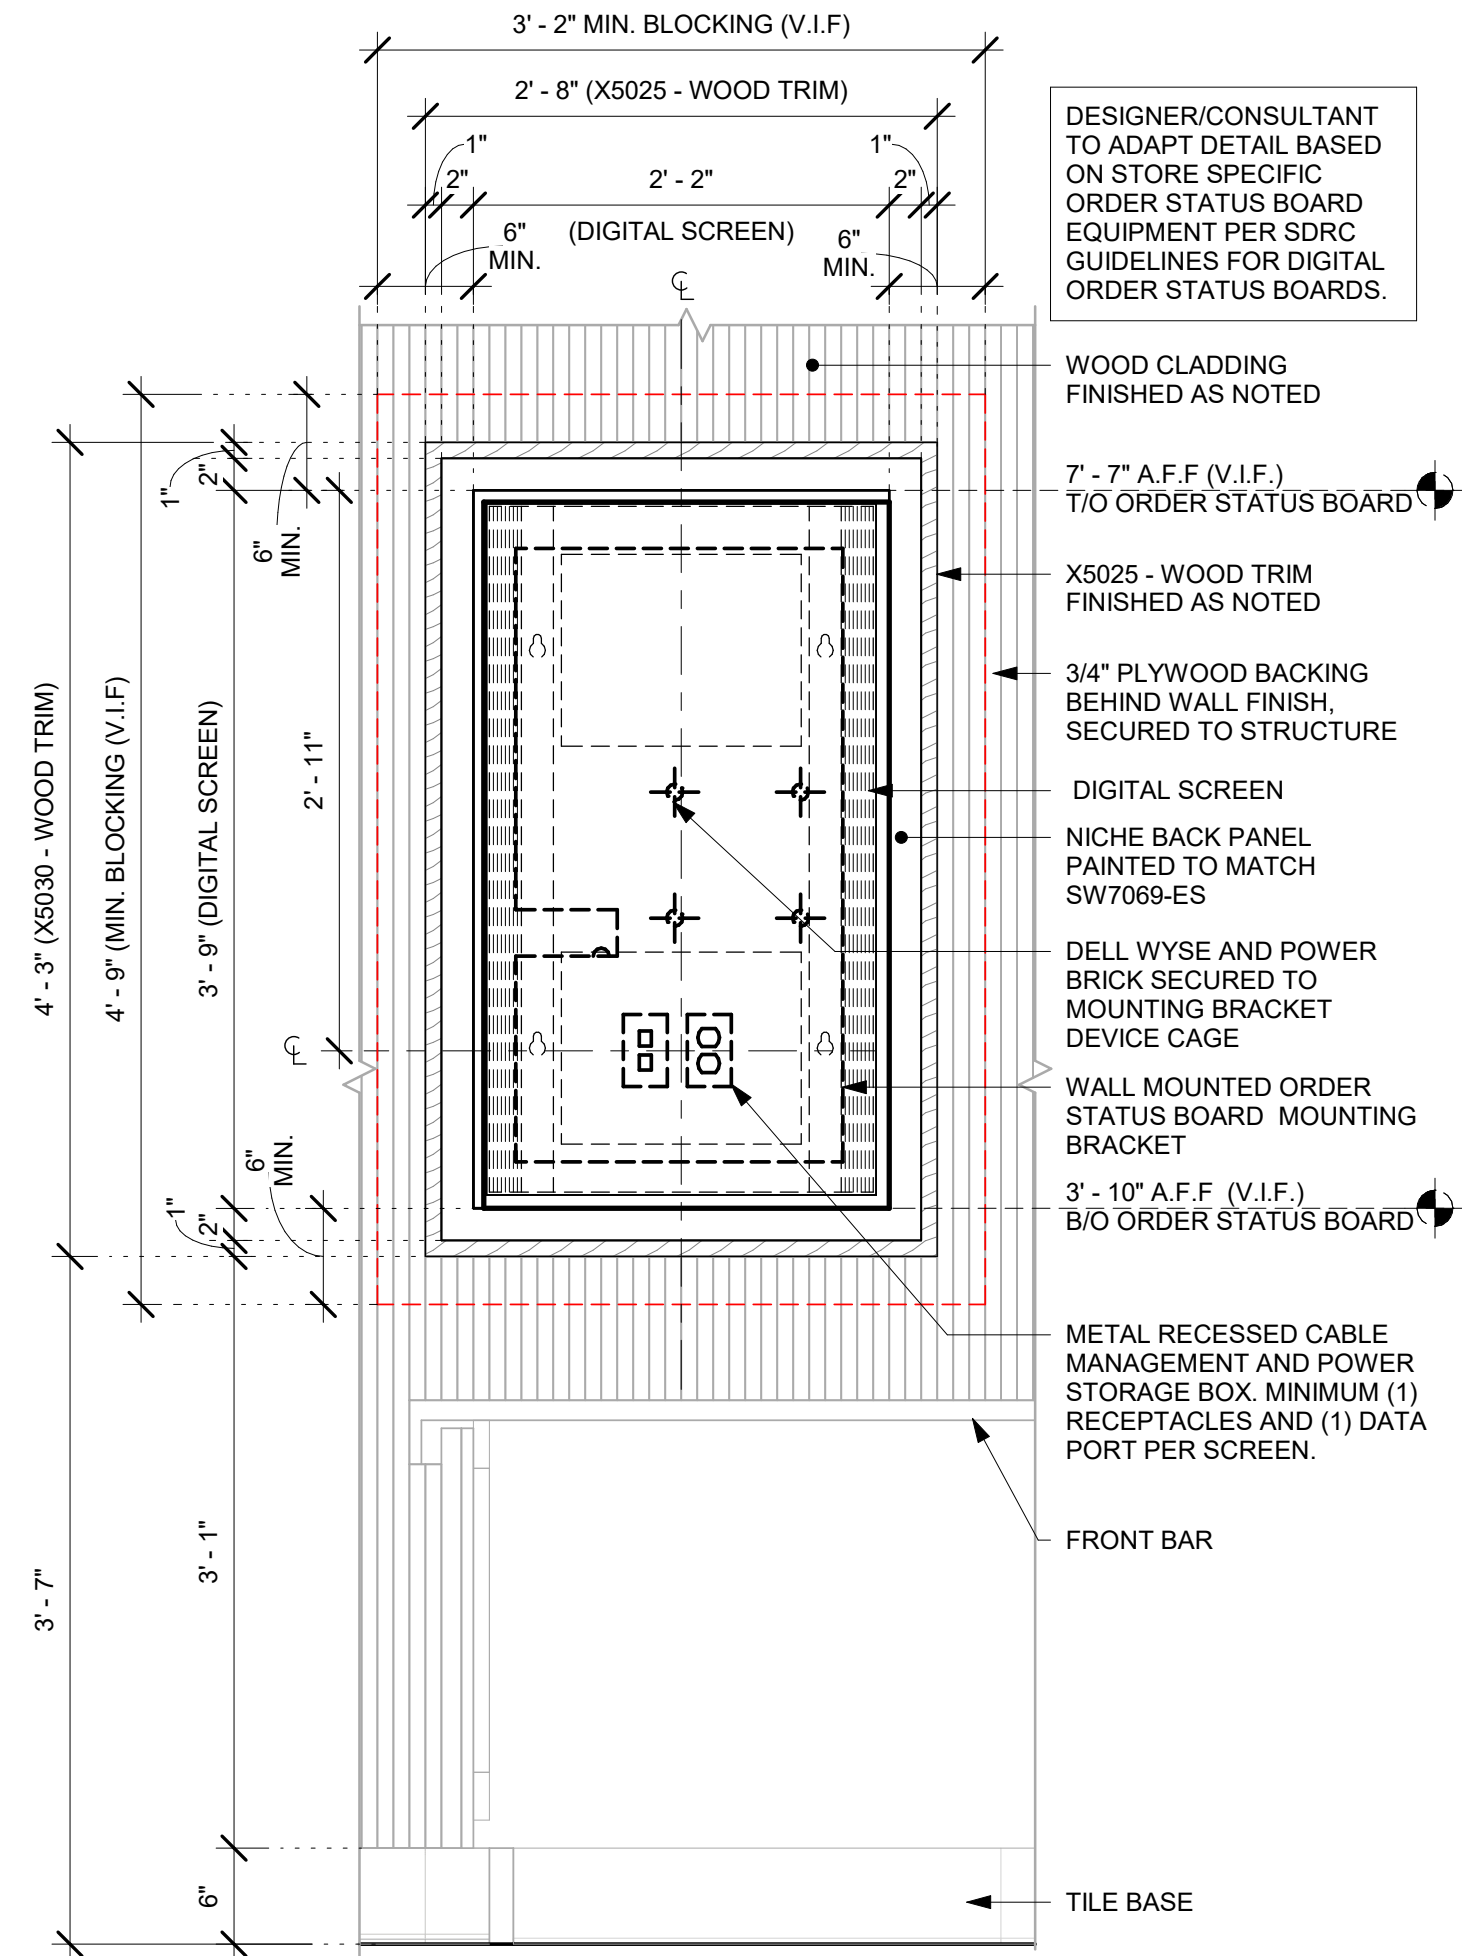


2 ORDER STATUS BOARD - ELEVATION
Scale: 1" = 1'-0"

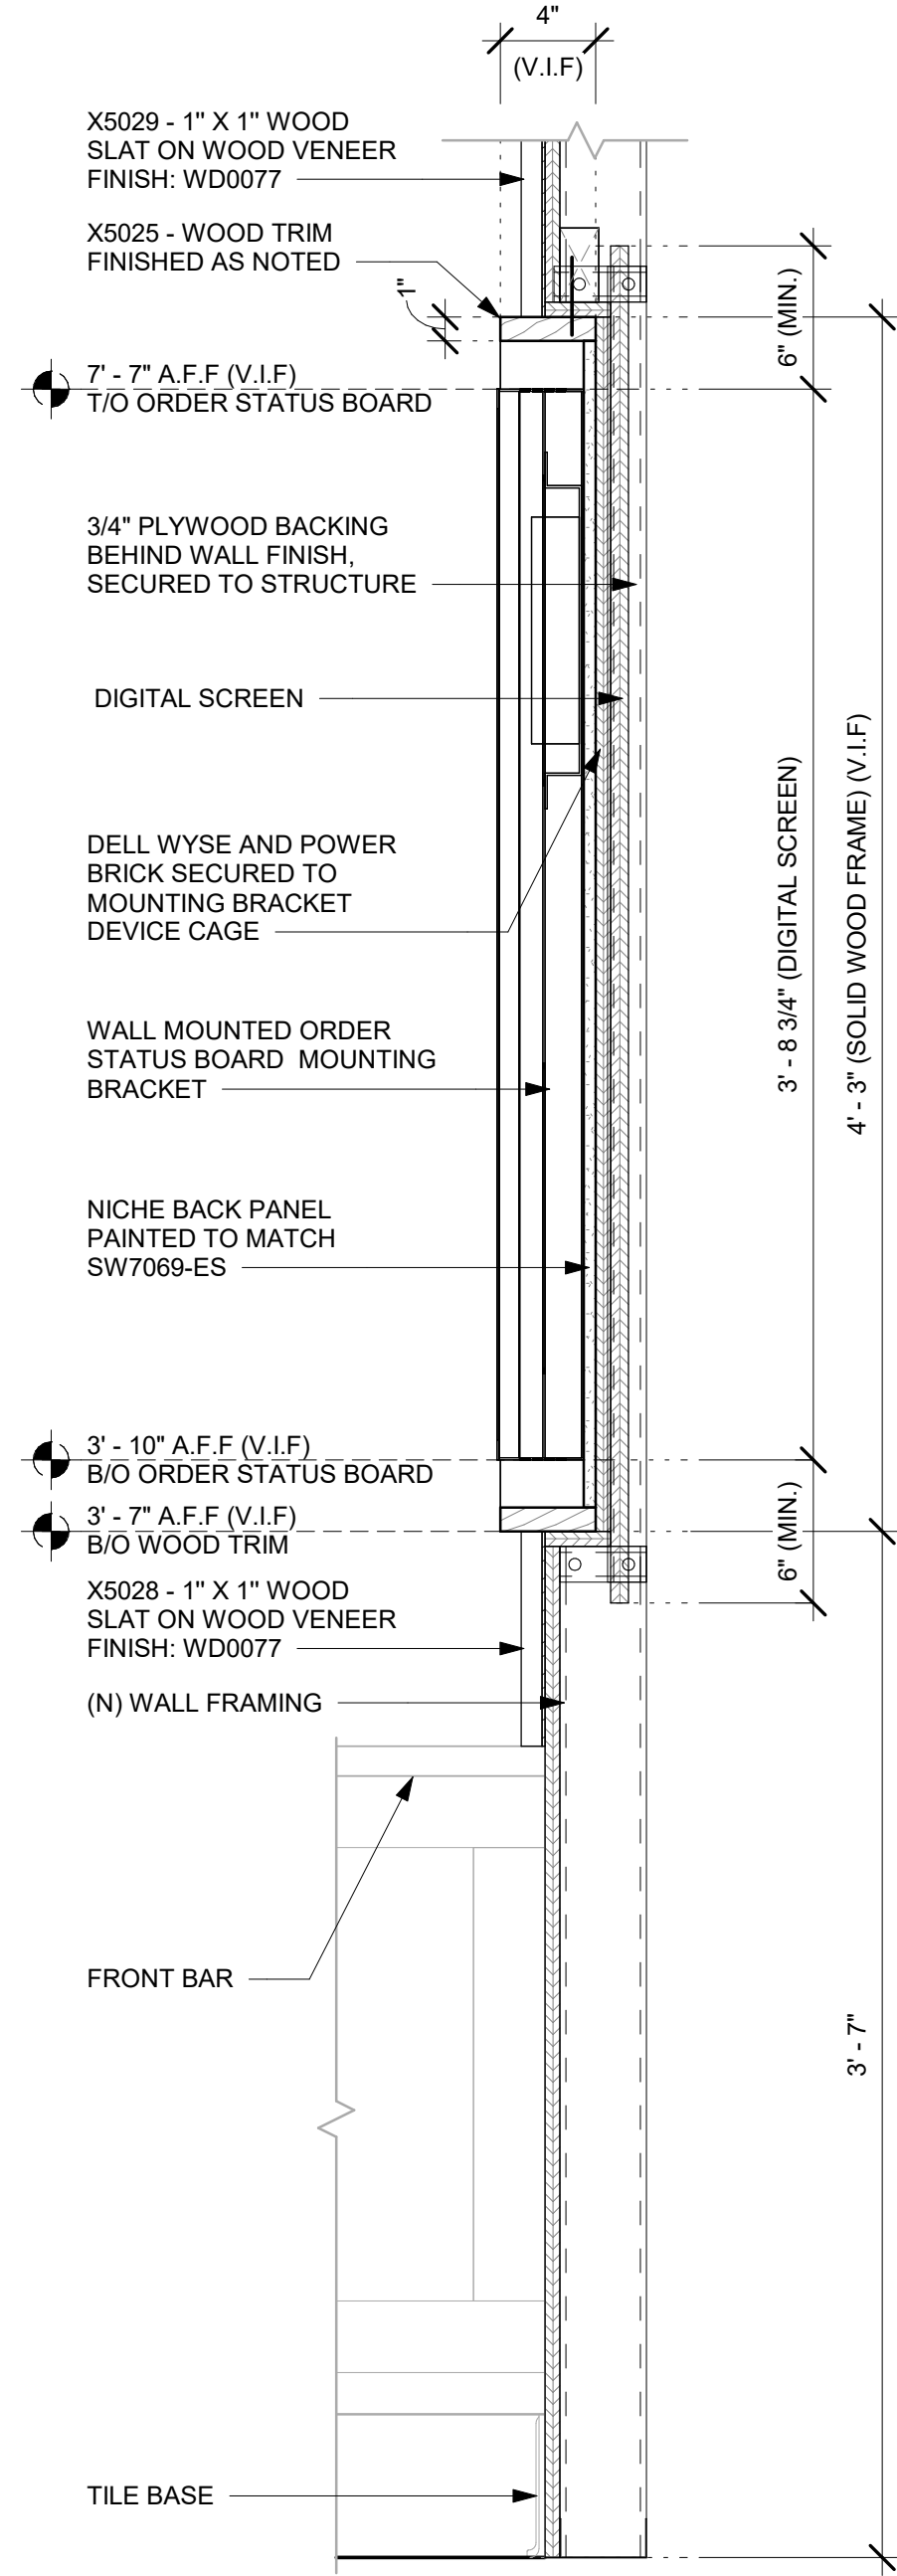


3 ORDER STATUS BOARD - SECTION
Scale: 1 1/2" = 1'-0"

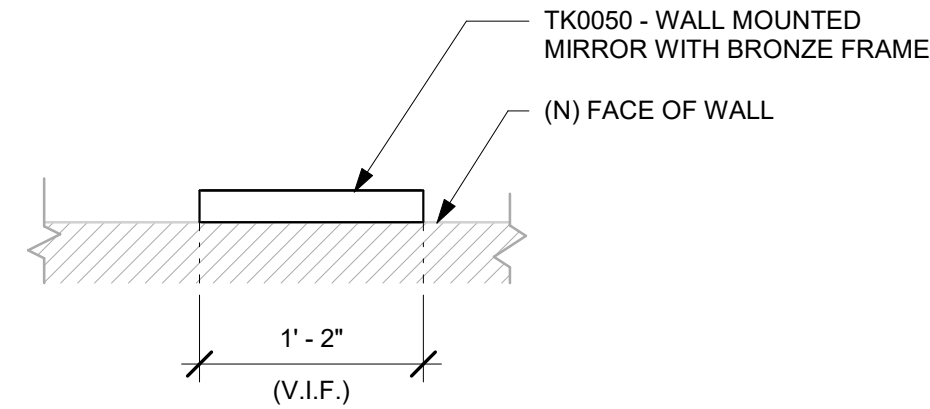

4 TK0050 - MIRROR - PLAN
Scale: 1" = 1'-0"

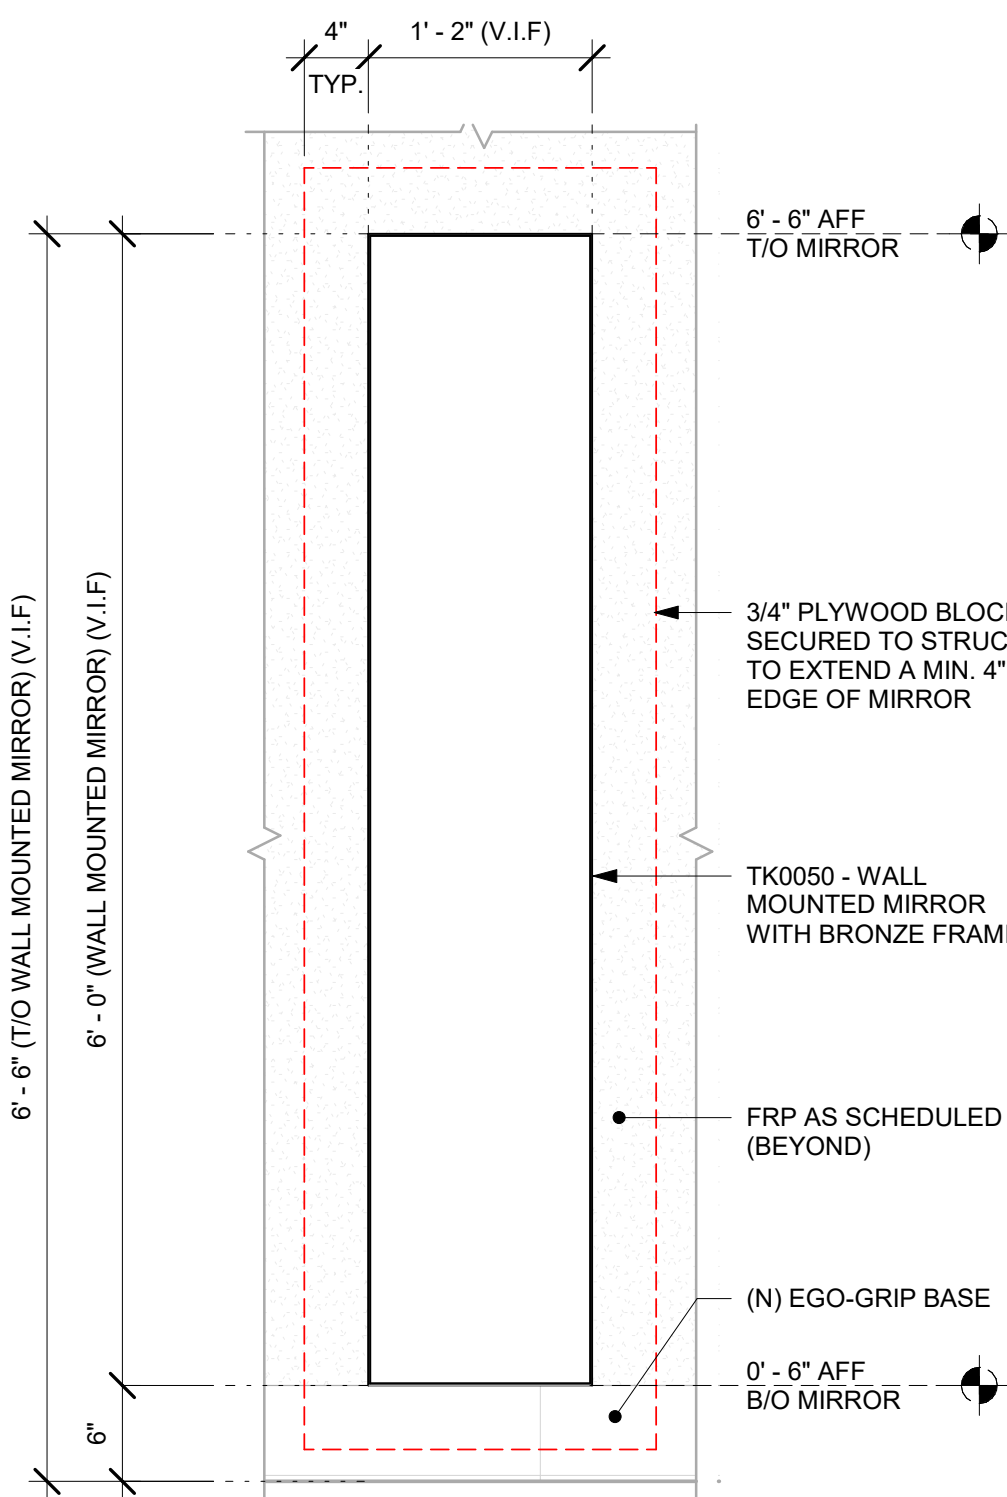

5 TK0050 - MIRROR - ELEVATION
Scale: 1" = 1'-0"

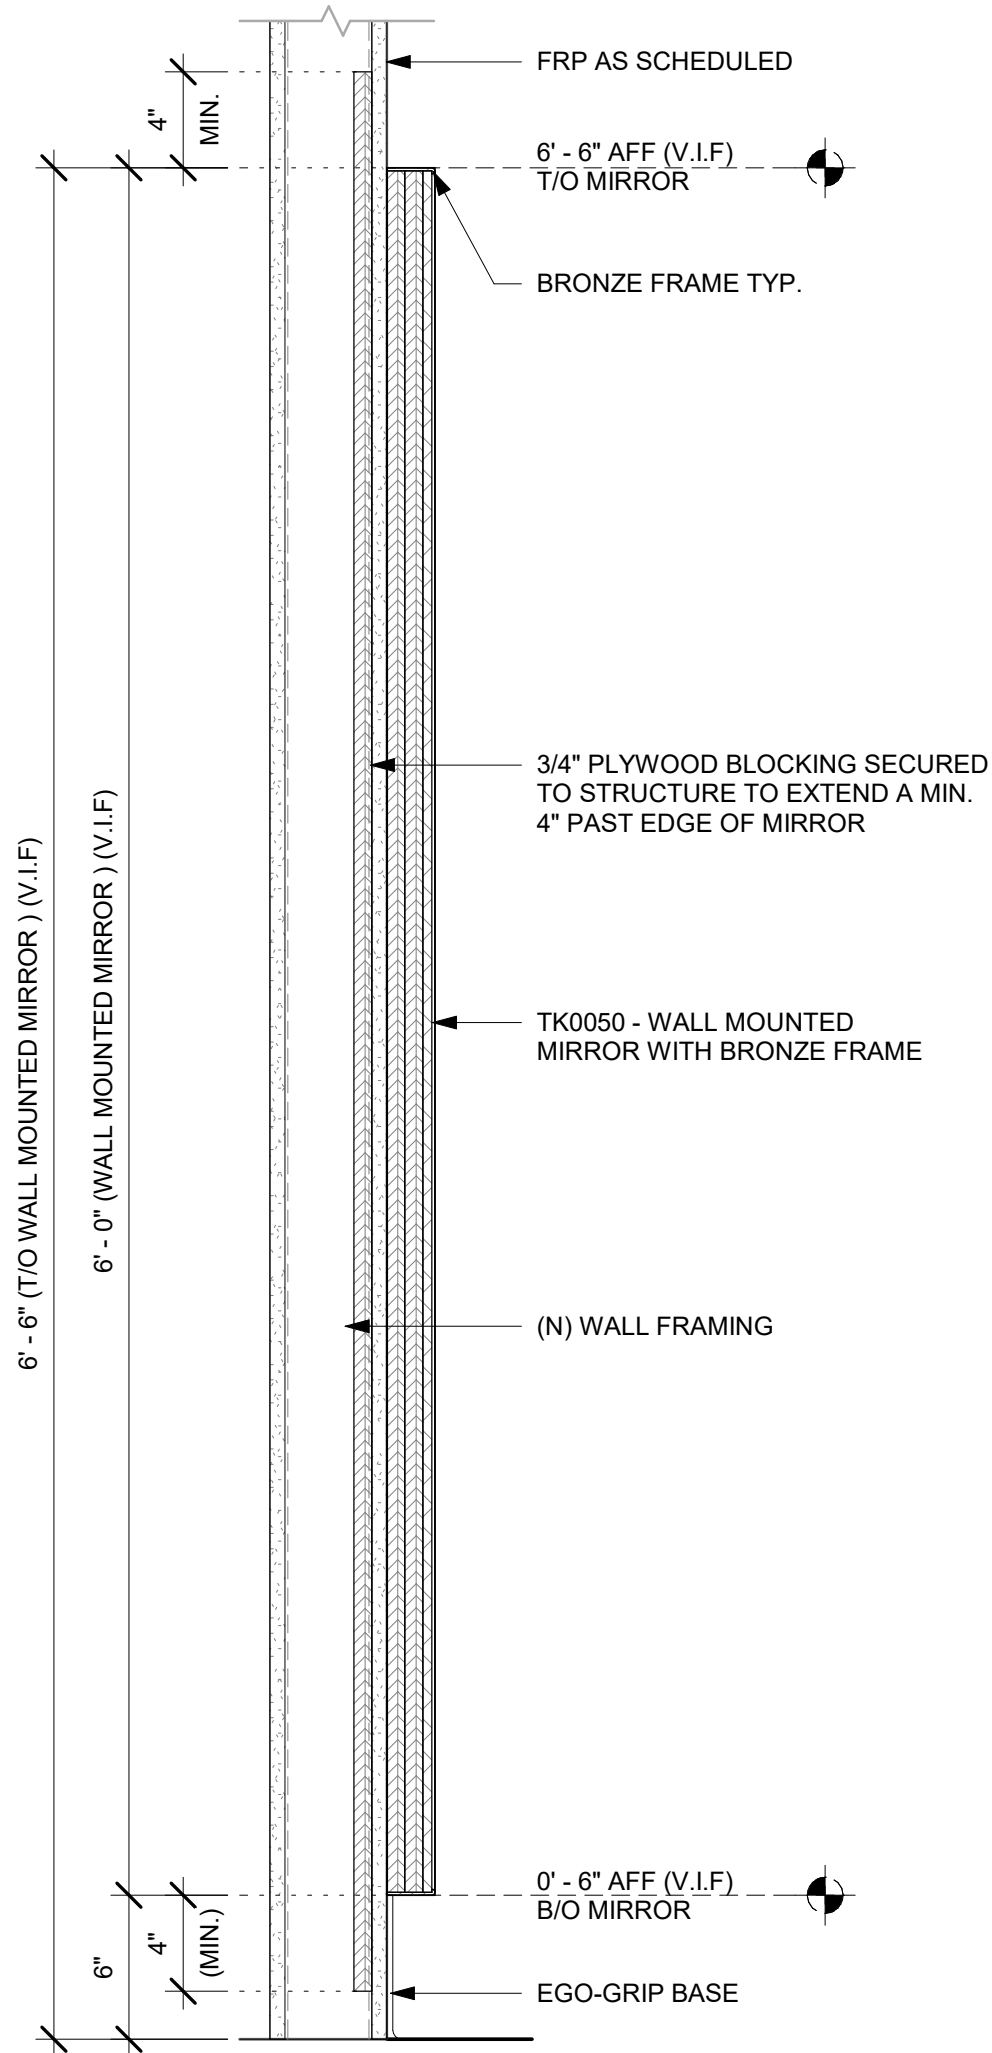

6 TK0050 - MIRROR - SECTION
Scale: 1 1/2" = 1'-0"



STARBUCKS®
2401 UTAH AVENUE SOUTH
SEATTLE, WASHINGTON 98134
(206) 318-1575

THESE DRAWINGS AND THE PROJECT MANUAL ARE CONFIDENTIAL AND SHALL REMAIN THE SOLE PROPERTY OF STARBUCKS CORPORATION, WHICH IS THE OWNER OF THE COPYRIGHT IN THIS WORK. THEY SHALL NOT BE REPRODUCED IN WHOLE OR IN PART, SHARED WITH THIRD PARTIES OR USED IN ANY MANNER ON OTHER PROJECTS OR EXTENSIONS TO THIS PROJECT WITHOUT THE PRIOR WRITTEN CONSENT OF STARBUCKS CORPORATION. THESE DRAWINGS AND SPECIFICATIONS ARE INTENDED TO EXPRESS THE INTENT FOR A PROTOTYPICAL STARBUCKS STORE (WHICH IS SUBJECT TO CHANGE AT ANYTIME) AND DO NOT REFLECT ACTUAL SITE CONDITIONS. NEITHER PARTY SHALL HAVE ANY OBLIGATION NOR LIABILITY TO THE OTHER (EXCEPT STATED ABOVE) UNTIL A WRITTEN AGREEMENT IS FULLY EXECUTED BY BOTH PARTIES.

STARBUCKS TEMPLATE VERSION: i2023.10.23

Design Forum Architects Inc.

2050 Byers Rd
Miami, OH 45342
Tel: (614) 804-7700

Donald J. Rehman
Architect in Charge
License: AR0017303



2230 PARK AVE, STE. 100, CINCINNATI, OH 45206
513.457.7131 - WWW.MARQUEENG.COM

FOR CONSTRUCTION

PROJECT NAME:
S SEMORAN BLVD & LEE VISTA BLVD

PROJECT ADDRESS:
**6605 S SEMORAN BLVD
ORLANDO, FL 32822**

STORE #: 9875
PROJECT #: 25630-101
ISSUE DATE: 03/04/2024
DESIGN MANAGER: MARTIN PEREZ
PRODUCTION DESIGNER: ANDY MCLOUD
CHECKED BY: DONALD REHMAN


Revision Schedule			
Rev	Date	By	Description

SHEET TITLE:
INTERIOR DETAILS


SCALE: AS SHOWN

SHEET NUMBER:
I-513

3/4/2024 2:40:15 PM

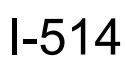


NOTE:
SHOP DRAWINGS TO BE APPROVED BY
SB DESIGNER PRIOR TO FABRICATION.

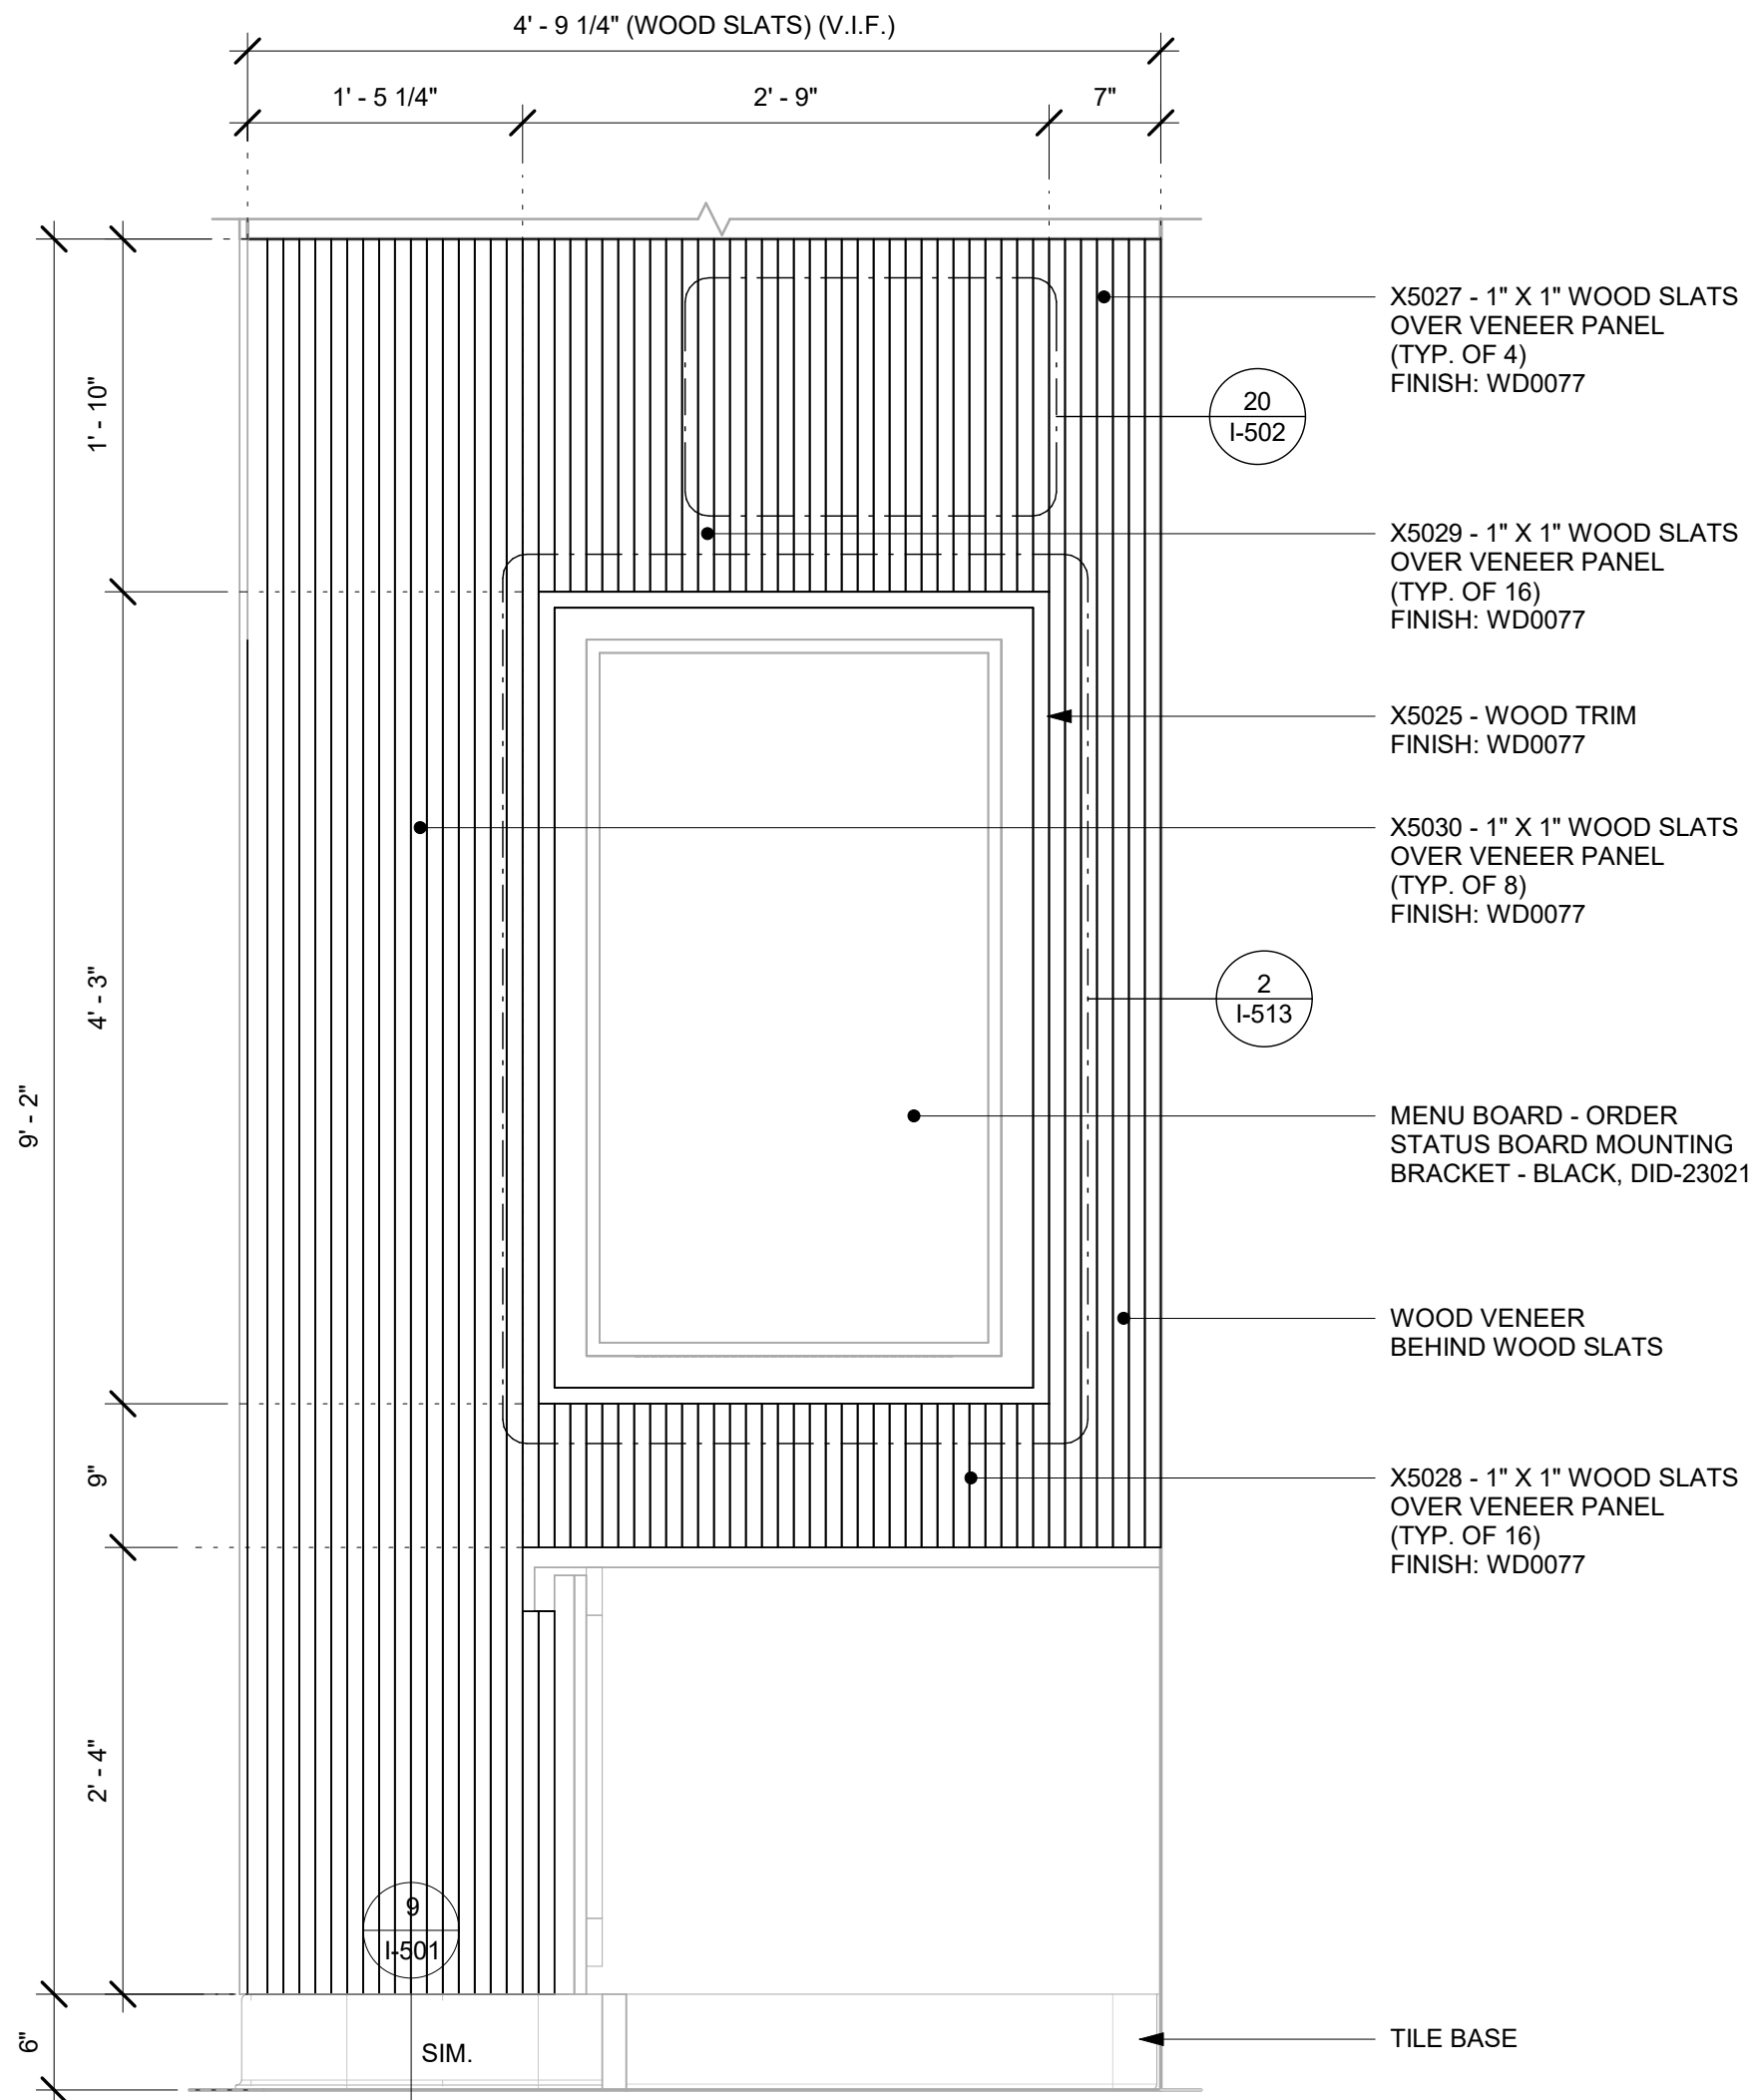

1 WOOD SLATS - ELEVATION AT ORDER STATUS BOARD SIDE

Scale: 1" = 1'-0"

FOR CONSTRUCTION




© 2023 STARBUCKS COFFEE COMPANY

STARBUCKS®
2401 UTAH AVENUE SOUTH
SEATTLE, WASHINGTON 98134
(206) 318-1575

THESE DRAWINGS AND THE PROJECT MANUAL ARE CONFIDENTIAL AND SHALL REMAIN THE SOLE PROPERTY OF STARBUCKS CORPORATION, WHICH IS THE OWNER OF THE COPYRIGHT IN THIS WORK. THEY SHALL NOT BE REPRODUCED IN WHOLE OR IN PART, SHARED WITH THIRD PARTIES OR USED IN ANY MANNER ON OTHER PROJECTS OR EXTENSIONS TO THIS PROJECT WITHOUT THE PRIOR WRITTEN CONSENT OF STARBUCKS CORPORATION. THESE DRAWINGS AND SPECIFICATIONS ARE INTENDED TO EXPRESS DESIGN INTENT FOR A PROTOTYPICAL STARBUCKS STORE (WHICH IS SUBJECT TO CHANGE AT ANYTIME) AND DO NOT REFLECT ACTUAL SITE CONDITIONS. NEITHER PARTY SHALL HAVE ANY OBLIGATION NOR LIABILITY TO THE OTHER (EXCEPT STATED ABOVE) UNTIL A WRITTEN AGREEMENT IS FULLY EXECUTED BY BOTH PARTIES.

STARBUCKS TEMPLATE VERSION: i2023.10.23

Design Forum Architects Inc.
2050 Byers Rd
Miamisburg, OH 45342
Tel: (844) 804-7700
Donald J. Reihman
Architect In Charge
License: AR0017303

**MARQUE ENGINEERING**
2230 PARK AVE, STE. 100, CINCINNATI, OH 45206
513.457.7131 - WWW.MARQUEENG.COM

PROJECT NAME:
S SEMORAN BLVD & LEE VISTA BLVD

PROJECT ADDRESS:
**6605 S SEMORAN BLVD
ORLANDO, FL 32822**

STORE #: 9875
PROJECT #: 25630-101
ISSUE DATE: 03/04/2024
DESIGN MANAGER: MARTIN PEREZ
PRODUCTION DESIGNER: ANDY MCLOUD
CHECKED BY: DONALD RETHMAN


Revision Schedule			
Rev	Date	By	Description

SHEET TITLE:
INTERIOR DETAILS


SCALE: 1" = 1'-0"

SHEET NUMBER:
I-515


NOTE:
SHOP DRAWINGS TO BE APPROVED BY
SB DESIGNER PRIOR TO FABRICATION.

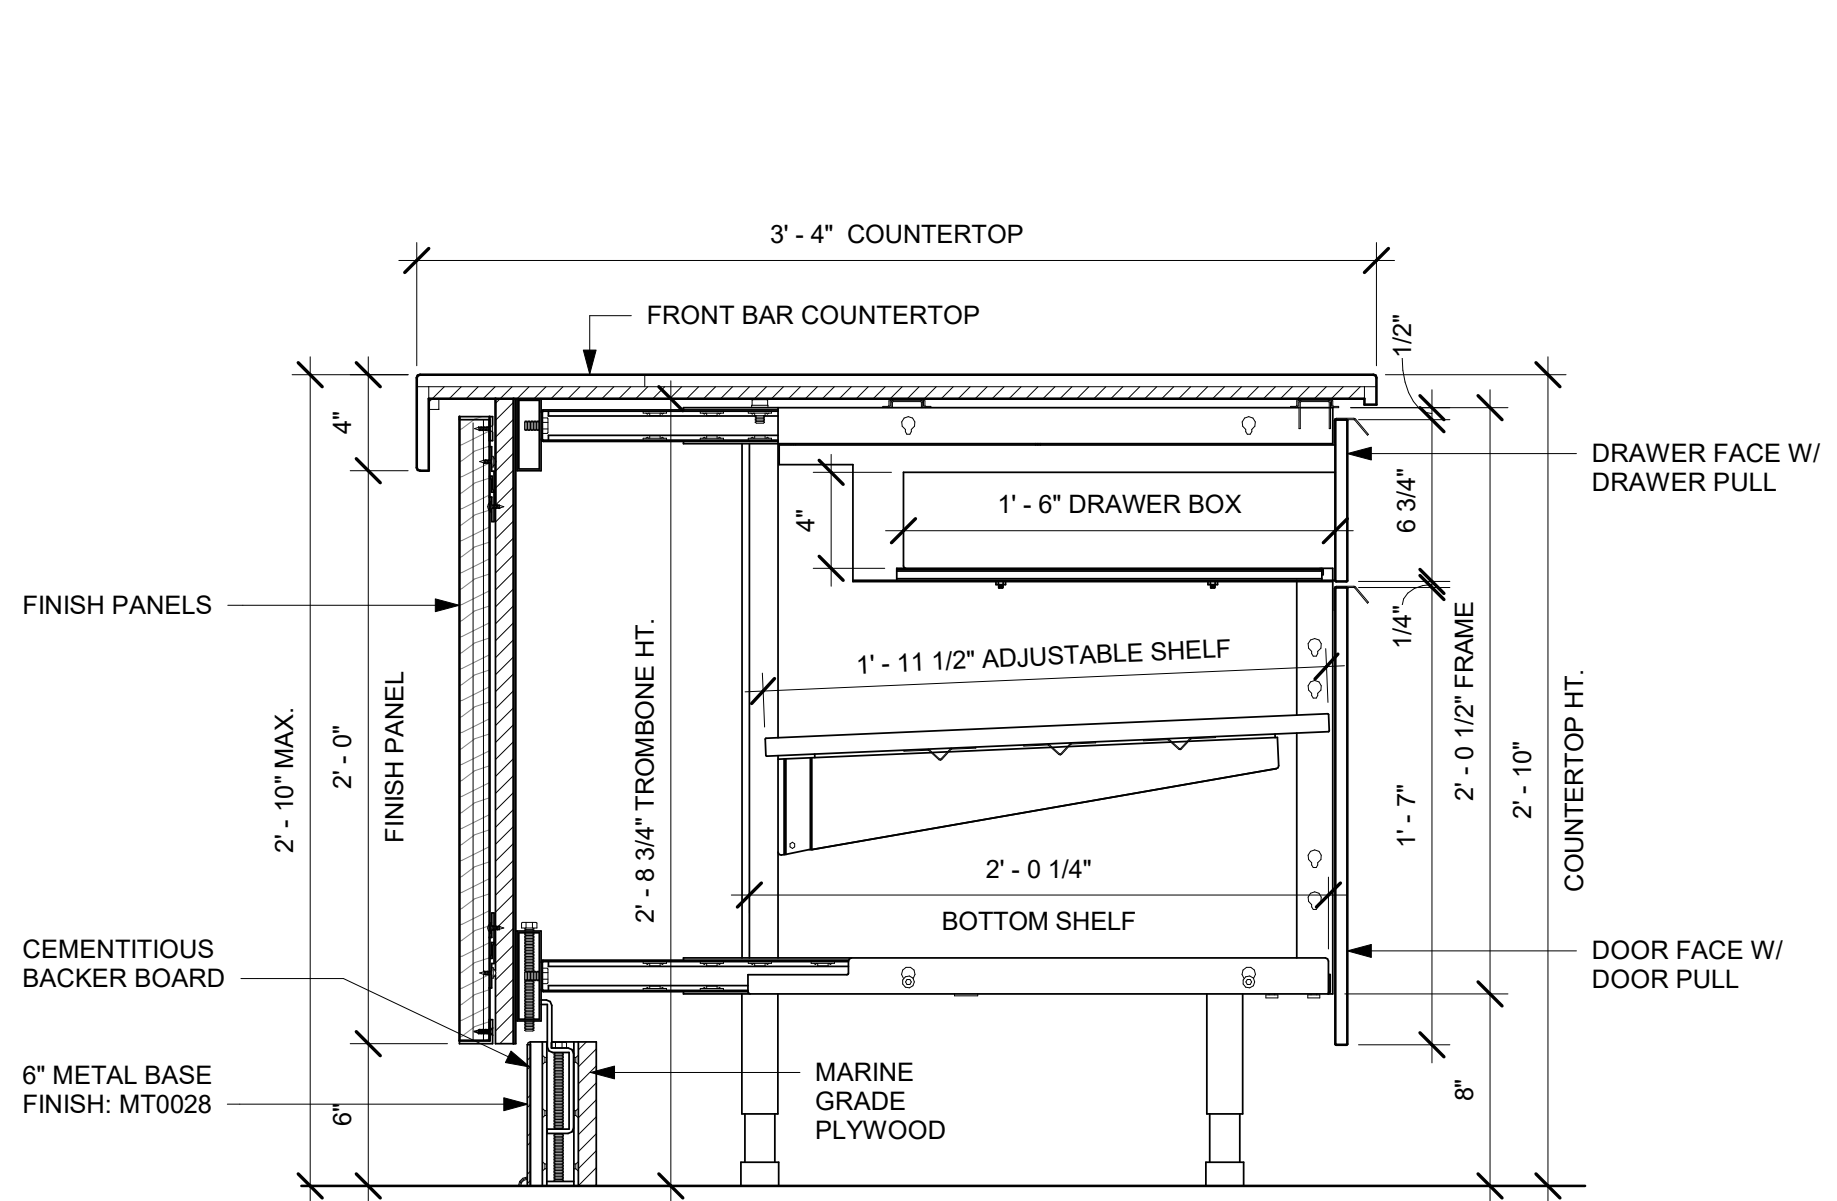


1 AC FRONT BAR DRAWER CABINET ASSEMBLY ON LEGS SECTION
Scale: 1 1/2" = 1'-0"

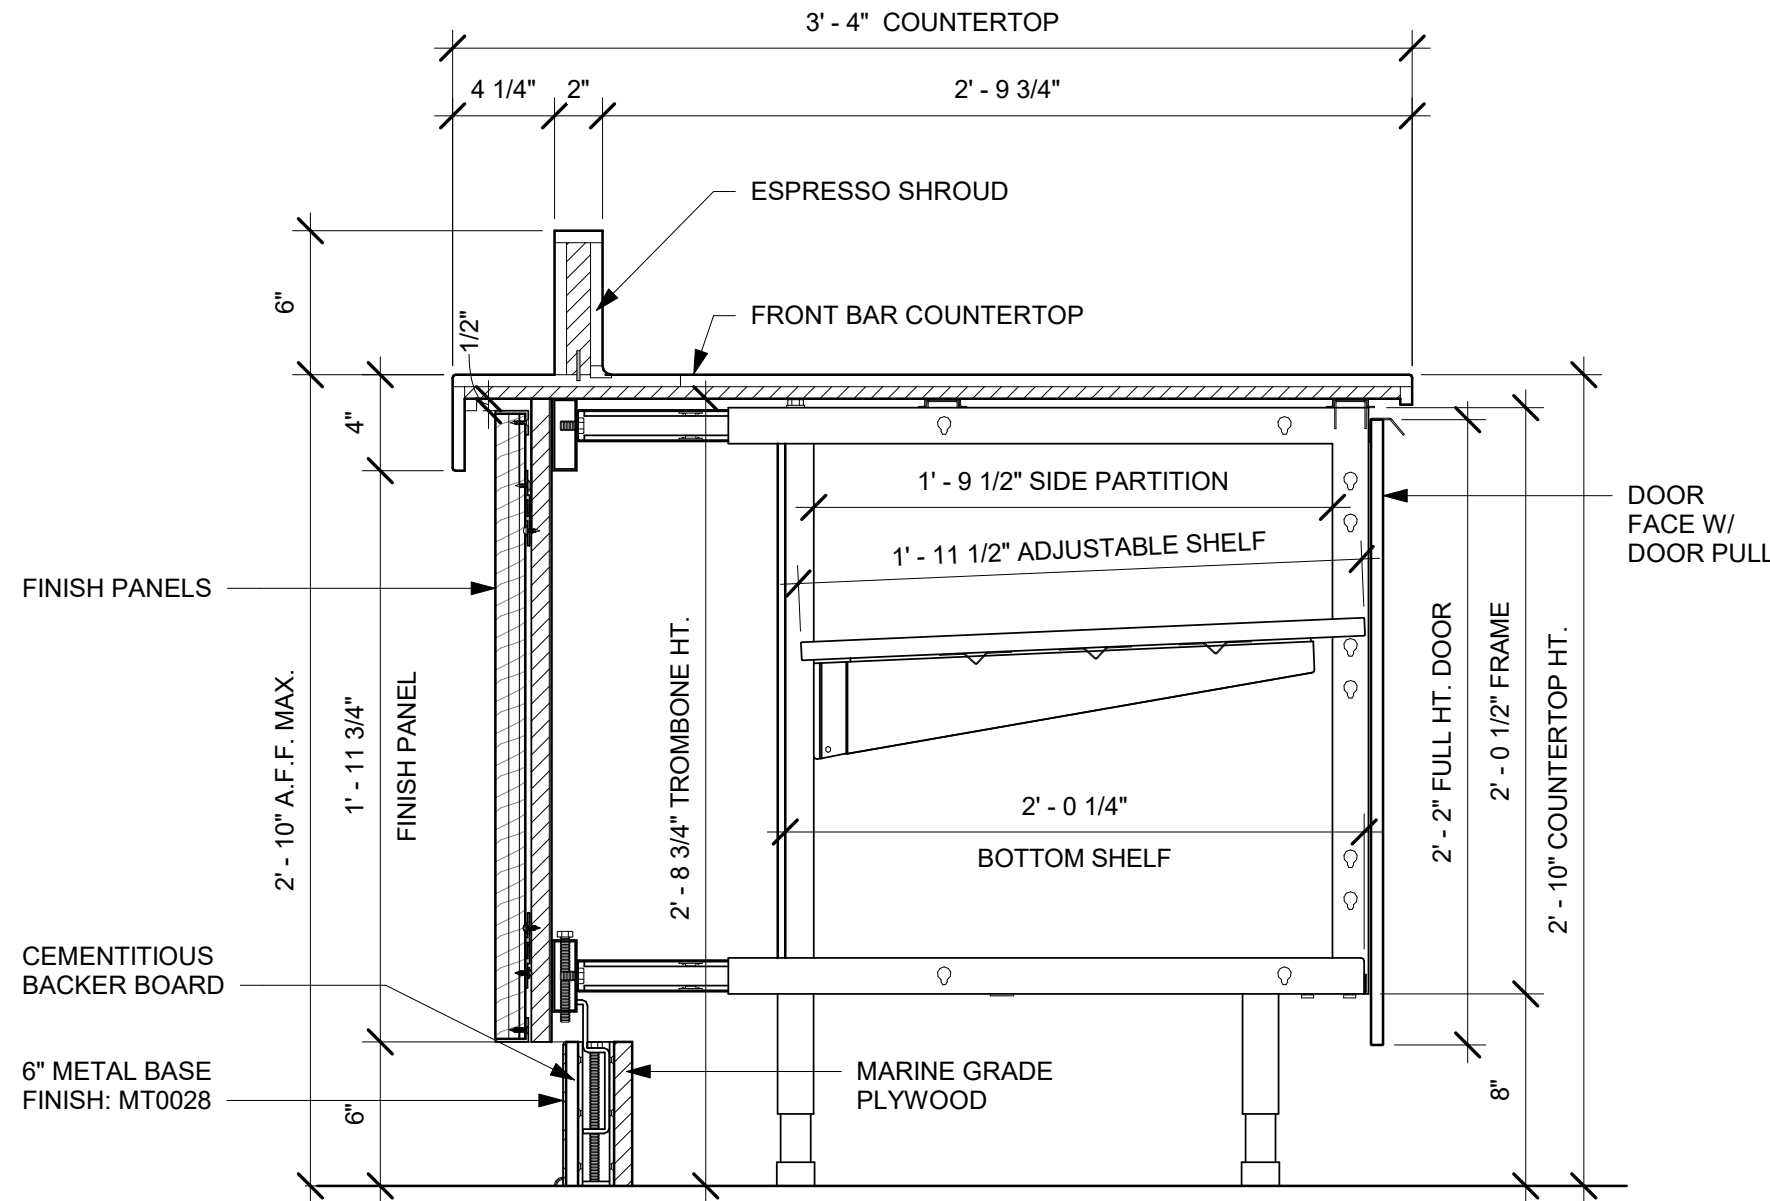


2 AC FRONT BAR CABINET ASSEMBLY ON LEGS SECTION
Scale: 1 1/2" = 1'-0"

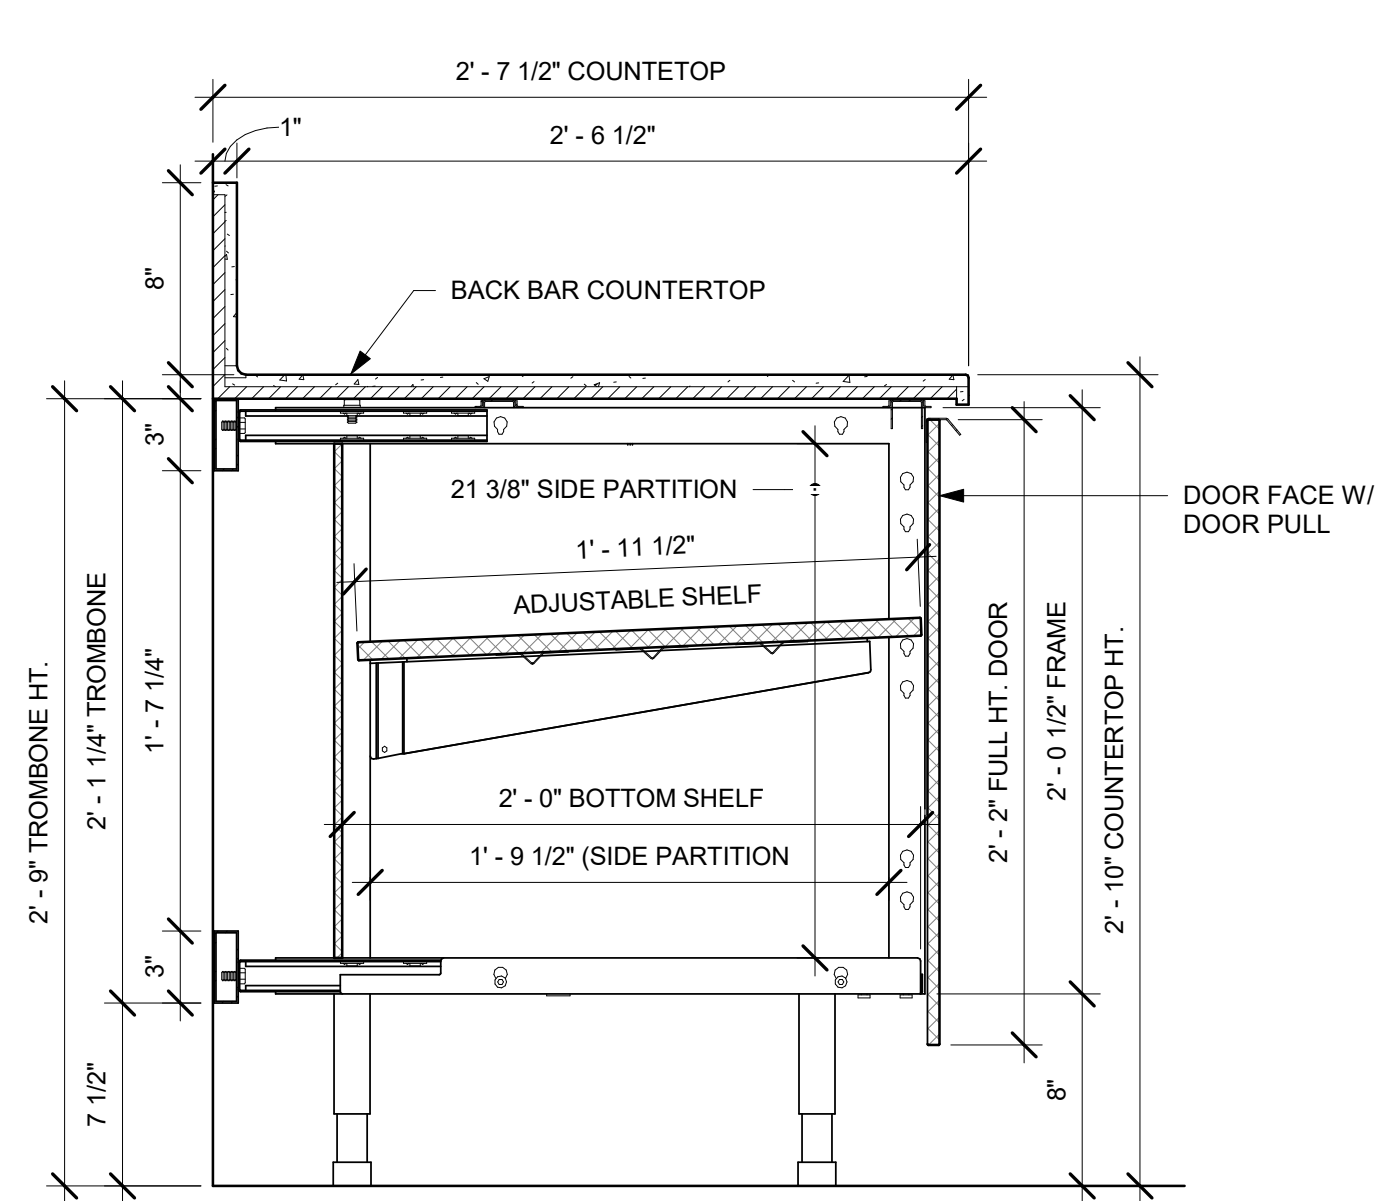


3 AC BACK BAR CABINET ASSEMBLY ON LEGS SECTION
Scale: 1 1/2" = 1'-0"

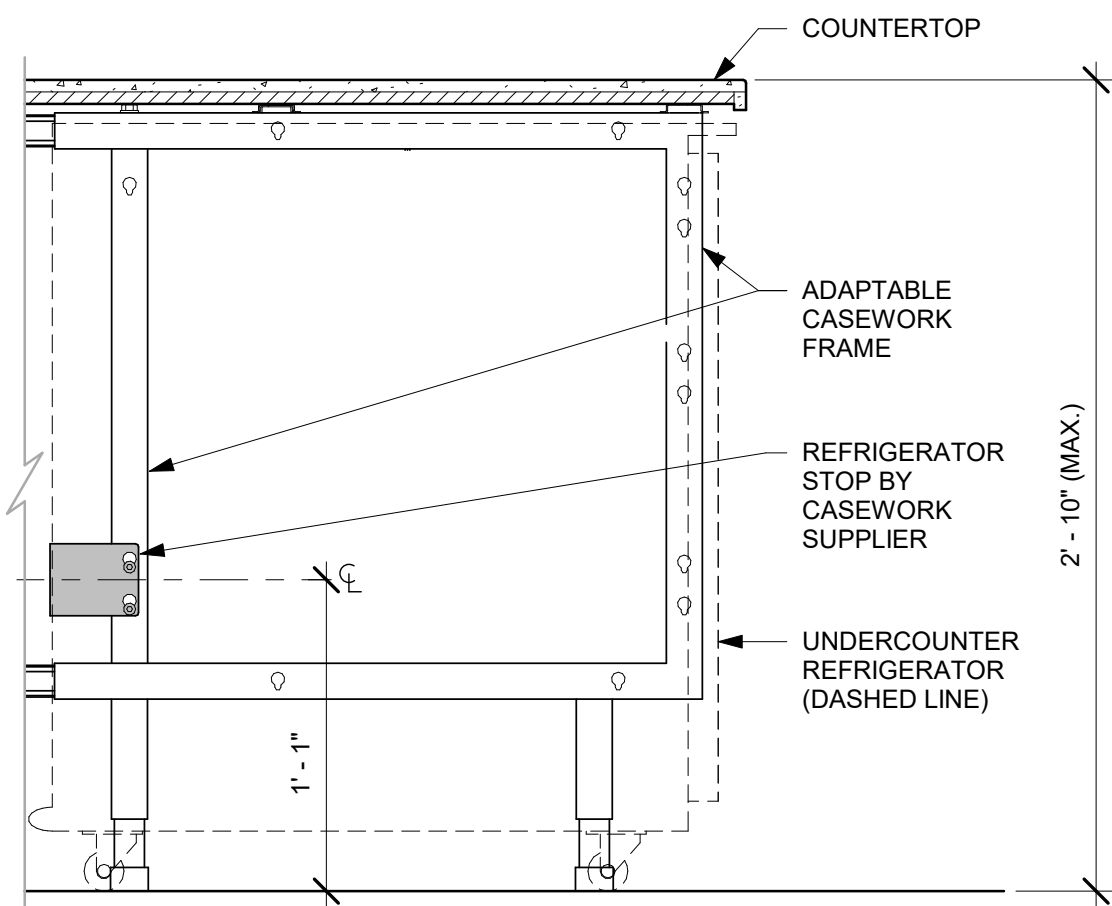


4 AC UNDERCOUNTER REFRIGERATOR SECTION
Scale: 1 1/2" = 1'-0"

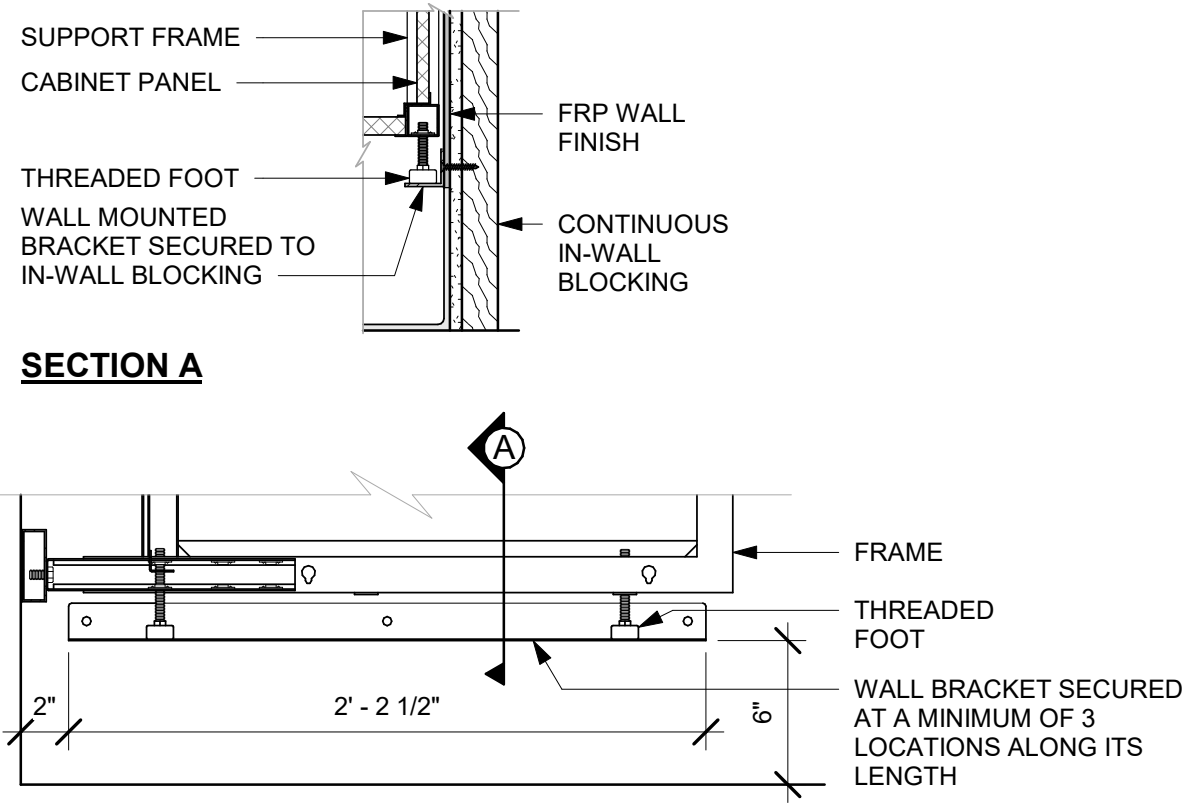


5 AC BACKLINE WALL BRACKET ASSEMBLY
Scale: 1 1/2" = 1'-0"

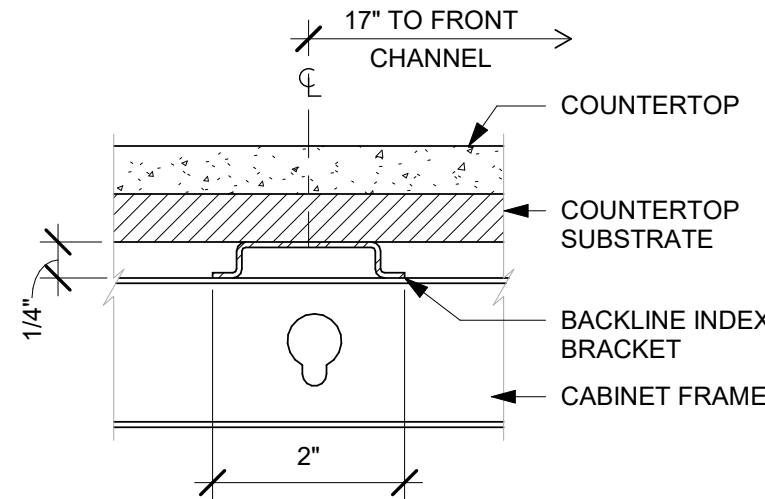


6 AC COUNTERTOP SUPPORT CHANNEL
Scale: 6" = 1'-0"

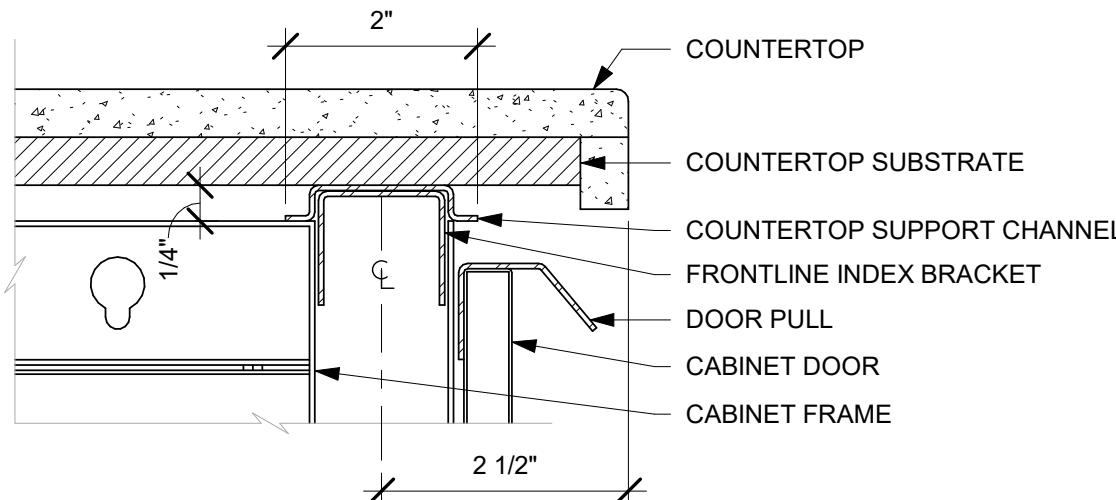

7 AC COUNTERTOP FRONT HAT SUPPORT CHANNEL
Scale: 6" = 1'-0"

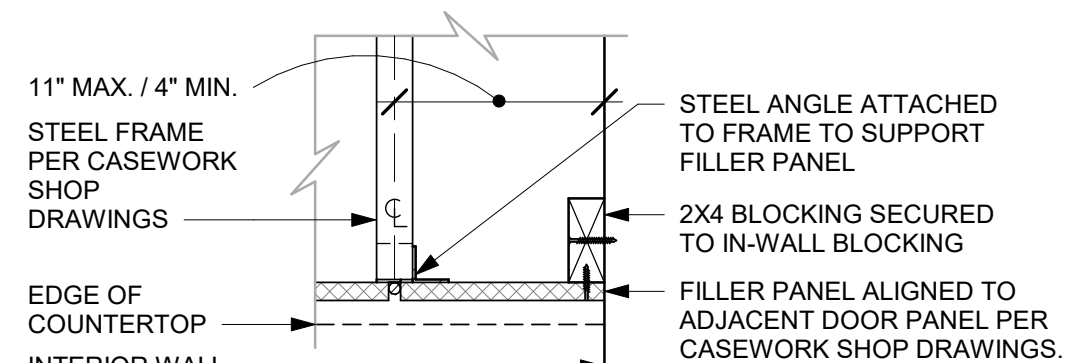

SECTION A

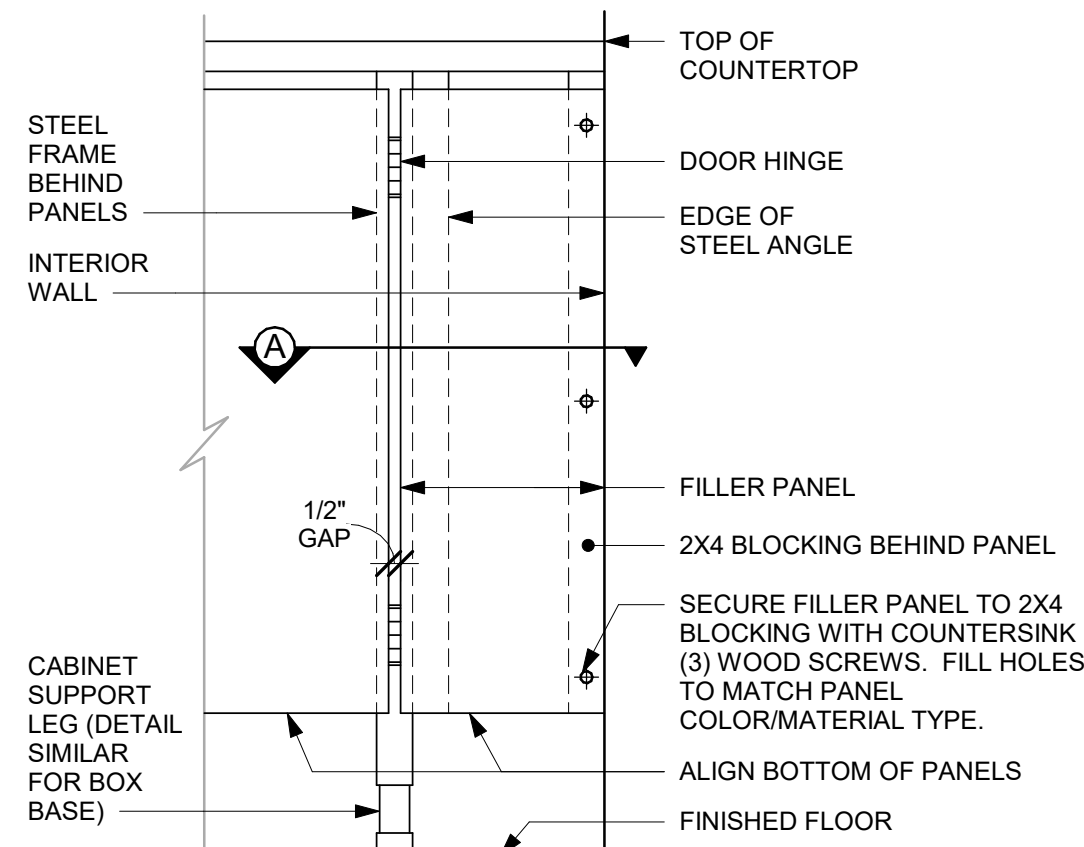

FRONT ELEVATION

8 FILLER PANEL AT WALL
Scale: 1 1/2" = 1'-0"



© 2023 STARBUCKS COFFEE COMPANY

STARBUCKS®
2401 UTAH AVENUE SOUTH
SEATTLE, WASHINGTON 98134
(206) 318-1575

THESE DRAWINGS AND THE PROJECT MANUAL ARE CONFIDENTIAL AND SHALL REMAIN THE SOLE PROPERTY OF STARBUCKS CORPORATION, WHICH IS THE OWNER OF THE COPYRIGHT IN THIS WORK. THEY SHALL NOT BE REPRODUCED IN WHOLE OR IN PART, SHARED WITH THIRD PARTIES OR USED IN ANY MANNER ON OTHER PROJECTS OR EXTENSIONS TO THIS PROJECT WITHOUT THE PRIOR WRITTEN CONSENT OF STARBUCKS CORPORATION. THESE DRAWINGS AND SPECIFICATIONS ARE INTENDED TO EXPRESS DESIGN INTENT FOR A PROTOTYPICAL STARBUCKS STORE (WHICH IS SUBJECT TO CHANGE AT ANYTIME) AND DO NOT REFLECT ACTUAL SITE CONDITIONS. NEITHER PARTY SHALL HAVE ANY OBLIGATION NOR LIABILITY TO THE OTHER (EXCEPT STATED ABOVE) UNTIL A WRITTEN AGREEMENT IS FULLY EXECUTED BY BOTH PARTIES.

STARBUCKS TEMPLATE VERSION: i2023.10.23

Design Forum Architects Inc.

2050 Byers Rd
Miamisburg, OH 45342
Tel: (844) 804-7700

Donald J. Rehman
Architect in Charge
License: AR0017303



2230 PARK AVE, STE. 100, CINCINNATI, OH 45206
513.457.7131 - WWW.MARQUEENG.COM

FOR CONSTRUCTION

PROJECT NAME:
S SEMORAN BLVD & LEE VISTA BLVD

PROJECT ADDRESS:
**6605 S SEMORAN BLVD
ORLANDO, FL 32822**

STORE #: 9875
PROJECT #: 25630-101
ISSUE DATE: 03/04/2024
DESIGN MANAGER: MARTIN PEREZ
PRODUCTION DESIGNER: ANDY MCLOUD
CHECKED BY: DONALD REHMAN

Revision Schedule			
Rev	Date	By	Description

SHEET TITLE:
INTERIOR DETAILS


SCALE: AS SHOWN

SHEET NUMBER:

I-516


3/4/2024 2:40:17 PM \\file-day.ad.changeupinc.com\Client\StarbucksArchitecture\Projects_2023\Florida\Semoran & Lee Vista -25630-101\25630-101_9875_S Semoran Blvd & Lee Vista Blvd, FL_2023.rvt

NOTE:
SHOP DRAWINGS TO BE APPROVED BY
SB DESIGNER PRIOR TO FABRICATION.

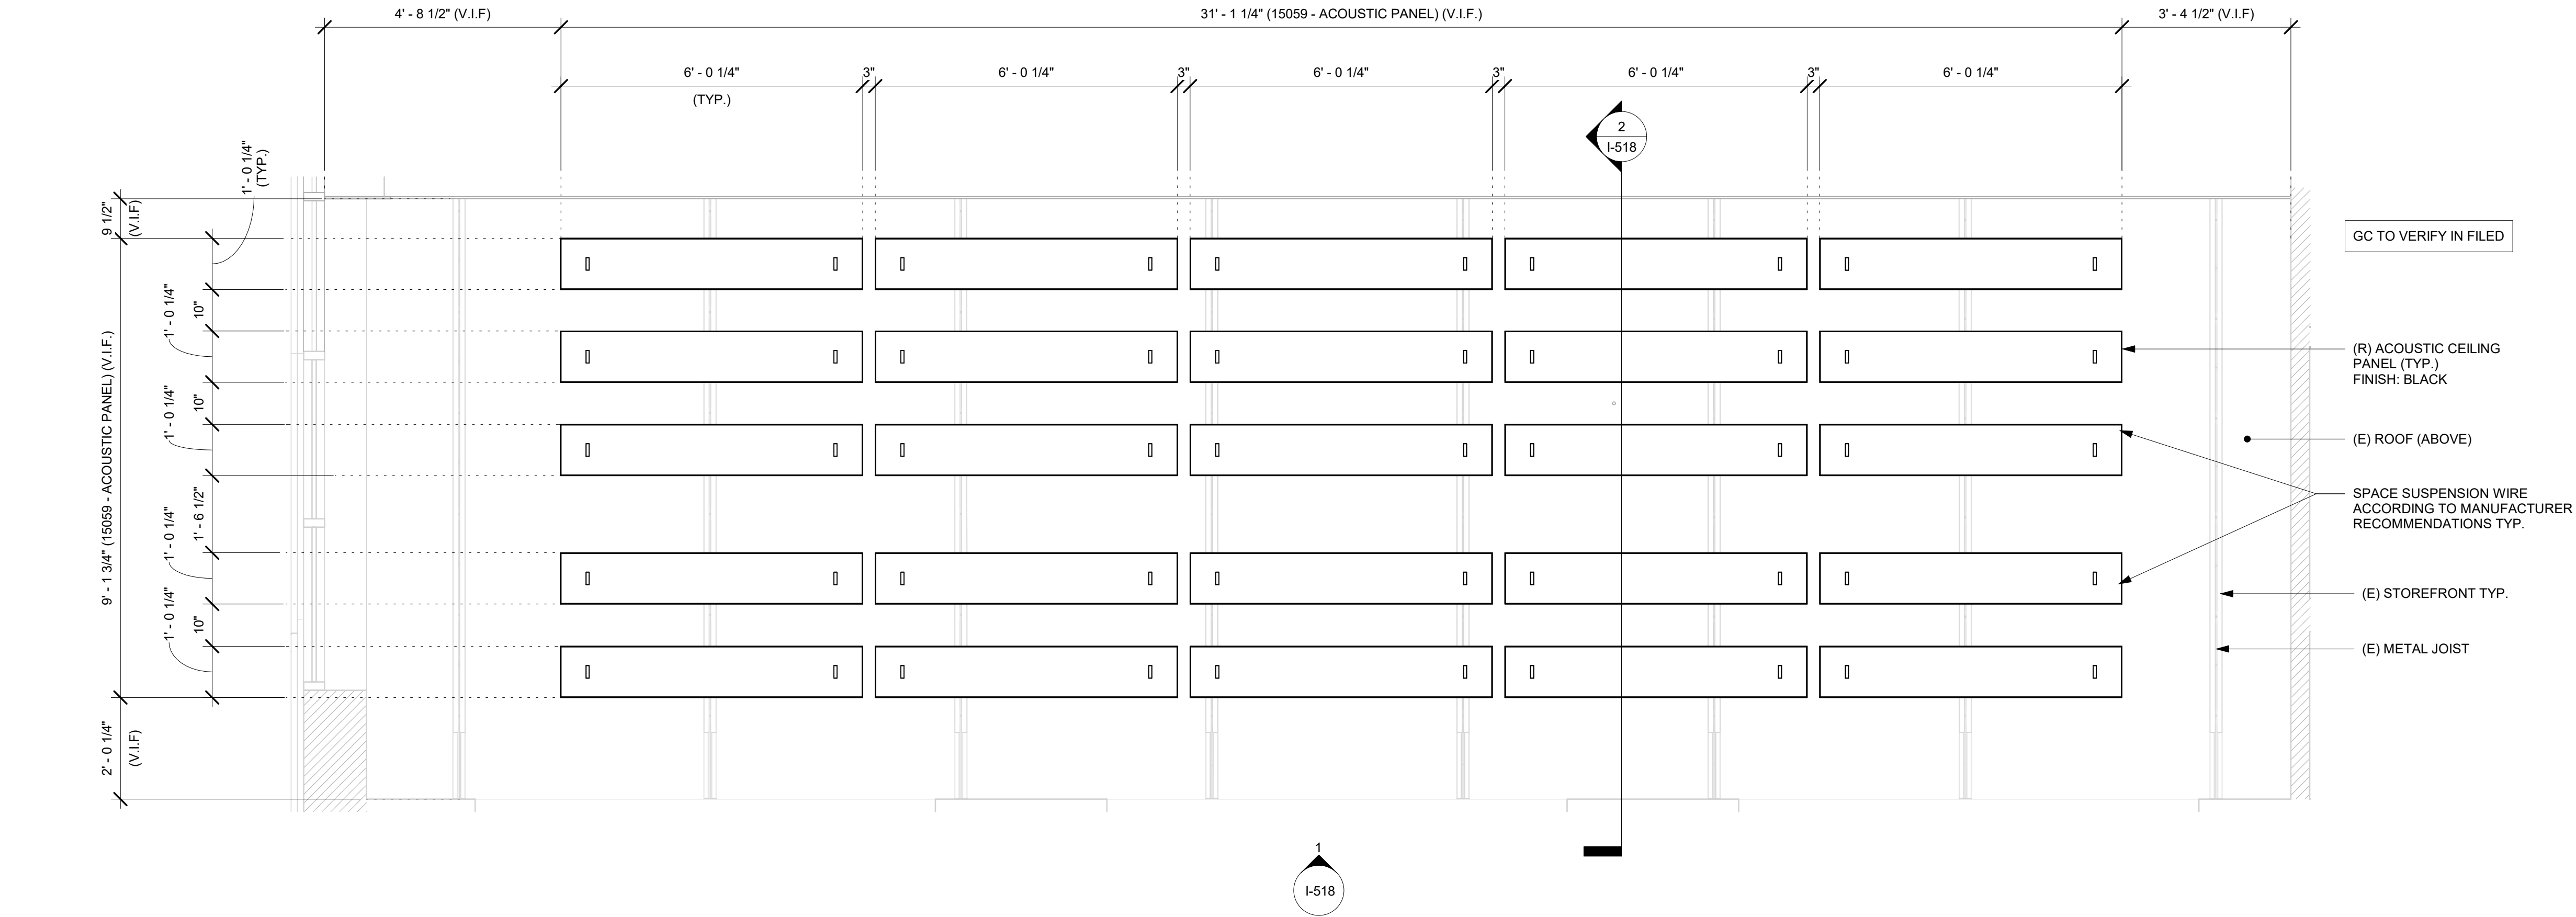

1 ACOUSTICAL CEILING PANEL - PLAN
Scale: 1/2" = 1'-0"

FOR CONSTRUCTION




© 2023 STARBUCKS COFFEE COMPANY

STARBUCKS®
2401 UTAH AVENUE SOUTH
SEATTLE, WASHINGTON 98134
(206) 318-1575

THESE DRAWINGS AND THE PROJECT MANUAL ARE CONFIDENTIAL AND SHALL REMAIN THE SOLE PROPERTY OF STARBUCKS CORPORATION, WHICH IS THE OWNER OF THE COPYRIGHT IN THIS WORK. THEY SHALL NOT BE REPRODUCED IN WHOLE OR IN PART, SHARED WITH THIRD PARTIES OR USED IN ANY MANNER ON OTHER PROJECTS OR EXTENSIONS TO THIS PROJECT WITHOUT THE PRIOR WRITTEN CONSENT OF STARBUCKS CORPORATION. THESE DRAWINGS AND SPECIFICATIONS ARE INTENDED TO EXPRESS INTENT FOR A PROTOTYPICAL STARBUCKS STORE (WHICH IS SUBJECT TO CHANGE AT ANYTIME) AND DO NOT REFLECT ACTUAL SITE CONDITIONS. NEITHER PARTY SHALL HAVE ANY OBLIGATION NOR LIABILITY TO THE OTHER (EXCEPT STATED ABOVE) UNTIL A WRITTEN AGREEMENT IS FULLY EXECUTED BY BOTH PARTIES.

STARBUCKS TEMPLATE VERSION: i2023.10.23

Design Forum Architects Inc.
2050 Byers Rd
Miamisburg, OH 45342
Tel: (844) 804-7700
Donald J. Reihman
Architect In Charge
License: AR0017303


2230 PARK AVE, STE. 100, CINCINNATI, OH 45206
513.457.7131 - WWW.MARQUEENG.COM

PROJECT NAME:
S SEMORAN BLVD & LEE VISTA BLVD

PROJECT ADDRESS:
**6605 S SEMORAN BLVD
ORLANDO, FL 32822**

STORE #: 9875
PROJECT #: 25630-101
ISSUE DATE: 03/04/2024
DESIGN MANAGER: MARTIN PEREZ
PRODUCTION DESIGNER: ANDY MCLOUD
CHECKED BY: DONALD RETHMAN

Revision Schedule			
Rev	Date	By	Description


SHEET TITLE:
ACOUSTICAL PANEL

SCALE: 1/2" = 1'-0"

SHEET NUMBER:
I-517


3/4/2024 2:40:18 PM \\file-day.ad.changeupinc.com\Client\StarbucksArchitecture\Projects_2023\Florida\Semoran & Lee Vista -25630-101\25630-101_9875_S Semoran Blvd & Lee Vista Blvd, FL_2023.rvt

NOTE:
SHOP DRAWINGS TO BE APPROVED BY
SB DESIGNER PRIOR TO FABRICATION.

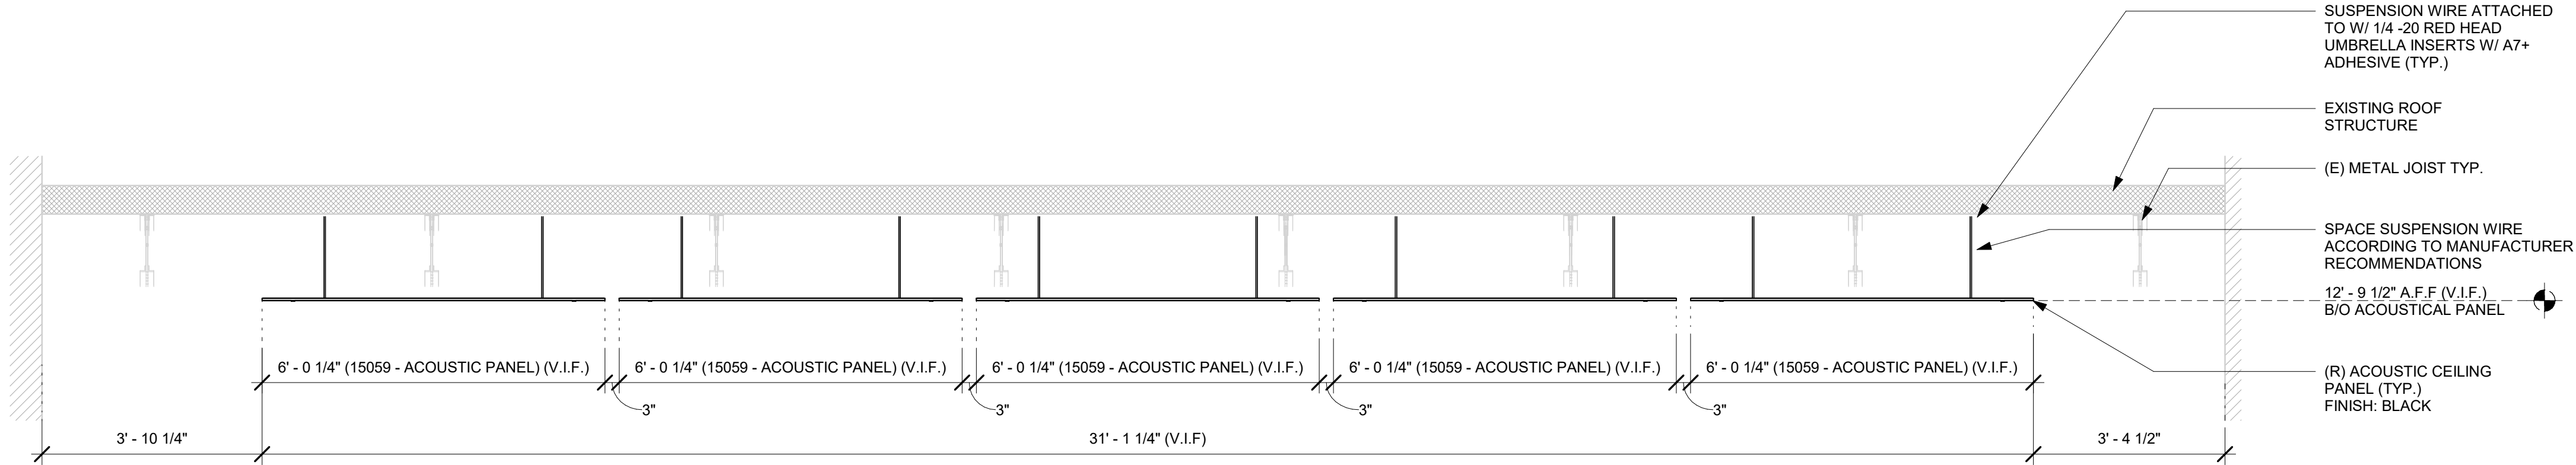

1 ACOUSTICAL PANELS - ELEVATION

Scale: 1/2" = 1'-0"

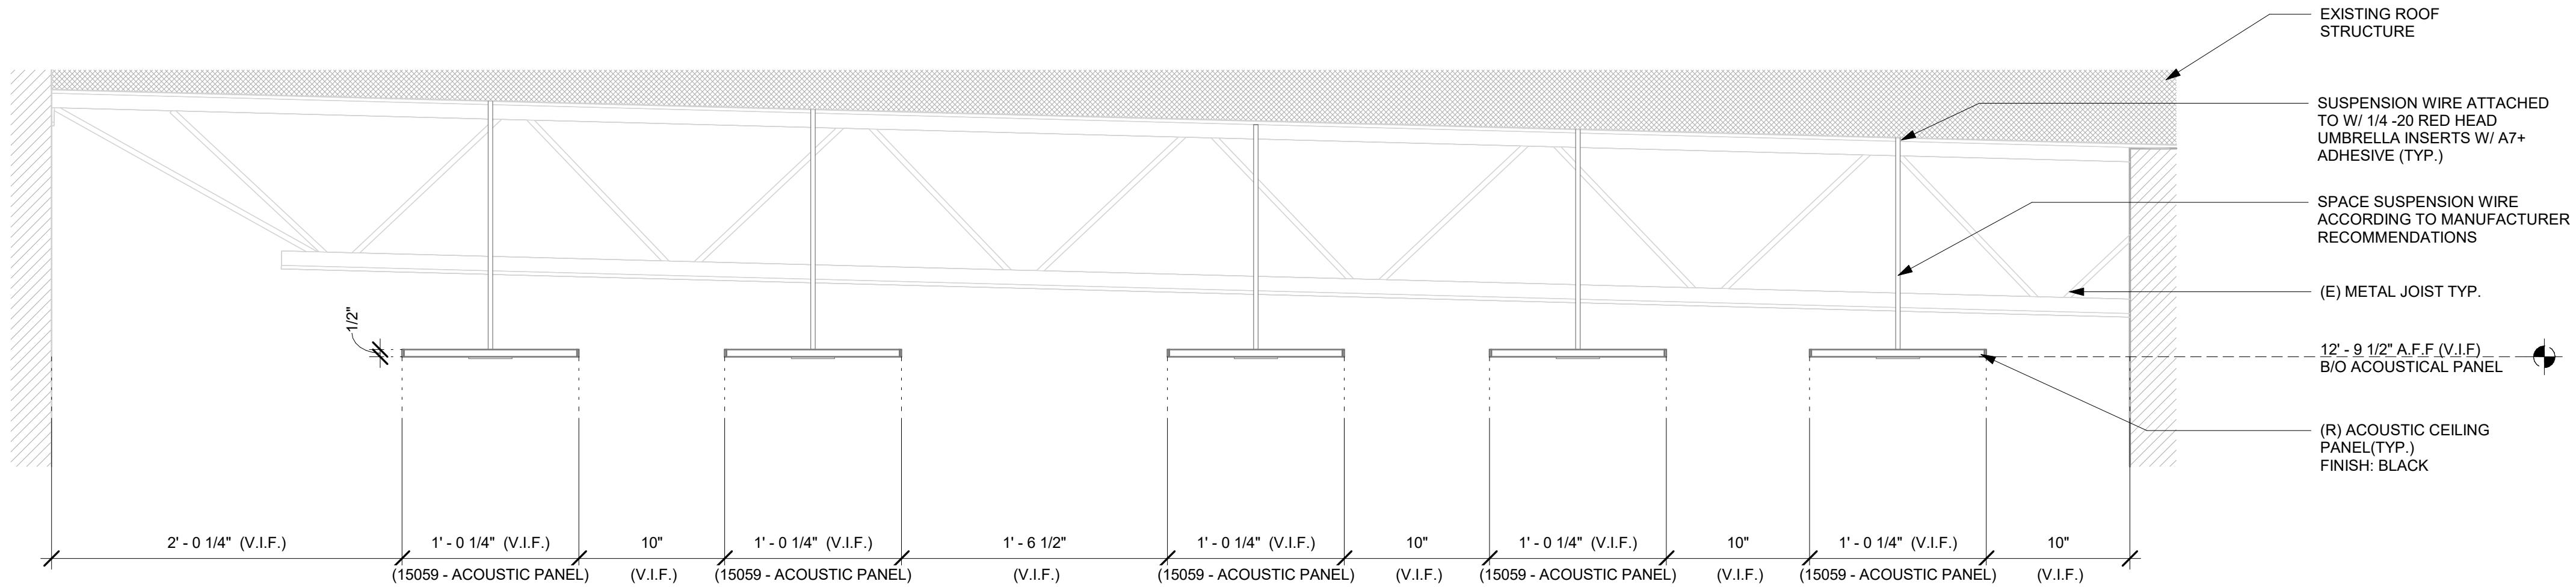

2 ACOUSTICAL PANELS - SECTION

Scale: 1 1/2" = 1'-0"

FOR CONSTRUCTION



© 2023 STARBUCKS COFFEE COMPANY

STARBUCKS®
2401 UTAH AVENUE SOUTH
SEATTLE, WASHINGTON 98134
(206) 318-1575

THESE DRAWINGS AND THE PROJECT MANUAL ARE CONFIDENTIAL AND SHALL REMAIN THE SOLE PROPERTY OF STARBUCKS CORPORATION, WHICH IS THE OWNER OF THE COPYRIGHT IN THIS WORK. THEY SHALL NOT BE REPRODUCED IN WHOLE OR IN PART, SHARED WITH THIRD PARTIES OR USED IN ANY MANNER ON OTHER PROJECTS OR EXTENSIONS TO THIS PROJECT WITHOUT THE PRIOR WRITTEN CONSENT OF STARBUCKS CORPORATION. THESE DRAWINGS AND SPECIFICATIONS ARE INTENDED TO EXPRESS INTENT FOR A PROTOTYPICAL STARBUCKS STORE (WHICH IS SUBJECT TO CHANGE AT ANYTIME) AND DO NOT REFLECT ACTUAL SITE CONDITIONS. NEITHER PARTY SHALL HAVE ANY OBLIGATION NOR LIABILITY TO THE OTHER (EXCEPT STATED ABOVE) UNTIL A WRITTEN AGREEMENT IS FULLY EXECUTED BY BOTH PARTIES.

STARBUCKS TEMPLATE VERSION: i2023.10.23

Design Forum Architects Inc.

2050 Byers Rd
Miami, FL 33134
Tel: (844) 804-7700

Donald J. Rehman
Architect In Charge
License: AR0017303



2230 PARK AVE, STE. 100, CINCINNATI, OH 45206
513.457.7131 - WWW.MARQUEENG.COM

PROJECT NAME:
S SEMORAN BLVD & LEE VISTA BLVD

PROJECT ADDRESS:
**6605 S SEMORAN BLVD
ORLANDO, FL 32822**

STORE #: 9875
PROJECT #: 25630-101
ISSUE DATE: 03/04/2024
DESIGN MANAGER: MARTIN PEREZ
PRODUCTION DESIGNER: ANDY MCLOUD
CHECKED BY: DONALD REHMAN


Revision Schedule			
Rev	Date	By	Description

SHEET TITLE:
ACOUSTICAL PANEL

SCALE: AS SHOWN

SHEET NUMBER:
I-518

NOTE:
SHOP DRAWINGS TO BE APPROVED BY
SB DESIGNER PRIOR TO FABRICATION.

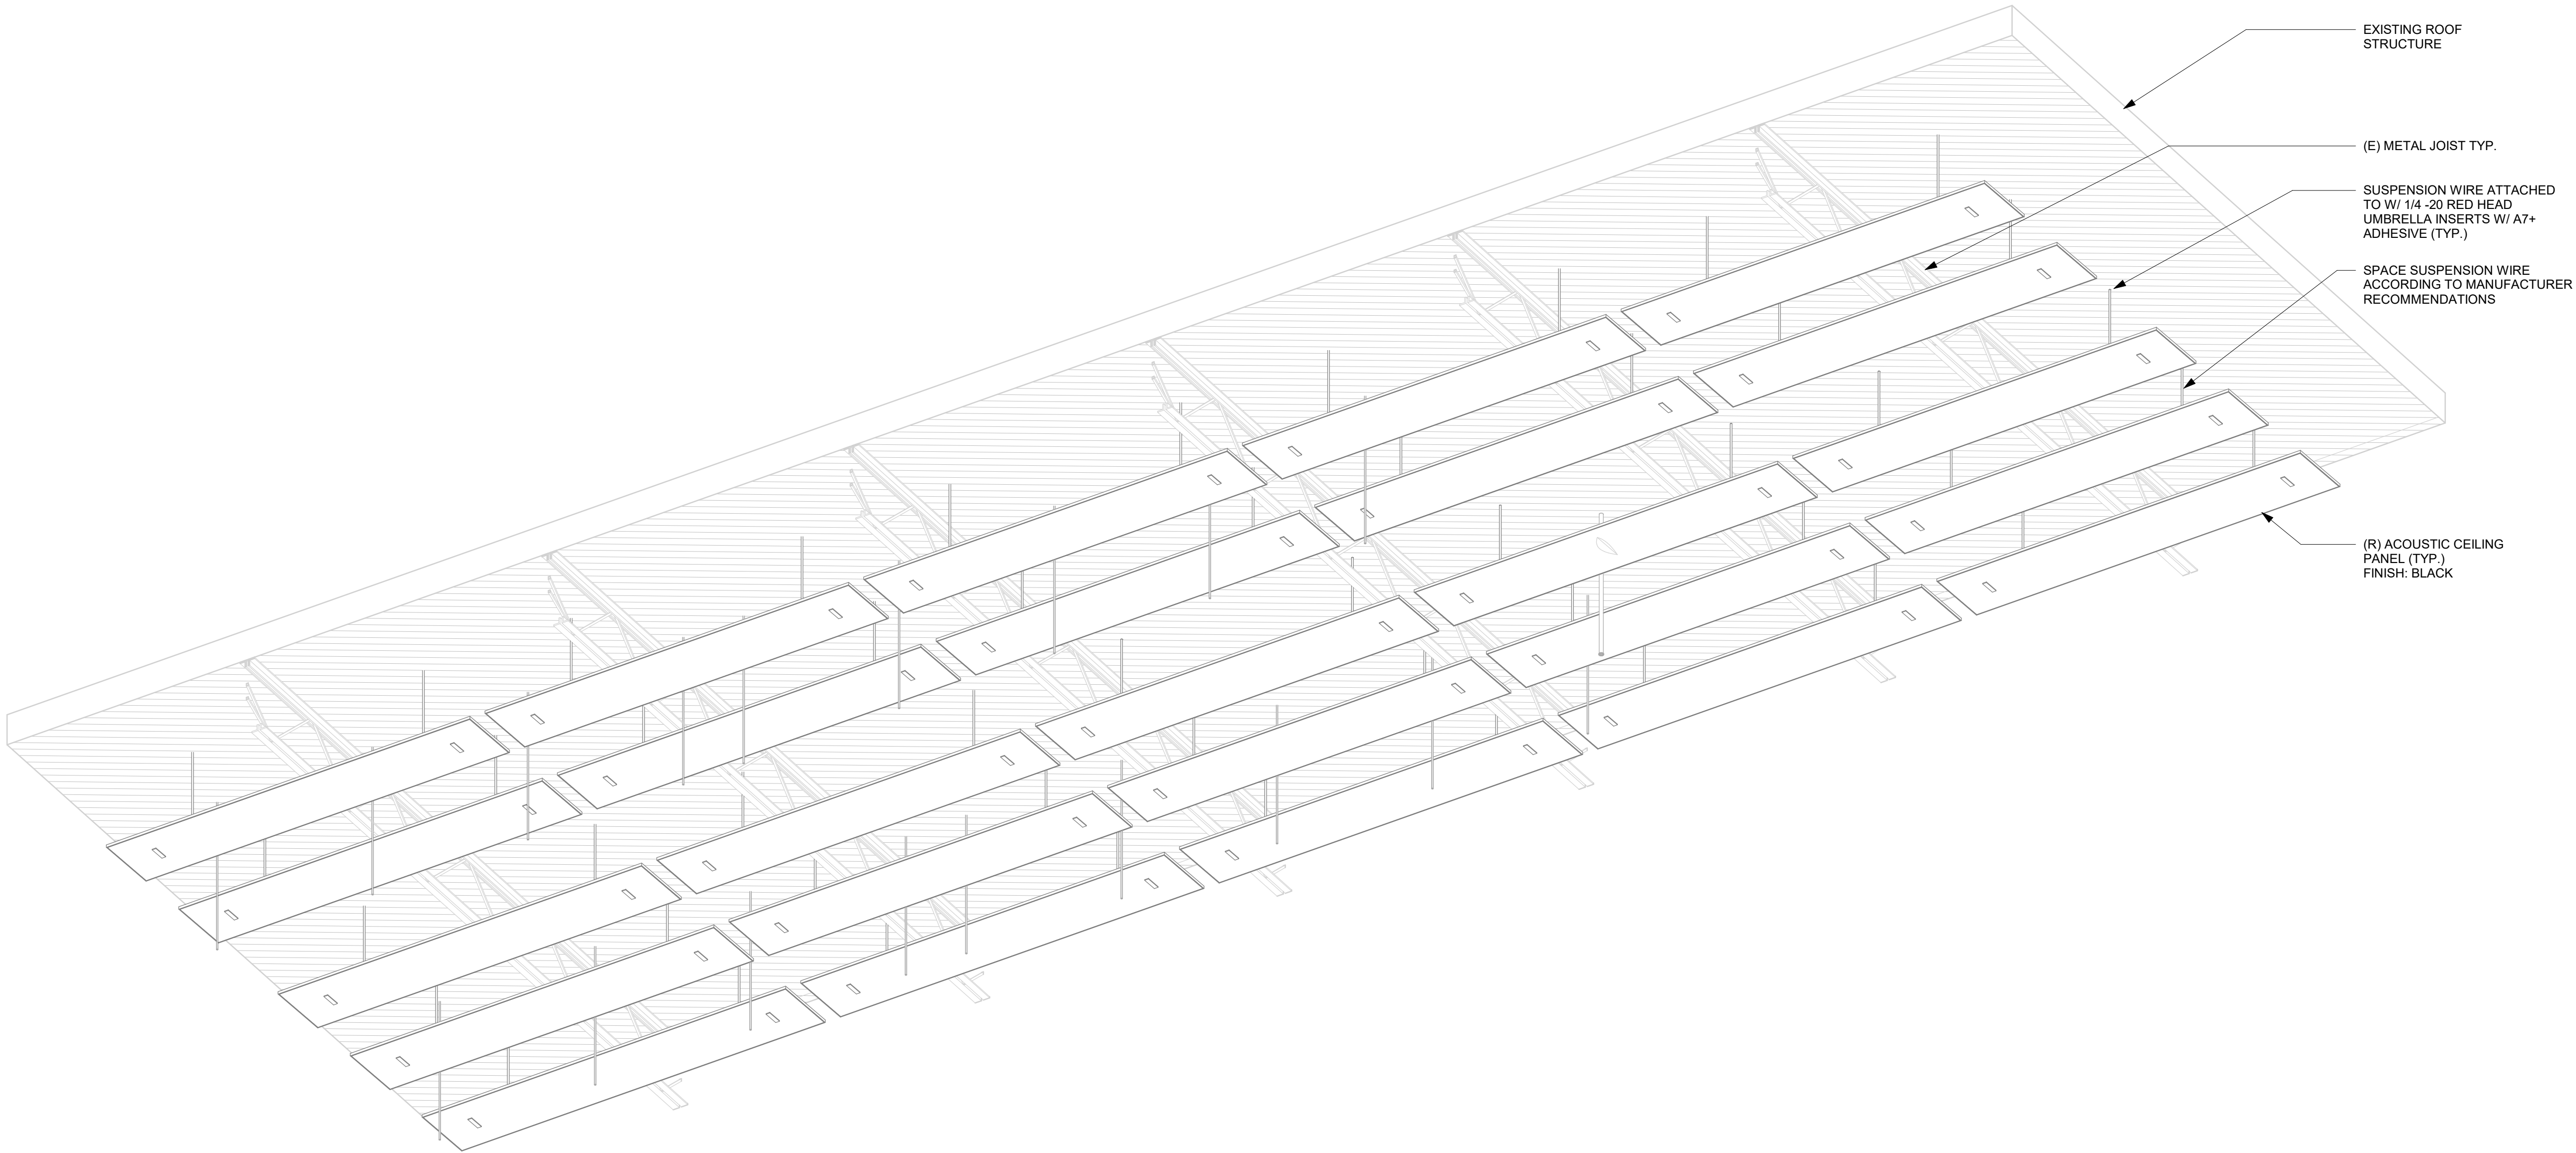

1 ACOUSTICAL PANELS - 3D VIEW

Scale



© 2023 STARBUCKS COFFEE COMPANY

STARBUCKS®
2401 UTAH AVENUE SOUTH
SEATTLE, WASHINGTON 98134
(206) 318-1575


THESE DRAWINGS AND THE PROJECT MANUAL ARE CONFIDENTIAL AND SHALL REMAIN THE SOLE PROPERTY OF STARBUCKS CORPORATION, WHICH IS THE OWNER OF THE COPYRIGHT IN THIS WORK. THEY SHALL NOT BE REPRODUCED IN WHOLE OR IN PART, SHARED WITH THIRD PARTIES OR USED IN ANY MANNER ON OTHER PROJECTS OR EXTENSIONS TO THIS PROJECT WITHOUT THE PRIOR WRITTEN CONSENT OF STARBUCKS CORPORATION. THESE DRAWINGS AND SPECIFICATIONS ARE INTENDED TO EXPRESS INTENT FOR A PROTOTYPICAL STARBUCKS STORE (WHICH IS SUBJECT TO CHANGE AT ANYTIME) AND DO NOT REFLECT ACTUAL SITE CONDITIONS. NEITHER PARTY SHALL HAVE ANY OBLIGATION NOR LIABILITY TO THE OTHER (EXCEPT STATED ABOVE) UNTIL A WRITTEN AGREEMENT IS FULLY EXECUTED BY BOTH PARTIES.

STARBUCKS TEMPLATE VERSION: i2023.10.23

**Design Forum
Architects Inc.**

2050 Byers Rd
Miamisburg, OH 45342
Tel: (844) 804-7700

Donald J. Reihman
Architect In Charge
License: AR0017303

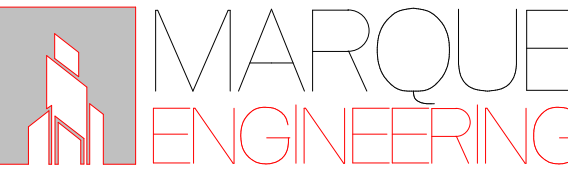

2230 PARK AVE, STE. 100, CINCINNATI, OH 45206
513.457.7131 - WWW.MARQUEENG.COM

FOR CONSTRUCTION

PROJECT NAME:
**S SEMORAN BLVD &
LEE VISTA BLVD**

PROJECT ADDRESS:
**6605 S SEMORAN BLVD
ORLANDO, FL 32822**

STORE #: 9875
PROJECT #: 25630-101
ISSUE DATE: 03/04/2024
DESIGN MANAGER: MARTIN PEREZ
PRODUCTION DESIGNER: ANDY MCLOUD
CHECKED BY: DONALD RETHMAN

Revision Schedule				
Rev	Date	By	Description	

SHEET TITLE:
ACOUSTICAL PANEL

SCALE: AS SHOWN

SHEET NUMBER:
I-519

DATA DEVICE SCHEDULE - "A"					
DESIGN ID	COUNT	DESCRIPTION	FURN. BY	INST. BY	COMMENTS
AUDIO VISUAL					
10005	1	MUSIC SYSTEM	SB	GC	
10013	2	DT QUEUE CAMERA	SB	GC	
19339	1	AMPLIFIER - 40W	SB	GC	
19493	3	SPEAKER PENDANT MOUNTED - BLACK	SB	GC	
DATA					
10002	1	COMPUTER MANAGER WORKSTATION	SB	GC	
10007	1	PRINTER MANAGER WORKSTATION	SB	GC	
18744	1	EQUIPMENT RACK WITH LOCK - 24IN 610MM	SB	GC	
20294	1	IOT MODULE	SB	GC	
GRAPHICS - INTERIOR MENU					
22970	4	MENU BOARD - DIGITAL DISPLAY - 44X25.25IN 1121X644MM - BLACK	SB	GC	
22971	3	MENU BOARD - DIGITAL MENU BOARD MOUNTING BRACKET SINGLE SCREEN - BLACK	SB	GC	
23021	1	MENU BOARD - ORDER STATUS BOARD MOUNTING BRACKET - BLACK	SB	GC	
POINT OF SALE					
10022	1	MONEY COUNTER	SB	GC	

WALL BASE SCHEDULE - "B"					
DESIGN ID	LENGTH	DESCRIPTION	FURN. BY	INST. BY	COMMENTS
BASE TRIM					
X9100	34' - 5"	FLOOR FRAME 16 GA 2B SS AROUND WALK-OFF MAT RECESSED	SB	GC	SOURCED FROM VD; SEE DETAIL: 1/I-501
X9102	51' - 2 1/2"	SCHLUTER BASE - DILEX - AHK TRIM	GC	GC	SCHLUTER SYSTEM WILL REQUIRE USE OF 90 DEGREE CORNER PIECE TO ACCOMODATE FOR RADIUS TRIM PROFILE. FINISH: DARK ANTHRACITE - SATIN ANODIZED ALUMINUM
METAL BASE					
X9101	23' - 6 3/4"	METAL BASE - 6IN 150MM - BLACK - MT0028	GC	GC	PROVIDED BY CASEWORK VENDOR
TILE BASE					
18740	54' - 7 3/4"	TILE BASE - PLAZA NOVA - BLACK SHADOW - 6X12IN 150X300MM	SB	GC	GROUT: MAPEI - 10 BLACK, OR EQUAL
19795	234' - 3 1/4"	POLYVINYL TILE BASE SHEET - ECO-GRIP - PEWTER - 6X96IN 150X2438MM	GC	GC	

CASEWORK SCHEDULE - "C"					
DESIGN ID	COUNT	DESCRIPTION	FURN. BY	INST. BY	COMMENTS
CABINET					
19281	2	CABINET - ESPRESSO ICE BIN STAINLESS - 20IN 510MM	SB	GC	
21890	27	CABINET - SIDE PANEL	SB	GC	
21891	9	CABINET - BOTTOM SHELF - 15IN 380MM	SB	GC	
21892	7	CABINET - BACK PANEL - 15IN 380MM	SB	GC	
21893	4	CABINET - ADJUSTABLE SHELF - 15IN 380MM	SB	GC	
21894	4	CABINET - DOOR - 15IN 380MM	SB	GC	FINISH: CP0024
21895	5	CABINET - DOOR TRASH - 15IN 380MM	SB	GC	FINISH: CP0024
21896	2	CABINET - DRAWER - 15IN 380MM	SB	GC	FINISH: CP0024
21898	1	CABINET - BOTTOM SHELF - 18IN 455MM	SB	GC	
21899	1	CABINET - BACK PANEL - 18IN 455MM	SB	GC	
21901	1	CABINET - DOOR - 18IN 455MM	SB	GC	FINISH: CP0024
21902	4	CABINET - BOTTOM SHELF - 30IN 760MM	SB	GC	
21903	1	CABINET - BACK PANEL - 30IN 760MM	SB	GC	
21904	7	CABINET - ADJUSTABLE SHELF - 30IN 760MM	SB	GC	
21905	1	CABINET - DOOR - 30IN 760MM	SB	GC	
21906	1	CABINET - END CAP FRONTBAR	SB	GC	FINISH: CP0024
21907	3	CABINET - END CAP BACKBAR	SB	GC	FINISH: CP0024
21908	1	CABINET - FILLER PANEL - VARIABLE LENGTH	SB	GC	FINISH: PLX001
21909	1	CABINET - DT POS UPPER CUBBY - 32IN 815MM	SB	GC	FINISH: PLX001
21910	1	CABINET - FRENCH CLEAT - VARIABLE LENGTH	SB	GC	LENGTH REQUIRED, (V.I.F) (1) 0' - 3 3/4" (1) 2' - 6 1/2"
21912	3	CABINET - BACK PANEL FOR POS - 30IN 760MM	SB	GC	
21913	2	CABINET - EQUIPMENT MOUNTING PANEL	SB	GC	
22749	1	CABINET - ESPRESSO PUMP MOUNT PANEL	SB	GC	
22986	2	CABINET - DELIVERY DRAWER - 15IN 380MM	SB	GC	
23425	2	CABINET - WRM DOOR LOWERED COUNTER - 15IN 380MM	SB	GC	
CABINETS					
23711	1	CABINET - CBE UPPER CASEWORK IN-LINE - RF - 82IN	SB	GC	FINISH: PLX001
CAFE					
20352	1	FREESTANDING INLINE 2 UNIT SHORT - 72IN 1830MM - WALNUT WD0077	SB	GC	
23963	1	WASTE AND RECYCLE STATION THREE DROP - WARM BROWN WOODGRAIN AND WHITE PL0030 CP0002	SB	GC	
COUNTERTOP					
21928	1	COUNTERTOP - END CAP BACKBAR	SB	GC	FINISH: CP0056
22354	1	COUNTERTOP - ESPRESSO SHROUD - 141IN 3580MM	SB	GC	FINISH: CP0056
22395	1	COUNTERTOP - HAND SINK LOW SPLASH - 15IN 380MM	SB	GC	
X5001	1	CUSTOM COUNTERTOP - END CAP FRONTBAR	SB	GC	FINISH: CP0056; SEE DETAIL: 2/I-509; SIM. DID# 21923; CUSTOM DUE TO 4" FRONT EDGE
X5002	1	CUSTOM COUNTERTOP - POS - 84IN 2135MM	SB	GC	FINISH: CP0056; SEE DETAIL: 2/I-509; SIM. DID# 22361; CUSTOM DUE TO 4" FRONT EDGE
X5003	1	CUSTOM COUNTERTOP - ESPRESSO FRONTBAR - LF - 141IN 3580MM	SB	GC	FINISH: CP0056; SEE DETAIL: 2/I-509; SIM. DID# 22352; CUSTOM DUE TO 4" FRONT EDGE
X5004	2	CUSTOM COUNTERTOP - FILLER FRONTBAR - VARIABLE LENGTH	SB	GC	FINISH: CP0056; SEE DETAIL: 2/I-509; SIM. DID# 21918; CUSTOM DUE TO 4" FRONT EDGE; LENGTH REQUIRED: (V.I.F) (1) 1' - 0 1/2" (1) 0' - 11 1/2"
X5005	1	CUSTOM COUNTERTOP - FRONTBAR - 15IN 380MM	SB	GC	FINISH: CP0056; SEE DETAIL: 2/I-509; SIM. DID# 21920; CUSTOM DUE TO 4" FRONT EDGE
X5006	1	CUSTOM COUNTERTOP - FRONTBAR - 30IN 760MM	SB	GC	FINISH: CP0056; SEE DETAIL: 2/I-509; SIM. DID# 21922; CUSTOM DUE TO 4" FRONT EDGE
X5010	1	CUSTOM COUNTERTOP - END CAP BACKBAR	SB	GC	FINISH: CP0056; SIM. DID# 21928; CUSTOM DUE TO 8IN INTEGRAL BACKSPLASH

CASEWORK SCHEDULE - "C"					
DESIGN ID	COUNT	DESCRIPTION	FURN. BY	INST. BY	COMMENTS
X5011	1	COUNTERTOP - BREW - LF - 90IN 2285MM	SB	GC	FINISH: CP0056; SIM. DID# 22328; CUSTOM DUE TO 8IN INTEGRAL BACKSPLASH
X5012	1	CUSTOM COUNTERTOP - 2IN TALL BACKSPLASH - VARIABLE LENGTH	SB	GC	FINISH: CP0056; SEE DETAIL: 4/I-510; LENGTH REQUIRED: (V.I.F) (1) 2' - 6 1/2"
X5016	1	CUSTOM COUNTERTOP - WARMING WITH RACK - RF - 110IN 2795MM	SB	GC	FINISH: CP0056; SIM. DID # 22385; CUSTOM DUE TO 8IN INTEGRAL BACKSPLASH
X5017	1	CUSTOM COUNTERTOP - WRM RF - 78IN 1980MM	SB	GC	FINISH: CP0056; SIM. DID #23430; CUSTOM DUE TO 8IN INTEGRAL BACKSPLASH
X5018	3	CUSTOM COUNTERTOP - 8IN TALL BACKSPLASH - VARIABLE LENGTH	SB	GC	FINISH: CP0056; SEE DETAIL: 10/I-510; LENGTH REQUIRED: (V.I.F) (3) 2' - 6 1/2"
X5034	4	CUSTOM COUNTERTOP - FILLER BACKBAR - VARIABLE LENGTH	SB	GC	FINISH: CP0056; SIM. DID # 21919; CUSTOM DUE TO 8IN INTEGRAL BACKSPLASH; LENGTH REQUIRED: (V.I.F) (3) 0' - 3/4" (1) 0' - 1 1/4"
X5035	1	CUSTOM COUNTERTOP - DT POS - LF - 67IN 1700MM	SB	GC	FINISH: CP0056; SEE DETAIL: 6/I-511; W/ 8IN INTE-GRAL BACKSPLASH; SEE DETAIL: 6/I-511
X5036	1	CUSTOM COUNTERTOP - CBE IN-LINE RF - 139IN 3530MM	SB	GC	FINISH: CP0056; SIM. DID# 23403; CUSTOM DUE TO 8IN INTEGRAL BACKSPLASH
DIEWALL					
21885	11	DIEWALL - FRAMING - VARIABLE LENGTH	SB	GC	
21886	5	DIEWALL - BASE - VARIABLE LENGTH	SB	GC	
21887	5	DIEWALL - SUBSTRATE PANEL - VARIABLE LENGTH	SB	GC	
21888	40	DIEWALL - SUPPORT LEG	SB	GC	
23439	1	DIEWALL - WRM STRUCTURE LOWERED COUNTER	SB	GC	
OTHER					
10829	8	CORNER GUARD - .75IN 19MM	SB	GC	LOCATED @ BOH; PROVIDED BY CASEWORK VENDOR
11155	2	ESPRESSO MACHINE PUMP MOUNT - 10X10IN 255X255MM	SB	GC	
21914	8	FRIDGE STOP BRACKET SET	SB	GC	
X5013	1	CUSTOM METAL ANGLE TRIM AT SOFFIT	SB	GC	FINISH: MT0028; SEE DETAIL: 7/A-503; PROVIDED BY CASEWORK VENDOR
X5014	1	CUSTOM CORIAN SILL TOP	SB	GC	FINISH: CP0056; SEE DETAIL: 4/I-511; PROVIDED BY CASEWORK VENDOR
X5019	1	CUSTOM METAL TRIM AT DT HEADER	SB	GC	FINISH: MT0028; SEE DETAIL: 2/I-107; PROVIDED BY CASEWORK VENDOR
X5020	1	FRY REGLET "Y" TRIM AT WOOD CLADDING EDGE	SB	GC	FINISH: BLACK; SEE DETAIL: 19/I-502; LOCATED @ CAFE; PROVIDED BY CASEWORK VENDOR
X5021	1	CUSTOM METAL TRIM AT BACKBAR	SB	GC	FINISH: MT0028; SEE DETAIL: 15/I-502; PROVIDED BY CASEWORK VENDOR
X5022	1	CUSTOM METAL TRIM AT WORKROOM	SB	GC	FINISH: MT0028; SEE DETAIL: 5/A-502; PROVIDED BY CASEWORK VENDOR
X5023	1	CUSTOM WOOD TRIM FRAME AT RR VESTIBULE	SB	GC	FINISH: WD0077; SEE DETAIL: 6/A-502; PROVIDED BY CASEWORK VENDOR
X5024	1	CUSTOM WOOD CAP AT SOFFIT	SB	GC	FINISH: WD0077; SEE DETAIL: 2/A-503; PROVIDED BY CASEWORK VENDOR
X5025	1	CUSTOM OSB WOOD FRAME	SB	GC	FINISH: WD0077; SEE DETAIL: 1/I-513; PROVIDED BY CASEWORK VENDOR
X5026	1	CUSTOM WOOD CAP	SB	GC	FINISH: WD0077; SEE DETAIL: 3/I-107; PROVIDED BY CASEWORK VENDOR
X5027	4	CUSTOM 1IN X 1IN WOOD SLAT - 82IN HEIGHT	SB	GC	FINISH: WD0077; SEE DETAIL: 1/I-515; PROVIDED BY CASEWORK VENDOR
X5028	16	CUSTOM 1IN X 1IN WOOD SLAT - 9IN HEIGHT	SB	GC	FINISH: WD0077; SEE DETAIL: 1/I-515; PROVIDED BY CASEWORK VENDOR
X5029	16	CUSTOM 1IN X 1IN WOOD SLAT - 22IN HEIGHT	SB	GC	FINISH: WD0077; SEE DETAIL: 1/I-515; PROVIDED BY CASEWORK VENDOR
X5030	8	CUSTOM 1IN X 1IN WOOD SLAT - 110IN HEIGHT	SB	GC	FINISH: WD0077; SEE DETAIL: 1/I-515; PROVIDED BY CASEWORK VENDOR
X5032	3	CUSTOM WOOD TRIM FRAME AT STOREFRONT	SB	GC	FINISH: WD0077; SEE DETAIL: 1/I-514; PROVIDED BY CASEWORK VENDOR
X5033	1	CUSTOM WOOD TRIM FRAME AT STOREFRONT ENTRY	SB	GC	FINISH: WD0077; SEE DETAIL: 1/I-514; PROVIDED BY CASEWORK VENDOR
X5038	1	CUSTOM METAL TRIM AT BACKBAR	SB	GC	FINISH: MT0028; SEE DETAIL: 10/I-502; PROVIDED BY CASEWORK VENDOR
PANEL					
21933	5	FINISH PANEL - VARIABLE LENGTH	SB	GC	FINISH: WD0077 (MAD303-V)

GRAPHICS AND ARTWORK SCHEDULE - "G"					
DESIGN ID	COUNT	DESCRIPTION	FURN. BY	INST. BY	COMMENTS
GRAPHICS - ARTWORK					
16995	1	SBXART - 16995, MICHAEL HANSON - COLOMBIA 22 - BW - FRAME WITH MAT- ART SIZE: 13" W X 22" H; MAT BORDER: 4" X 4"; OVERALL SIZE: 21" W X 30" H - PAPER - 1; FRAME: 1A - 613674 EBONIZED WALNUT	SB	GC	SEE ELEVATION: 1/I-202
17065	1	SBXART - 17065, MICHAEL HANSON - PANAMA 18 - BW - FRAME WITH MAT- ART SIZE: 13" W X 22" H; MAT BORDER: 4" X 4"; OVERALL SIZE: 21" W X 30" H - PAPER - 1; FRAME: 1A - 613674 EBONIZED WALNUT	SB	GC	SEE ELEVATION: 1/I-202
23315	1	SBXART - 23315, RYAN R BROWNE - HACIENDA ABSTRACTION 4 - WRAPPED CANVAS IN FLOAT FRAME - ART SIZE: 64"W X 43" H - REVEAL 1/4" - PRINT TO EDGES - PRINT EDGES BLACK -OVERALL SIZE: 65"W X 44" H - CANVAS 1 - FRAME 3A - 623674 EBONIZED WALNUT	SB	GC	SEE ELEVATION: 1/I-201
X1006	1	COMMUNITY BOARD WITH 3" FRAME; OVERALL SIZE: 48" W X 36" H	SB	GC	SEE ELEVATION: 4/I-204
GRAPHICS - OTHER					
X1005	2	3M FASARA GLASS FINISHES FROST/MATTE RE1SIAR, SILVER, 50 IN X 98.4 FT, 1 ROLL/CASE	SB	GC	BLOCK-OUT FILM APPLIED TO EXTERIOR OF WINDOW SIZE REQUIRED: (V.I.F.) (1) 3' - 1" W X 2' - 8" H (1) 3' - 1" W X 6' - 7" H

SPECIALTY EQUIPMENT SCHEDULE - "E"					
DESIGN ID	COUNT	DESCRIPTION	FURN. BY	INST. BY	COMMENTS
COOLING					
10267	3	FRIDGE UNDERCOUNTER 1 DOOR - 27IN 685MM	SB	GC	
20011	1	FRIDGE NITRO 2 TAP JT NITCOM RH	SB	GC	KIT INCLUDES UNDERCOUNTER FRIDGE, FONT, TRAY, AND TUBING
EQUIPMENT					
17564	1	BLENDER PITCHER RINSER WITH SENSOR	SB	GC	
21679	1	NITROGEN GENERATOR ELEMENT COMPACT	SB	GC	
22885	1	BREWER CLOVER VERTICA DOUBLE	SB	GC	
23380	1	BREWER CLOVER VERTICA INSTALL KIT	SB	GC	
23381	1	BREWER CLOVER VERTICA CORD	SB	GC	
23393	3	EQUIPMENT - CBE MILK DISPENSE BRACKET SLIDE	SB	GC	
23419	3	MILK DISPENSER	SB	GC	
23443	1	OVEN COMBI	SB	GC	
FOOD CASE					
21215	1	FOOD CASE - ZEPHYR - 28IN 710MM	SB	GC	
23440	1	FOOD CASE - WARMING WALL - 1000 SQUARE	SB	GC	
ICE					
19278	2	ICE - BIN DROP IN 45LB 20KG HORIZONTAL	SB	GC	
23421	1	ICE - NUGGET ICE DISPENSER - SINGLE ICE MACHINE	SB	GC	
23423	1	ICE - NUGGET ICE DIVERTER	SB	GC	
23424	1	ICE - NUGGET ICE DIVERTER CONTROL PANEL	SB	GC	
OTHER					
10091	1	CUP DISPENSER TALL HOT VERTICAL	SB	GC	
10384	2	DIAPER CHANGING STATION HORIZONTAL	SB	GC	
10396	1	CUP DISPENSER SHORT HOT VERTICAL	SB	GC	
10791	2	CUP DISPENSER GRANDE VENTI COLD VERTICAL	SB	GC	
10855	2	CUP DISPENSER GRANDE VENTI HOT VERTICAL	SB	GC	
10858	1	CUP DISPENSER TALL COLD VERTICAL	SB	GC	
10947	1	SOAP DISPENSER WALL MOUNTED	SB	GC	
10992	1	PAPER TOWEL DISPENSER HALF SIZE - TRANSLUCENT GRAY	SB	GC	
13330	1	MOBILE CUP DISPENSER CADDY	SB	GC	
13584	1	CUP DISPENSER TRENTA COLD VERTICAL	SB	GC	
20403	6	KEG - 3GAL	SB	GC	
21554	8	POWER EXTENSION DUAL RECEPTACLE AND USB SURFACE MOUNT - BLACK	SB	GC	
22827	1	NITRO 2 TAP HANDLE WITH BADGE AND MOUNT KIT	SB	GC	JOE TAP, FOR USE AT BACKBAR NITRO FONT
23420	2	REFRESHER DISPENSE SMALL	SB	GC	
STORAGE					
10222	2	WIRE SHELF GRID AT SINK	SB	GC	
21934	1	PASTRY TRAY RACK UNDERCOUNTER - 30IN 760MM	SB	GC	
23445	3	PASTRY COOLING RACK WALL MOUNTED	SB	GC	
TK0048	2	5 COMP LOCKER - 15IN 380MM	SB	GC	


DOOR SCHEDULE - "D"					
DESIGN ID	COUNT	DESCRIPTION	FURN. BY	INST. BY	COMMENTS
DOOR					
10190	2	DOOR - SINGLE FLUSH - 36IN - TYPE E	SB	GC	DOOR FINISH: STAIN TO MATCH WD0035; FRAME FINISH: SW8991-SG; KICKPLATE : STAINLESS STEEL LOCKNET; SEE HARDWARE SET #6, DOOR TYPE E
X2001	1	DOOR - STOREFRONT METAL FRAME SINGLE - TYPE B	GC	GC	LOCKNET; DOOR FINISH: 1/4" TEMPERED GLASS - INSIDE GLAZING - IMPACT RESISTANT; FRAME FINISH: CLEAR ANODIZED ALUMINIUM; SEE HARDWARE SET # 2-A, DOOR TYPE B

RESPONSIBILITY LEGEND

FURN. BY	INST. BY
GC - FURNISHED BY GENERAL CONTRACTOR	GC - INSTALLED BY GENERAL CONTRACTOR
SB - FURNISHED BY STARBUCKS	SB - INSTALLED BY STARBUCKS
VD - FURNISHED BY VENDOR	VD - INSTALLED BY VENDOR

NOTE:
ALL RESPONSIBILITIES TO BE CONFIRMED WITH STARBUCKS CONSTRUCTION MANAGER PRIOR TO ORDERING / CONSTRUCTION.

FOR CONSTRUCTION



© 2023 STARBUCKS COFFEE COMPANY

STARBUCKS®
2401 UTAH AVENUE SOUTH
SEATTLE, WASHINGTON 98134
(206) 318-1575

THESE DRAWINGS AND THE PROJECT MANUAL ARE CONFIDENTIAL AND SHALL REMAIN THE SOLE PROPERTY OF STARBUCKS CORPORATION, WHICH IS THE OWNER OF THE COPYRIGHT IN THIS WORK. THEY SHALL NOT BE REPRODUCED IN WHOLE OR IN PART, SHARED WITH THIRD PARTIES OR USED IN ANY MANNER ON OTHER PROJECTS OR EXTENSIONS TO THIS PROJECT WITHOUT THE PRIOR WRITTEN CONSENT OF STARBUCKS CORPORATION. THESE DRAWINGS AND SPECIFICATIONS ARE INTENDED TO EXPRESS DESIGN INTENT FOR A PROTOTYPICAL STARBUCKS STORE (WHICH IS SUBJECT TO CHANGE AT ANY TIME) AND DO NOT REFLECT ACTUAL SITE CONDITIONS. NEITHER PARTY SHALL HAVE ANY OBLIGATION NOR LIABILITY TO THE OTHER (EXCEPT STATED ABOVE) UNTIL A WRITTEN AGREEMENT IS FULLY EXECUTED BY BOTH PARTIES.

STARBUCKS TEMPLATE VERSION: i2023.10.23

Design Forum Architects Inc.

2050 Byers Rd
Miamiburg, OH 45342
Tel: (844) 804-7700

Donald J. Rehmman
Architect In Charge
License: AR0017303

MARQUE ENGINEERING

2230 PARK AVE, STE. 100, CINCINNATI, OH 45206
513.457.7131 - WWW.MARQUEENG.COM

PROJECT NAME:
<

FURNITURE SCHEDULE - "F"						
DESIGN ID	COUNT	DESCRIPTION	FURN. BY	INST. BY	COMMENTS	
BANQUETTE						
22501	4	BANQUETTE - SAN JUAN - 6FT 183CM - WALNUT WD0077	SB	GC	FINISH: WD0077; SEE DETAIL: 1/I-512	
23017	4	BANQUETTE - SAN JUAN CUSHION SEAT AND BACK C EDGE - 6FT 183CM - CAMEL BROWN NATURAL F0008	SB	GC	FINISH: F-0008; SEE DETAIL: 1/I-512; LENGTH REQUIRED: (1) 6' - 0"	
CHAIR						
21373	6	CHAIR - CAFE PEGGY UPHOLSTERED - WALNUT AND CAMEL BROWN NATURAL WD0077 F0008	SB	GC		
23138	6	CHAIR - CAFE ASHER UPHOLSTERED BACK - WALNUT AND BLACK NATURAL WD0077 F0046	SB	GC		
23446	20	CHAIR - CAFE HANS 2.0 - BLACK	SB	GC		
23448	4	CHAIR - LOUNGE HANS 2.0 - BLACK	SB	GC		
TK0077	1	CHAIR - MANAGERS WORKSTATION	SB	GC	STEELCASE SERIES ONE ARMLESS	
DESK						
TK0053	1	DESK - MANAGERS WORKSTATION SHELVES - 48IN 1220MM	SB	GC		
TK0076	1	DESK - MANAGERS WORKSTATION - 48X24X27IN 1220X610X685MM	SB	GC		
MIRROR						
14350	2	MIRROR - RESTROOM ANGLED- 18X36IN 455X915MM	SB	GC	INSTALLED AT CENTER OF SINK, MIN. 40" A.F.F. TO B.O. MIRROR.	
TK0050	1	MIRROR - BOH - 16X51IN 405X1295MM	SB	GC	SEE DETAIL: 4/I-513	
OTHER						
TK0051	1	COAT HOOK STRIP - 30IN 760MM	SB	GC	BLACK FINISH	
STORAGE						
TK0078	1	FILE MOBILE PEDESTAL WITH CUSHION AND LOCK	SB	GC		
TK0079	1	MANAGERS DESK CART - 24X20IN 610X510MM	SB	GC		
TABLE						
17340	10	TABLE - CAFE METAL PEDESTAL BASE SQUARE - 24IN 610MM - BLACK MT0028	SB	GC		
17341	2	TABLE - ACCESSIBLE METAL WITH TAPERED LEGS - 36X24IN 915X610MM - BLACK MT0028	SB	GC		
21449	7	TABLE - BASE CAFE HEIGHT BOTTLE - FLAT BLACK MT0028	SB	GC		
21453	2	TABLE - BASE ACCESSIBLE BOTTLE - FLAT BLACK MT0028	SB	GC		
21799	2	TABLE - TOP ACCESSIBLE ROUND EDGE OBLONG - 48X24IN 1220X610MM - WALNUT WD0077	SB	GC		
21841	4	TABLE - TOP ROUND EDGE ROUND - 24IN 610MM - WALNUT WD0077	SB	GC		
21847	3	TABLE - TOP ROUND EDGE SQUARE - 24IN 610MM - WALNUT WD0077	SB	GC		
WINDOW TREATMENT						
22486	9	ROLLER SHADE - DARK BROWN - 5PC OPEN	SB	GC	LENGTH REQUIRED (V.I.F.): (1) 3' - 0" (1) 3' - 2" (1) 3' - 1" (4) 4' - 4" (1) 2' - 8" (1) 6' - 0" EXTEND TO TOP OF BOTTOM MULLION	

LIGHTING FIXTURE SCHEDULE - "L"						
DESIGN ID	COUNT	DESCRIPTION	FURN. BY	INST. BY	BULB	COMMENTS
EXIT						
19047	4	LED EXIT SIGN WITH EMERGENCY LIGHT - BLACK AND GREEN	SB	GC	INTEGRATED LED	
19057	2	LED EMERGENCY LIGHT DOUBLE - BLACK	SB	GC	INTEGRATED LED	
PENDANT						
X7002	1	PENDANT - MATTEO ASTRO SKU: C80701BKOP / COLOR: BLACK	SB	GC	(1) 25W E12 BASE	
RECESSED CAN						
21774	20	CAN - LED ADJUSTABLE RECESSED - 3IN 75MM - BLACK - 1155LM FLOOD	SB	GC	INTEGRATED LED	WITH DIMMER.
SCONCE						
20719	2	SCONCE - JUNIPER THIN - 24IN 610MM - BLACK OXIDE	SB	GC	INTEGRATED LED	
20748	2	SCONCE - KUZCO PLUTO TRIPLE - CHROME	SB	GC	INTEGRATED LED	
20778	1	SCONCE - RBW CRISP - FROSTED	SB	GC	INTEGRATED LED	
STRIP						
22215	2	STRIP - LED TAPE IN HOUSING - VARIABLE LENGTH - BLACK - 350LM PER FT	SB	GC	INTEGRATED LED	FIELD TRIMMABLE TO 0.9IN LENGTHS (V.I.F) (1) 24' - 0" (1) 0' - 6"
22217	3	STRIP - LED TAPE - VARIABLE LENGTH - 350LM PER FT	SB	GC	INTEGRATED LED	FIELD TRIMMABLE TO 0.9 IN LENGTHS (V.I.F); LENGTH REQUIRED: (1) 24' - 0" (1) 13' - 8" (1) 6' - 10"
TRACK						
12949	6	TRACK - WITH CONNECTORS - 12FT 365CM - BLACK - 1 CIRCUIT	SB	GC		ALL BAR / CAFE TRACK LIGHTING TO BE RUN THROUGH 1A / 2A CURRENT LIMITING DEVICE #RCLF12BL-TCL2BL; SEE ELECTRICAL DRAWINGS FOR ADDITIONA INFORMATION
15058	2	TRACK - WITH CONNECTORS - 6FT 183CM - BLACK - 1 CIRCUIT	SB	GC		ALL BAR / CAFE TRACK LIGHTING TO BE RUN THROUGH 1A / 2A CURRENT LIMITING DEVICE #RCLF12BL-TCL2BL; SEE ELECTRICAL DRAWINGS FOR ADDITIONA INFORMATION
21779	17	TRACK - LED FIXTURE WITH SNOOT - 3IN 75MM - BLACK - 1100LM FLOOD	SB	GC	INTEGRATED LED	
TROFFER						
23055	7	TROFFER - LED RECESSED - 24X48IN 600X1200MM - WHITE - 2700K	SB	GC	INTEGRATED LED	

MECHANICAL EQUIPMENT SCHEDULE - "M"					
DESIGN ID	COUNT	DESCRIPTION	FURN. BY	INST. BY	COMMENTS
OTHER					
17797	1	ENERGY MANAGEMENT SYSTEM - HVAC ONLY	SB	GC	

PLUMBING FIXTURE SCHEDULE - "P"					
DESIGN ID	COUNT	DESCRIPTION	FURN. BY	INST. BY	COMMENTS
DRAIN					
10294	7	DRAIN - FLOOR SINK SQUARE - 12IN 305MM	SB	GC	ZURN FD2372-H, A.R.E. FLOOR SINK WITH 6" SUPM DEPTH AND 1/2 GRATE.
10594	2	DRAIN - FLOOR SINK SQUARE - 5IN 125MM	GC	GC	ZURN ZN415B
10726	7	FLOOR SINK - GRATE HALF SQUARE - 12IN 305MM	SB	GC	ZURN FD2372-H, A.R.E. FLOOR SINK WITH 6" SUPM DEPTH AND 1/2 GRATE.
FAUCET					
10152	1	FAUCET - DOUBLE LABORATORY WITH BENT RISER SPOUT	SB	GC	
10153	3	FAUCET - WATER TOWER - 12IN 305MM	SB	GC	
10215	1	FAUCET - DOUBLE LABORATORY WITH SWING SPOUT	SB	GC	
10447	1	FAUCET - PRE RINSE SPRAYER WALL MOUNTED	SB	GC	
10597	1	FAUCET - SINGLE HANDLE	SB	GC	
10804	1	FAUCET - PRE RINSE SWING SPOUT	SB	GC	
11003	2	FAUCET - METERED	SB	GC	
22642	2	FAUCET - INSTANTHOT SYSTEM 2 BUTTON WITH BOILER AND BRACKET	SB	GC	KIT INCLUDES FONT, UNDERCOUNTER BOILER AND BOILER BRACKET FOR SIDE PANEL MOUNTING. BRACKET CAN BE FLOOR MOUNTED USING SET OF (4) STAINLESS STEEL LEGS, ORDERED SEPARATELY THROUGH VENDOR.
FILTER					
23355	1	FILTER - FILTRATION BOOSTER PUMP	SB	SB	GC TO COORD. WITH VENDOR
SINK					
10549	1	SINK - RINSE DROP IN SST - 12X20IN 305X510MM	SB	GC	
13264	1	SINK - 3 COMP WORK SST - 93IN 2350MM	SB	GC	
17565	1	SINK - RINSE WITH DRAINBOARD - 15X27IN 380X685MM	SB	GC	
22768	2	SINK - COUNTERTOP RINSER WITH WATER TOWER - 26X9IN 660X235MM	SB	GC	

PAINT SCHEDULE						
COLOR CODE	DESCRIPTION	LRV	FURN. BY	INST. BY	COMMENTS	
SW6991-SG	SW - BLACK MAGIC - EGGSHELL	3	GC	GC	USE PRIMER CP-1	
SW7020-ES	SW - BLACK FOX - EGGSHELL	7	GC	GC	USE PRIMER CP-1	
SW7031-ES	SW - MEGA GREIGE -EGGSHELL	37	GC	GC	USE PRIMER CP-1	
SW7039-ES	SW - VIRTUAL TAUPE - EGGSHELL	20	GC	GC	USE PRIMER CP-1	
SW7631-ES	SW - CITY LOFT - EGGSHELL	70	GC	GC	USE PRIMER CP-1	

WALL TREATMENT (AREA) SCHEDULE - "Q"					
DESIGN ID	AREA	DESCRIPTION	FURN. BY	INST. BY	COMMENTS
PLASTIC					
23764	766 SF	POLYWALL WALLCOVERING	GC	GC	
TILE					
20227	477 SF	TILE - I COCCI - CEMENTO - 6X24IN 150X600MM	SB	GC	GROUT: MAPEI - 47 CHARCOAL, OR EQUAL
X9200	714 SF	TILE - GEO WHITE MATTE - 10X2IN 254X50MM	SB	GC	GROUT: MAPEI 105 TO START FULL TILE UNDER GYP CEILING
WALL COVERING					
21060	171 SF	WALL COVERING - ACCORD - SHARK	SB	GC	
WOOD CLADDING					
X9202	330 SF	WOOD - WALNUT - PLANK - VERTICAL	SB	GC	WD0077 MAD 100-V PLANK; PROVIDED BY CASEWORK VENDOR

WALL TREATMENT (LENGTH) SCHEDULE- "R"					
DESIGN ID	LENGTH	DESCRIPTION	FURN. BY	INST. BY	COMMENTS
TRIM					
X9201	124' - 11"	SCHLUTER JOLLY TRIM ; STAINLESS STEEL	GC	GC	SEE DETAIL: 7/I-502 AND 9/I-502; FINISH: STAINLESS STEEL
X9204	18' - 9 3/4"	1" X 2" WOOD TRIM	SB	GC	FINISH: WD0077; SEE DETAIL: 10/A-503; PROVIDED BY CASEWORK VENDOR

SIGNAGE SCHEDULE - "S"					
DESIGN ID	COUNT	DESCRIPTION	FURN. BY	INST. BY	COMMENTS
SIGNAGE - DRIVE THRU					
23725	1	SIGN - DIRECTIONAL EXIT ONLY NON-ILLUM DS - NEW FOUNDATION - 44IN 1120MM	SB	VD	SEE DETAIL: 2 & 3/A-002

FLOOR TREATMENT SCHEDULE - "T"					
DESIGN ID	AREA	DESCRIPTION	FURN. BY	INST. BY	COMMENTS
TILE					
19795	807 SF	POLYVINYL FLOOR SHEET - ECO-GRIP - PEWTER - 60X96IN 1524X2438MM	GC	GC	GC TO PROCURE FROM ALLIED INDUSTRIES
20228	669 SF	TILE - I COCCI - CEMENTO - 24X24IN 600X600MM	SB	GC	GROUT: MAPEI - 47 CHARCOAL, OR EQUAL
WALK OFF MAT					
19289	39 SF	WALK OFF MAT - HELIX Z2 - BLACK AND GUNMETAL - 12X9IN 305X230MM	SB	GC	CANNOT BE CUT TO SIZE; USE HELIX Z1 AS BORDER WHEN FULL TILES CANNOT BE PLACED


CEILING TREATMENT SCHEDULE - "U"					
DESIGN ID	AREA	DESCRIPTION	FURN. BY	INST. BY	COMMENTS
OTHER					
19734	174 SF	ACT - ULTIMA - 2X2FT 61X61CM	GC	GC	DESIGN TO SPECIFY WHITE, OR CUSTOM COLOR; FOR ORDERING CONTACT DEB PICKENS AT DPLPICKENS@ARMSTRONGCEILINGS.COM, PH: 480-695-9053; FACTORY FINISHED TO MATCH SW9169 CHATURA GRAY
X11302	31 SF	ACT - WHITE - 2X4FT 61X122CM	GC	GC	VINYL CLAD AT STORAGE
X11303	330 SF	ACT - WHITE - 2X2FT 61X61CM - MATCH TO EXISTING	GC	GC	VINYL CLAD AT BOH

RESPONSIBILITY LEGEND

FURN. BY	INST. BY
GC - FURNISHED BY GENERAL CONTRACTOR	GC - INSTALLED BY GENERAL CONTRACTOR
SB - FURNISHED BY STARBUCKS	SB - INSTALLED BY STARBUCKS
VD - FURNISHED BY VENDOR	VD - INSTALLED BY VENDOR

NOTE:
ALL RESPONSIBILITIES TO BE CONFIRMED WITH STARBUCKS CONSTRUCTION MANAGER PRIOR TO ORDERING / CONSTRUCTION.

FOR CONSTRUCTION




© 2023 STARBUCKS COFFEE COMPANY

STARBUCKS®
2401 UTAH AVENUE SOUTH
SEATTLE, WASHINGTON 98134
(206) 318-1575

THESE DRAWINGS AND THE PROJECT MANUAL ARE CONFIDENTIAL AND SHALL REMAIN THE SOLE PROPERTY OF STARBUCKS CORPORATION, WHICH IS THE OWNER OF THE COPYRIGHT IN THIS WORK. THEY SHALL NOT BE REPRODUCED IN WHOLE OR IN PART, SHARED WITH THIRD PARTIES OR USED IN ANY MANNER ON OTHER PROJECTS OR EXTENSIONS TO THIS PROJECT WITHOUT THE PRIOR WRITTEN CONSENT OF STARBUCKS CORPORATION. THESE DRAWINGS AND SPECIFICATIONS ARE INTENDED TO EXPRESS DESIGN INTENT FOR A PROTOTYPICAL STARBUCKS STORE (WHICH IS SUBJECT TO CHANGE AT ANYTIME) AND DO NOT REFLECT ACTUAL SITE CONDITIONS. NEITHER PARTY SHALL HAVE ANY OBLIGATION NOR LIABILITY TO THE OTHER (EXCEPT STATED ABOVE) UNTIL A WRITTEN AGREEMENT IS FULLY EXECUTED BY BOTH PARTIES.

STARBUCKS TEMPLATE VERSION: i2023.10.23

Design Forum Architects Inc.
2050 Byers Rd
Miamisburg, OH 45342
Tel: (844) 804-7700
Donald J. Reithman
Architect In Charge
License: AR0017303

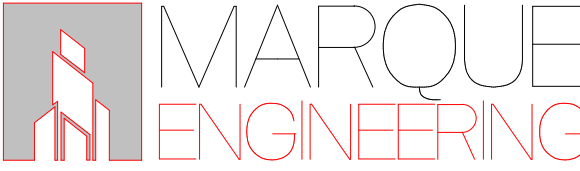
2230 PARK AVE, STE. 100, CINCINNATI, OH 45206
513.457.7131 - WWW.MARQUEENG.COM

PROJECT NAME:
S SEMORAN BLVD & LEE VISTA BLVD

PROJECT ADDRESS:
**6605 S SEMORAN BLVD
ORLANDO, FL 32822**

STORE #: 9875
PROJECT #: 25630-101
ISSUE DATE: 03/04/2024
DESIGN MANAGER: MARTIN PEREZ
PRODUCTION DESIGNER: ANDY MCLOUD
CHECKED BY: DONALD RETHMAN

Revision Schedule			
Rev	Date	By	Description

SHEET TITLE:
SCHEDULES

SCALE: NO SCALE

SHEET NUMBER:
I-602

ABBREVIATIONS

AFF	ABOVE FINISHED FLOOR
AHJ	AUTHORITIES HAVING JURISDICTION
APPROX	APPROXIMATE
BLDG	BUILDING
CLG	CEILING
CONST	CONSTRUCTION
CW	DOMESTIC COLD WATER
CXA	COMMISSIONING AGENT
DEG	DEGREES
DN	DOWN
DTL	DETAIL
DWG(S)	DRAWING(S)
EA	EACH
EC	ELECTRICAL CONTRACTOR
ELEC	ELECTRICAL
EMER	EMERGENCY
EXIST	EXISTING
EXT	EXTERIOR
FD	FLOOR DRAIN
FS	FLOOR SINK
F&I	FURNISH & INSTALL
FOIC	FURNISHED BY OWNER, INSTALLED BY CONTRACTOR
FOIO	FURNISHED BY OWNER, INSTALLED BY OWNER
FLR	FLOOR
FT	FOOT/FEET
FCO	FLOOR CLEANOUT
GC	GENERAL CONTRACTOR
GFCI	GROUND FAULT CIRCUIT INTERRUPTER
GW	GREASE WASTE
HR	HOUR
HVAC	HEATING, VENTILATION, AND AIR CONDITIONING
HW	HOT WATER
HS	HANDSINK
HWS	HOT WATER SUPPLY
HWR	HOT WATER RETURN
LL	LANDLORD
LV	LOW VOLTAGE
MAX	MAXIMUM
MC	MECHANICAL CONTRACTOR
MDP	MAIN DISTRIBUTION PANEL
MECH	MECHANICAL
MEP	MECHANICAL, ELECTRICAL, AND PLUMBING
MFG	MANUFACTURER
MIN	MINIMUM
MS	MOP SINK
NL	NIGHTLIGHT
NTS	NOT TO SCALE
PC	PLUMBING CONTRACTOR
PS	PREP SINK
POC	POINT OF CONNECTION
REF	REFERENCE
REQ'D	REQUIRED
REV	REVISION
SHT	SHEET
SF	SQUARE FEET
SPECS	SPECIFICATION(S)
SST	STAINLESS STEEL
TEL	TELEPHONE
TEMP	TEMPORARY
TMV	TEMPERATURE MIXING VALVE
TW	TEMPERED HOT WATER
TYP	TYPICAL
UC	UNDER COUNTER
UNO	UNLESS NOTED OTHERWISE
V	VENT
W	SANITARY WASTE
WCO	WALL CLEANOUT
WH	WATER HEATER
WP	WEATHER PROOF

PLUMBING SYMBOL LEGEND

_____	S OR W	SANITARY OR WASTE PIPING ABOVE SLAB
_____	S OR W	SANITARY OR WASTE PIPING BELOW SLAB
_____	V	VENT PIPING
—GW—	GW	GREASE WASTE
—CD—	CD	CONDENSATE DRAIN
— — — — —	CW	COLD WATER PIPING
— — — — —	HW	HOT WATER PIPING
—CWF—	CWF	COLD WATER FILTERED
—CWN—	CWN	COLD WATER NANO FILTERED
—CWS—	CWS	COLD WATER SOFTENED
—TW—	TW	TEMPERED WATER
—RO—	RO	REVERSE OSMOSIS WATER
—G—	G	GAS PIPING
—RD—	RD	REFRIGERANT DISCHARGE PIPING
—RS—	RS	REFRIGERANT SUCTION PIPING
—○—	BV	BALL VALVE
—◇—	GV	GATE VALVE
—┴—	CH. V	CHECK VALVE
—┴—	RV	RELIEF VALVE
—┴—	HB	HOSE BIBB
—┴—		SHOCK ABSORBER
—┴—		STRAINER
—┴—	WCO	WALL CLEANOUT
—○—	FCO	FLOOR CLEANOUT
—┼—	FS	FLOOR SINK
—┼—	WM	WATER METER
—⊗—	POC	CONNECT TO EXISTING

PLUMBING SCOPE OF WORK SUMMARY

THE FOLLOWING SCOPE OF WORK IS BASED ON THE LANDLORD'S WORKLETTER EXHIBIT C. THIS SCOPE OF WORK IS NOT INTENDED TO INDICATE THE FULL SCOPE, BUT ONLY A BROAD SUMMARY. THE GENERAL CONTRACTOR SHALL REFERENCE THE COMPLETE WORKLETTER FOR A MORE DETAILED DESCRIPTION OF WORK BY BOTH PARTIES. ANY QUESTIONS REGARDING SCOPE SHALL BE BROUGHT TO STARBUCKS ATTENTION FOR CLARIFICATION. RESPONSIBILITY INDICATED BELOW MEANS FURNISHED, PERMITTED AND INSTALLED BY THE PARTY INDICATED.

WORK DESCRIPTION	RESPONSIBILITY	
	EXISTING	CONTRACTOR
WATER SERVICE AND METER	X	
BOOSTER PUMP FOR WATER SERVICE	X	
BELOW FLOOR/SLAB WASTE, VENT AND WATER PIPES		X
ABOVE FLOOR/SLAB WASTE, VENT AND WATER PIPES		X
PLUMBING VENTS THROUGH ROOF	X	
EXTERIOR HOSE BIBBS	N/A	N/A
BASE COVERAGE SPRINKLER SYSTEM	X	
SPRINKLER SYSTEM MODIFICATIONS FOR TENANT BUILDOUT	X	
EXTERIOR GREASE INTERCEPTOR	X	

SYSTEM COMMISSIONING

CONTRACTOR RESPONSIBILITIES FOR BUILDING COMMISSIONING

CONTRACTOR SHALL PROVIDE SUPPORT AND WORK AS SPECIFIED, NEEDED AND REQUIRED TO CONDUCT AND FACILITATE STARBUCKS STAFF BUILDING COMMISSIONING EFFORTS. THIS WORK WILL BE COMPRISED OF THREE DISTINCT EFFORTS:

- 1) SUPPORT STARBUCKS COMMISSIONING AGENT (CXA) DURING INSTALLATION VERIFICATION AND CORRECT DISCLOSED DEFICIENCIES;
- 2) PERFORM TESTING, ADJUSTING, BALANCING AND SYSTEM STARTUP AND SUPPORT FUNCTIONAL PERFORMANCE TESTING BY STARBUCKS CXA;
- 3) CORRECT DEFICIENCIES DISCLOSED BY FUNCTIONAL PERFORMANCE TESTING AND SUBMIT REPORTS. CONTRACTOR SHALL PERFORM AND PROVIDE THE FOLLOWING:

- A. SYSTEMS SUBJECT TO COMMISSIONING MAY INCLUDE, BUT ARE NOT LIMITED TO, DOMESTIC HOT WATER GENERATION.
- B. CONTRACTOR SHALL INCLUDE COMMISSIONING ACTIVITIES IN PROJECT SCHEDULE AND SHOW INTERVALS FOR PERFORMANCE OF WORK FOR WHICH CONTRACTOR IS RESPONSIBLE AND INTERVALS FOR WORK PERFORMED BY STARBUCKS CXA. CONTRACTOR SHALL SHOW RESOURCES FOR PERFORMING ALL WORK RELATED TO COMMISSIONING ACTIVITIES ON A LINE ITEM IN THE SCHEDULE OF VALUES.
- C. CONTRACTOR SHALL INSTALL EQUIPMENT IN ACCORDANCE WITH THE MANUFACTURER'S REQUIREMENTS AND ALL CONTRACT DOCUMENTS. ENSURE THAT ALL EQUIPMENT IS INSTALLED TOTALLY COMPLETE, AND ACCESSIBLE TO STARBUCKS CXA FOR INSTALLATION VERIFICATION AND FUNCTIONAL PERFORMANCE TESTING PRIOR TO THE SCHEDULED START OF INSTALLATION VERIFICATION.
- D. INSTALLATION VERIFICATION SHALL BE PERFORMED BY STARBUCKS CXA. CONTRACTOR SHALL SUPPORT STARBUCKS CXA INSTALLATION VERIFICATION EFFORTS AS NECESSARY. PROVIDE ALL ACCESS AND EQUIPMENT NECESSARY FOR STARBUCKS STAFF TO VERIFY THAT THE EQUIPMENT IS INSTALLED CORRECTLY.
- E. CONTRACTOR SHALL BE READILY AVAILABLE DURING INSTALLATION VERIFICATION TO CORRECT ANY DEFICIENCIES OR DEFECTS DISCLOSED BY THE INSTALLATION VERIFICATION PROCESS. CORRECTIONS SHALL BE MADE IN A TIMELY MANNER WITHOUT DISRUPTION OF THE CONSTRUCTION SCHEDULE.
- F. ALL DOMESTIC WATER HEATING, RECIRCULATING, FILTER AND SOFTENING EQUIPMENT SHALL BE TESTED AND/OR ADJUSTED AND BALANCED BY THE CONTRACTOR'S TESTING, ADJUSTING AND BALANCE AGENT (SEE TESTING ADJUSTING AND BALANCING) OR THE MANUFACTURER'S CERTIFIED STARTUP REPRESENTATIVE AFTER THE SYSTEM IS VERIFIED TO BE COMPLETE AND CORRECT BY STARBUCKS CXA IN ACCORDANCE WITH THE REQUIREMENTS OF THESE DOCUMENTS. SEQUENCES OF OPERATION SHALL BE TESTED TO ENSURE THAT THEY OPERATE IN ACCORDANCE WITH THE CONTRACT REQUIREMENTS. DELIVERABLES: PRELIMINARY, WRITTEN FUNCTIONAL PERFORMANCE REPORT CONFORMING TO THE REQUIREMENTS SPECIFIED HEREIN, DOCUMENTING THE INFORMATION SPECIFIED, ETC. TO THE STARBUCKS CXA IMMEDIATELY UPON COMPLETION OF THE WORK.
- G. CONTRACTOR SHALL INFORM STARBUCKS CXA WHEN EQUIPMENT IS READY FOR FUNCTIONAL PERFORMANCE TESTING. ALL EQUIPMENT SHALL BE READY FOR FUNCTIONAL PERFORMANCE TESTING PRIOR TO STARTING TESTING. CONTRACTOR SHALL OPERATE EQUIPMENT FOR STARBUCKS CXA AND VERIFY BY DEMONSTRATION THE CORRECT OPERATION OF EQUIPMENT, RESPONSE OF SENSORS, AND PROPER EXECUTION OF HVAC CONTROL AND LIGHTING SEQUENCES, INCLUDING BUT NOT LIMITED TO, AIR MOVEMENT, TEMPERATURE, SOUND, AND CONTROL RESPONSE. PROVIDE ANY SECURITY ACCESS, HARDWARE, SOFTWARE, OR OTHER SUPPORT AS NEEDED FOR THE STARBUCKS CXA TO EFFICIENTLY WITNESS AND DOCUMENT ALL EQUIPMENT TESTING. STARBUCKS CXA WILL RECORD THE EQUIPMENT OPERATION AND RESPONSE TO TESTING SEQUENCES AND PREPARE A LIST OF ANY DEFICIENCIES DISCLOSED BY THE FUNCTIONAL PERFORMANCE TESTS FOR CORRECTION BY THE CONTRACTOR. EQUIPMENT INCLUDES, BUT IS NOT LIMITED TO, AIR HANDLING UNITS, ROOFTOP AND SPLIT TYPE, CONDENSING UNITS, EXHAUST FANS, LIGHTING CONTROLS, ETC. DELIVERABLES: PROVIDE COMPLETED COPIES OF ALL START UP REPORTS, FILLED OUT ON THE MANUFACTURER'S FORMS, TO THE STARBUCKS CXA.
- H. CONTRACTOR IS RESPONSIBLE FOR CORRECTING ANY ISSUES OR DEFICIENCIES DISCLOSED DURING THE FUNCTIONAL PERFORMANCE TESTING PROCESS. CORRECTIONS SHOULD BE MADE IN A TIMELY MANNER WITHOUT DISRUPTION TO THE SYSTEM AND CONSTRUCTION SCHEDULE.
- I. CONTRACTOR SHALL BE READILY AVAILABLE FOR ANY RE-TESTING OF EQUIPMENT DEEMED NECESSARY BY STARBUCKS CXA DURING INSTALLATION VERIFICATION AND FUNCTIONAL PERFORMANCE TESTING. CONTRACTOR IS RESPONSIBLE FOR CORRECTING ANY ISSUES OR DEFICIENCIES FOUND IN THE SYSTEM DURING ANY AND ALL RE-TESTING. CORRECTIONS SHOULD BE MADE IN A TIMELY MANNER WITHOUT DISRUPTION TO THE SYSTEM AND CONSTRUCTION SCHEDULE. DELIVERABLES: FINAL BALANCE REPORT, DEFICIENCIES LIST NOTING CORRECTIVE ACTIONS PERFORMED BY CONTRACTOR IN RESPONSE TO INSTALLATION VERIFICATION AND FUNCTIONAL PERFORMANCE TEST RESULTS.
- J. CONSTRUCTION AND POST CONSTRUCTION TESTING: ADDITIONAL TESTING MAY BE REQUIRED BY LEED AND OTHER PROCESSES THAT MAY OCCUR OUT OF SEQUENCE WITH COMMISSIONING SERVICE. CONTRACTOR SHALL CONDUCT, DOCUMENT, SUPPORT AND SCHEDULE THIS TESTING AS DIRECTED BY STARBUCKS CXA.

VALVES

GENERAL
INSTALL VALVES FOR EACH FIXTURE AND ITEM OF EQUIPMENT. PROVIDE BRAIDED STAINLESS STEEL HOSE (UNLESS OTHERWISE NOTED) BETWEEN VALVE AND EQUIPMENT IN ACCORDANCE WITH MANUFACTURER'S SPECIFICATIONS. LOCATE SHUT-OFF VALVES ADJACENT TO EQUIPMENT FOR EASY ACCESS SUCH THAT VALVES CAN BE REACHED WITHOUT MOVING EQUIPMENT. SHUT OFF VALVES TO BE BALL TYPE. VALVES SHALL BE LISTED/APPROVED FOR USE PER AUTHORITIES HAVING JURISDICTION (AHJ) AND CODE REQUIREMENTS. PROVIDE VALVE IDENTIFICATION PER THE PROJECT MANUAL FOR MAIN WATER SERVICE SHUT-OFF AND ANY OTHER VALVES WHICH ARE NOT CLEARLY EVIDENT WHAT THEY SERVE.

PLUMBING FIXTURES

WATER HEATER
STARBUCKS WATER HEATER PER STARBUCKS STANDARD AND PER AUTHORITIES HAVING JURISDICTION (AHJ), WHICHEVER IS MORE STRINGENT. PROVIDE INSTALLATION COMPLETE WITH FITTINGS AS SHOWN IN THE DRAWINGS. SET HOT WATER TEMPERATURE AT 140° F OR ADJUST AS REQUIRED BY AHJ. PROVIDE THERMOMETER ON HOT WATER PIPE LEAVING WATER HEATER.

WATER FILTRATION
STARBUCKS WATER FILTRATION VENDOR WILL PROVIDE FILTRATION SYSTEM. CONTRACTOR SHALL CONFIRM WITH STARBUCKS CONSTRUCTION MANAGER WHETHER VENDOR OR PLUMBING CONTRACTOR IS TO INSTALL FILTRATION SYSTEM. PROVIDE AND COORDINATE INSTALLATION COMPLETE WITH ALL PIPING, FITTINGS, AND EQUIPMENT AS INDICATED ON THE DRAWINGS.

CONNECTIONS
THE PLUMBING CONTRACTOR SHALL MAKE ALL FINAL CONNECTIONS TO EQUIPMENT INCLUDING REQUIRED MATERIAL SUCH AS PIPING, VALVES, FILTERS, TRAPS, CHECKS VALVES, VACUUM BREAKERS, AND FLEXIBLE AND RIGID TUBING.

SCHEDULES
REFER TO SCHEDULES ON DRAWINGS FOR A DESCRIPTION OF LISTED ITEMS AND FURNISH ANY AND ALL PLUMBING FIXTURES LISTED AS "GC". ANY DISCREPANCIES ABOUT WHO IS TO PROVIDE PLUMBING FIXTURES IN THE SCHEDULE SHALL BE BROUGHT TO STARBUCKS ATTENTION FOR CLARIFICATION. INSTALL ALL FIXTURES LISTED REGARDLESS OF WHO SUPPLIES.

DISHWASHER
G.C. TO FURNISH AND INSTALL POWER CORD FOR DISHWASHER PER JURISDICTIONAL REQUIREMENTS. IF EQUIPMENT IS SPECIFIED AS HOBART ADVANSYS, THE UNIT IS TO BE PLUMBED WITH COLD, NON-FILTERED WATER. IF THE WATER FILTRATION SYSTEM IS A PENTAIR CONFIGURATION II OR III, THEN THE COLD, NON-FILTERED WATER MUST ALSO BE SOFTENED.

INSULATION

WATER PIPING
PROVIDE THERMAL INSULATION PER THE SPECIFICATIONS.

SAFETY COVERS
FURNISH AND INSTALL SPECIFIED NO SCALD SAFETY COVERS WITH INSULATED FOAM LINER AND TAMPER PROOF STRAP AT ALL EXPOSED ADA SINK P-TRAPS AND WATER SUPPLIES AND AS REQUIRED BY JURISDICTION .

PIPING

CONDENSATE DRAINAGE PIPING
THE PLUMBING CONTRACTOR SHALL PROVIDE CONDENSATE DRAINS FOR AIR HANDLING UNITS AND STARBUCKS EQUIPMENT (REFER TO SCHEDULE). CONDENSATE DRAINAGE PIPING SHALL BE TYPE "M" COPPER TUBING WITH WROUGHT COPPER SWEAT FITTINGS JOINED WITH 50/50 SOLDER.

TESTING
ALL PIPES SHALL BE TESTED BY AN APPROVED METHOD BEFORE THEY ARE BACKFILLED OR CONCEALED. AFTER TESTING IS COMPLETE, THE PLUMBING CONTRACTOR SHALL DISINFECT THE POTABLE WATER SYSTEM AS REQUIRED BY LOCAL AUTHORITY. TEST WATER PURITY ACCORDING TO LOCAL REQUIREMENTS AND SUBMIT CERTIFIED TEST RESULTS TO ENGINEER FOR REVIEW AND APPROVAL.

NITROGENATION

STARBUCKS NITROGENATION VENDOR WILL PROVIDE AND INSTALL EQUIPMENT AND FITTINGS IF APPLICABLE TO PROJECT SCOPE FOR NITRO STATION. GENERAL CONTRACTOR SHALL COORDINATE NITRO SYSTEM INSTALLATION WITH STARBUCKS VENDOR.

GENERAL PLUMBING NOTES

1. PLUMBING CONTRACTOR SHALL COORDINATE WITH THE GENERAL CONTRACTOR TO PATCH AND REPAIR ALL EXISTING WALLS, FLOORS, CEILINGS OR OTHER SURFACES IDENTIFIED TO REMAIN THAT MAY BECOME DAMAGED DURING THE COURSE OF WORK.
2. EXPOSED/SURFACE MOUNTED PIPING IS ONLY ALLOWED IN THE BAR AREA UNDER COUNTERTOPS, WHERE IT DOES NOT OBSTRUCT CABINETS/DEVICES AND WHERE APPROVED BY STARBUCKS CONSTRUCTION MANAGER. IF ROUTED THROUGH CABINETS, IT SHALL BE ROUTED TO MAXIMIZE STORAGE SPACE AND BE PROTECTED FROM DAMAGE.
3. DRAWINGS ARE DIAGRAMMATIC AND INDICATE GENERAL INTENT OR ARRANGEMENT OF SYSTEM(S). FURNISH AND INSTALL ALL COMPONENTS NEEDED WHETHER INDICATED OR NOT TO PROVIDE A COMPLETE AND OPERATING SYSTEM. OVERALL CASEWORK COMPONENT DIMENSIONING ON PLUMBING DETAILS ARE SHOWN FOR REFERENCE AND COORDINATION ONLY.
4. CONTRACTOR TO VERIFY ALL DIMENSIONS, INCLUDING CLEARANCES REQUIRED BY OTHER TRADES, AND NOTIFY STARBUCKS CONSTRUCTION MANAGER OF ANY DISCREPANCIES PRIOR TO PROCEEDING WITH THE WORK. ALL DIMENSIONS ARE TO THE FACE OF THE FINISHED SURFACE UNLESS NOTED OTHERWISE. ALL DIMENSIONS TO BE TAKEN FROM ACTUAL BUILDING DIMENSIONS.
5. THE PLUMBING CONTRACTOR SHALL COORDINATE PLUMBING WORK WITH OTHER TRADES. THE ARCHITECTURAL DRAWINGS AND SPECIFICATIONS SHALL TAKE PRECEDENCE OVER ALL OTHER DRAWINGS. SEE ARCHITECTURAL DRAWINGS FOR FIXTURES IN CASEWORK AND PLUMBING DETAILS. SEE THE PROJECT MANUAL FOR PLUMBING SPECIFICATION SECTIONS.
6. ALL PIPING AND/OR PLUMBING DEVICES SHALL BE SUPPORTED FROM STRUCTURE (NOT FROM HVAC DUCTS OR OTHER PIPES/CONDUITS).
7. WHEN BUNDLING SEVERAL INDIRECT WASTE LINES TO DRAIN INTO FLOOR SINK, A UNISTRUT IS REQUIRED FOR SECURING AND BRACING ALL LINES ABOVE THE DRAIN.
8. FURNISH AND INSTALL ALL NEEDED DRAIN LINES PER CODE (NOT ALL SHOWN). INSTALL DRAINS AT 2% SLOPE WHERE POSSIBLE WITHOUT DIPS OR SAGS. ALL INDIRECT DRAINS SHALL RUN SEPARATELY FROM EACH OTHER TO INDIRECT DRAIN RECEPTOR AND SHALL TERMINATE WITH AN AIR GAP PER CODE.
9. FURNISH AND INSTALL WALL CLEANOUTS AT ALL SINKS AND AS NEEDED PER CODE (NOT ALL SHOWN).
10. INSULATE ICE BIN DRAINAGE PIPES PER THE REQUIREMENTS IN THE PROJECT MANUAL.
11. PROCURE WATER HEATERS THROUGH STARBUCKS NATIONAL ACCOUNT WITH DISTRIBUTOR NATIONAL HOT WATER. SUBMIT ORDERS BY EMAIL TO: HOTWATERNIGHTCALLS@NATIONALWHOLESALE.BIZ NATIONAL HOT WATER CONTACT FOR ORDERING AND DISTRIBUTION SUPPORT: (888) 444-4435.
12. PROCURE WATER CLOSETS, URINALS AND FLUSH VALVES THROUGH STARBUCKS NATIONAL ACCOUNT WITH DISTRIBUTOR FERGUSON. SUBMIT QUOTATION REQUESTS BY EMAIL TO: NA.PROJECTS@FERGUSON.COM FERGUSON CONTACT FOR ORDERING AND DISTRIBUTION SUPPORT: (757) 234-8342.

GENERAL NOTES

SCOPE
THE INTENT OF THE PROJECT MANUAL AND THE DRAWINGS IS TO PROVIDE A COMPLETE AND FULLY OPERATIONAL PLUMBING SYSTEM. THE CONTRACTOR SHALL FURNISH ALL LABOR, MATERIAL, AND EQUIPMENT RELATED TO THE INSTALLATION OF THE PLUMBING WORK.

SITE EXAMINATION
THE CONTRACTOR SHALL THOROUGHLY EXAMINE ALL AREAS WHERE FIXTURES, EQUIPMENT, AND PIPING WILL BE INSTALLED AND WILL REPORT ANY CONDITION THAT PREVENTS THE PROPER INSTALLATION OF THE PLUMBING WORK.

STANDARDS
EQUIPMENT AND MATERIALS SHALL CONFORM WITH THE APPROPRIATE PROVISIONS OF LISTING STANDARD IN EFFECT AS APPLICABLE TO EACH INDIVIDUAL UNIT OR ASSEMBLY.

CODES
ALL WORK SHALL BE PERFORMED IN STRICT ACCORDANCE WITH ALL APPLICABLE PROVINCIAL AND LOCAL CODES AND ORDINANCES. IN CASE OF CONFLICT BETWEEN THE DRAWINGS AND SPECIFICATIONS AND THE CODES AND ORDINANCES, THE HIGHEST STANDARD SHALL APPLY. THE CONTRACTOR SHALL SATISFY CODE REQUIREMENTS AS A MINIMUM STANDARD WITHOUT ANY EXTRA COST TO STARBUCKS.

PERMITS AND FEES
THE CONTRACTOR SHALL PROCURE AND PAY FOR ALL PERMITS, FEES, AND INSPECTIONS NECESSARY TO COMPLETE THE PLUMBING WORK.

WARRANTY
THE CONTRACTOR SHALL UNCONDITIONALLY WARRANT ALL WORK TO BE FREE OF DEFECTS IN MATERIAL AND WORKMANSHIP FOR A PERIOD OF ONE (1) YEAR FROM THE DATE OF FINAL ACCEPTANCE BY STARBUCKS AND WILL REPAIR OR REPLACE ANY DEFECTIVE WORK PROMPTLY AND WITHOUT CHARGE AND RESTORE ANY OTHER EXISTING WORK DAMAGED IN THE COURSE OF REPAIRING DEFECTIVE MATERIALS AND WORKMANSHIP.

LANDLORD REQUIREMENTS

PRIOR TO BID: THE CONTRACTOR SHALL COORDINATE WITH LANDLORD / BUILDING OWNER FOR ANY CONSTRUCTION REQUIREMENTS. CONTRACTOR SHALL BECOME COMPLETELY FAMILIAR WITH REQUIREMENTS AND ADHERE TO THEM. WHERE LANDLORD / BUILDING OWNER REQUIREMENTS ARE MORE STRINGENT THAN SHOWN IN THESE PLANS, LANDLORD / BUILDING OWNER REQUIREMENTS SHALL GOVERN.



© 2019 STARBUCKS COFFEE COMPANY

STARBUCKS®
2401 UTAH AVENUE SOUTH
SEATTLE, WASHINGTON 98134
(206) 318-1575


THESE DRAWINGS AND THE PROJECT MANUAL ARE CONFIDENTIAL AND SHALL REMAIN THE SOLE PROPERTY OF STARBUCKS CORPORATION, WHICH IS THE OWNER OF THE COPYRIGHT IN THIS WORK. THEY SHALL NOT BE REPRODUCED IN WHOLE OR IN PART, SHARED WITH THIRD PARTIES OR USED IN ANY MANNER ON OTHER PROJECTS OR EXTENSIONS TO THIS PROJECT WITHOUT THE PRIOR WRITTEN CONSENT OF STARBUCKS CORPORATION. THESE DRAWINGS AND SPECIFICATIONS ARE INTENDED TO EXPRESS DESIGN INTENT FOR A PROTOTYPICAL STARBUCKS STORE (WHICH IS SUBJECT TO CHANGE AT ANYTIME) AND DO NOT REFLECT ACTUAL SITE CONDITIONS. NEITHER PARTY SHALL HAVE ANY OBLIGATION NOR LIABILITY TO THE OTHER (EXCEPT STATED ABOVE) UNTIL A WRITTEN AGREEMENT IS FULLY EXECUTED BY BOTH PARTIES.

STARBUCKS TEMPLATE VERSION: i2023-05-01

Design Forum Architects Inc.

2956 Byers Rd
Miamisburg, OH 45342
Tel: (844) 804-7700

Donald J. Rethman
Architect in Charge

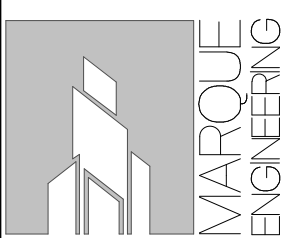

4850 SMITH RD., STE. 101
CINCINNATI, OH 45212
513.901.0040
WWW.MARQUEENG.COM

FOR CONSTRUCTION

PROJECT NAME:
S SEMORAN BLVD & LEE VISTA BLVD

PROJECT ADDRESS:
**6605 S SEMORAN BLVD,
ORLANDO, FL 32822**

STORE #: 9875
PROJECT #: 25630-101
ISSUE DATE: 03/04/2024
DESIGN MANAGER: MARTIN PEREZ
PRODUCTION DESIGNER: ANDY MCLOUD
CHECKED BY: EVAN DUFFY

Revision Schedule			
Rev	Date	By	Description

SHEET TITLE:
PLUMBING NOTES

SCALE: 1/4" = 1'-0"

SHEET NUMBER:
P001

PLUMBING FIXTURE SCHEDULE - "P"				
DESIGN ID	DESCRIPTION	FURN. BY	INST. BY	COMMENTS
X8019	HOT WATER RECIRCULATION PUMP	GC	GC	
DRAIN				
10294	DRAIN - FLOOR SINK SQUARE - 12IN 305MM	GC	GC	
10594	DRAIN - FLOOR SINK SQUARE - 5IN 125MM	GC	GC	ZURN ZN415B
10726	DRAIN - GRATE HALF SQUARE - 12IN 305MM	GC	GC	
FAUCET				
10152	FAUCET - DOUBLE LABORATORY WITH BENT RISER SPOUT	SB	GC	
10153	FAUCET - WATER TOWER - 12IN 305MM	SB	GC	
10215	FAUCET - DOUBLE LABORATORY WITH SWING SPOUT	SB	GC	
10447	FAUCET - PRE RINSE SPRAYER WALL MOUNTED	SB	GC	
10597	FAUCET - SINGLE HANDLE	SB	GC	
10804	FAUCET - PRE RINSE SWING SPOUT	SB	GC	
10922	FAUCET - MOP SINK WALL MOUNTED	SB	GC	
11003	FAUCET - DIPPERWELL	SB	GC	
13588	FAUCET - HAND SINK WALL MOUNTED	SB	GC	
21352	FAUCET - RESTROOM WITH MOTION SENSOR	SB	GC	
22642	FAUCET - INSTANTHOT SYSTEM 2 BUTTON WITH BOILER AND BRACKET	SB	GC	KIT INCLUDES FONT, UNDERCOUNTER BOILER AND BOILER BRACKET FOR SIDE PANEL MOUNTING. BRACKET CAN BE FLOOR MOUNTED USING SET OF (4) STAINLESS STEEL LEGS. ORDERED SEPARATELY THROUGH VENDOR.
FILTER				
13076	FILTER - PREFILTRATION SYSTEM	SB	GC	
23355	FILTER - FILTRATION BOOSTER PUMP	SB	SB	GC TO COORD. WITH VENDOR
OTHER				
22224	WATER HEATER 50GAL 190L ELECTRIC	SB	GC	
SINK				
10116	SINK - RESTROOM WALL MOUNTED	SB	GC	
10549	SINK - RINSE DROP IN SST - 12X20IN 305X510MM	SB	GC	
10995	SINK - MOP - 24X24IN 610X610MM	SB	GC	
13264	SINK - 3 COMP WORK SST - 93IN 2350MM	SB	GC	
14688	SINK - HAND WITH SIDE SPLASH WALL MOUNTED SST	SB	GC	
17565	SINK - RINSE WITH DRAINBOARD - 15X27IN 380X685MM	SB	GC	
22768	SINK - COUNTERTOP RINSER WITH WATER TOWER - 26X9IN 660X235MM	SB	GC	

SPECIALTY EQUIPMENT SCHEDULE - "E"				
f	DESCRIPTION	FURN. BY	INST. BY	COMMENTS
EQUIPMENT				
19742	E-R			
22885	BREWER CLOVER VERTICA DOUBLE	SB	GC	
23380	BREWER CLOVER VERTICA INSTALL KIT	SB	GC	
23381	BREWER CLOVER VERTICA CORD	SB	GC	
23443	OVEN COMBI	SB	GC	
FOOD CASE				
23440	FOOD CASE - WARMING WALL - 1000 SQUARE	SB	GC	
ICE				
10102	ICE - BIN B55			
23183	ICE - MACHINE HMC1410ABT AIR COOLED	SB	GC	
23421	ICE - NUGGET ICE DISPENSER - SINGLE ICE MACHINE	SB	GC	
23525	ICE -BIN ADAPTOR FOLLETT B55H22H30DV PEDESTAL TOP FOR B55			

ELECTRIC WATER HEATER	
TAG	22224
GALLON CAPACITY	50
VOLTAGE/PHASE	208/3
UPPER/LOWER WATTAGE	4500/4500/4500
NO. OF ELEMENTS	3 (SIMULTANEOUS)
GPH RECOVERY @ 100	56
MANUFACTURER	BRADFORD WHITE
MODEL	E32-50S-3

GENERAL NOTES

- FURNISH AND INSTALL A COMPLETE AND OPERATING SYSTEM. ALL ITEMS ARE NOT NECESSARILY SHOWN.
- PLUMBING CONTRACTOR RESPONSIBLE FOR SITE INVESTIGATION PRIOR TO START OF WORK TO REVEAL FULL SCOPE OF WORK.
- ALL PLUMBING LINES TO BE ROUTED SUCH THAT THEY ARE NOT VISIBLE TO CUSTOMERS EXCEPT WHERE FIRST APPROVED BY STARBUCKS AT EXPOSED CEILING AREAS.
- REFER TO MANUFACTURER SPECIFICATIONS FOR LOCATION OF CONNECTIONS UNLESS OTHERWISE NOTED.
- DIMENSIONS ARE TO FINISH FACE UNLESS OTHERWISE NOTED.
- REFER TO DETAIL SHEETS FOR PLUMBING FITTINGS LOCATED IN CASEWORK.
- COLD WATER SUPPLY LINES INSIDE CASEWORK AND BAR AREA TO BE COVERED WITH 1/2" (10MM) THICK SELF SEALING, SECTIONAL CLOSED-CELL FOAM INSULATION. REFER TO SPECIFICATIONS FOR HOT WATER SUPPLY LINE INSULATION REQUIREMENTS.
- INSULATE ALL PIPING INCLUDING PIPES AT BAR AND IN CASEWORK PER THE REQUIREMENTS LISTED IN THE PROJECT MANUAL.
- GENERAL CONTRACTOR SHALL CONTACT WATER FILTRATION SUPPLIER TO COORDINATE SOW AND SCHEDULE PRIOR TO INSTALLATION OF WATER FILTRATION SYSTEM.

KEYED NOTES

- PIPE 3/4" COLD SOFTENED WATER TO WATER HEATER. PIPE 2" HOT WATER FROM WATER HEATER. WATER HEATER AS SPECIFIED ON SHEET P601. REFER TO WATER HEATER DETAIL ON SHEET P501.
- 1/2" HOT WATER AND 1/2" COLD WATER TO FAUCET WITH INTEGRAL ASSE 1001 ATMOSPHERIC VACUUM BREAKER AT MOP SINK. CAULK AND SEAL BACK OF SINK TO WALL.
- (2) 3/4" CITY COLD WATER WITH ASSE 1022 DOUBLE CHECK VALVE WITH ATMOSPHERIC VENT TO FILTRATION EQUIPMENT WITH 3/4" FILTERED WATER 3/4" COLD SOFTENED WATER OUT. PLUMBING CONTRACTOR TO FOLLOW MANUFACTURER'S INSTALLATION INSTRUCTIONS AND ACTIVATION PROCEDURE FOR BOTH SYSTEMS. REFER TO FILTER CONNECTION DETAIL ON SHEET P501.
- 1/2" COLD SOFTENED WATER WITH INTEGRAL ASSE 1001 ATMOSPHERIC VACUUM BREAKER TO DISHWASHER. INSTALL SHUT-OFF WITH 3/4" MALE HOSE-END FITTING @ 18" AFF UNDER COMPARTMENT SINK. SHUT-OFF TO INCLUDE PRESSURE REDUCING VALVE, PRESSURE GAUGE(SET @20 PSIG, 1"OR-5 PSIG), LINE STRAINER, AND SHOCK ARRESTOR IN WALL. CONNECT SANITIZER TO CSW SUPPLY WITH 72" LONG BRAIDED STAINLESS STEEL HOSE.
- 1/2" FILTERED WATER WITH ASSE 1022 DOUBLE CHECK VALVE WITH A ATMOSPHERIC VENT ICE MACHINE. REDUCE TO 3/8" AT MACHINE.
- 1/2" HOT WATER AND 1/2" COLD WATER TO ASSE 1070 THERMOSTATIC MIXING VALVE. 3/8" TEMPERED WATER FROM THERMOSTATIC MIXING VALVE TO FAUCET AT HAND SINK. SET THERMOSTATIC MIXING VALVE TO DELIVER 100 °F TEMPERED WATER.
- 1/2" FILTERED WATER TO COFFEE/TEA BREWER WITH ASSE 1022 DOUBLE CHECK VALVE WITH ATMOSPHERIC VENT. INSTALL SHUT-OFF TO ESPRESSO MACHINE WATER INLET. SEE DETAIL PROVIDED ON SHEET P501.
- 1/2" FILTERED WATER TO ESPRESSO MACHINE PUMP. CONNECT 3/8" COMPRESSION BRAIDED STAINLESS STEEL HOSE FROM SHUT-OFF TO ESPRESSO MACHINE WATER INLET. SEE DETAIL PROVIDED ON SHEET P-501.
- 1/2" COLD WATER TO DIPPERWELL FAUCET. REDUCE TO 1/4" AT UNIT.
- 1/2" FILTERED WATER TO INSTAHOT TAP. REDUCE TO 1/4" AT UNIT.
- 1/2" FILTERED WATER TO WATER TOWER FAUCET LOCATED IN WATER STATION.
- 1/2" COLD WATER TO TOILET. PROVIDE WATER HAMMER ARRESTOR IN SUPPLY LINE. SEE DETAILS ON SHEET P501.
- 3/4" FILTERED WATER AND 3/4" COLD WATER DOWN IN THE WALL TO BELOW SLAB PROVIDE 1/2" ELASTOMERIC INSULATION ON PIPING BELOW SLAB AND EXTEND 2" ABOVE FINISHED FLOOR. VERIFY ROUTING IN FIELD WITH GC PRIOR TO INSTALLATION.
- 1/2" HOT WATER WITH ASSE 1012 DOUBLE CHECK VALVE WITH A ATMOSPHERIC VENT TO SINK.
- CONNECT TO EXISTING 2" DOMESTIC WATER SERVICE TO LEAST SPACE. VERIFY EXACT SIZE, LOCATION PRESSURE AND REQUIREMENTS ON SITE.
- 1/2" COLD WATER WITH ASSE 1022 DOUBLE CHECK VALVE WITH A ATMOSPHERIC VENT TO PITCHER RINSER.
- ROUTE 3/4" FILTERED WATER AND 3/4" COLD WATER BELOW COUNTER TOP LEVELTHROUGH CABINETRY. REFER TO NOTES 9,10,11, AND 17. VERIFY ROUTING IN FIELD WITH GC PRIOR TO INSTALLATION.
- 1/2" FILTERED WATER WITH ASSE 1022 DOUBLE CHECK VALVE WITH ATMOSPHERIC VENT AND 1/2" COLD WATER WITH ASSE 1022 DOUBLE CHECK VALVE WITH ATMOSPHERIC VENT TO COMBI OVEN.
- 1/2" NITROGEN GAS LINE FROM NITROGEN GENERATOR TO NITRO WORKSTATION. FINAL CONNECTION BY STARBUCKS VENDOR.
- 1/2" HOT WATER 1/2" COLD WATER TO ASSE 1070 THERMOSTATIC MIXING VALVE. REDUCE HOT WATER AND COLD WATER LINES TO 3/8" AT THERMOSTATIC MIXING VALVE. 3/8" TEMPERED WATER FROM THERMOSTATIC MIXING VALVE TO METERED FAUCET AT LAVATORY. SET THERMOSTATIC MIXING VALVE TO DELIVER 100°F TEMPERED WATER.
- 3/4" HOT WATER RETURN TO HOT WATER RECIRC PUMP. SEE DETAIL SHEET P501.
- CONNECT ICE CONVEYOR TUBING TO ICE DISPENSER. MAINTAIN MINIMUM 2% SLOPE TOWARD ICE DIVERTER. SEE DETAILS SHEET P502.
- ROUTE ICE CONVEYOR TUBING FROM ICE DIVERTER TO ICE DISPENSER WITHIN 3" SCHEDULE 40 PVC PIPE. SEE DETAILS SHEET P502.
- ROUTE SEPARATE ICE CONVEYOR TUBES FROM ICE DIVERTER TO ICE MACHINE BIN AND ICE DISPENSER. SEE DETAILS P502.

FOR CONSTRUCTION



STARBUCKS®
2401 UTAH AVENUE SOUTH
SEATTLE, WASHINGTON 98134
(206) 318-1575


THESE DRAWINGS AND THE PROJECT MANUAL ARE CONFIDENTIAL AND SHALL REMAIN THE SOLE PROPERTY OF STARBUCKS CORPORATION, WHICH IS THE OWNER OF THE COPYRIGHT IN THIS WORK. THEY SHALL NOT BE REPRODUCED IN WHOLE OR IN PART, SHARED WITH THIRD PARTIES OR USED IN ANY MANNER ON OTHER PROJECTS OR EXTENSIONS TO THIS PROJECT WITHOUT THE PRIOR WRITTEN CONSENT OF STARBUCKS CORPORATION. THESE DRAWINGS AND SPECIFICATIONS ARE INTENDED TO EXPRESS DESIGN INTENT FOR A PROTOTYPICAL STARBUCKS STORE (WHICH IS SUBJECT TO CHANGE AT ANYTIME) AND DO NOT REFLECT ACTUAL SITE CONDITIONS. NEITHER PARTY SHALL HAVE ANY OBLIGATION NOR LIABILITY TO THE OTHER (EXCEPT STATED ABOVE) UNTIL A WRITTEN AGREEMENT IS FULLY EXECUTED BY BOTH PARTIES.

STARBUCKS TEMPLATE VERSION: i2023-05-01

Design Forum Architects Inc.

2956 Byers Rd
Miamisburg, OH 45342
Tel: (844) 804-7700

Donald J. Rethman
Architect in Charge

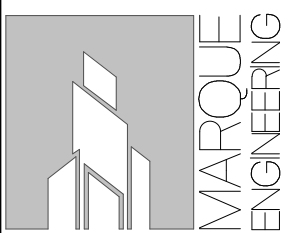

4850 SMITH RD., STE. 101
CINCINNATI, OH 45212
513.901.0040
WWW.MARQUEENG.COM

PROJECT NAME:
S SEMORAN BLVD & LEE VISTA BLVD

PROJECT ADDRESS:
**6605 S SEMORAN BLVD,
ORLANDO, FL 32822**


STORE #: 9875
PROJECT #: 25630-101
ISSUE DATE: 03/04/2024
DESIGN MANAGER: MARTIN PEREZ
PRODUCTION DESIGNER: ANDY MCLOUD
CHECKED BY: EVAN DUFFY

Revision Schedule			
Rev	Date	By	Description


SHEET TITLE:
PLUMBING SUPPLY PLAN
SCALE: 1/4" = 1'-0"

SHEET NUMBER:

P111

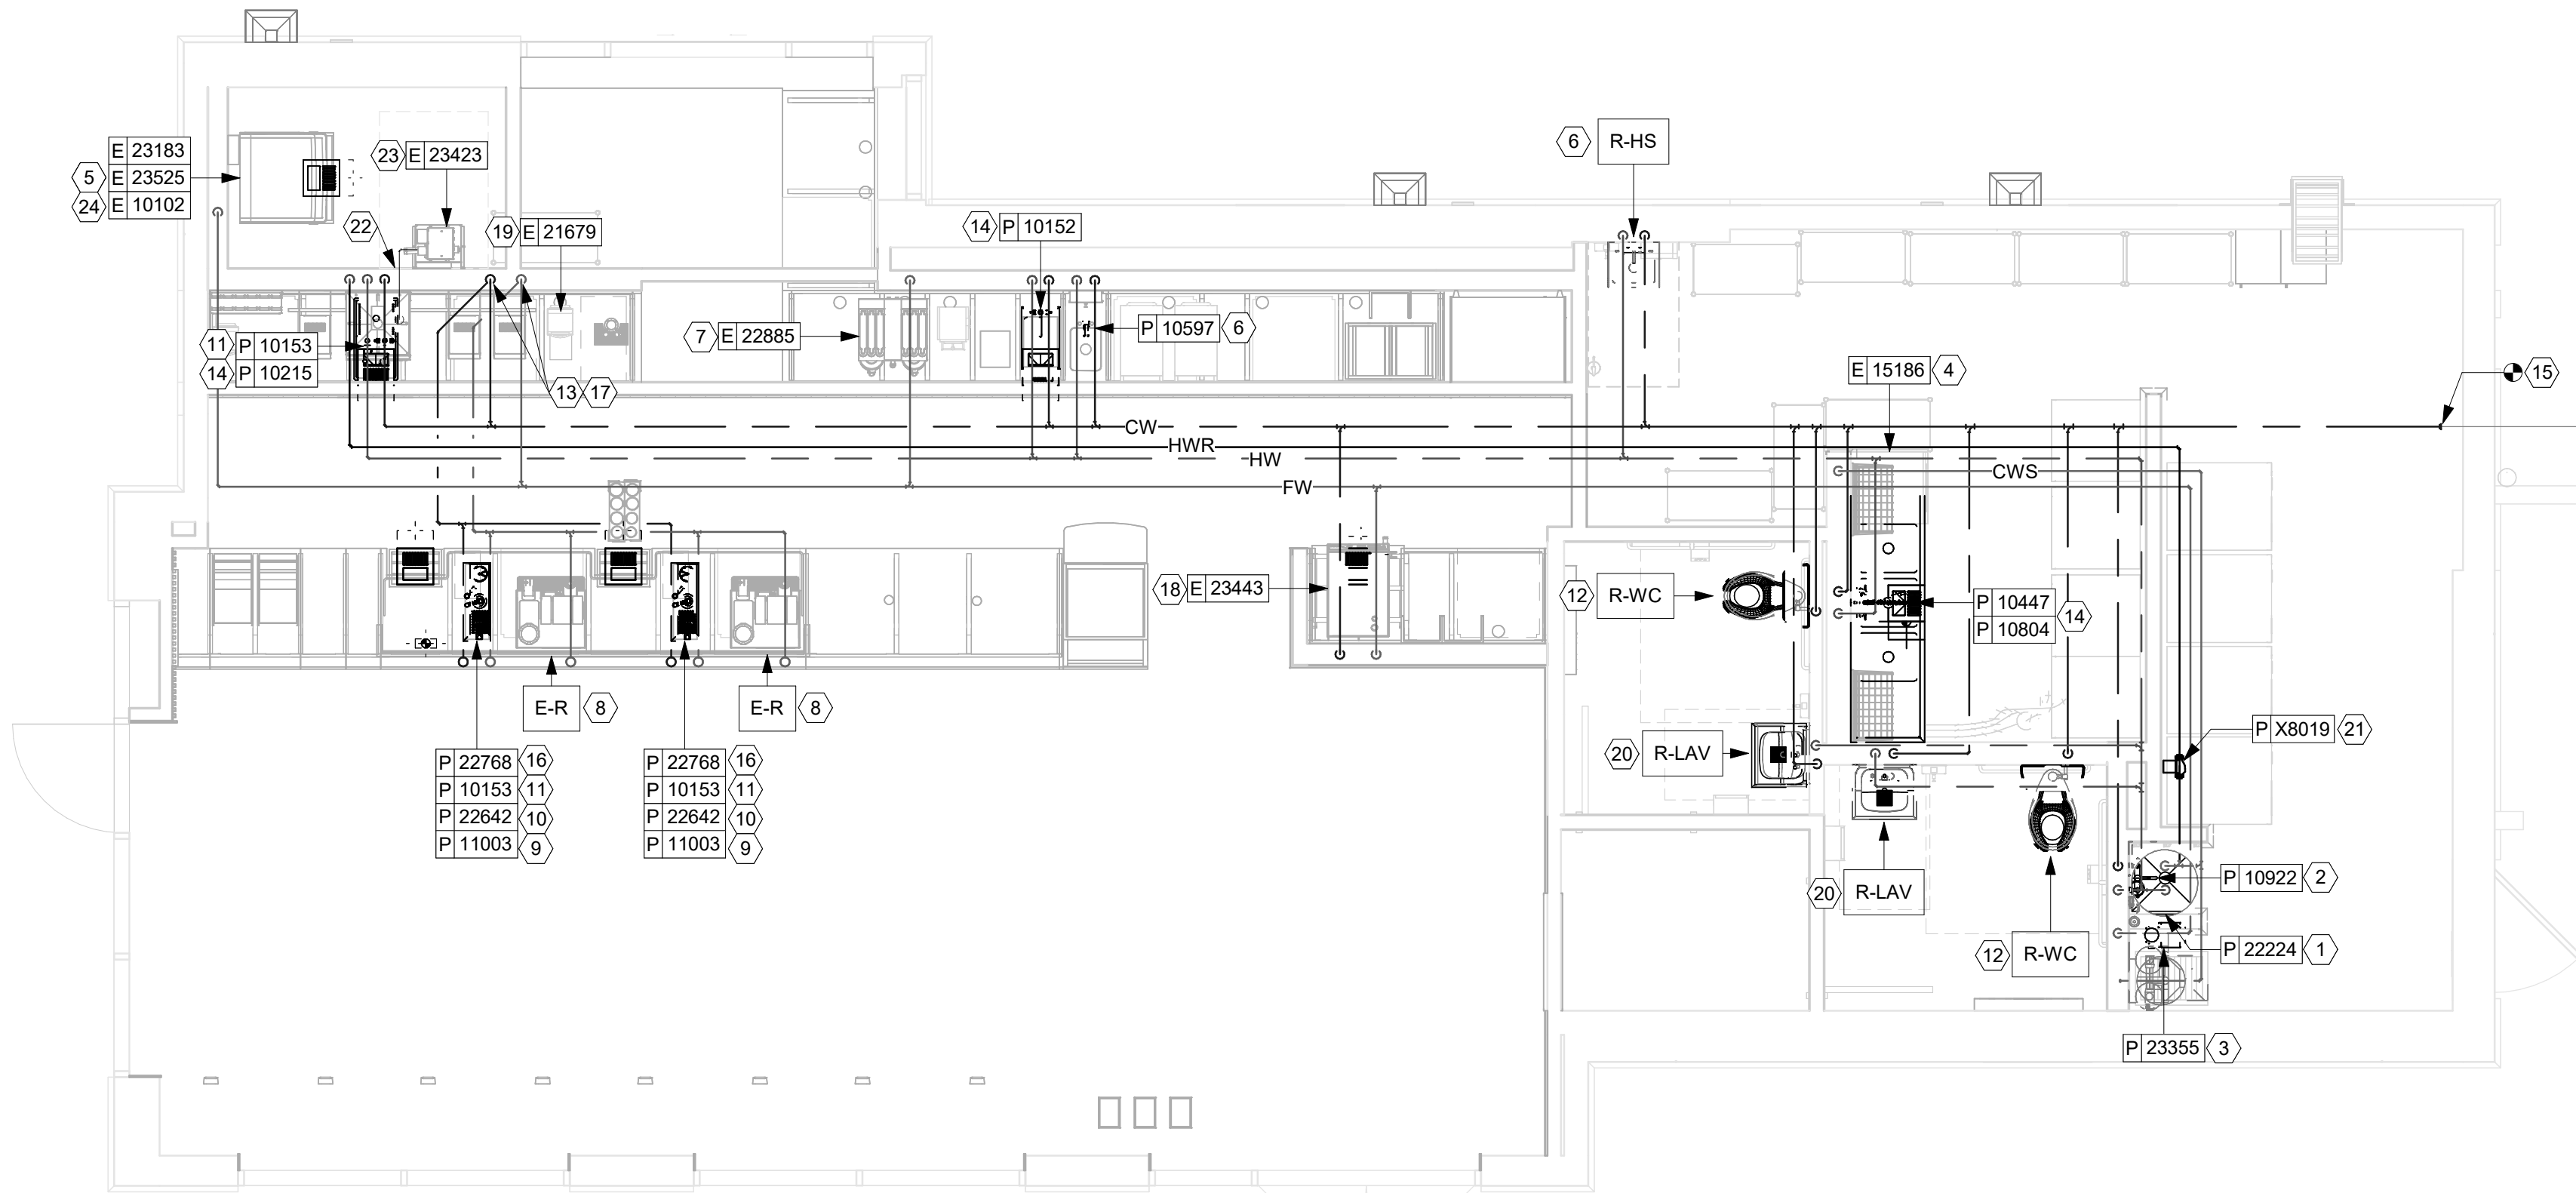

1 PLUMBING SUPPLY PLAN
Scale: 1/4" = 1'-0"

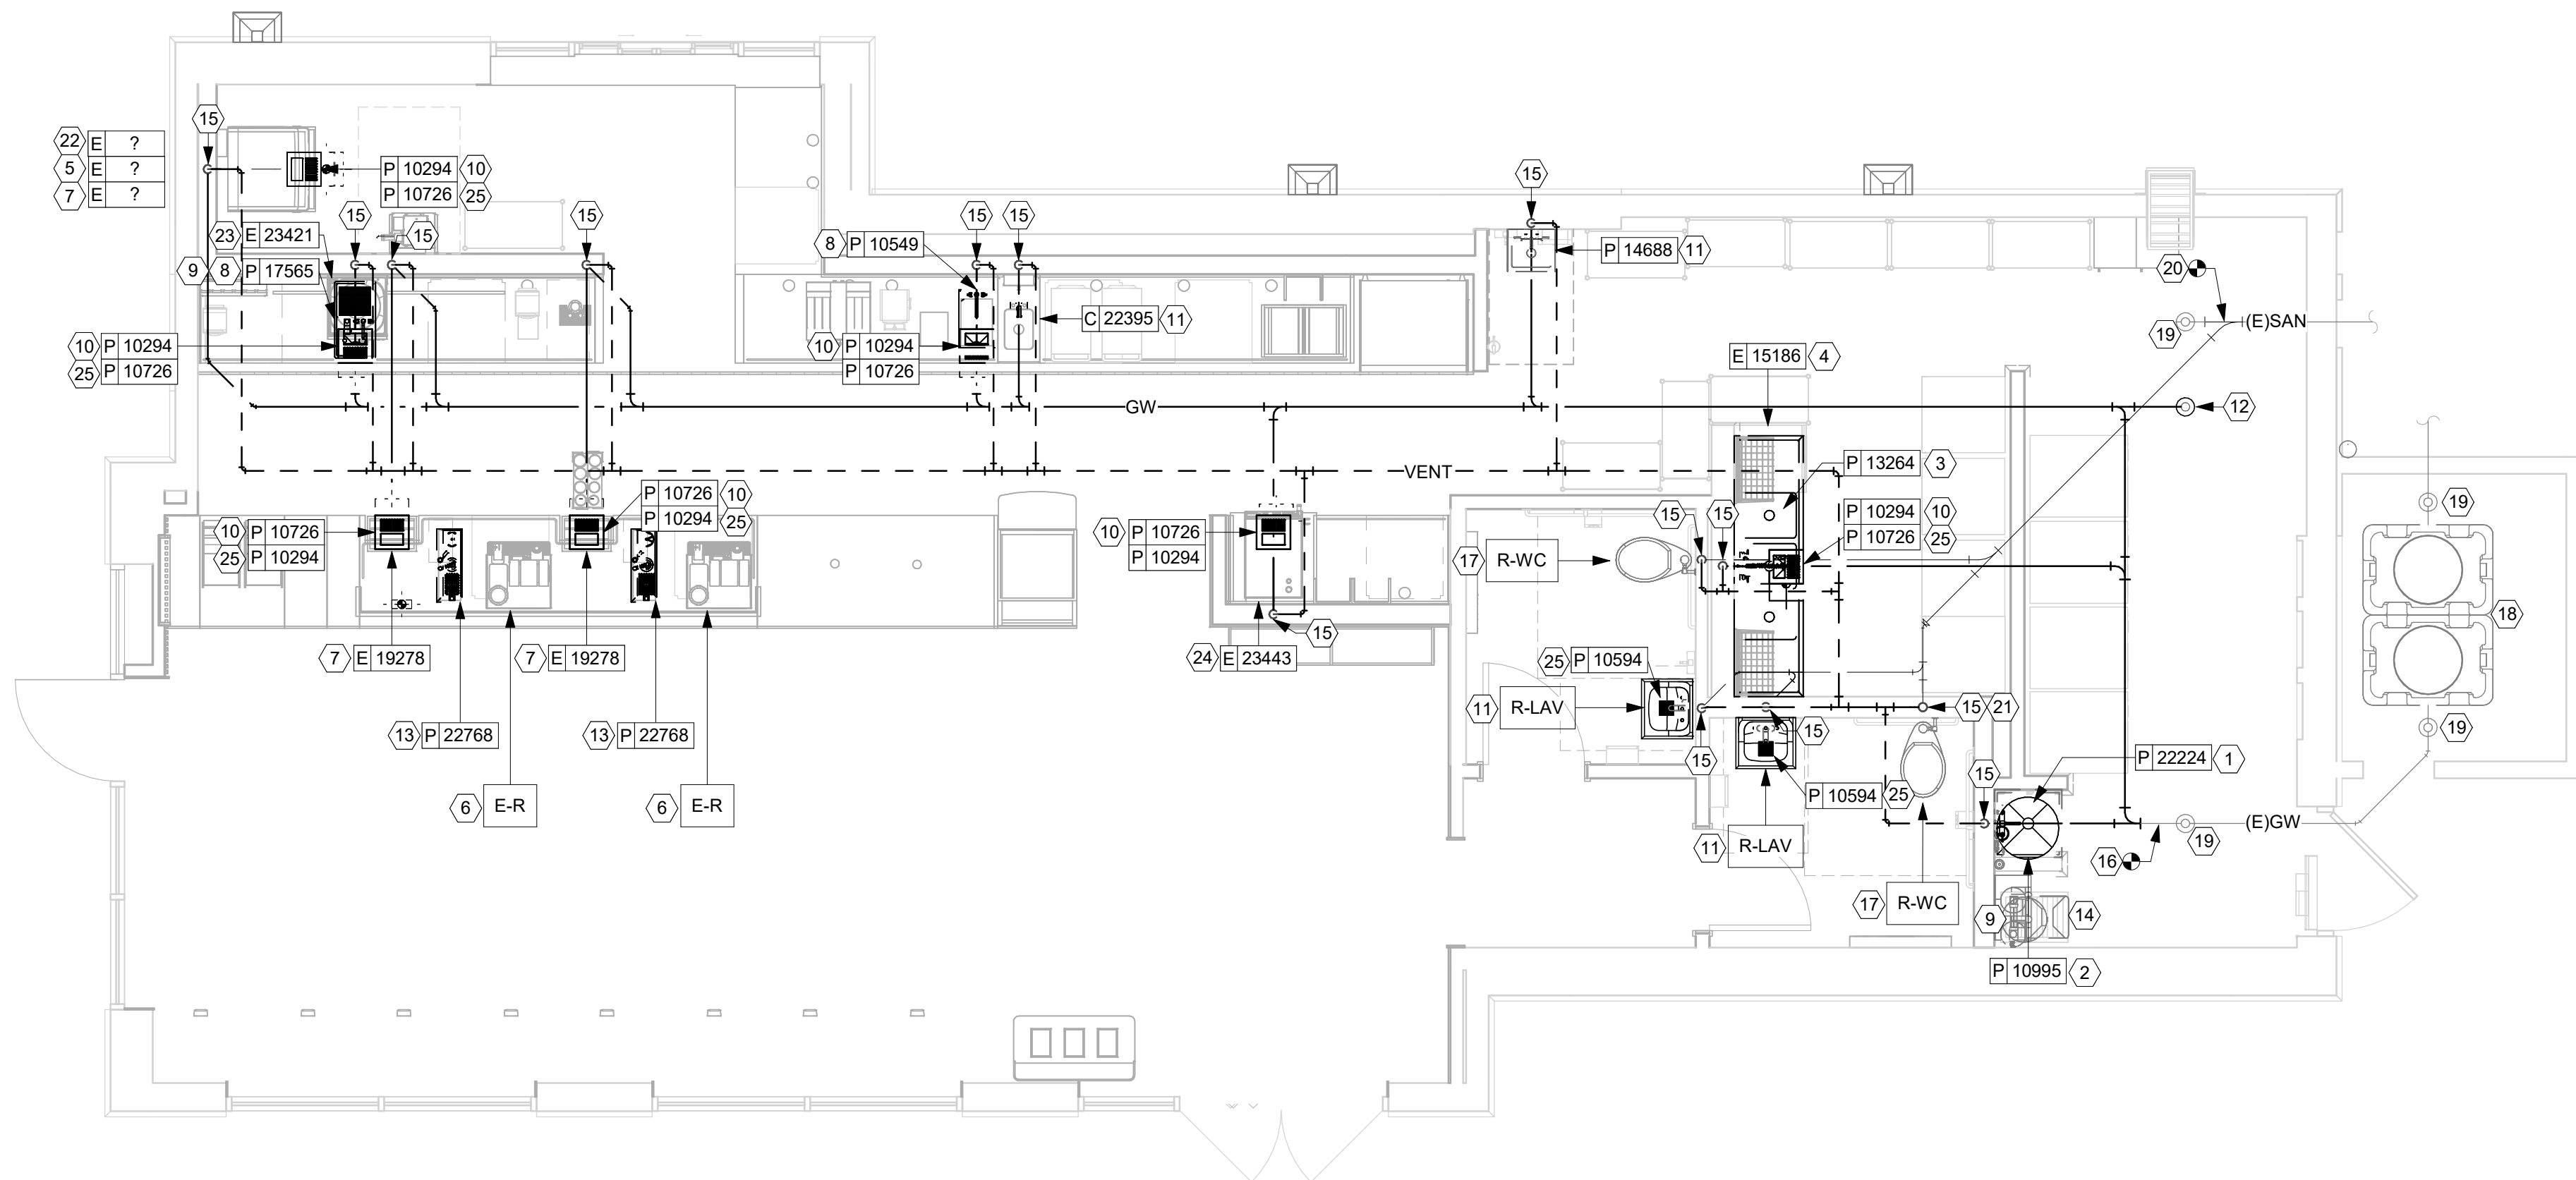

GENERAL NOTES

- A. FURNISH AND INSTALL A COMPLETE AND OPERATING SYSTEM. ALL ITEMS ARE NOT NECESSARILY SHOWN.
- B. FOR FULL SCHEDULES AND COMPLETE LISTING SEE ARCHITECTURAL SCHEDULES. CONFIRM ALL QUANTITIES WITH PLAN.
- C. PLUMBING CONTRACTOR RESPONSIBLE FOR SITE INVESTIGATION PRIOR TO START OF WORK TO REVEAL FULL SCOPE OF WORK.
- D. COORDINATE WITH ELECTRICAL CONTRACTOR FOR POWER CONNECTOR FOR POWER CONNECTION TO ALL PLUMBING EQUIPMENT.
- E. SEE ARCHITECTURAL DRAWINGS FOR DIMENSIONS.
- F. ALL INDIRECT DRAIN LINES SHALL BE ROUTED WITHOUT DIPS OR SAGS TO TERMINATE WITH AN AIR GAP INTO AN APPROVED INDIRECT WASTE RECEPTOR.
- G. REFER TO DETAILS FOR FURTHER REQUIREMENTS.
- H. LOCATIONS OF EXISTING PIPING AND FIXTURES ARE APPROXIMATE. VERIFY LOCATION IN FIELD.

KEYED NOTES

1. 3/4" PRESSURE RELIEF INDIRECT DRAIN FROM WATER HEATER TO MOP SINK.
2. 3" WASTE FROM MOP SINK.
3. 2" INDIRECT DRAIN FROM EACH THREE COMPARTMENT SINK BASIN TO FLOOR SINK.
4. 1-1/4" INDIRECT DRAIN FROM DISHWASHER TO FUNNEL OVER FLOOR SINK IF PERMITTED.
5. 3/4" I.D. F.P.T. FROM DRAIN ON ICE MACHINE TO INDIRECT DRAIN AT FLOOR SINK.
6. 5/8" DRAIN HOSE TO INDIRECT DRAIN RISER. SEE DETAIL ON SHEET P501.
7. 1" INDIRECT INSULATED DRAIN LINE FROM ICE BIN DROP TO FLOOR SINK.
8. 1-1/2" INDIRECT DRAIN FROM SINK TO FLOOR SINK.
9. 3/4" INDIRECT DRAIN FROM WATER STATION TO DRAIN BOARD TO FLOOR SINK.
10. 3" WASTE FROM FLOOR SINK.
11. 2" WASTE FROM SINK.
12. FLOOR CLEAN OUT MATCH TO DRAIN IN LINE SIZE.
13. 1-1/2" INDIRECT DRAIN FROM PITCHER RINSER TO FLOOR SINK.
14. 3/4" INDIRECT DRAIN FROM WATER EQUIPMENT TO MOP SINK.
15. 2" VENT PIPE.
16. CONNECT TO EXISTING GREASE WASTE BUILDING DRAIN.
17. 3" WASTE FROM WATER CLOSET.
18. EXISTING 1250 GALLON GREASE INTERCEPTOR TO REMAIN. FIELD VERIFY LOCATION, SIZE AND DIRECTION OF FLOW PRIOR TO BEGINNING WORK.
19. EXISTING CLEAN OUT TO REMAIN WITHOUT MODIFICATION.
20. CONNECT TO EXISTING SANITARY BUILDING DRAIN.
21. CONNECT TO EXISTING VENT THROUGH ROOF. VERIFY SIZE, LOCATION, AND CONDITION PRIOR TO BID.
22. 3/4" INDIRECT F.P.T. AND 3/8" INDIRECT DRAIN FROM CHASSIS DRAIN PAN DOWN WALL IN SURFACE MOUNTED 1-1/2" PVC STAND PIPE TO FLOOR SINK. SEE DETAIL ON SHEET P502.
23. 3/4" INDIRECT DRAIN FROM ICE DISPENSER TO FLOOR SINK. SEE DETAIL SHEET P502.
24. 1-1/2" INDIRECT DRAIN FROM COMBI OVEN TO FLOOR SINK.
25. 3" WASTE FROM FLOOR DRAIN. PROVIDE ASSE 1072 TRAP UARD AT FLOOR DRAIN P-TRAP.



STARBUCKS®
2401 UTAH AVENUE SOUTH
SEATTLE, WASHINGTON 98134
(206) 318-1575


THESE DRAWINGS AND THE PROJECT MANUAL ARE CONFIDENTIAL, AND SHALL REMAIN THE SOLE PROPERTY OF STARBUCKS CORPORATION, WHICH IS THE OWNER OF THE COPYRIGHT IN THIS WORK. THEY SHALL NOT BE REPRODUCED (IN WHOLE OR IN PART), SHARED WITH THIRD PARTIES OR USED IN ANY MANNER ON OTHER PROJECTS OR EXTENSIONS TO THIS PROJECT WITHOUT THE PRIOR WRITTEN CONSENT OF STARBUCKS CORPORATION. THESE DRAWINGS AND MANUALS ARE PROVIDED TO PREPARE DESIGN INTENT FOR A PROTOTYPAL STARBUCKS STORE (WHICH IS SUBJECT TO CHANGE AT ANYTIME) AND DO NOT REFLECT ACTUAL SITE CONDITIONS. NEITHER PARTY SHALL HAVE ANY OBLIGATION OR LIABILITY TO THE OTHER (EXCEPT STATED ABOVE) UNTIL A WRITTEN AGREEMENT IS FULLY EXECUTED BY BOTH PARTIES.

STARBUCKS TEMPLATE VERSION: i2023-05-01

**Design Forum
Architects Inc.**

2056 Byers Rd
Miamisburg, OH 45342
Tel: (844) 804-7700

Donald J. Rethman
Architect In Charge

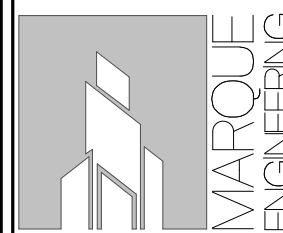

4850 SMITH RD., STE. 101
CINCINNATI, OH 45212
513.901.0040
WWW.MARQUEENG.COM

FOR CONSTRUCTION

PROJECT NAME:
**S SEMORAN BLVD &
LEE VISTA BLVD**

PROJECT ADDRESS:
6605 S SEMORAN BLVD,
ORLANDO, FL 32822

STORE #:	9875
PROJECT #:	25630-101
ISSUE DATE:	03/04/2024
DESIGN MANAGER:	MARTIN PERE
PRODUCTION DESIGNER:	ANDY MCLOU
CHECKED BY:	EVAN DUFFY


Revision Schedule			
Rev	Date	By	Description

SHEET TITLE:
**PLUMBING WASTE &
VENT PLAN**

SHEET NUMBER: P112


1 ELECTRIC WATER HEATER

Scale: 1/4" = 1'-0"

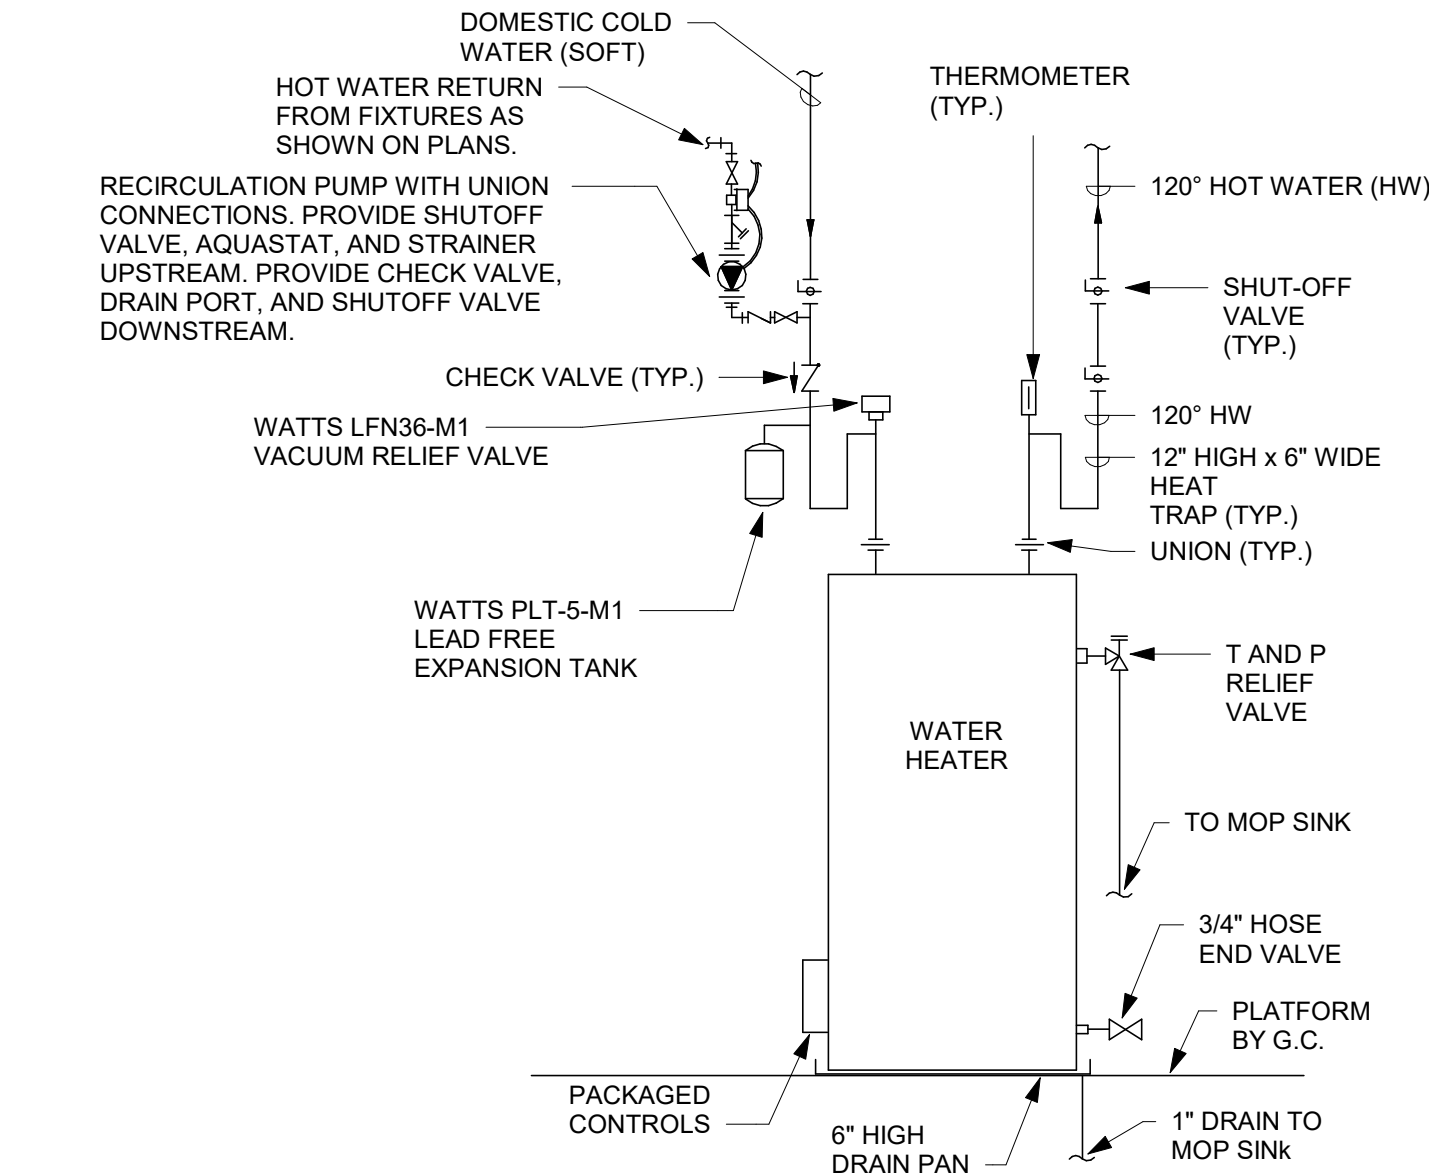

HOT WATER HEATER NOTES:


- RECIRCULATION PUMP:** BELL & GOSSETT #NBF-36 WET ROTOR TYPE IN-LINE 3-SPEED PUMP WITH 3300RPM MOTOR, LEAD FREE BRONZE BODY WITH FULL UNION CONNECTIONS, CAPACITY OF 15 GPM AT 15 FEET OF HEAD. PROVIDE WITH BELL & GOSSETT AGS-3/4 SURFACE MOUNTED AQUASTAT WITH SINGLE POLE DOUBLE THROW SWITCH FOR CIRCULATOR CONTROL. SET AQUASTAT TO SHUT "OFF" (OPEN) RECIRCULATION PUMP AT WATER HEATER SET POINT AND "ON" (CLOSED) AT 10°F BELOW SET POINT. ELECTRICAL REQUIREMENTS: 120 VOLT, 2.25 FULL LOAD AMPS.
- TIME SWITCH:** BELL & GOSSETT TC-1, 7 DAY, ONE CIRCUIT, SINGLE POLE SINGLE THROW, ELECTRONIC TIME SWITCH OR EQUAL. TIME SWITCH SHALL BE MOTOR RATED (1 HP @ 120 VOLT, SINGLE PHASE), MINIMUM OF 20 SET POINTS (14 ON/OFF CYCLES) AND BATTERY BACK-UP. COORDINATE WITH GC FOR INSTALLATION AND INTERLOCK OF TIME SWITCH IN SERIES WITH AQUASTAT AND RECIRCULATION PUMP. SET TIME SWITCH "ON" TO ONE HOUR BEFORE STORE OPENING AND "OFF" TO ONE HOUR AFTER STORE CLOSING. VERIFY STORE OPERATING HOURS WITH STARBUCKS CM.

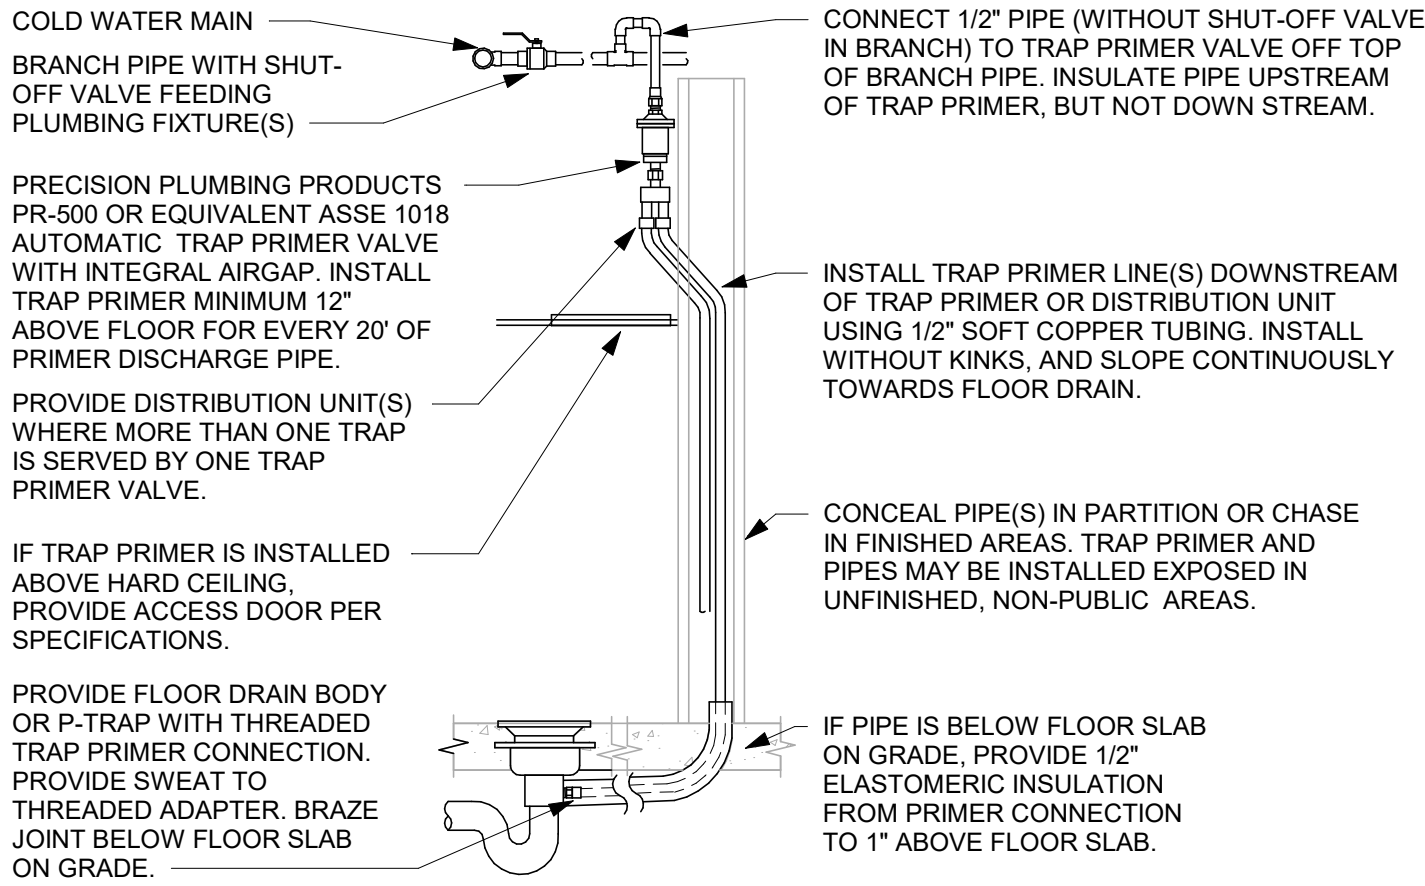

6 TRAP PRIMER DETAIL

Scale: 1/4" = 1'-0"

PROVIDE TRAP PRIMERS WHERE SHOWN ON FLOOR PLANS, AND WHERE REQUIRED BY LOCAL AUTHORITIES. PIPING ARRANGEMENT SHOWN IS SCHEMATIC; ADJUST TO SUIT FIELD CONDITIONS. REFER TO SPECIFICATIONS AND PLUMBING FIXTURE SCHEDULE FOR MORE INFORMATION. INSTALL TRAP PRIMER VALVE AND DISTRIBUTION UNIT PER MANUFACTURER'S RECOMMENDATIONS.

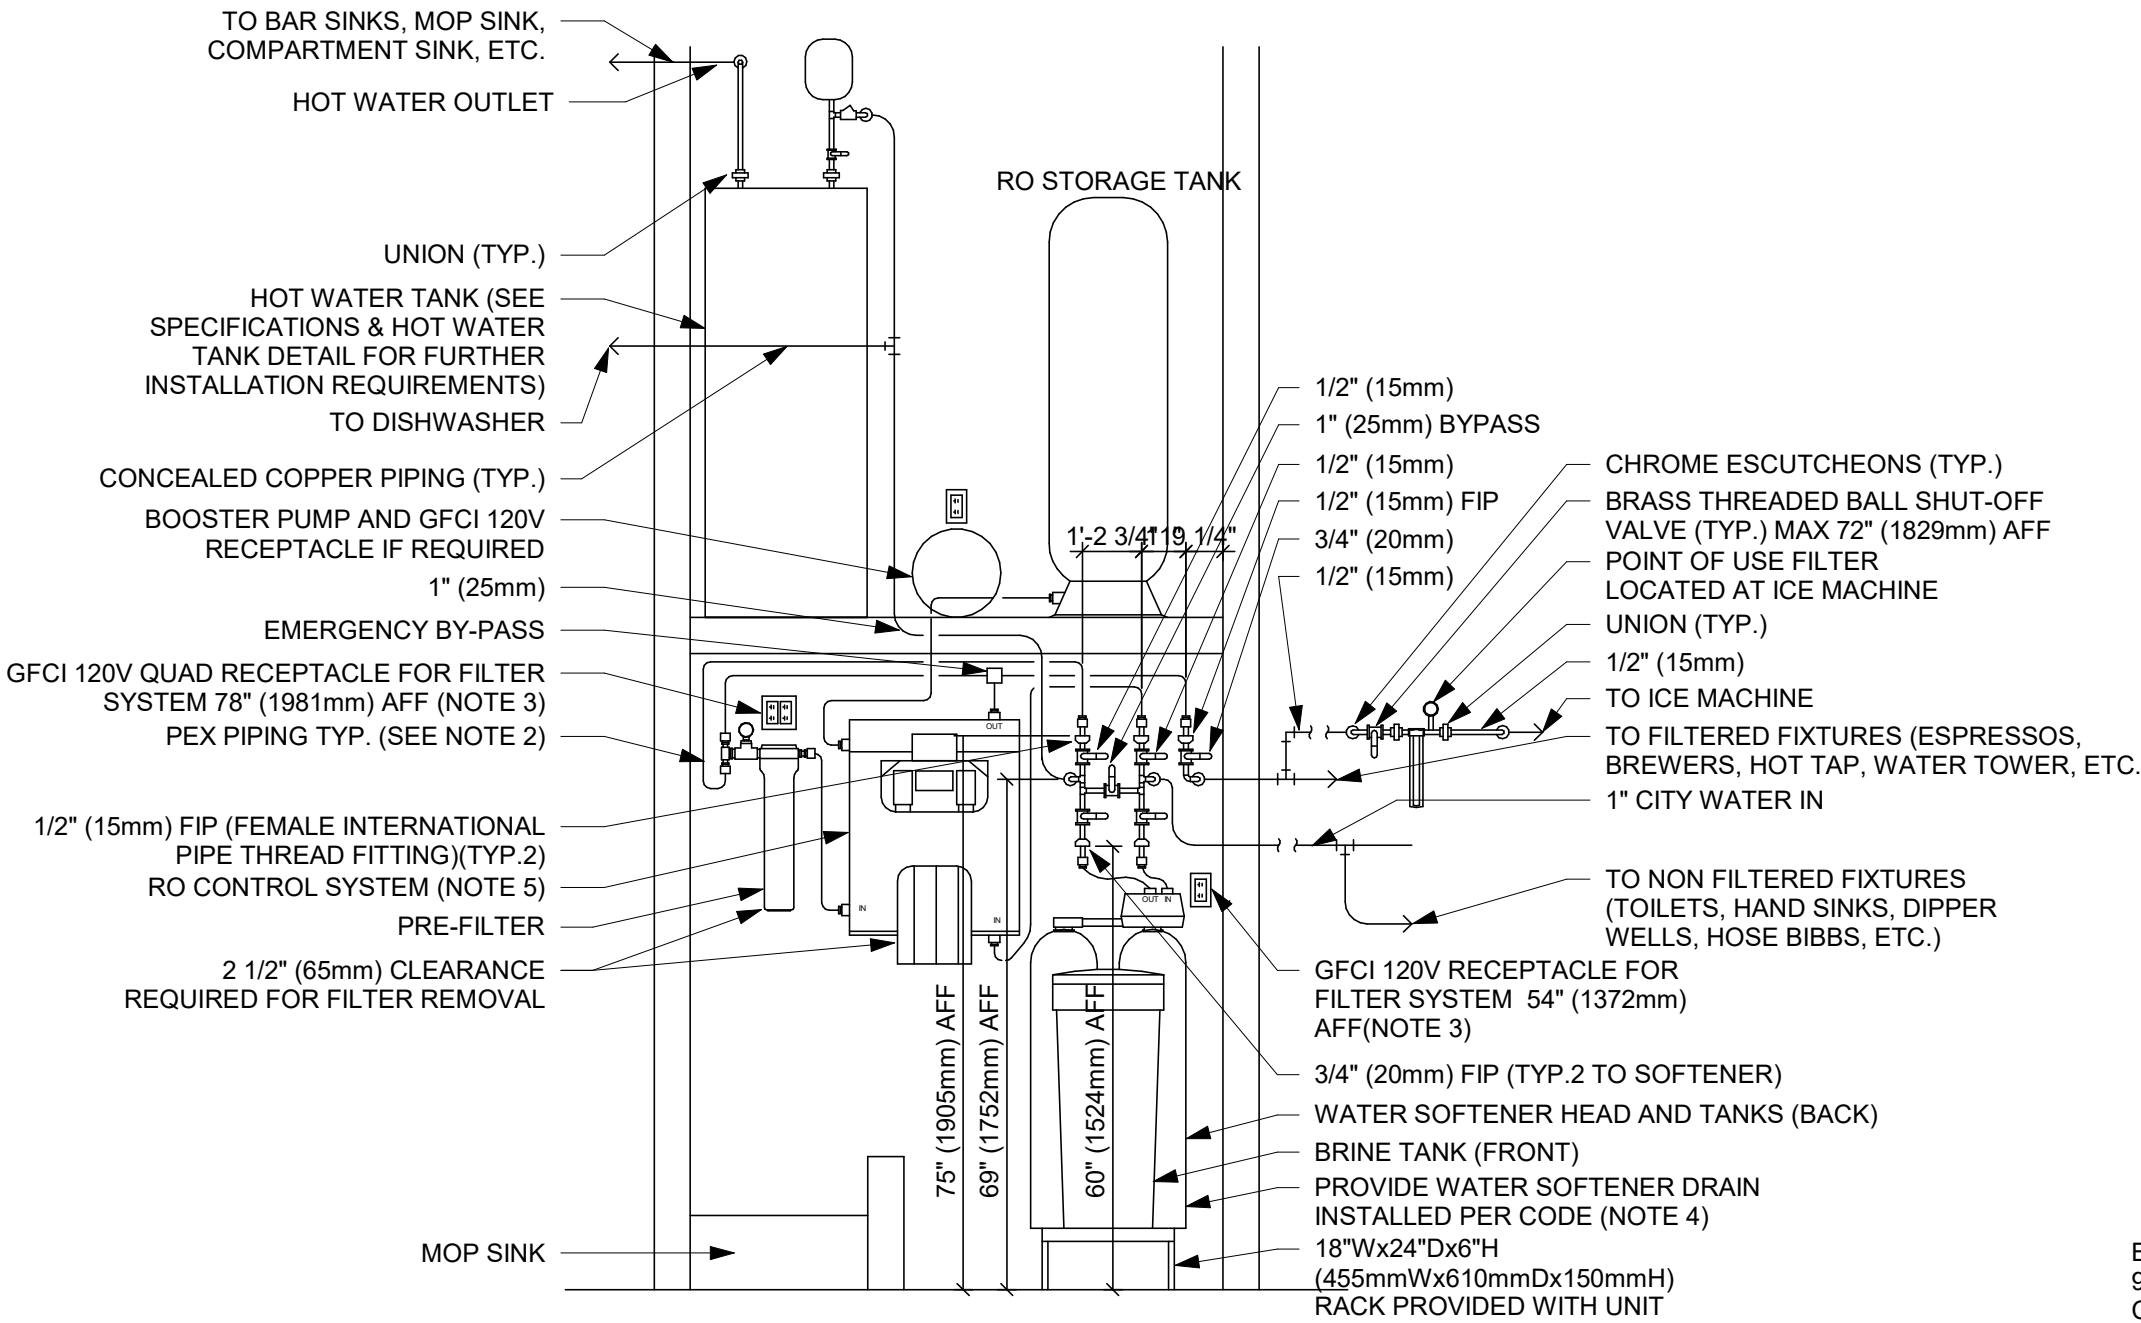

NOTES:

- ALL COMPONENTS DRAWN IN BOLD ARE GC RESPONSIBILITY. GC TO COORDINATE INSTALLATION OF ALL OTHER COMPONENTS SHOWN WITH FILTER VENDOR.
- ALL PIPING SHALL BE COPPER EXCEPT PEX TYPE PIPING IS ACCEPTABLE BETWEEN FILTER SYSTEM COMPONENTS WHERE ALLOWED BY CODE
- COORDINATE WITH ELECTRICAL CONTRACTOR FOR RECEPTACLES.
- PROVIDE WATER SOFTENER INDIRECT DRAIN TO SINK, INSTALLED PER CODE. (CONFIRM REQUIREMENTS WITH SOFTENER EQUIPMENT CUTSHEETS IN ITEM SPECIFICATIONS).
- PROVIDE RO INDIRECT DRAIN TO SINK INSTALLED PER CODE. (CONFIRM REQUIREMENTS WITH RO EQUIPMENT CUTSHEET IN ITEM SPECIFICATIONS).
- IN MUNICIPALITIES WITH BRINE RESTRICTIONS, REFER TO THE WATER SYSTEM CONFIGURATIONS APPENDIX UNDER ITEM SPECIFICATIONS FOR WATER SOFTENER EXCHANGE TANK SCHEMATIC.
- COMPONENTS ARE TO BE POSITIONED TO MAXIMIZE ACCESS FOR REGULAR SERVICING. PRE-FILTER, BYPASS VALVES, AND SOFTENER TANKS MUST BE INSTALLED 72" (1828MM) AFF OR LOWER.


8 TYPE 3 WATER TREATMENT SYSTEM

Scale: 1/4" = 1'-0"

WATER HAMMER ARRESTOR SIZING CHART

FIXTURE UNIT RATING	PDI SIZE	CONNECTION TO SUPPLY LINE
1-11	A	3/4"
12-32	B	1"
33-60	C	1"
61-113	D	1 1/4"
114-154	E	1 1/2"
155-330	F	2"

REFERENCE PDI-WH-201.

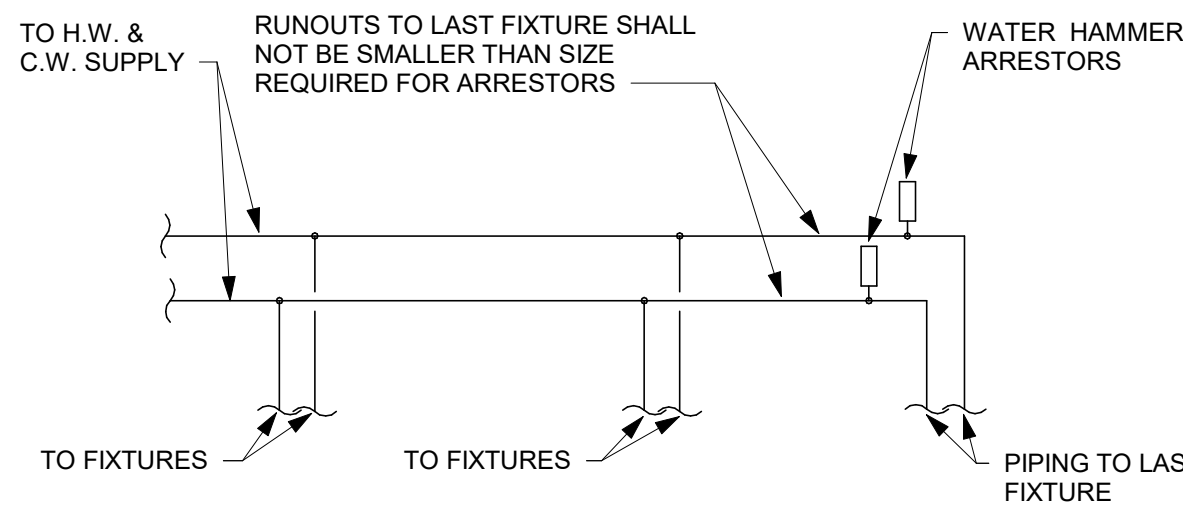

7 WATER HAMMER ARRESTOR

Scale: 1/4" = 1'-0"

BRAIDED STAINLESS STEEL HOSE. 9/16-24 UNEF COMPRESSION CONNECTION 150 PSIG MIN. RATING (TYP. 2)

ASSE 1022 DOUBLE CHECK VALVE WITH ATMOSPHERIC VENT (TYP. 2)
WATER PUMP. INSTALL TO ALLOW ACCESS TO INTEGRAL PUMP FILTER. SEE PUMP ATTACHEMENT DETAIL (TYP. 2)


BRAIDED STAINLESS STEEL HOSE. 9/16-24 UNEF COMPRESSION CONNECTION 150 PSIG MIN. RATING (TYP. 2)

1/2" NPT TO HOSE COMPRESSION CONNECTION (TYP. 2)


1/2" BALL VALVE. (TYP. 2)

5 ESPRESSO MACHINE GENERAL PIPING CONNECTION SCHEMATIC

Scale: 1/4" = 1'-0"

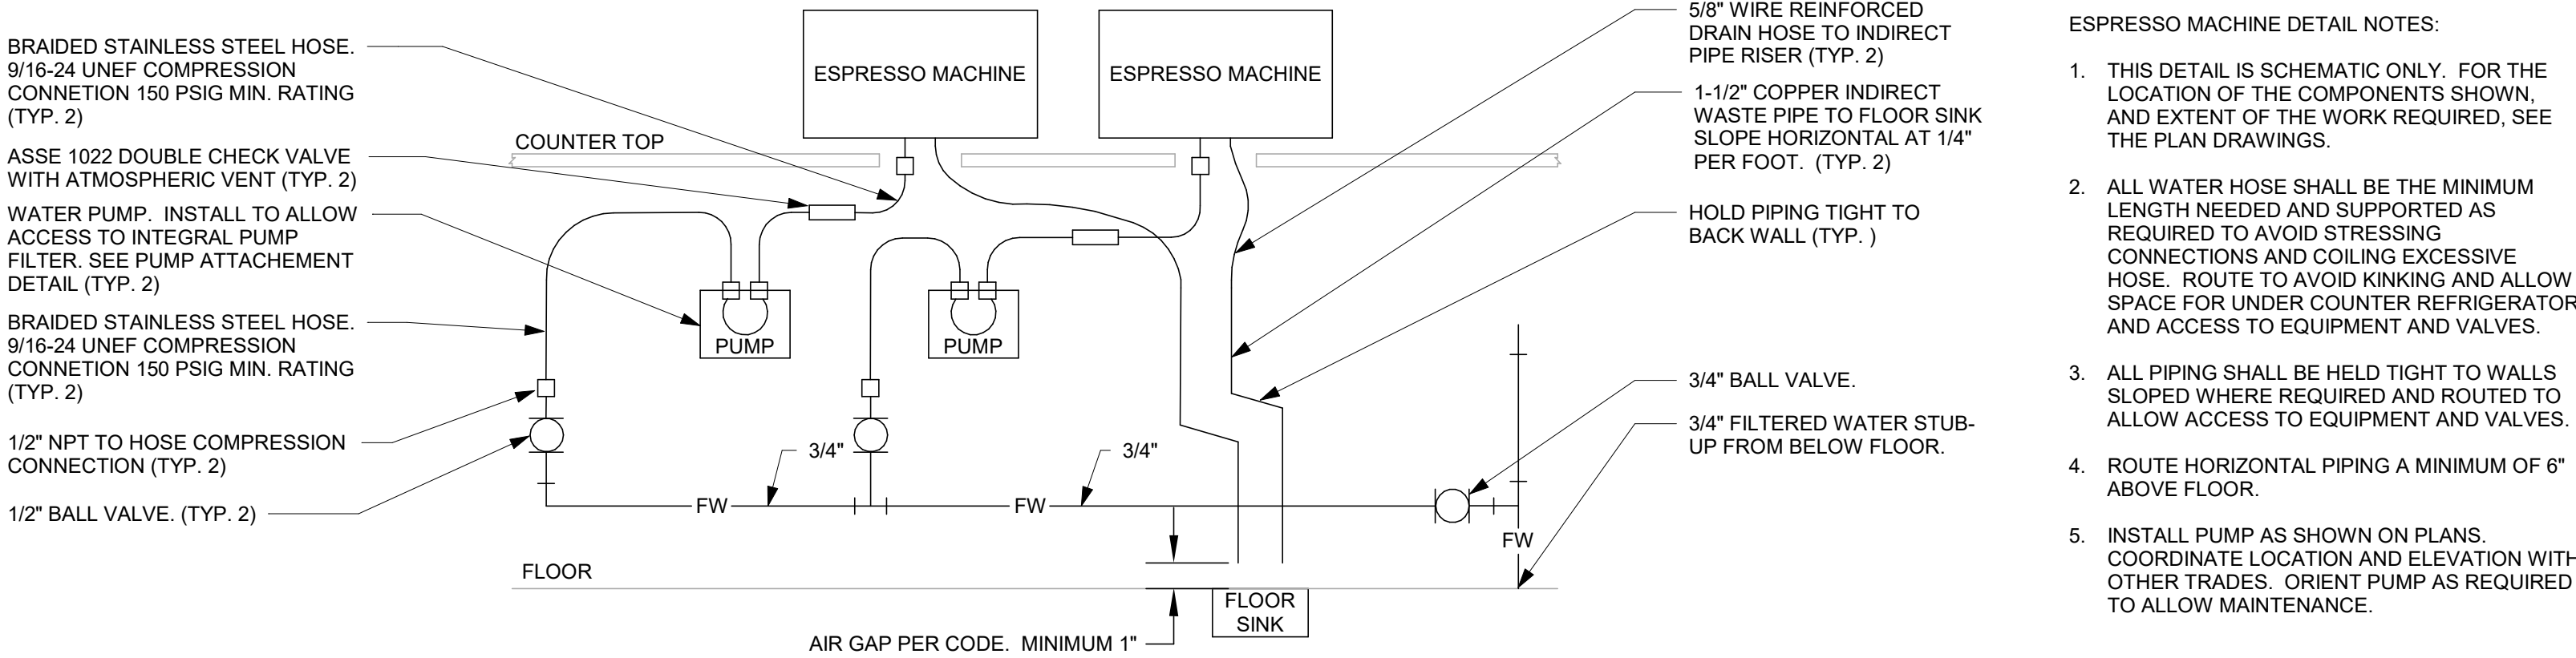


PROVIDE CLEANOUT WITH ADJUSTABLE CLEANOUT TOP WITH VARIATIONS SUITABLE FOR FLOOR COVERING (CARPET MARKER, RECESSED FOR TILE, SCORRIATED FOR UNFINISHED FLOORS). CLEAN THE TOP OF EXPOSED FCO AFTER INSTALLATION.

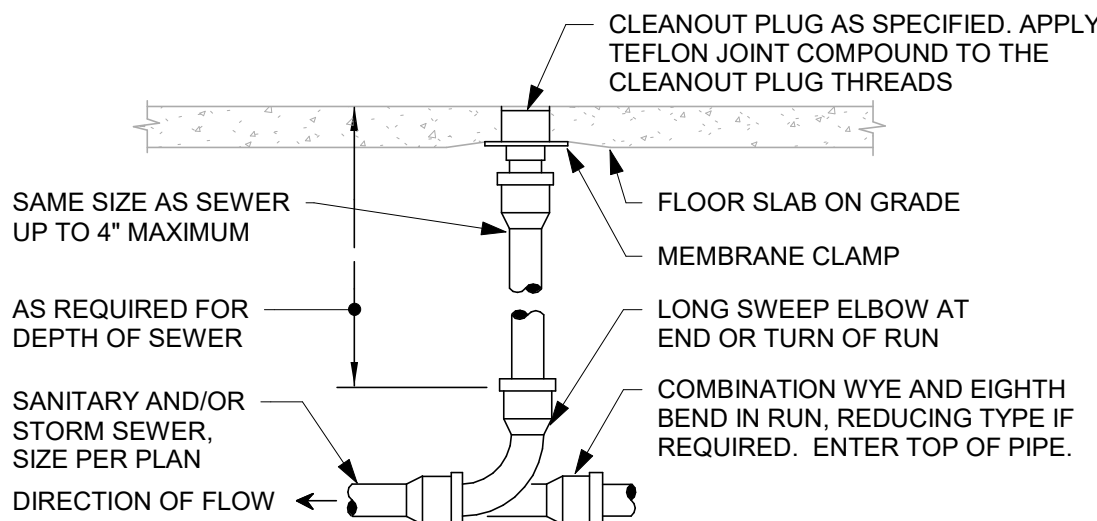

REFER TO SPECIFICATIONS AND SCHEDULE FOR MORE INFORMATION. LOCATE AT BUILDING EXIT, AT ENDS OF RUNS, AT TURNS OF PIPE GREATER THAN 45°, AT 50' INTERVALS ON STRAIGHT RUNS, AND/OR WHERE SHOWN ON PLANS AND RISERS. PROVIDE BACKFILL PER ARCHITECTURAL SPECIFICATIONS. LOCATE CLEANOUT WHERE THERE IS 18" CLEAR AROUND, FOR ACCESSIBILITY. CONSULT LOCAL CODES AND OFFICIALS FOR OTHER REQUIREMENTS.

2 FLOOR CLEANOUT


Scale: 1/4" = 1'-0"

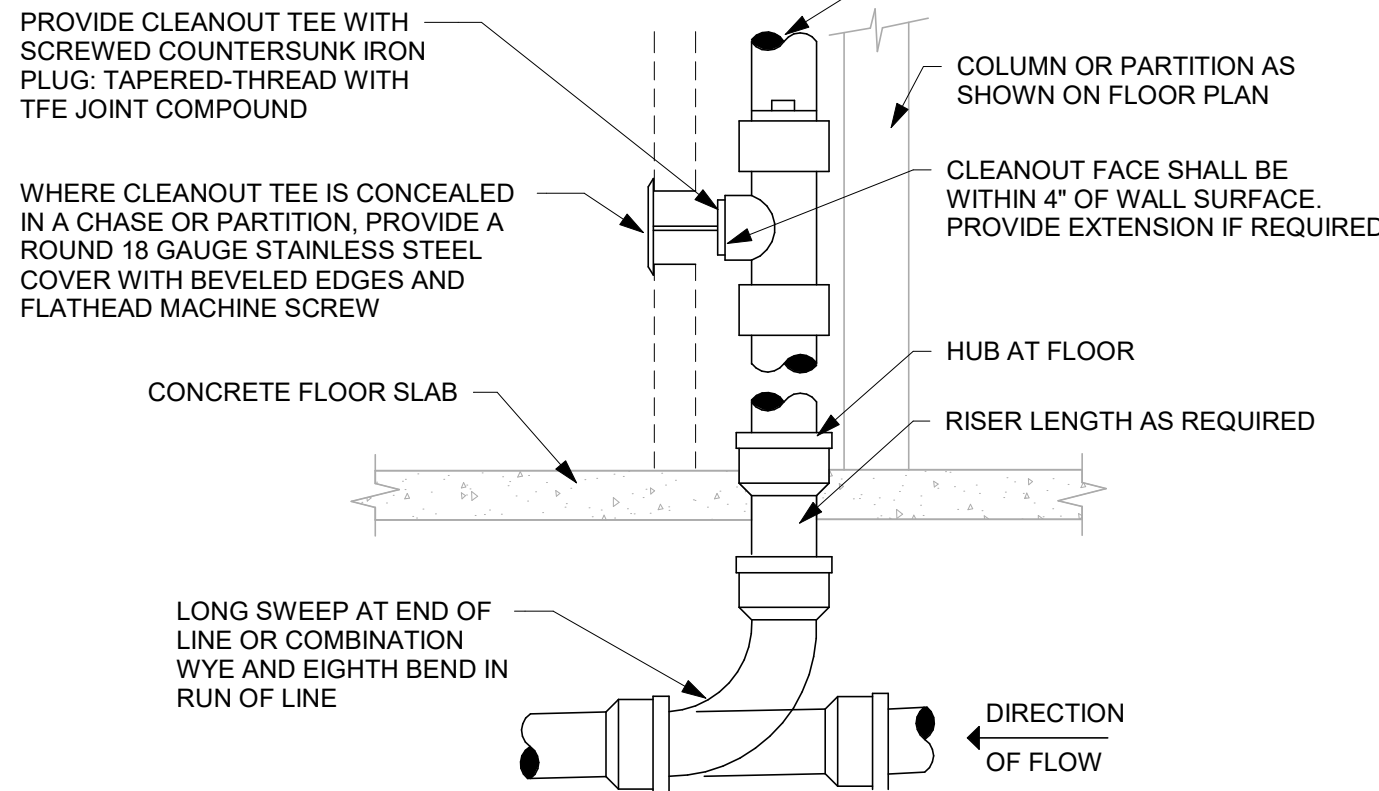

PROVIDE WALL CLEANOUT AT BASE OF ALL RAIN-LEADER DOWNSPOUTS. PROVIDE WALL CLEANOUT WHERE SHOWN ON PLAN, AND ON SANITARY WASTE BRANCHES NOT SERVED WITH FLOOR CLEANOUT. LOCATE ABOVE FIXTURE FLOOD RIM WITHIN 4' OF FLOOR. CONSULT LOCAL CODES FOR OTHER WALL CLEANOUT REQUIREMENTS.

4 WALL CLEANOUT

Scale: 1/4" = 1'-0"

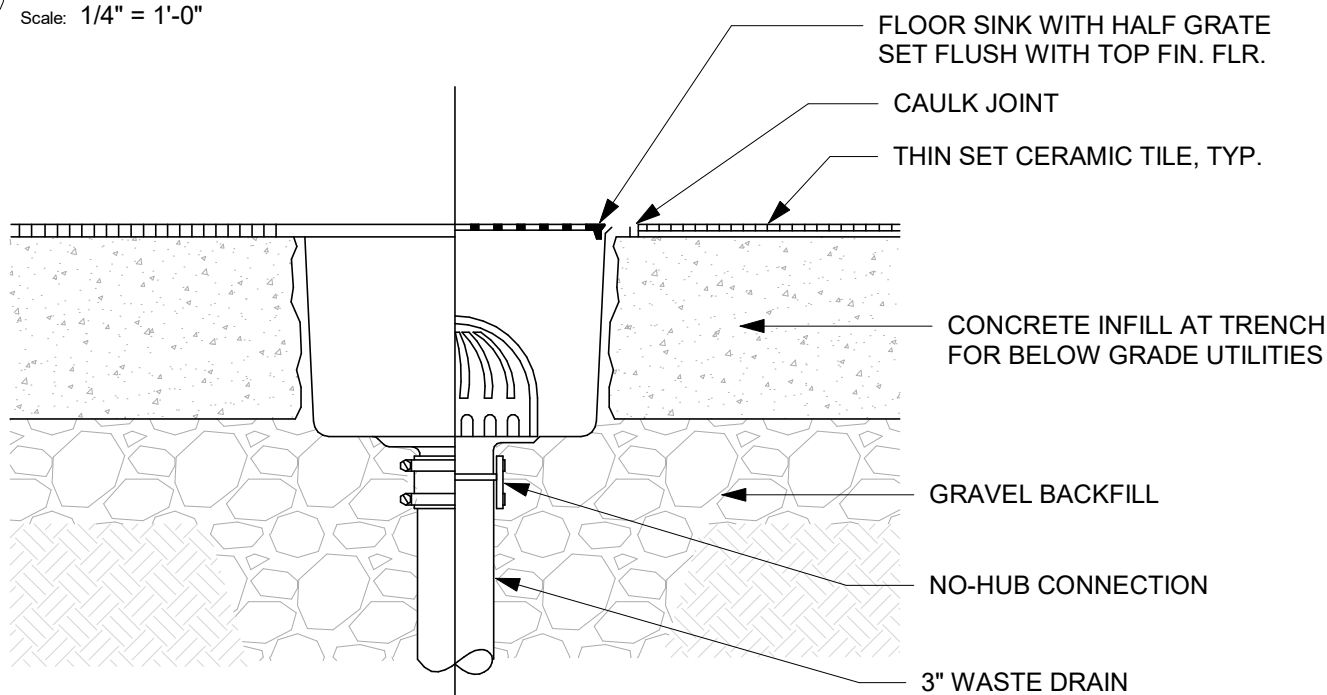

3 FLOOR SINK DETAIL

Scale: 1/4" = 1'-0"

ESPRESSO MACHINE DETAIL NOTES:

- THIS DETAIL IS SCHEMATIC ONLY. FOR THE LOCATION OF THE COMPONENTS SHOWN, AND EXTENT OF THE WORK REQUIRED, SEE THE PLAN DRAWINGS.
- ALL WATER HOSE SHALL BE THE MINIMUM LENGTH NEEDED AND SUPPORTED AS REQUIRED TO AVOID STRESSING CONNECTIONS AND COILING EXCESSIVE HOSE. ROUTE TO AVOID KINKING AND ALLOW SPACE FOR UNDER COUNTER REFRIGERATOR AND ACCESS TO EQUIPMENT AND VALVES.
- ALL PIPING SHALL BE HELD TIGHT TO WALLS SLOPED WHERE REQUIRED AND ROUTED TO ALLOW ACCESS TO EQUIPMENT AND VALVES.
- ROUTE HORIZONTAL PIPING A MINIMUM OF 6" ABOVE FLOOR.
- INSTALL PUMP AS SHOWN ON PLANS. COORDINATE LOCATION AND ELEVATION WITH OTHER TRADES. ORIENT PUMP AS REQUIRED TO ALLOW MAINTENANCE.

FOR CONSTRUCTION



© 2019 STARBUCKS COFFEE COMPANY

STARBUCKS®
2401 UTAH AVENUE SOUTH
SEATTLE, WASHINGTON 98134
(206) 318-1575


THESE DRAWINGS AND THE PROJECT MANUAL ARE CONFIDENTIAL AND SHALL REMAIN THE SOLE PROPERTY OF STARBUCKS CORPORATION, WHICH IS THE OWNER OF THE COPYRIGHT IN THIS WORK. THEY SHALL NOT BE REPRODUCED IN WHOLE OR IN PART, SHARED WITH THIRD PARTIES OR USED IN ANY MANNER ON OTHER PROJECTS OR EXTENSIONS TO THIS PROJECT WITHOUT THE PRIOR WRITTEN CONSENT OF STARBUCKS CORPORATION. THESE DRAWINGS AND SPECIFICATIONS ARE INTENDED TO EXPRESS DESIGN INTENT FOR A PROTOTYPICAL STARBUCKS STORE (WHICH IS SUBJECT TO CHANGE AT ANYTIME) AND DO NOT REFLECT ACTUAL SITE CONDITIONS. NEITHER PARTY SHALL HAVE ANY OBLIGATION NOR LIABILITY TO THE OTHER (EXCEPT STATED ABOVE) UNTIL A WRITTEN AGREEMENT IS FULLY EXECUTED BY BOTH PARTIES.

STARBUCKS TEMPLATE VERSION: i2023-05-01

Design Forum Architects Inc.

2956 Byers Rd
Miamisburg, OH 45342
Tel: (844) 804-7700

Donald J. Bethman
Architect in Charge

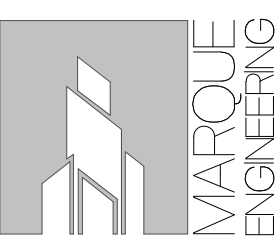

4850 SMITH RD., STE. 101
CINCINNATI, OH 45212
513.901.0040
WWW.MARQUEENG.COM

PROJECT NAME:
S SEMORAN BLVD & LEE VISTA BLVD

PROJECT ADDRESS:
6605 S SEMORAN BLVD, ORLANDO, FL 32822

STORE #: 9875
PROJECT #: 25630-101
ISSUE DATE: 03/04/2024
DESIGN MANAGER: MARTIN PEREZ
PRODUCTION DESIGNER: ANDY MCLOUD
CHECKED BY: EVAN DUFFY


Revision Schedule				
Rev	Date	By	Description	

SHEET TITLE:
PLUMBING DETAILS


SCALE: 1/4" = 1'-0"

SHEET NUMBER:


P501

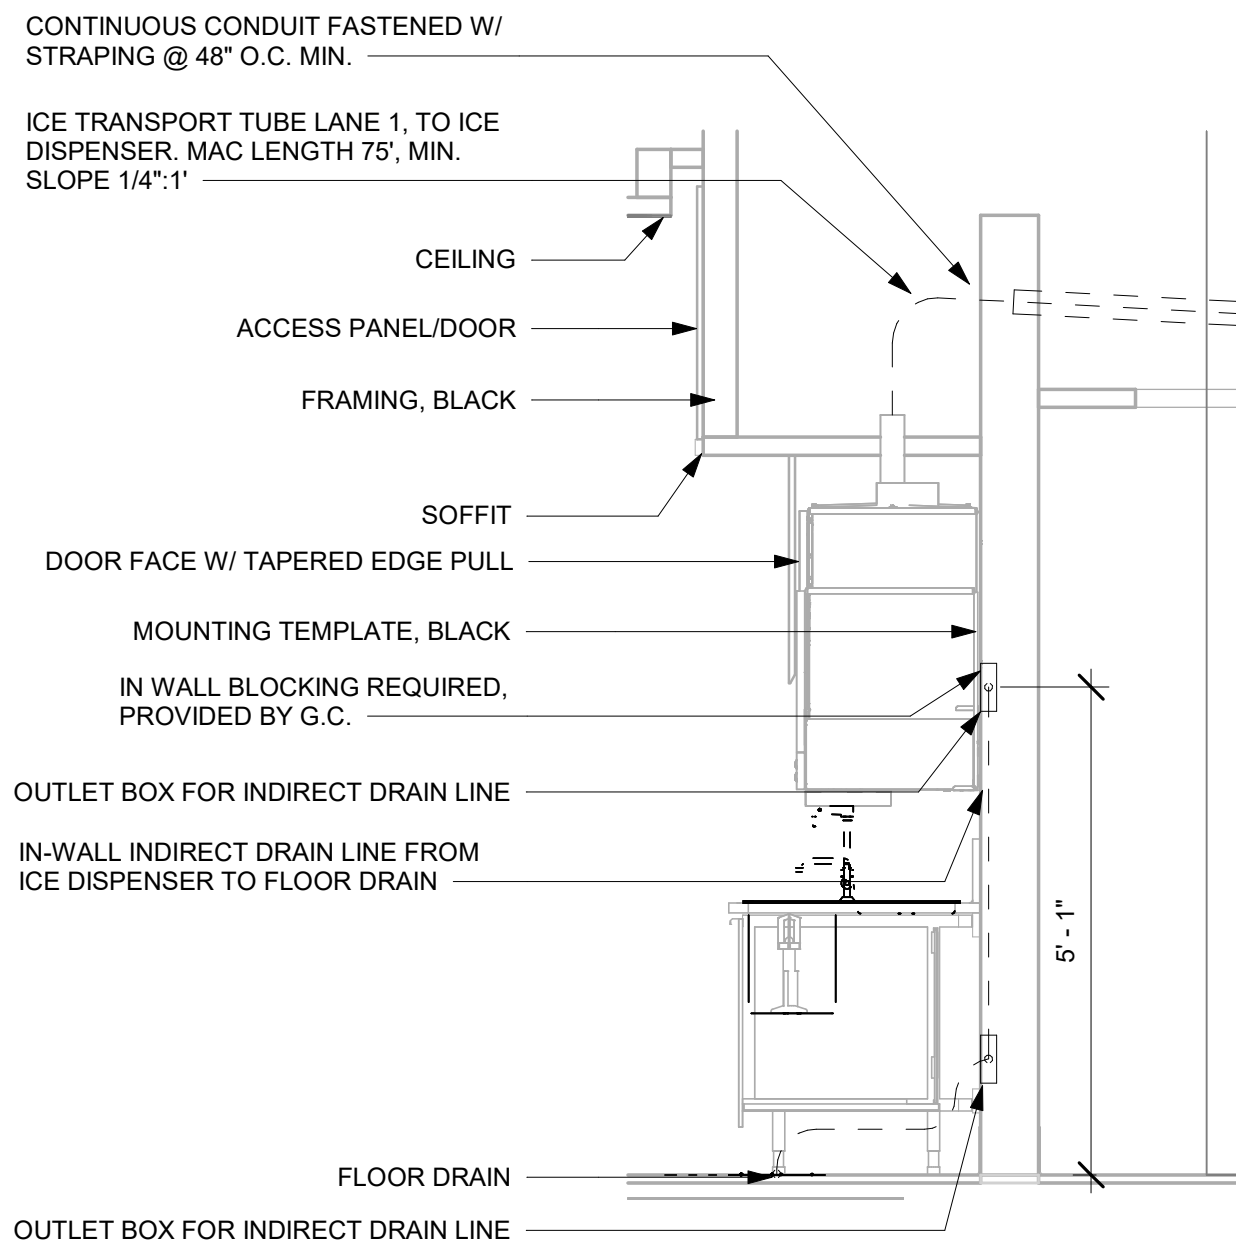


4 SECTION A - PLUMBING DRIAGRAM
Scale: 1/2" = 1'-0"

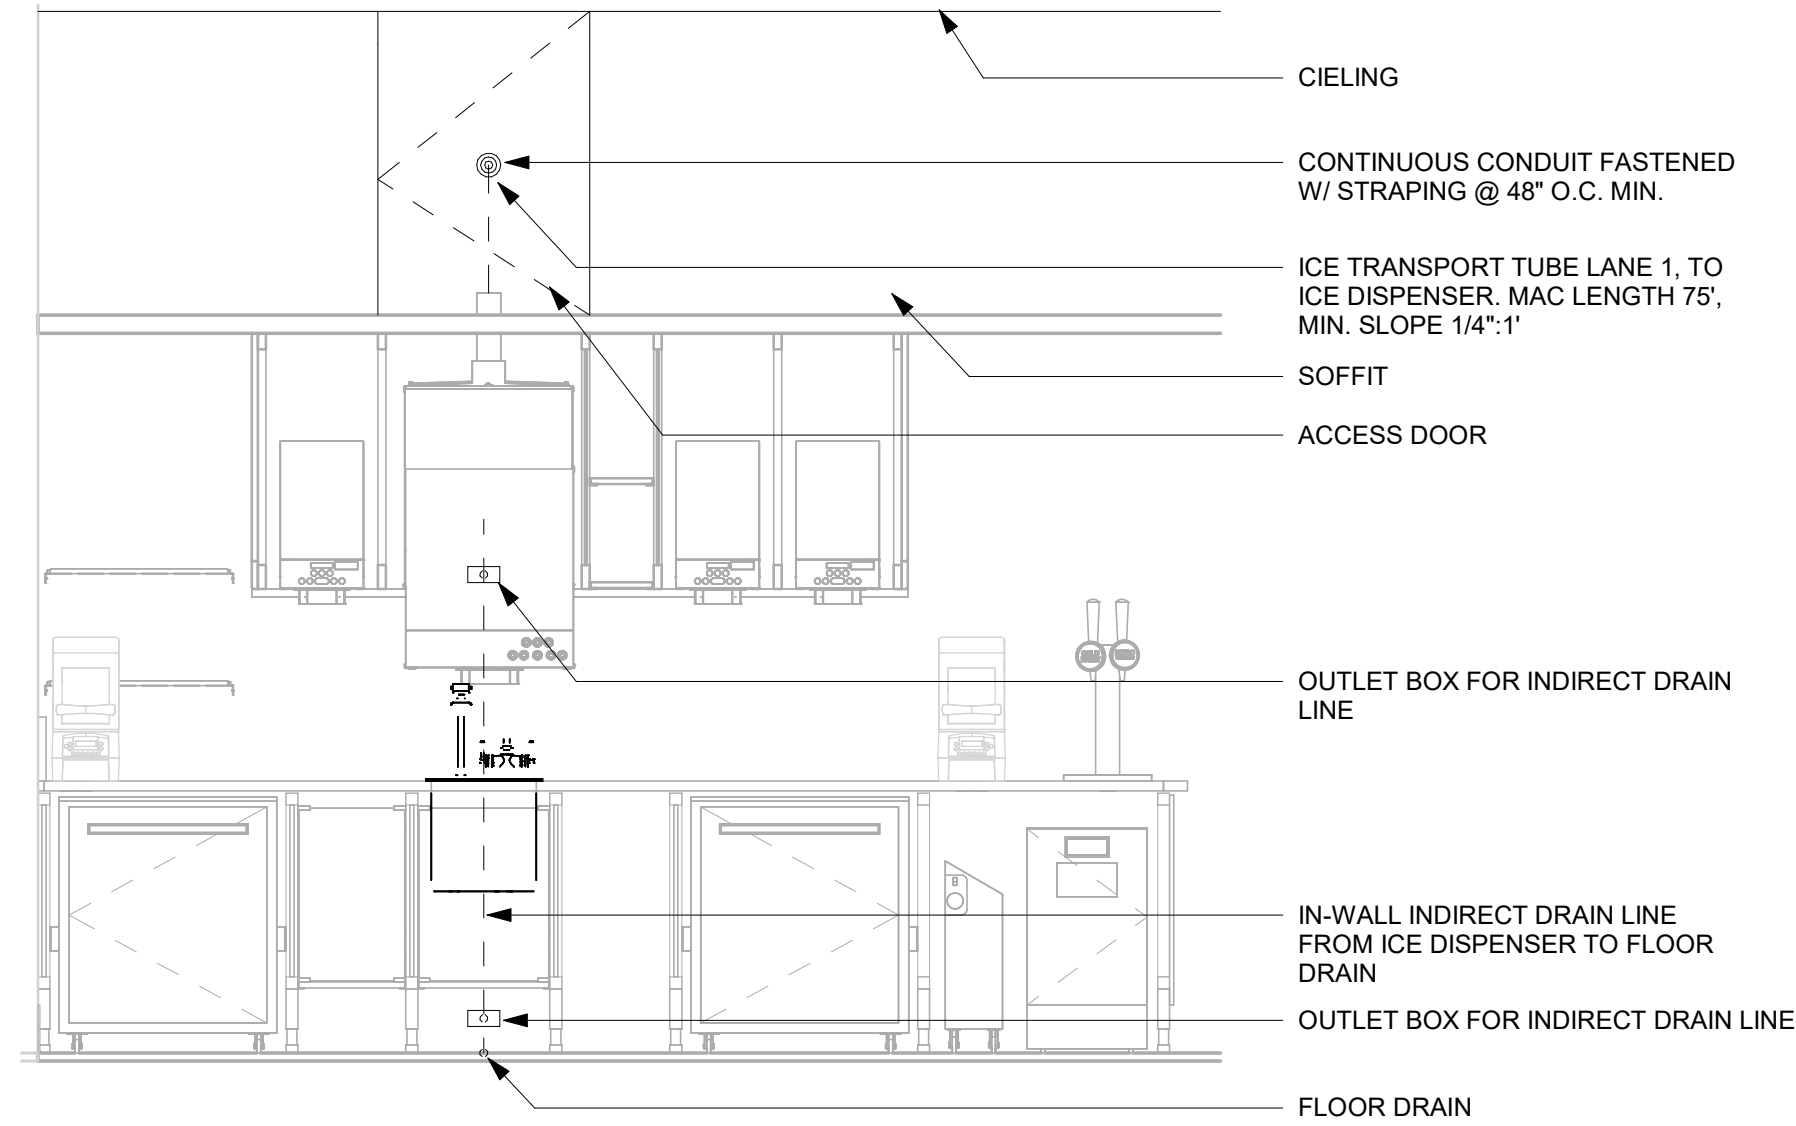


3 ELEVATION - PLUMBING DIAGRAM
Scale: 1/2" = 1'-0"

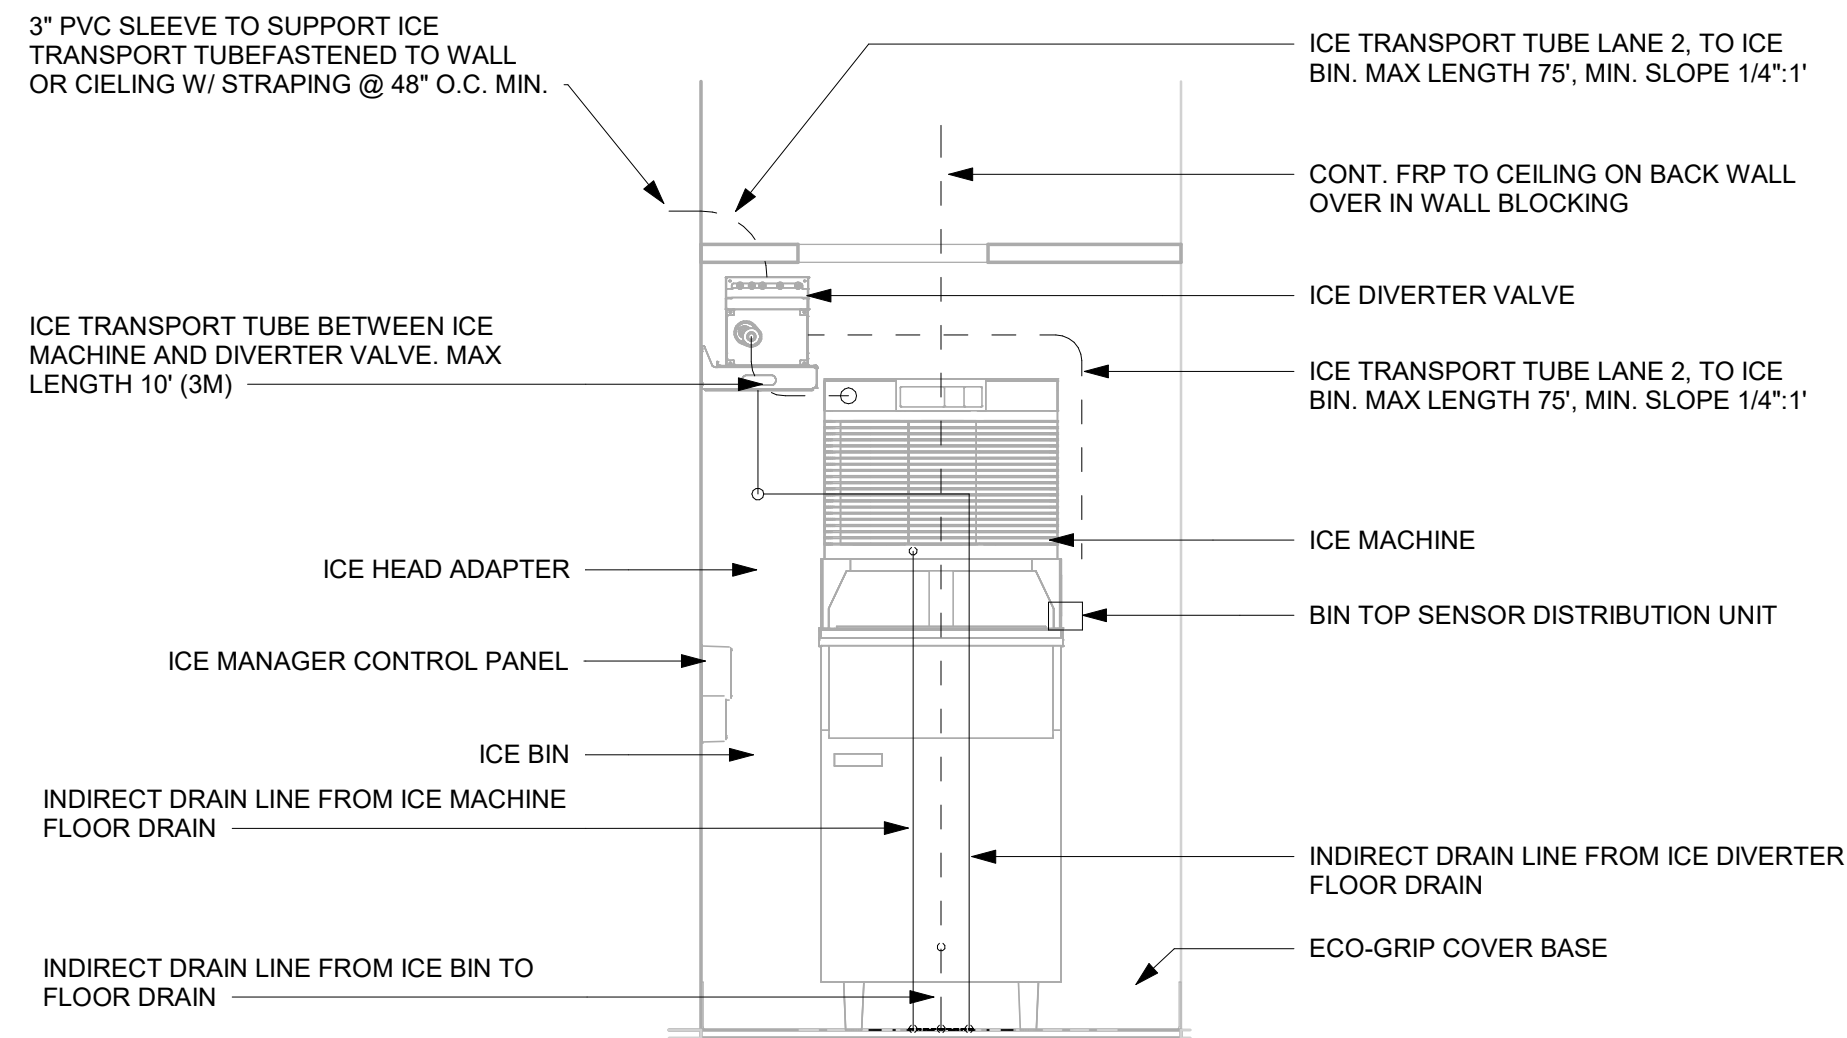

5 ELEVATION - PLUMBING DIAGRAM
Scale: 1/2" = 1'-0"

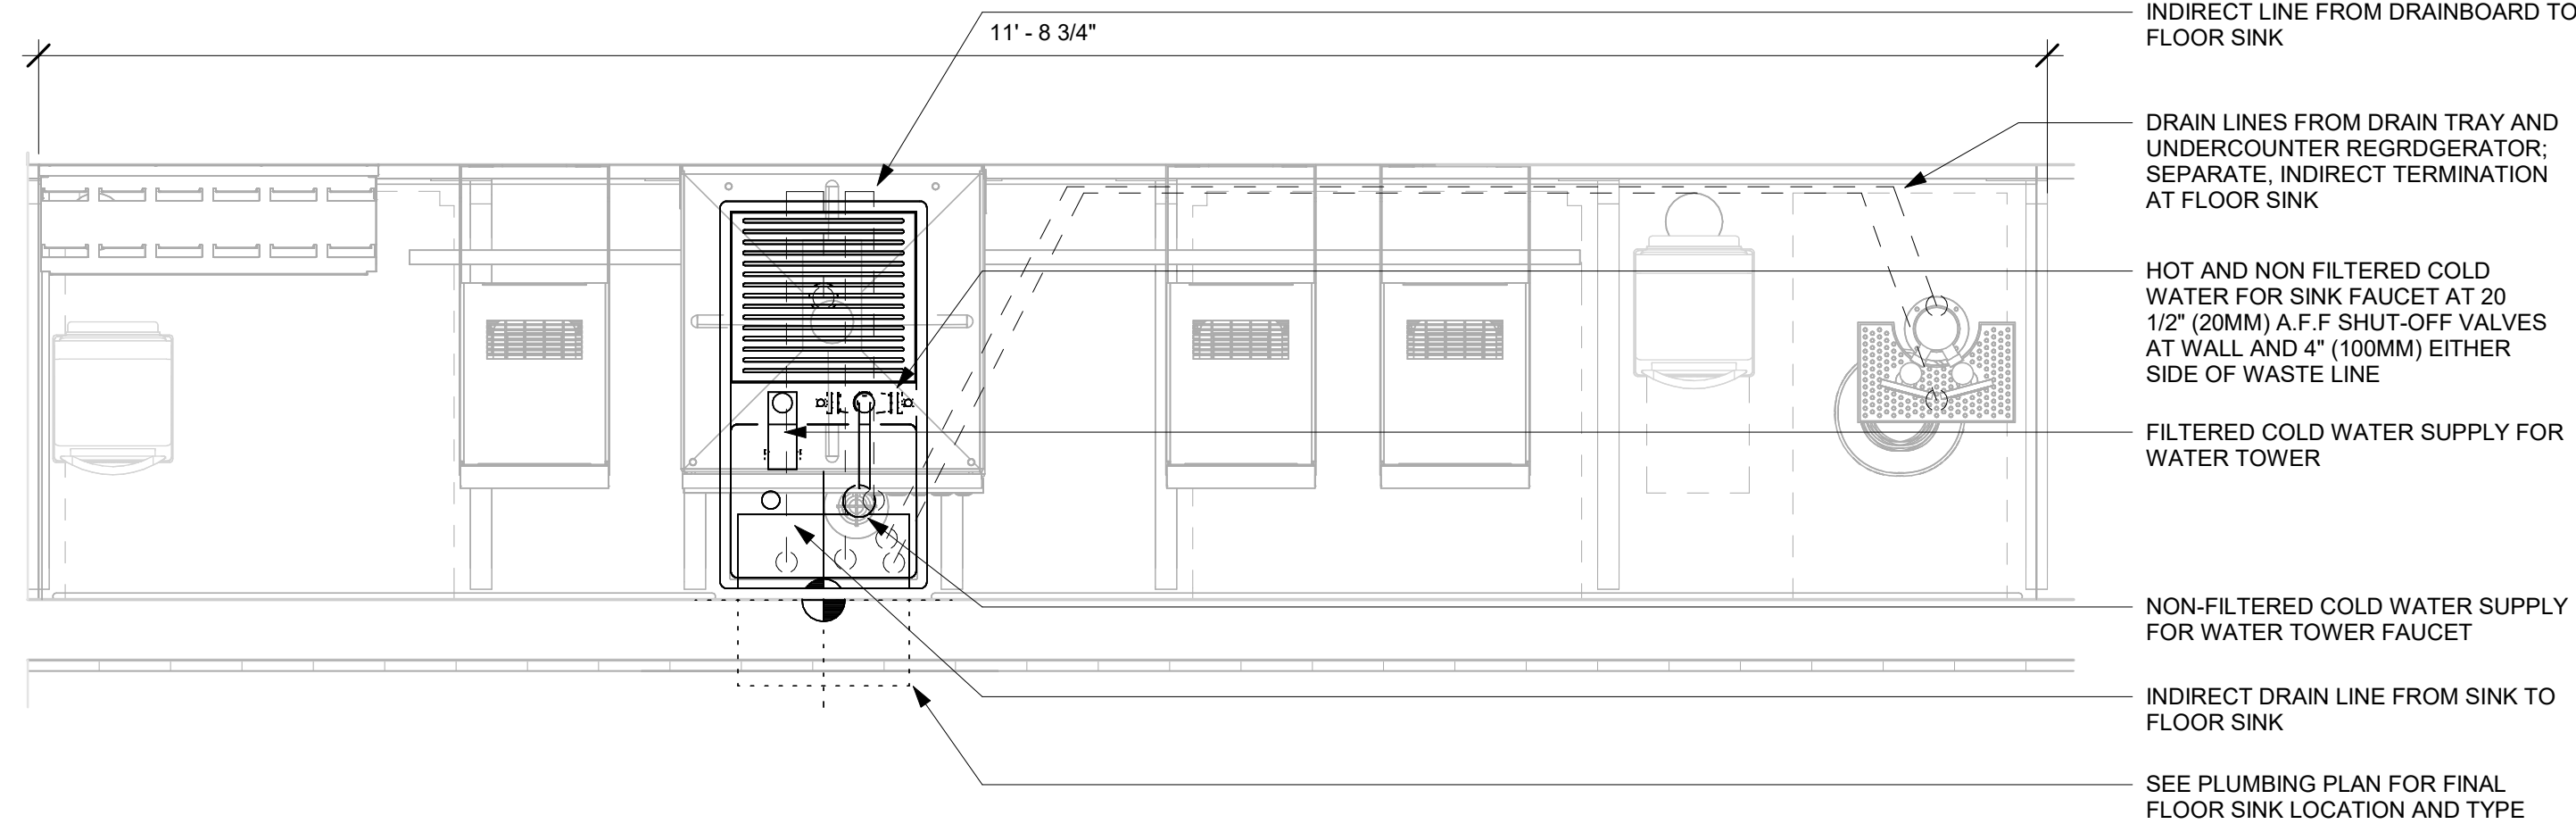

1 ICE DISPENSER DETAIL
Scale: 1" = 1'-0"

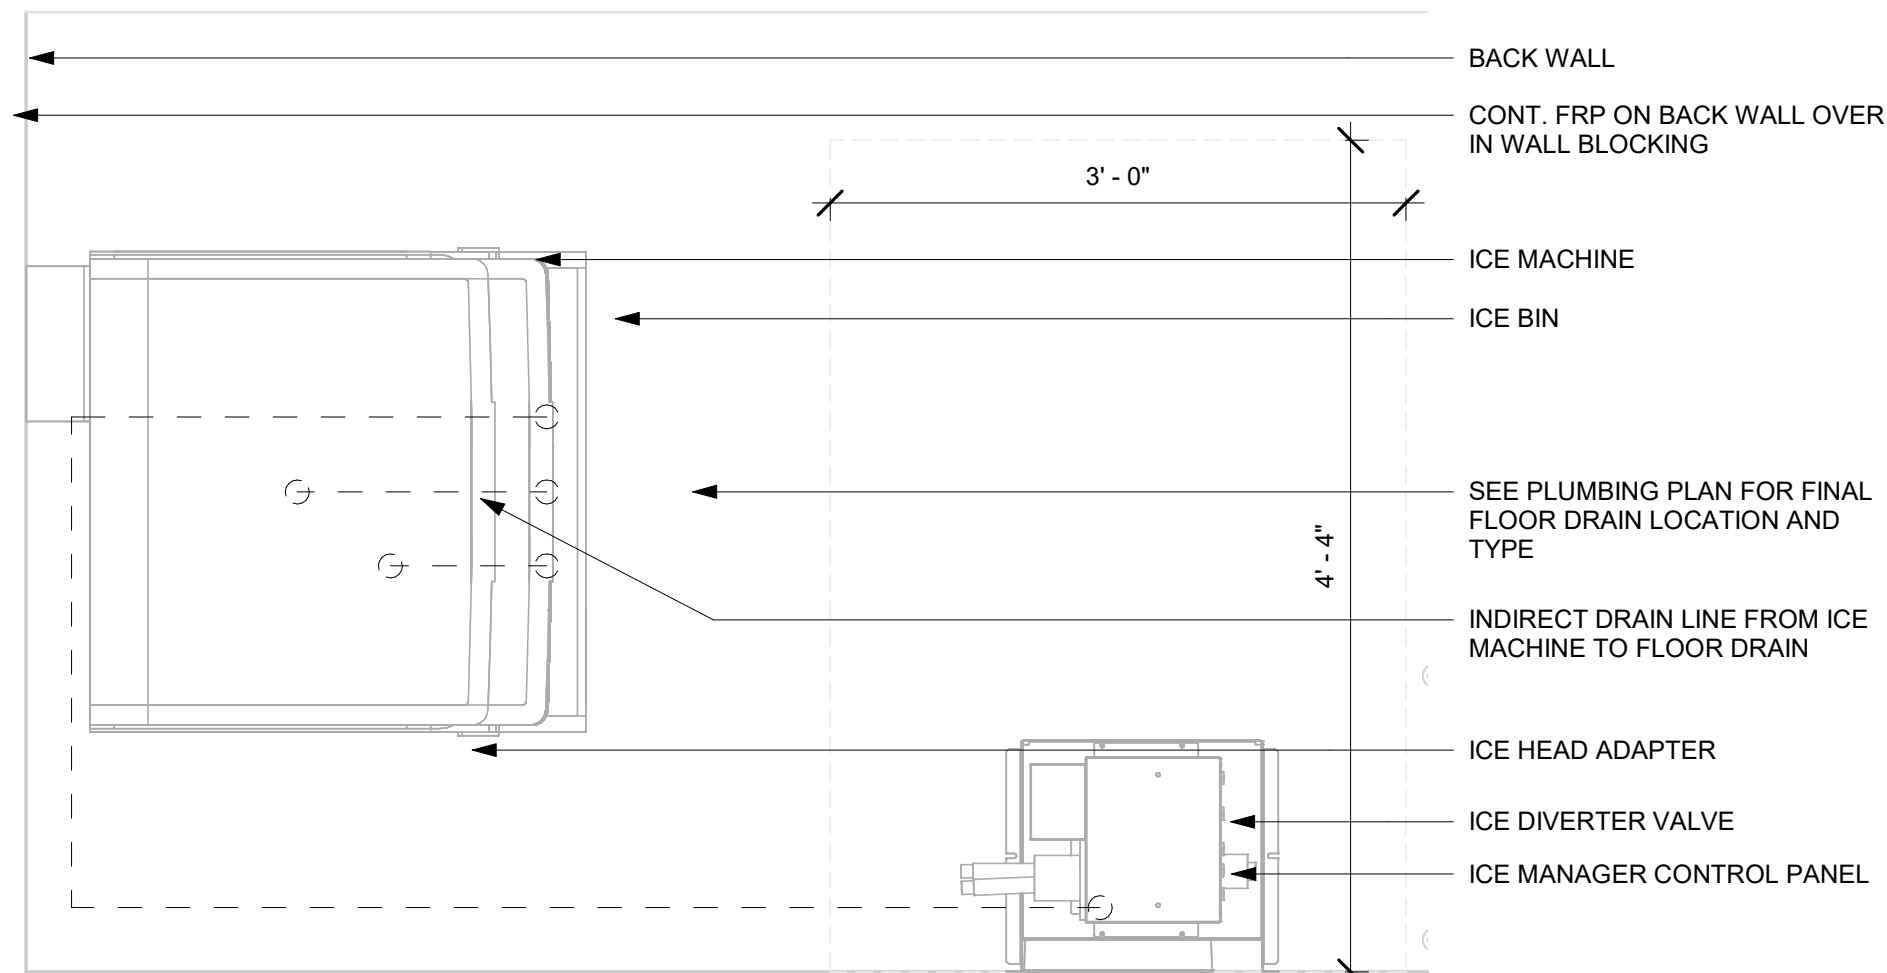

2 ICE MACHINE WITH DIVERTER DETAIL
Scale: 1" = 1'-0"



© 2019 STARBUCKS COFFEE COMPANY

STARBUCKS®
2401 UTAH AVENUE SOUTH
SEATTLE, WASHINGTON 98134
(206) 318-1575


THESE DRAWINGS AND THE PROJECT MANUAL ARE CONFIDENTIAL AND SHALL REMAIN THE SOLE PROPERTY OF STARBUCKS CORPORATION, WHICH IS THE OWNER OF THE COPYRIGHT IN THIS WORK. THEY SHALL NOT BE REPRODUCED IN WHOLE OR IN PART, SHARED WITH THIRD PARTIES OR USED IN ANY MANNER ON OTHER PROJECTS OR EXTENSIONS TO THIS PROJECT WITHOUT THE PRIOR WRITTEN CONSENT OF STARBUCKS CORPORATION. THESE DRAWINGS AND SPECIFICATIONS ARE INTENDED TO EXPRESS DESIGN INTENT FOR A PROTOTYPICAL STARBUCKS STORE (WHICH IS SUBJECT TO CHANGE AT ANYTIME) AND DO NOT REFLECT ACTUAL SITE CONDITIONS. NEITHER PARTY SHALL HAVE ANY OBLIGATION NOR LIABILITY TO THE OTHER (EXCEPT STATED ABOVE) UNTIL A WRITTEN AGREEMENT IS FULLY EXECUTED BY BOTH PARTIES.

STARBUCKS TEMPLATE VERSION: i2023-05-01

Design Forum Architects Inc.

2056 Byers Rd
Miamisburg, OH 45342
Tel: (844) 804-7700

Donald J. Bethman
Architect in Charge

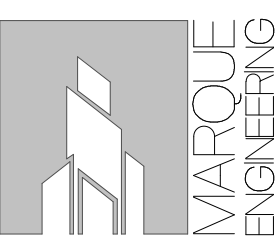

4850 SMITH RD., STE. 101
CINCINNATI, OH 45212
513.901.0040
WWW.MARQUEENG.COM

FOR CONSTRUCTION

PROJECT NAME:
S SEMORAN BLVD & LEE VISTA BLVD

PROJECT ADDRESS:
**6605 S SEMORAN BLVD,
ORLANDO, FL 32822**

STORE #: 9875
PROJECT #: 25630-101
ISSUE DATE: 03/04/2024
DESIGN MANAGER: MARTIN PEREZ
PRODUCTION DESIGNER: ANDY MCLOUD
CHECKED BY: EVAN DUFFY


Revision Schedule			
Rev	Date	By	Description

SHEET TITLE:
PLUMBING DETAILS

SCALE: As indicated

SHEET NUMBER:

P502

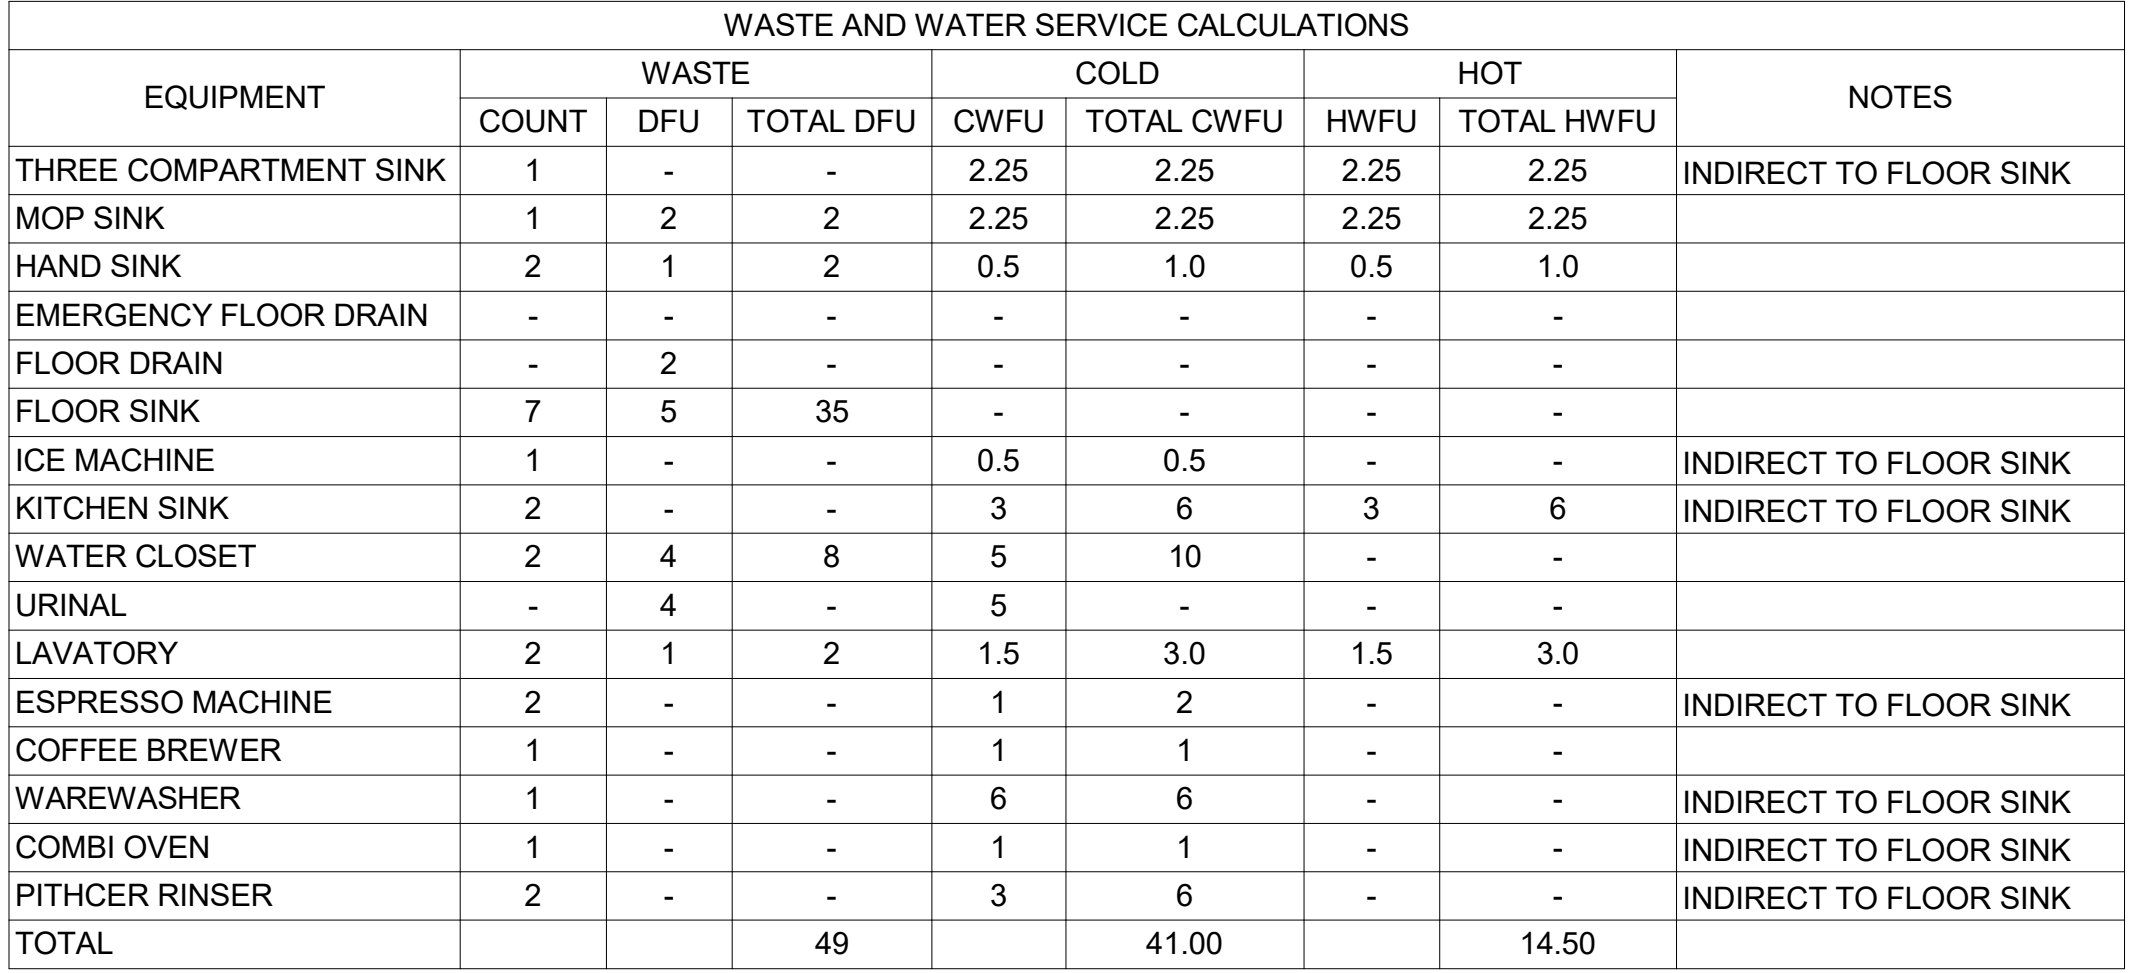


THESE DRAWINGS AND THE PROJECT MANUAL ARE CONFIDENTIAL, AND SHALL REMAIN THE SOLE PROPERTY OF STARBUCKS CORPORATION, WHICH IS THE OWNER OF THE COPYRIGHT IN THE WORK. THEY SHALL NOT BE REPRODUCED (IN WHOLE OR IN PART), SHARED WITH THIRD PARTIES OR USED IN ANY MANNER ON OTHER PROJECTS OR EXTENSIONS TO THIS PROJECT WITHOUT THE PRIOR WRITTEN CONSENT OF STARBUCKS CORPORATION. THESE DRAWINGS AND SPECIFICATIONS ARE INTENDED TO EXPRESS DESIGN INTENT, NOT A PLOT OR A CONTRACT, AND ARE NOT TO BE USED (OR SUBJECT TO CHANGE AT ANYTIME) AND DO NOT REFLECT ACTUAL SITE CONDITIONS. NEITHER PARTY SHALL HAVE ANY OBLIGATION NOR LIABILITY TO THE OTHER (EXCEPT STATED ABOVE) UNTIL A WRITTEN AGREEMENT IS FULLY EXECUTED BY BOTH PARTIES.

STARBUCKS TEMPLATE VERSION: i2023-05-01

**Design Forum
Architects Inc.**

2056 Byers Rd
Miamisburg, OH 45342
Tel: (844) 804-7700

Donald J. Rethman
Architect In Charge

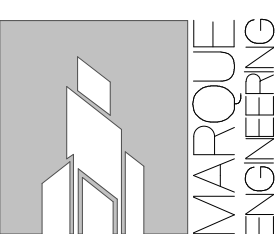

4850 SMITH RD., STE. 101
CINCINNATI, OH 45212
513.901.0040
WWW.MARQUEENG.COM

FOR CONSTRUCTION

PROJECT NAME:
S SEMORAN BLVD &
LEE VISTA BLVD

PROJECT ADDRESS:
6605 S SEMORAN BLVD,
ORLANDO, FL 32822

STORE #: 9875
PROJECT #: 25630-101
ISSUE DATE: 03/04/2024
DESIGN MANAGER: MARTIN PER
PRODUCTION DESIGNER: ANDY MCLOU
CHECKED BY: EVAN DUFFY

Revision Schedule			
Rev	Date	By	Description

SHEET TITLE:
PLUMBING ISOMETRICS

SCALE

SHEET NUMBER

P601

ABBREVIATIONS


AFF	ABOVE FINISHED FLOOR
AHJ	AUTHORITIES HAVING JURISDICTION
APPROX	APPROXIMATE
BLDG	BUILDING
CO2	CARBON DIOXIDE
CD	CEILING DIFFUSER
CLG	CEILING
CONST	CONSTRUCTION
CXA	COMMISSIONING AGENT
DEG	DEGREES
DM	STARBUCKS DESIGN MANAGER
DN	DOWN
DTL	DETAIL
DWG(S)	DRAWING(S)
EA	EACH
EC	ELECTRICAL CONTRACTOR
ECP	EQUIPMENT CONTROL PAC
EG	EXHAUST GRILLE
ELEC	ELECTRICAL
EM	EMERGENCY
EMS	ENERGY MANAGEMENT SYSTEM
EXIST	EXISTING
EXT	EXTERIOR
F&I	FURNISH & INSTALL
FOIC	FURNISHED BY OWNER, INSTALLED BY CONTRACTOR
FOIO	FURNISHED BY OWNER, INSTALLED BY OWNER
FLR	FLOOR
FT	FOOT/FEET
G	GAS PIPING
GC	GENERAL CONTRACTOR
HR	HOOR
HVAC	HEATING, VENTILATION, AIR CONDITIONING
I.D.	INSIDE DIAMETER
IAQ	INDOOR AIR QUALITY
LCP	LIGHTING CONTROL PANEL
LL	LANDLORD
LV	LOW VOLTAGE
MAX	MAXIMUM
MC	MECHANICAL CONTRACTOR
MECH	MECHANICAL
MEP	MECHANICAL, ELECTRICAL AND PLUMBING
MFG	MANUFACTURER
MNG	MINIMUM
NTS	NOT TO SCALE
O.D.	OUTSIDE DIMENSION
OSA	OUTSIDE AIR
REF	REFERENCE
REQ'D	REQUIRED
REV	REVISION
RT	ROOFTOP
SF	SQUARE FEET
SHT	SHEET
SPECS	SPECIFICATION(S)
SST	STAINLESS STEEL
TEMP	TEMPORARY
TYP	TYPICAL
UNO	UNLESS NOTED OTHERWISE
UC	UNDER COUNTER
WH	WATER HEATER
WSHP	WATER SOURCE HEAT PUMP

MECHANICAL SCOPE OF WORK SUMMARY

THE FOLLOWING SCOPE OF WORK IS BASED ON THE LANDLORD'S WORKLETTER EXHIBIT C. THIS SCOPE OF WORK IS NOT INTENDED TO INDICATE THE FULL SCOPE, BUT ONLY A BROAD SUMMARY. THE GENERAL CONTRACTOR SHALL REFERENCE THE COMPLETE WORKLETTER FOR A MORE DETAILED DESCRIPTION OF WORK BY BOTH PARTIES. ANY QUESTIONS REGARDING SCOPE SHALL BE BROUGHT TO STARBUCKS ATTENTION FOR CLARIFICATION. RESPONSIBILITY INDICATED BELOW MEANS FURNISHED, PERMITTED AND INSTALLED BY THE PARTY INDICATED.

WORK DESCRIPTION	RESPONSIBILITY	
	EXISTING	CONTRACTOR
HVAC UNITS, CURB AND STRUCTURAL	X	
HVAC UNIT ECONOMIZERS AND RELIEF	X	
SMOKE DETECTORS IN DUCTWORK AND INTERLOCK THERMOSTATS AND CONTROLS	X	X
EMS CONTROLS		X
MOTORIZED DAMPERS FOR BACKDRAFT	X	
EXHAUST FAN, CURB AND MOTORIZED DAMPER		X
AIR DEVICES		X
DUCTWORK 12" OR LARGER		X
DUCTWORK 10" OR SMALLER		X
DAMPERS FOR CONNECTIONS		X
GAS SERVICE AND METER	N/A	N/A
GAS PIPING TO SPACE	N/A	N/A
GAS PIPING TO HOT WATER TANK	N/A	N/A
GAS PIPING TO HVAC UNITS	N/A	N/A
LOUVERS FOR INTAKES, EXHAUST AND PRESSURE RELIEF	N/A	N/A

MECHANICAL SYMBOL LEGEND

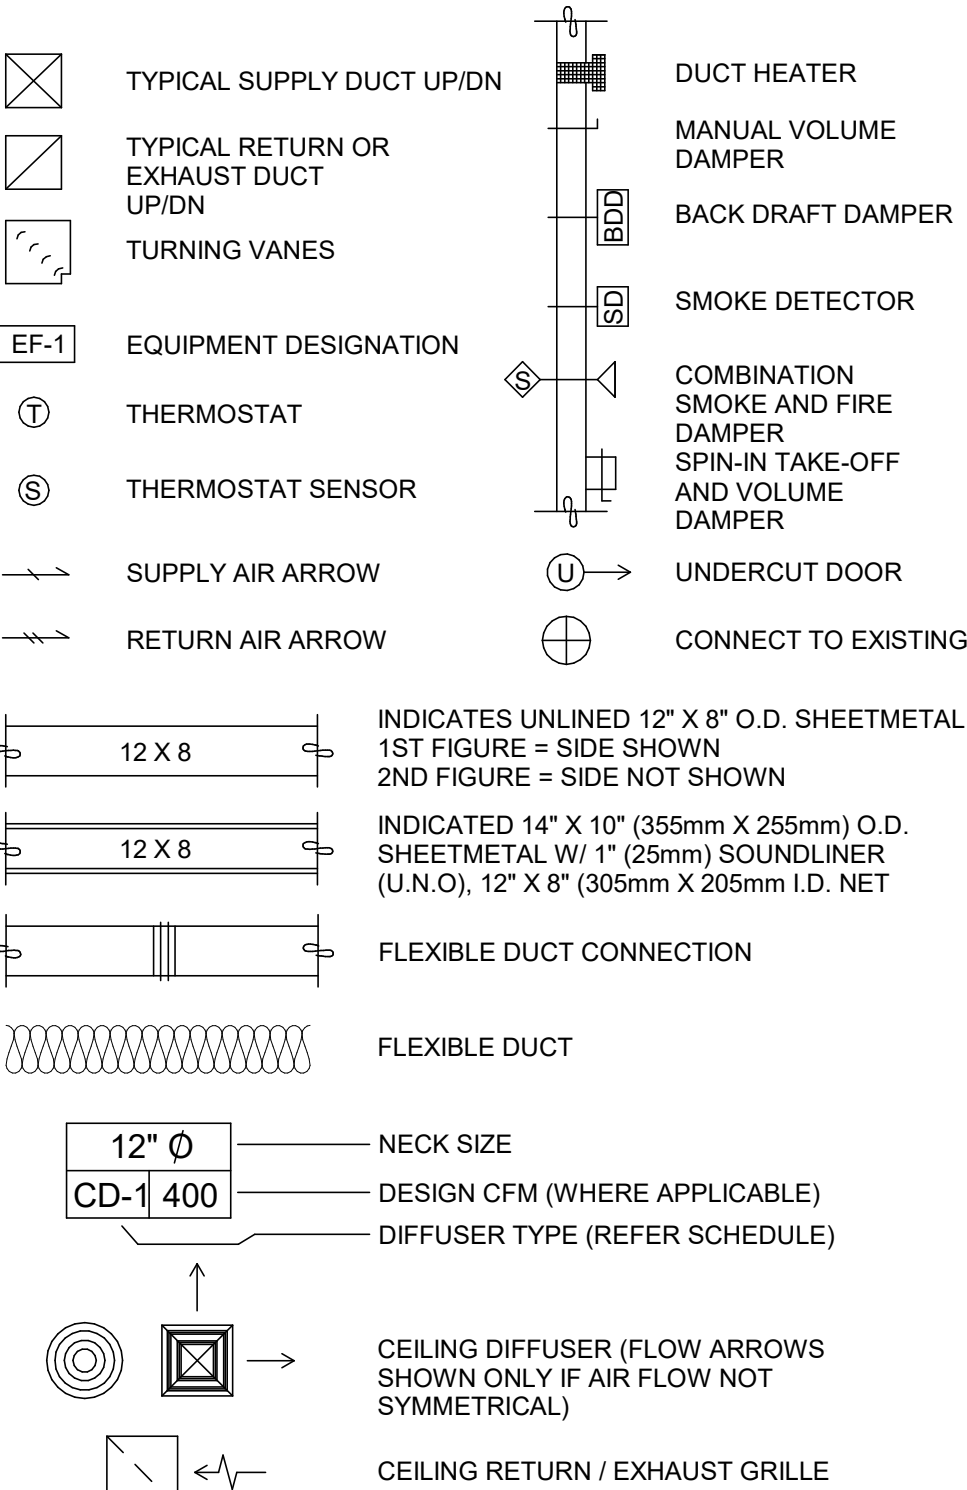

CONTROLS AND OPERATION NOTES

THE GENERAL CONTRACTOR SHALL FURNISH AND INSTALL THE FOLLOWING COMPONENTS:

CONTROL WIRING
THE MECHANICAL CONTRACTOR SHALL PROVIDE ALL CONTROL WIRING IN CONDUIT NECESSARY FOR THE COMPLETE AND PROPER OPERATING TEMPERATURE CONTROL SYSTEM INCLUDING ALL MODES OF OPERATION AND INTERLOCK.

EXHAUST FANS
RESTROOM EXHAUST FAN(S) TO BE OPERATED IN CONJUNCTION WITH STORE HOURS UNLESS OTHERWISE NOTED OR APPROVED OR AS REQUIRED BY JURISDICTION (COORDINATE WITH ELECTRICAL).

THERMOSTAT
PERMANENT THERMOSTAT(S) AND REMOTE SENSOR(S) SHALL BE FURNISHED AND INSTALLED. ONE THERMOSTAT AND SENSOR IS PROVIDED FOR EACH UNIT. MOUNT THERMOSTAT(S) AND SENSOR(S) IN LOCATION & HEIGHT AS INDICATED ON DRAWINGS. MECHANICAL CONTRACTOR TO PROVIDE THERMOSTAT IDENTIFICATION LABELS PER SPECIFICATION REQUIREMENTS. REFER TO THERMOSTAT SETUP INSTRUCTIONS BELOW FOR ADDITIONAL REQUIREMENTS.

THERMOSTAT SETUP INSTRUCTIONS

PROVIDE THE FOLLOWING SETUP AND PROGRAMMING:

- CONFIGURE AS FOLLOWS:
 - DEGREES "F" DISPLAY
 - 12 HOUR CLOCK
 - CONTINUOUS FAN OPERATION IN OCCUPIED MODE
 - DISABLE KEYBOARD PROGRAMMING
- SET TIME AND DATE.
- SET TO DISPLAY CURRENT TEMPERATURE.
- SET OCCUPIED START TIME AT 30 MIN. BEFORE OPENING. SET UNOCCUPIED START TIME AT 30 MIN. AFTER CLOSING. VERIFY HOURS WITH STORE MANAGER OR CONSTRUCTION MANAGER.
- SET POINTS SHALL BE AS FOLLOWS OR AS APPROPRIATE FOR CLIMATE:
 - OCCUPIED (5° F DEADBAND) (3° C DEADBAND)
 - HEATING: 70° F (21° C)
 - COOLING: 75° F (24° C)
 - UNOCCUPIED
 - HEATING: 60° F (15° C)
 - COOLING: 78° F (25° C)
- SET TWO (2) HOUR OCCUPIED OVERRIDE FUNCTION TO PROVIDE THE FOLLOWING SET POINT OVERRIDES:
 - HEATING: +2° F (1° C)
 - COOLING: -2° F (1° C)

HVAC EQUIPMENT AND MATERIALS

FILTERS
IF OPERATING HVAC DURING CONSTRUCTION, PROVIDE THREE (3) SETS OF 2" (51MM) MERV6 PLEATED DISPOSABLE FILTERS (OR HIGHER RATING IF REQUIRED BY LEED). USE ONE SET UNTIL COMPLETION OF CONSTRUCTION. INSTALL ONE SET AT COMPLETION OF CONSTRUCTION (PRIOR TO TAB) AND DELIVER ONE SET OF MERV13 FILTERS TO STARBUCKS LABELED TO DENOTE THEIR RESPECTIVE AIR HANDLING UNIT.

BRACING AND ANCHORING
ALL MECHANICAL EQUIPMENT, FIXED OR FLEXIBLY MOUNTED, SHALL BE BRACED OR ANCHORED TO COMPLY WITH LOCAL CODES.

DUCTWORK AND ACCESSORIES

SHEET METAL DUCTWORK
ASSEMBLE AND INSTALL DUCTWORK IN ACCORDANCE WITH RECOGNIZED INDUSTRY PRACTICE FOR ACHIEVING AIR TIGHT (5% LEAKAGE) AND NOISELESS (NO OBJECTIONABLE NOISE) SYSTEMS. NO VARIATION OF DUCT CONFIGURATION OR SIZES WILL BE PERMITTED EXCEPT BY PERMISSION FROM THE ENGINEER.

DAMPERS
PROVIDE CONVENIENTLY LOCATED ACCESS DOORS OF AMPLE SIZE AND QUANTITY FOR SERVICING THE DAMPERS. PROVIDE MOTORIZED DAMPERS AT ALL INTAKE & EXHAUST BUILDING OPENINGS. COORDINATE WITH OTHER TRADES FOR ACCESS PANELS, POWER AND FIRE ALARM INTERFACES. SEE PROJECT MANUAL.

ACOUSTICAL DUCT LINER
UNLESS OTHERWISE INDICATED ON THE PLANS, PROVIDE 1" (25MM) ACOUSTICAL DUCT LINER IN SUPPLY AND RETURN DUCTWORK WITHIN 10'-0" (305CM) OF THE DISCHARGE AND INTAKE OF AIR HANDLING UNITS. INCREASE DUCT SIZE INDICATED ON PLANS AS NEEDED TO ACCOMMODATE LINER. LINER TO BE PROVIDED AND FASTENED TO DUCT WITH MECHANICAL LINER FASTENERS IN ACCORDANCE WITH SMACNA AND PROJECT MANUAL.

FLEXIBLE DUCTWORK
FLEXIBLE DUCT WORK SHALL ONLY BE INSTALLED AS SHOWN IN PLAN AND NOT ABOVE HARD LID CEILINGS. FLEXIBLE DUCTWORK SHALL NOT EXCEED 5'-0" (152CM) IN LENGTH AND TWO 45° ELBOWS. IT SHALL BE PULLED TAUT AND APPROPRIATELY FASTENED TO RIGID BRANCH DUCT & DIFFUSER. BENDS SHALL BE MINIMIZED AND WHERE NEEDED BE A FULL RADIUS BEND. SUPPORT BANDS SHALL BE INSTALLED SO AS TO NOT CRIMP FLEX DUCT. FLEXIBLE DUCTWORK SHALL MEET REQUIREMENTS.

TESTING, ADJUSTING, BALANCING

INDEPENDENT AIR BALANCE CONTRACTOR OR QUALIFIED MECHANICAL CONTRACTOR SHALL BE QUALIFIED BY NEBB OR AABC STANDARDS. BALANCER SHALL ACCURATELY BALANCE THE SUPPLY, RETURN AND OUTSIDE AIR, EXHAUST FAN(S), HYDRONIC (WHERE APPLICABLE) AND EXHAUST FAN(S) SYSTEMS TO PROVIDE AIR AND WATER QUANTITIES WITHIN 10% PLUS MINUS OF THE VALUES INDICATED ON THE DRAWINGS AND IN THE SPECIFICATIONS UNLESS MANUFACTURER REQUIRES TIGHTER TOLERANCES. OPERATE AUTOMATIC CONTROLS SYSTEMS AND VERIFY SETPOINTS FOR THERMOSTATS, CO2 SENSORS, DOV, EMS AND ECONOMIZER/OUTSIDE AIR DAMPER. SEE CONTROLS AND OPERATION NOTES AND HVAC SCHEDULES AND NOTES FOR DETAILS. IF DEFICIENCIES OR SITE CONDITIONS PREVENT COMPLETE AND PROPER BALANCING, DO NOT COMPLETE WORK AND SUBMIT A REQUEST FOR INFORMATION TO GET COMPLETE INFORMATION PRIOR TO COMPLETING WORK. SUBMIT THREE (3) COPIES OF THE BALANCE REPORT TO THE ENGINEER, CONSTRUCTION MANAGER AND COMMISSIONING AGENT FOR APPROVAL. THE BALANCE REPORT SHALL INCLUDE NEBB OR AABC CREDENTIALS, EQUIPMENT/INSTRUMENT LIST WIT THE MOST RECENT CALIBRATION DATE AND BALANCE REPORTS FOR ALL HVAC AND EXHAUST SYSTEMS. T&B REPORT SHOULD MATCH NEBB OR AABC STANDARD REPORTS INCLUDING UNIT TEST DATA WITH TEMPERATURES, PRESSURES AND STATIC PRESSURE PROFILES. INCLUDE A COPY OF THE BALANCE REPORT AS APPROVED BY THE ENGINEER WITH APPLICATION FOR FINAL CONTRACT PAYMENT.

IAQ MANAGEMENT PLAN

DURING CONSTRUCTION, CONTRACTOR SHALL COMPLY WITH CHAPTER 3 OF SMACNA'S IAQ GUIDELINES FOR OCCUPIED BUILDINGS UNDER CONSTRUCTION. CONTRACTOR SHALL PERFORM AND SUBMIT ALL INFORMATION AS REQUIRED. IF HVAC SYSTEM IS TO BE USED DURING CONSTRUCTION, INSTALL MERV 8 FILTERS AT EACH RETURN AIR GRILL AND COMPLY WITH SMACNA'S GUIDELINES.

ENERGY MANAGEMENT SYSTEM (EMS)

THE GENERAL CONTRACTOR SHALL INSTALL (OR DEMO AND REINSTALL FOR RENOVATIONS) THE VENSTAR SURVEYOR EMS SYSTEMS PRIOR TO THE LAST WEEK OF CONSTRUCTION. MECHANICAL CONTRACTOR TO INSTALL ONE PERMANENT THERMOSTAT AND REMOTE SENSOR PER HVAC UNIT, AS PROVIDED BY VENSTAR. LOCATE AND MOUNT THERMOSTAT(S) AND SENSOR(S) PER THE DRAWINGS. INSTALL THERMOSTAT IDENTIFICATION LABELS PER VENSTAR SPECIFICATIONS.

MECHANICAL CONTRACTOR TO COMPLETE FINAL CONNECTIONS FROM SURVEYOR DATA CONCENTRATOR TO STORE ROUTER PRIOR TO CONTACTING VENSTAR (818-812-9812). VENSTAR TO PROGRAM THE HVAC AND/OR LIGHTING CONTROLS WITH STANDARD STARBUCKS SETTINGS. FOR ASSISTANCE WITH OR TROUBLESHOOTING OF THE SURVEYOR CONTROLS, CONTACT VENSTAR.

GENERAL MECHANICAL NOTES

- MECHANICAL CONTRACTOR SHALL COORDINATE WITH THE GENERAL CONTRACTOR TO PATCH AND REPAIR ALL EXISTING WALLS, FLOORS, CEILINGS OR OTHER SURFACES IDENTIFIED TO REMAIN THAT MAY BECOME DAMAGED DURING THE COURSE OF WORK.
- DRAWINGS ARE DIAGRAMMATIC AND INDICATE GENERAL INTENT OR ARRANGEMENT OF SYSTEM(S). FURNISH & INSTALL ALL COMPONENTS NEEDED WHETHER INDICATED OR NOT TO PROVIDE A COMPLETE AND OPERATING SYSTEM.
- CONTRACTOR TO VERIFY ALL DIMENSIONS, INCLUDING CLEARANCES REQUIRED BY OTHER TRADES, AND NOTIFY STARBUCKS CONSTRUCTION MANAGER OF ANY DISCREPANCIES PRIOR TO PROCEEDING WITH THE WORK. ALL DIMENSIONS ARE TO THE FACE OF THE FINISHED SURFACE UNLESS NOTED OTHERWISE. ALL DIMENSIONS TO BE TAKEN FROM ACTUAL BUILDING DIMENSIONS.
- THE MECHANICAL CONTRACTOR SHALL COORDINATE HVAC WORK WITH OTHER TRADES. THE ARCHITECTURAL DRAWINGS AND PROJECT MANUAL SHALL TAKE PRECEDENCE OVER ALL OTHER DRAWINGS. SEE ARCHITECTURAL DRAWINGS AND PROJECT MANUAL FOR DIMENSIONED DIFFUSER LOCATIONS AND MOUNTING HEIGHTS WHERE EXPOSED.
- NEW DUCTWORK AND EQUIPMENT SHALL NOT BE INSTALLED WHERE IT OBSTRUCTS ANY EXISTING OR NEW AREAS THAT REQUIRE ACCESS.
- INSULATE DUCTWORK PER CODE AND SPEC. REQUIREMENTS. COORDINATE CLEARANCE REQUIREMENTS FOR ADDED INSULATION.
- ALL IS NEW UNLESS NOTED OTHERWISE.

GENERAL NOTES

SCOPE
THE INTENT OF THE PROJECT MANUAL AND THE DRAWINGS IS TO PROVIDE A COMPLETE AND FULLY OPERATIONAL MECHANICAL SYSTEM. THE MECHANICAL CONTRACTOR SHALL FURNISH ALL LABOR, MATERIAL, AND EQUIPMENT NECESSARY TO COMPLETE THE MECHANICAL WORK.

SITE EXAMINATION
THE MECHANICAL CONTRACTOR SHALL THOROUGHLY EXAMINE ALL AREAS WHERE EQUIPMENT, DUCTWORK, AND PIPING WILL BE INSTALLED AND WILL REPORT ANY CONDITION THAT, IN HIS OPINION, PREVENTS THE PROPER INSTALLATION OF THE MECHANICAL WORK.

PENETRATIONS
WHERE PIPES AND DUCTS PENETRATE WALL, SEAL OPENINGS TO PREVENT AIR TRANSFER BETWEEN SPACES. USE FIRE RATED SEALANTS ON ALL FIRE SEPARATION PENETRATIONS, INCLUDING FLOORS. SEAL AROUND ALL PIPES AND DUCTS PENETRATING FIRE SEPARATIONS WITH NON-COMBUSTIBLE PACKING RETAINED BY METAL COLLARS. THE ASSEMBLY SHALL BE APPROVED BY STATE FIRE MARSHALL.

STANDARDS
EQUIPMENT AND MATERIALS SHALL CONFORM WITH THE APPROPRIATE PROVISIONS OF CSA, ULC, ARL, ASME, ASTM, UL, NEMA, ANSI, SMACNA, ASHRAE, NFPA, AS APPLICABLE TO EACH INDIVIDUAL UNIT OR ASSEMBLY.

CODES
ALL WORK SHALL BE PERFORMED IN STRICT ACCORDANCE WITH ALL APPLICABLE PROVINCIAL AND LOCAL CODES AND ORDINANCES. IN CASE OF CONFLICT BETWEEN THE DRAWINGS AND PROJECT MANUAL AND THE CODES AND ORDINANCES, USE WHICHEVER IS MORE STRINGENT. THE MECHANICAL CONTRACTOR SHALL SATISFY CODE REQUIREMENTS AS A MINIMUM STANDARD WITHOUT ANY EXTRA COST TO STARBUCKS.


PERMITS AND FEES
THE MECHANICAL CONTRACTOR SHALL PROCURE AND PAY FOR ALL PERMITS, FEES, AND INSPECTIONS NECESSARY TO COMPLETE THE MECHANICAL WORK.

WARRANTY
THE MECHANICAL CONTRACTOR SHALL UNCONDITIONALLY WARRANT ALL WORK TO BE FREE OF DEFECTS IN MATERIAL AND WORKMANSHIP FOR A PERIOD OF ONE (1) YEAR FROM THE DATE OF FINAL ACCEPTANCE BY STARBUCKS AND WILL REPAIR OR REPLACE ANY DEFECTIVE WORK PROMPTLY AND WITHOUT CHARGE AND RESTORE ANY OTHER EXISTING WORK DAMAGED IN THE COURSE OF REPAIRING DEFECTIVE MATERIALS AND WORKMANSHIP.

LANDLORD REQUIREMENTS

PRIOR TO BID: THE GENERAL CONTRACTOR SHALL COORDINATE WITH LANDLORD / BUILDING OWNER FOR ANY CONSTRUCTION REQUIREMENTS. IF LANDLORD / BUILDING OWNER DOES HAVE REQUIREMENTS, CONTRACTOR SHALL BECOME COMPLETELY FAMILIAR WITH REQUIREMENTS AND ADHERE TO THEM. WHERE LANDLORD / BUILDING OWNER REQUIREMENTS ARE MORE STRINGENT THAN SHOWN IN THESE PLANS (IN THE OPINION OF THE ENGINEER), LANDLORD / BUILDING OWNER REQUIREMENTS SHALL GOVERN.

FOR CONSTRUCTION




© 2019 STARBUCKS COFFEE COMPANY

STARBUCKS®
2401 UTAH AVENUE SOUTH
SEATTLE, WASHINGTON 98134
(206) 318-1575

THESE DRAWINGS AND THE PROJECT MANUAL ARE CONFIDENTIAL AND SHALL REMAIN THE SOLE PROPERTY OF STARBUCKS CORPORATION, WHICH IS THE OWNER OF THE COPYRIGHT IN THIS WORK. THEY SHALL NOT BE REPRODUCED IN WHOLE OR IN PART, SHARED WITH THIRD PARTIES OR USED IN ANY MANNER ON OTHER PROJECTS OR EXTENSIONS TO THIS PROJECT WITHOUT THE PRIOR WRITTEN CONSENT OF STARBUCKS CORPORATION. THESE DRAWINGS AND SPECIFICATIONS ARE INTENDED TO EXPRESS DESIGN INTENT FOR A PROTOTYPICAL STARBUCKS STORE (WHICH IS SUBJECT TO CHANGE AT ANYTIME) AND DO NOT REFLECT ACTUAL SITE CONDITIONS. NEITHER PARTY SHALL HAVE ANY OBLIGATION NOR LIABILITY TO THE OTHER (EXCEPT STATED ABOVE) UNTIL A WRITTEN AGREEMENT IS FULLY EXECUTED BY BOTH PARTIES.

STARBUCKS TEMPLATE VERSION: i2023-05-01

Design Forum Architects Inc.
2056 Byers Rd
Miamisburg, OH 45342
Tel: (844) 804-7700
Donald J. Rethman
Architect in Charge

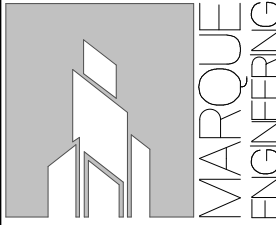**MARQUE ENGINEERING**
4850 SMITH RD., STE. 101
CINCINNATI, OH 45212
513.901.0040
WWW.MARQUEENG.COM

PROJECT NAME:
S SEMORAN BLVD & LEE VISTA BLVD

PROJECT ADDRESS:
**6605 S SEMORAN BLVD,
ORLANDO, FL 32822**


STORE #: 9875
PROJECT #: 25630-101
ISSUE DATE: 03/04/2024
DESIGN MANAGER: MARTIN PEREZ
PRODUCTION DESIGNER: ANDY MCLOUD
CHECKED BY: EVAN DUFFY

Revision Schedule			
Rev	Date	By	Description

SHEET TITLE:
MECHANICAL NOTES

SCALE: 1/4" = 1'-0"

SHEET NUMBER:
M001

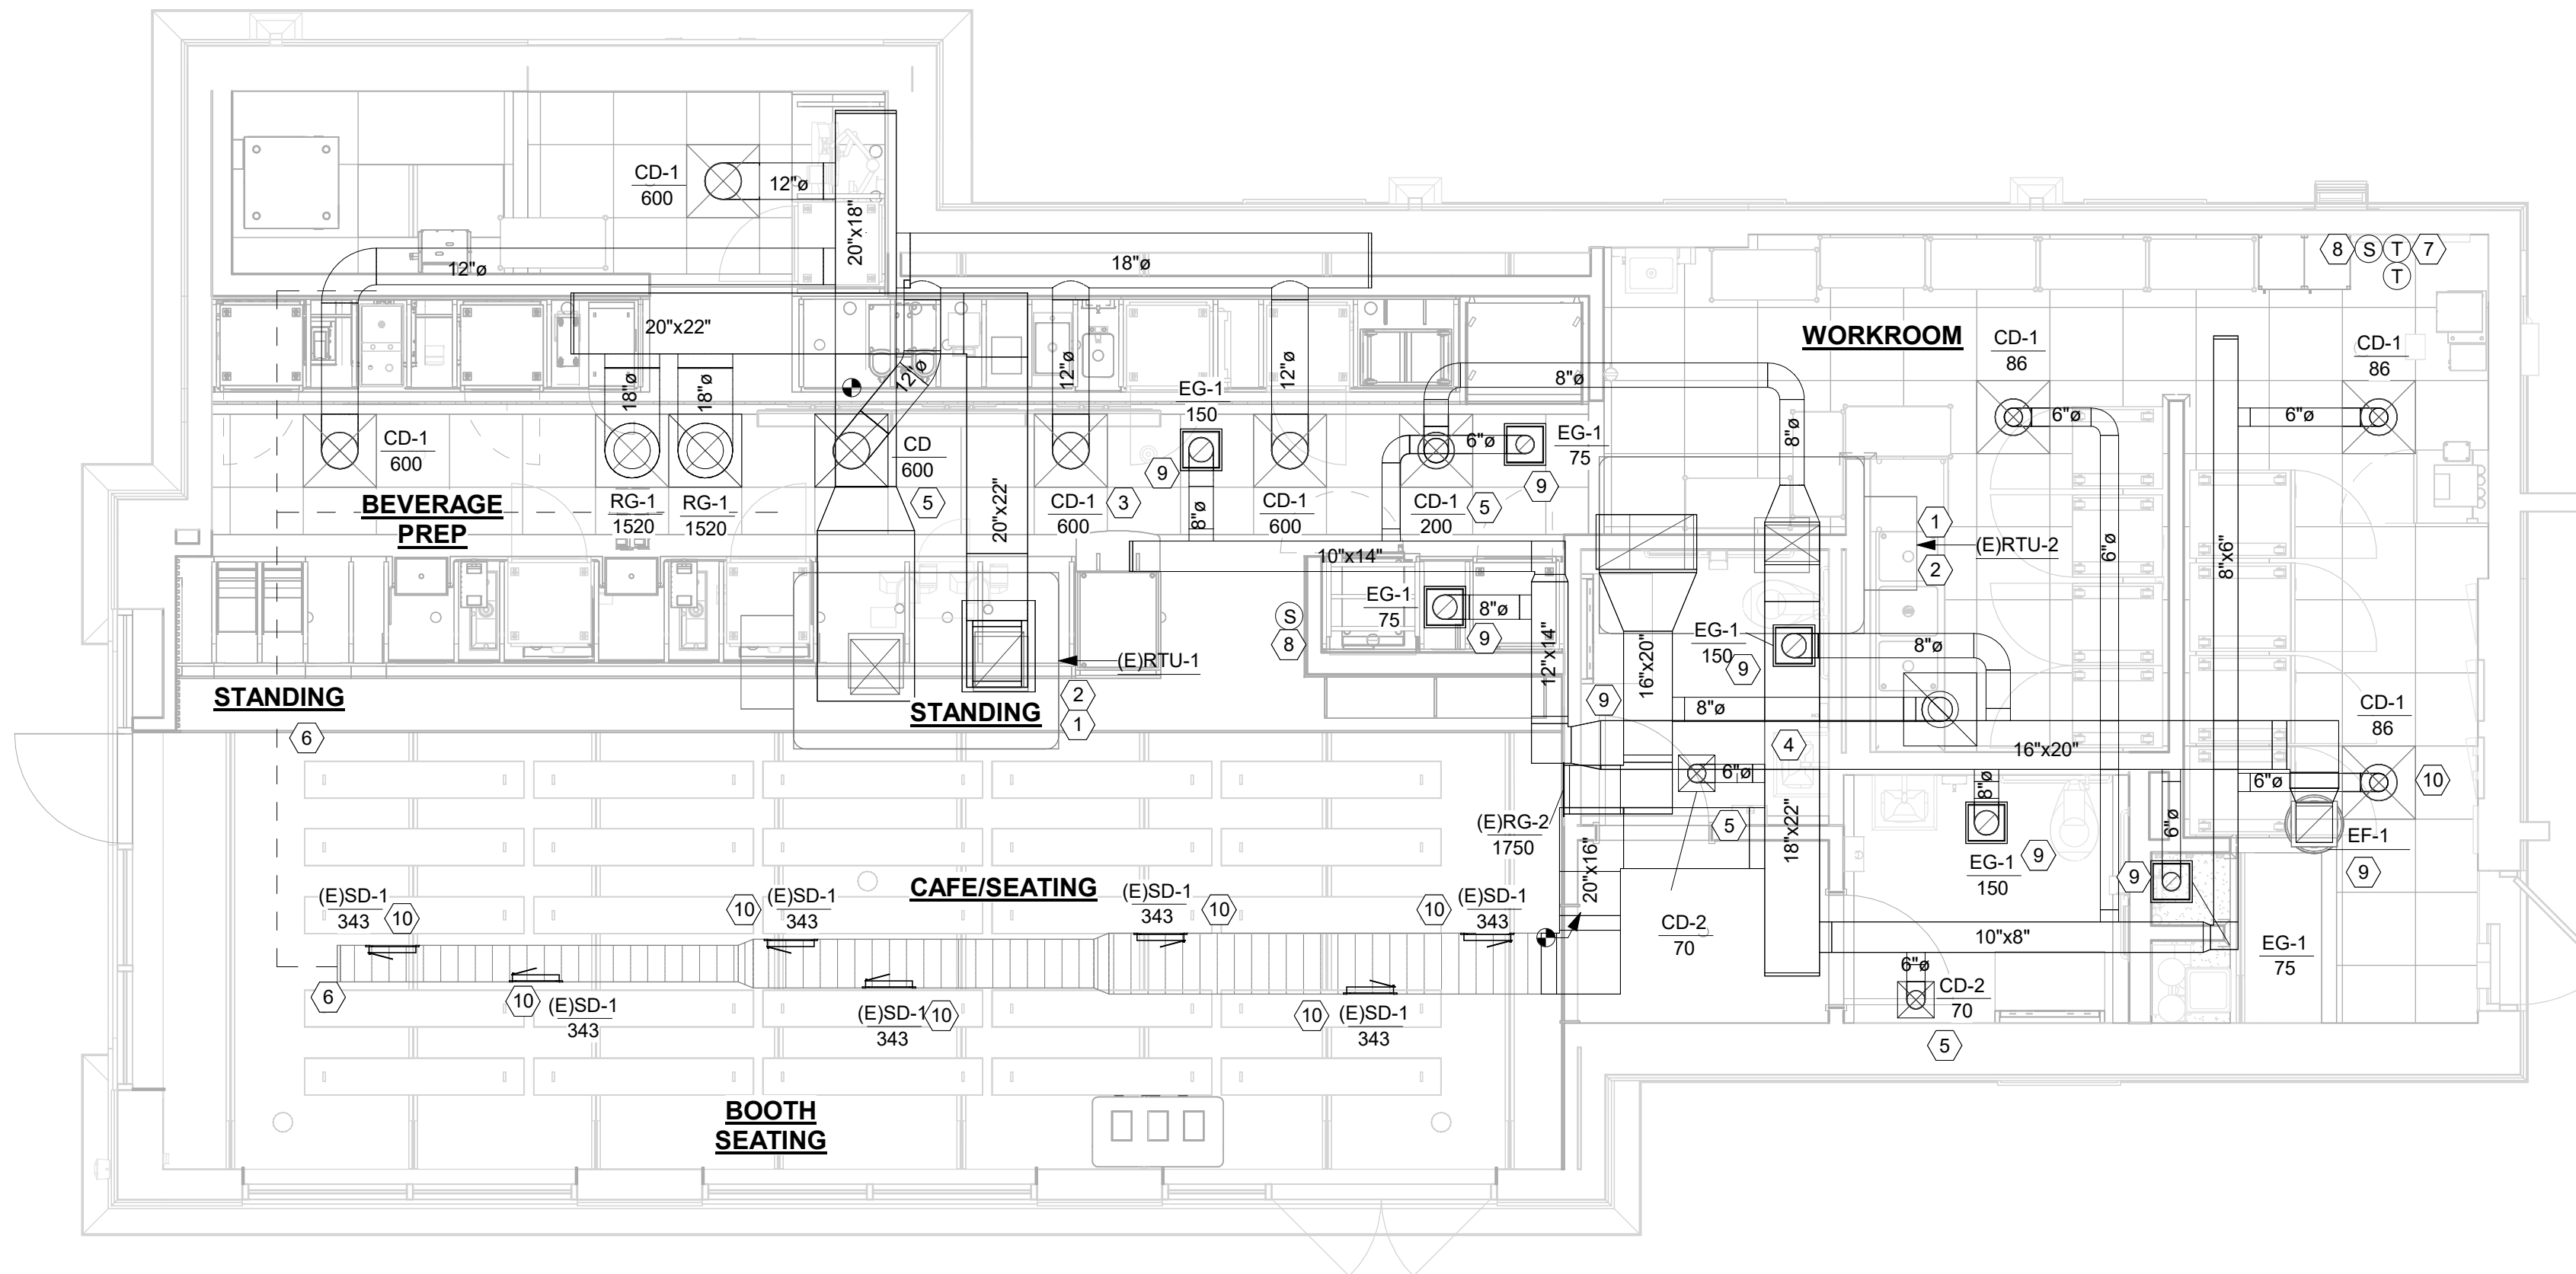


GENERAL NOTES

- SEE ARCHITECTURAL SHEETS FOR PAINTING AND COLORS OF ALL EXPOSED DUCTWORK, DIFFUSERS AND GRILLES.
- SEE ARCHITECTURAL SHEETS FOR DIMENSIONED DIFFUSER & EXPOSED DUCT LOCATIONS.
- DIFFUSERS AND RETURN GRILLES SHALL BE CENTERED IN CEILING TILE, UNLESS OTHERWISE NOTED.
- REFERENCE LANDLORD WORK LETTER FOR DIVISION OF MECHANICAL SCOPE OF WORK AND COORDINATE WITH STARBUCKS CONSTRUCTION MANAGER.
- SEE SHEET M-601 FOR EQUIPMENT & AIR DEVICE SCHEDULES.
- MECHANICAL CONTRACTOR RESPONSIBLE FOR SITE INVESTIGATION PRIOR TO START OF WORK TO REVEAL FULL SCOPE OF PROJECT.
- COORDINATE WITH ELECTRICAL CONTRACTOR FOR POWER CONNECTIONS TO ALL MECHANICAL EQUIPMENT.
- DUCTWORK ABOVE CEILINGS SHALL BE ROUTED AS HIGH AS POSSIBLE. REFER TO CEILING PLANS AND SECTIONS FOR HEIGHT OF EXPOSED DUCTWORK.
- CONTRACTOR SHALL INSTALL REFRIGERANT PIPING TO/FROM REMOTE CONDENSER FOR ICE MACHINE AND/OR WALK IN COOLERS.

KEYED NOTES

- EXISTING ROOFTOP AC UNIT ON ROOF TO REMAIN AND BE REUSED. CLEAN AND ADJUST AS REQUIRED. REPLACE FILTERS PRIOR TO ANY AIR BALANCE AND AFTER FINAL STORE CLEANING.
- EXISTING SMOKE DETECTOR FOR ROOFTOP UNIT TO REMAIN AND BE REUSED. CLEAN AND ADJUST AS REQUIRED. FIELD VERIFY ALL REQUIREMENTS.
- RELOCATE EXISTING AIR DEVICE AS INDICATED FOR NEW LAYOUT AS SHOWN ON PLANS. EXTEND DUCTWORK AS / IF NECESSARY. CLEAN AIR DEVICE AS REQUIRED. FURNISH NEW MOUNTING FRAME IF NECESSARY. BALANCE AIR DEVICE TO MATCH THE PRE-CONSTRUCTION CFM. FIELD VERIFY LOCATION AND ALL REQUIREMENTS.
- EXISTING DUCTWORK FOR ROOFTOP UNIT TO REMAIN AND BE REUSED. FIELD VERIFY EXISTING ROUTING. PROVIDE NEW DUCT TAPS AS REQUIRED FOR NEW LAYOUT. ANY EXISTING BRANCH TAP NOT BEING REUSED SHALL BE CAPPED AND SEALED AIR TIGHT.
- COORDINATE WITH G.C. AND OWNER FOR THE PAINTING OF THE DIFFUSER TO MATCH COLOR OF CEILING. FIELD VERIFY ALL REQUIREMENTS.
- REMOVE DUCTWORK AND AIR DEVICES BACK TO THIS POINT AND CAP AND SEAL. FIELD VERIFY EXISTING ROUTING AND ALL REQUIREMENTS.
- EXISTING THERMOSTATS TO REMAIN. CLEAN AND ADJUST AS REQUIRED. EXTEND CONTROL WIRE AS REQUIRED. FIELD VERIFY LOCATION AND ALL REQUIREMENTS.
- RELOCATE EXISTING SENSOR TO NEW LOCATION. CLEAN AND ADJUST AS REQUIRED. FIELD VERIFY EXISTING LOCATION AND ALL REQUIREMENTS.
- REPLACE EXISTING EXHAUST FAN WITH NEW EXHAUST FAN IN SAME LOCATION. MOUNT FAN ON EXISTING FAN CURB. FIELD VERIFY LOCATION AND ALL REQUIREMENTS.
- AIR DEVICE TO REMAIN AND BE REUSED. CLEAN AIR DEVICE AS REQUIRED. BALANCE AIR DEVICE TO MATCH THE PRE-CONSTRUCTION CFM.

FOR CONSTRUCTION




© 2019 STARBUCKS COFFEE COMPANY

STARBUCKS®
2401 UTAH AVENUE SOUTH
SEATTLE, WASHINGTON 98134
(206) 318-1575

THESE DRAWINGS AND THE PROJECT MANUAL ARE CONFIDENTIAL AND SHALL REMAIN THE SOLE PROPERTY OF STARBUCKS CORPORATION, WHICH IS THE OWNER OF THE COPYRIGHT IN THIS WORK. THEY SHALL NOT BE REPRODUCED IN WHOLE OR IN PART, SHARED WITH THIRD PARTIES OR USED IN ANY MANNER ON OTHER PROJECTS OR EXTENSIONS TO THIS PROJECT WITHOUT THE PRIOR WRITTEN CONSENT OF STARBUCKS CORPORATION. THESE DRAWINGS AND SPECIFICATIONS ARE INTENDED TO EXPRESS DESIGN INTENT FOR A PROTOTYPICAL STARBUCKS STORE (WHICH IS SUBJECT TO CHANGE AT ANYTIME) AND DO NOT REFLECT ACTUAL SITE CONDITIONS. NEITHER PARTY SHALL HAVE ANY OBLIGATION NOR LIABILITY TO THE OTHER (EXCEPT STATED ABOVE) UNTIL A WRITTEN AGREEMENT IS FULLY EXECUTED BY BOTH PARTIES.

STARBUCKS TEMPLATE VERSION: i2023-05-01

Design Forum Architects Inc.
2056 Byers Rd
Miamisburg, OH 45342
Tel: (844) 804-7700
Donald J. Bethman
Architect in Charge

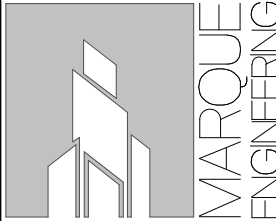**MARQUE ENGINEERING**
4850 SMITH RD., STE. 101
CINCINNATI, OH 45212
513.901.0040
WWW.MARQUEENG.COM

PROJECT NAME:
S SEMORAN BLVD & LEE VISTA BLVD

PROJECT ADDRESS:
**6605 S SEMORAN BLVD,
ORLANDO, FL 32822**

STORE #: 9875
PROJECT #: 25630-101
ISSUE DATE: 03/04/2024
DESIGN MANAGER: MARTIN PEREZ
PRODUCTION DESIGNER: ANDY MCLOUD
CHECKED BY: EVAN DUFFY

Revision Schedule			
Rev	Date	By	Description


SHEET TITLE:
MECHANICAL DESIGN PLAN
SCALE: 1/4" = 1'-0"

SHEET NUMBER:
M101

VENTILATION SCHEDULE

Starbucks - S. Semoran Blvd & Lee Vista Blvd (Reno) - Orlando, FL						Vbz = Az x Ra + Rp x Pz											
			Table 403.3.1.1				PEOP...	AREA	OA	AIR		SA		Zp =		Vot =	
		Az	OCCUPANCY	Rp	Ra	Pz	Rp x Pz	Az x Ra	CFM	Eff	Voz=	CFM	OA	Voz /		Voz /	
ROO...	ROOM NAME	SQFT	CATEGORY	CF...	CFM/S...	peo...	CFM	CFM	Vbz	Ez	Vb...	Vpz	.	Vpz	Ev	Ev	
													5%				
100	Bev Prep	381	Kitchen	7.5	0.12	2	15	46	61	0.8	76	3000	150	0.03	1.00	76	
	RTU-1	381				2					76	3000	150			76	
													27%				
101	BOH	356	Storage	0	0.12	3	0	43	43	0.8	53	260	70	0.21	0.90	59	
105	Dining Space	571	Dining Space	7.5	0.18	48	360	103	463	0.8	578	2400	650	0.24	0.90	643	
106	Restroom 1	53	Restroom	0	0	0	0	0	0	0.8	0	70	19	0.00	0.90	0	
107	Restroom 2	52	Restroom	0	0	0	0	0	0	0.8	0	70	19	0.00	0.90	0	
100	Bev Prep	25	Kitchen	7.5	0.12	1	8	3	11	0.8	13	200	10	0.07	1.00	13	
	RTU-2	1057				52					645	3000	770			715	

- NOTES:
- SET OUTSIDE AIR AS CALLED OUT ON THE RTU SCHEDULE.
 - OUTSIDE AIR BASED ON CODE OCCUPANCY LISTED ON SHEET G001.

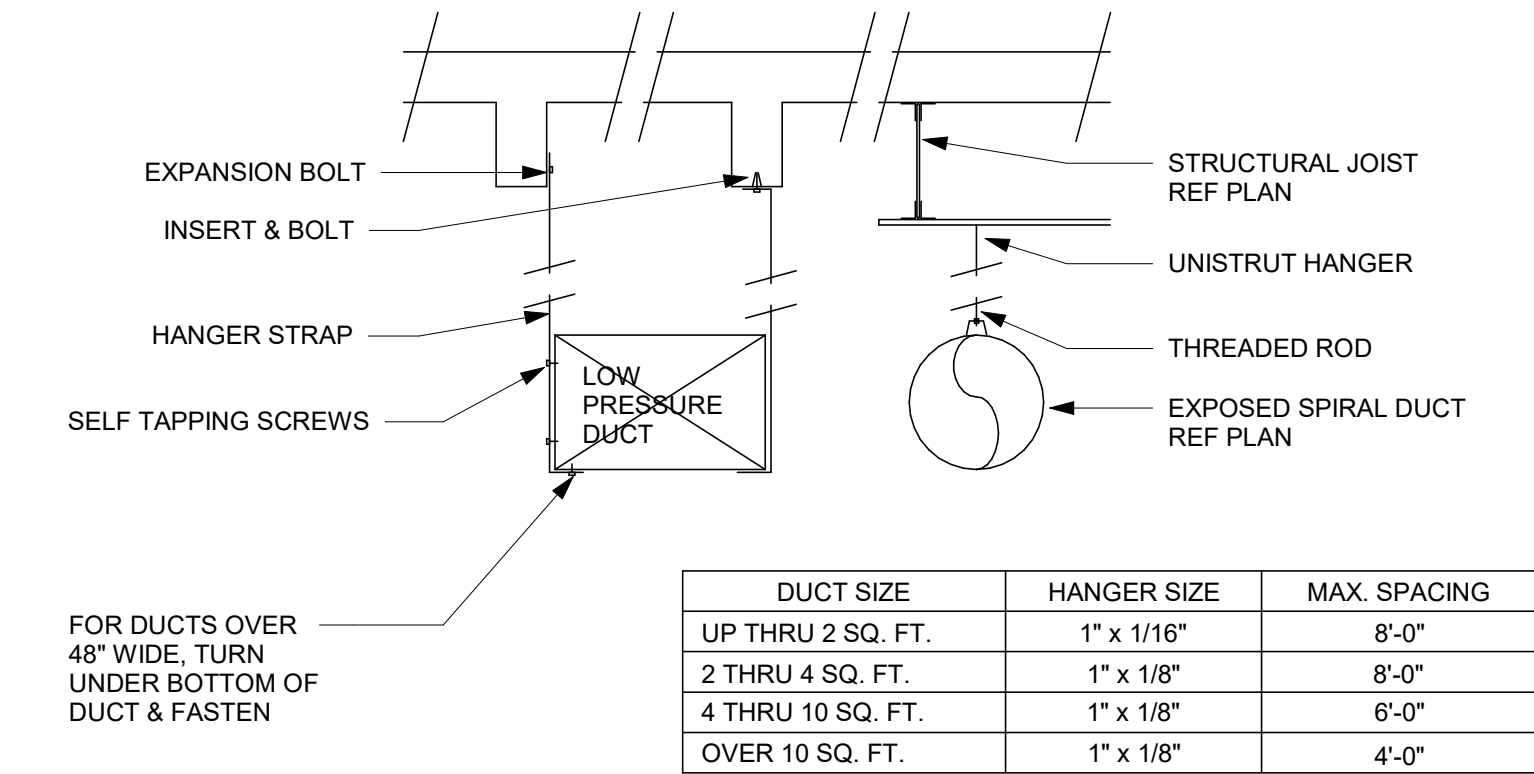

1 DUCT HANGING DETAIL

Scale: 1/4" = 1'-0"

EXISTING ROOFTOP AC UNIT SCHEDULE																	
Description	MANUFACTURER	MODEL	TOTAL COOLING (TONS)	SENSIBLE COOLING (MBTUH)	SUPPLY FLOW CFM	OA CFM	ELEC HEAT (MGH)	EDB (°F)	EWB (°F)	ESP IN. W.C.	HP	EER	VOLTAGE	PHASE	MCA	MOCP	REMARKS
(E)RTU-1	TRANE	TSC090F3RCA1	7.5	67.9	3000	150	17.5	94	37	2.00	1	11.2	208	3	38.1	60	1,2
(E)RTU-2	TRANE	TSC090F3RCA1	7.5	62.7	3000	770	16.1	94	37	2.00	1	11.2	208	3	38.1	60	1,2

- REMARKS:
- ALL HVAC EQUIPMENT TO BE FIELD LABELED TO IDENTIFY WHICH AREAS OF THE BUILDING THEY SERVE.
 - EXISTING ROOFTOP UNIT. MECHANICAL CONTRACTOR TO SERVICE ROOFTOP UNIT TO ASSURE IT IS OPERATING PROPERLY, REPLACE ALL FILTERS, AND REFURBISH TO LIKE NEW CONDITIONS.

EXHAUST FAN SCHEDULE												
TAG	TYPE	SERVES	MANUFACTURER	MODEL	PERFORMANCE			ELECTRICAL			WEIGHT	NOTES
					HP	CFM	ESP (in w.g.)	VOLTAGE	PHASE	MCA		
EF-1	ROOF	RESTROOMS/KITCHEN	GREENHECK	G-095-VG	1/6	675	0.5	120	1	3.5	-	-

GRILLE, REGISTER, DIFFUSER, CONTROL & SENSOR SCHEDULE		
TAG	TITUS MODEL NO. OR AS NOTED	NOTES
CD-1	MODEL TDC, LAY-IN, 24"X24", 4-WAY	1
CD-2	MODEL TDC, SURFACE, 12"X12", 4-WAY	1
LD-1	MODEL ML38, 60" LONG, (3) 3/4" SLOT	1
RG-1	MODEL 350RL, LAY-IN, 24"X24"	1
EG-1	MODEL 350RL, SURFACE, 10"x10"	1

- NOTES:
- COORDINATE MOUNTING TYPES WITH ARCHITECTURAL CEILING AND WALL TYPES, AND SEE NECK SIZES ON PLANS.

ENERGY MANAGEMENT SYSTEM (EMS) DEVICES		
DESCRIPTION	RESPONSIBILITY	COMMENTS
VENSTAR DC400, DATA CONCENTRATOR	SB-GC	LOCATE AT MANAGER'S WORK STATION. LOCATION SHOWN ON SHEET E-501, DETAIL 2.
VENSTAR ECP400, EQUIPMENT CONTROL PACK	SB-GC	LOCATE AT EACH HVAC UNIT. LOCATION OF HVAC UNITS SHOWN ON SHEET M-101.
VENSTAR CT414, COMMUNICATING THERMOSTAT	SB-GC	LOCATE BY MANAGER'S WORK STATION AS SHOWN ON M-101 AND E-103. COORDINATE LOCATION WITH STARBUCKS' EQUIPMENT.
VENSTAR RS410, WALL MOUNT REMOTE TEMPERATURE SENSOR	SB-GC	LOCATE AS SHOWN ON M-101, ONE PER HVAC UNIT. COORDINATE LOCATION WITH STARBUCKS' ART, EQUIP.: PROJECT MANAGER.
VENSTAR RS420, OPTIONAL NARROW DROP DOWN SENSOR	SB-GC	OPTIONAL SENSOR FOR WORKROOM. USE AS LAST RESORT ONLY IF NO SPACE EXISTS FOR WALL MOUNT TEMPERATURE SENSOR.
VENSTAR OTS400, OUTDOOR TEMPERATURE SENSOR	SB-GC	LOCATE IN OUTSIDE AIR DUCT OF AHU-1.
VENSTAR SP400, SENSOR PAC	SB-GC	LOCATE COMPONENTS (AIRFLOW & TEMP SENSORS) PER SP400 SENSOR PAC INSTALLATION INSTRUCTIONS.

- NOTES:
- SURVEYOR ENERGY MANAGEMENT SYSTEM HARDWARE IS SUPPLIED BY STARBUCKS.
 - DRAWING FOR GENERAL INFORMATION, DESIGN INTENT, AND COORDINATION ONLY.

ELECTRICAL / MECHANICAL COORDINATION NOTES:

PROVIDE AND COORDINATE LINE VOLTAGE WIRING, LINE VOLTAGE CONTROL AND INTERLOCK WIRING FOR MECHANICAL SYSTEMS, AND LOW VOLTAGE CONTROL WIRING.

FURNISH WIRING DIAGRAMS TO THE ELECTRICIAN AS REQUIRED FOR PROPER EQUIPMENT HOOKUP. COORDINATE WITH THE ELECTRICIAN THE ACTUAL WIRE SIZING AMPS FOR MECHANICAL EQUIPMENT (FROM THE EQUIPMENT NAMEPLATE) TO ENSURE PROPER INSTALLATION.



© 2019 STARBUCKS COFFEE COMPANY

STARBUCKS®
2401 UTAH AVENUE SOUTH
SEATTLE, WASHINGTON 98134
(206) 318-1575


THESE DRAWINGS AND THE PROJECT MANUAL ARE CONFIDENTIAL AND SHALL REMAIN THE SOLE PROPERTY OF STARBUCKS CORPORATION, WHICH IS THE OWNER OF THE COPYRIGHT IN THIS WORK. THEY SHALL NOT BE REPRODUCED IN WHOLE OR IN PART, SHARED WITH THIRD PARTIES OR USED IN ANY MANNER ON OTHER PROJECTS OR EXTENSIONS TO THIS PROJECT WITHOUT THE PRIOR WRITTEN CONSENT OF STARBUCKS CORPORATION. THESE DRAWINGS AND SPECIFICATIONS ARE INTENDED TO EXPRESS DESIGN INTENT FOR A PROTOTYPICAL STARBUCKS STORE (WHICH IS SUBJECT TO CHANGE AT ANYTIME) AND DO NOT REFLECT ACTUAL SITE CONDITIONS. NEITHER PARTY SHALL HAVE ANY OBLIGATION NOR LIABILITY TO THE OTHER (EXCEPT STATED ABOVE) UNTIL A WRITTEN AGREEMENT IS FULLY EXECUTED BY BOTH PARTIES.

STARBUCKS TEMPLATE VERSION: i2023-05-01

Design Forum Architects Inc.

2956 Byers Rd
Miamisburg, OH 45342
Tel: (844) 804-7700

Donald J. Bethman
Architect in Charge

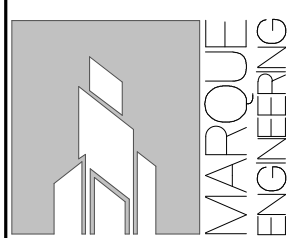

4850 SMITH RD., STE. 101
CINCINNATI, OH 45212
513.901.0040
WWW.MARQUEENG.COM

FOR CONSTRUCTION

PROJECT NAME:
S SEMORAN BLVD & LEE VISTA BLVD

PROJECT ADDRESS:
**6605 S SEMORAN BLVD,
ORLANDO, FL 32822**

STORE #: 9875
PROJECT #: 25630-101
ISSUE DATE: 03/04/2024
DESIGN MANAGER: MARTIN PEREZ
PRODUCTION DESIGNER: ANDY MCLOUD
CHECKED BY: EVAN DUFFY

Revision Schedule			
Rev	Date	By	Description

SHEET TITLE:
MECHANICAL SCHEDULES
SCALE: 1/4" = 1'-0"

SHEET NUMBER:
M601

ABBREVIATIONS

AFF	ABOVE FINISHED FLOOR
AHJ	AUTHORITIES HAVING JURISDICTION
APPROX	APPROXIMATE
BLDG	BUILDING
CKT	CIRCUIT
CLG	CEILING
CM	STARBUCKS CONSTRUCTION MANAGER
CONST	CONSTRUCTION
CW	COLD WATER
CXA	COMMISSIONING AGENT
DEG	DEGREES
DL	LIGHTS WITHIN DAYLIGHT ZONE
DM	STARBUCKS DESIGN MANAGER
DN	DOWN
DTL	DETAIL
DWG(S)	DRAWING(S)
EA	EACH
EC	ELECTRICAL CONTRACTOR
ECP	EQUIPMENT CONTROL PAC
EG	EXHAUST GRILLE
ELEC	ELECTRICAL
EM	EMERGENCY
EMS	ENERGY MANAGEMENT SYSTEM
EXIST	EXISTING
EXT	EXTERIOR
F&I	FURNISH & INSTALL
FOIC	FURNISHED BY OWNER, INSTALLED BY CONTRACTOR
FOIO	FURNISHED BY OWNER, INSTALLED BY OWNER
FLR	FLOOR
FT	FOOT/FEET
GC	GENERAL CONTRACTOR
GFCI	GROUND FAULT CIRCUIT INTERRUPTER
GND	GROUND
HR	HOUR
HVAC	HEATING, VENTILATION, AIR CONDITIONING
HW	HOT WATER
LCP	LIGHTING CONTROL PANEL
LL	LANDLORD
LS	LIGHT SENSOR PHOTOCCELL
LV	LOW VOLTAGE
MAX	MAXIMUM
MC	MECHANICAL CONTRACTOR
MDP	MAIN DISTRIBUTION PANEL
MECH	MECHANICAL
MEP	MECHANICAL, ELECTRICAL, AND PLUMBING
MFG	MANUFACTURER
MIN	MINIMUM
NL	NIGHTLIGHT
NTS	NOT TO SCALE
OCP	OVERCURRENT PROTECTION
PIR	PASSIVE INFRARED SENSOR
REF	REFERENCE
REQ(D)	REQUIRE(D)
REV	REVISION
SF	SQUARE FEET
SHT	SHEET
SPECS	SPECIFICATION(S)
SST	STAINLESS STEEL
TEL	TELEPHONE
TEMP	TEMPORARY
TYP	TYPICAL
UC	UNDER COUNTER
UNO	UNLESS NOTED OTHERWISE
WH	WATER HEATER
WP	WEATHER PROOF

ELECTRICAL SCOPE OF WORK SUMMARY

THE FOLLOWING SCOPE OF WORK IS BASED ON THE LANDLORD'S WORKLETTER EXHIBIT C. THIS SCOPE OF WORK IS NOT INTENDED TO INDICATE THE FULL SCOPE, BUT ONLY A BROAD SUMMARY. THE GENERAL CONTRACTOR SHALL REFERENCE THE COMPLETE WORKLETTER FOR A MORE DETAILED DESCRIPTION OF WORK BY BOTH PARTIES. ANY QUESTIONS REGARDING SCOPE SHALL BE BROUGHT TO STARBUCKS ATTENTION FOR CLARIFICATION. RESPONSIBILITY INDICATED BELOW MEANS FURNISHED, PERMITTED AND INSTALLED BY THE PARTY INDICATED.

WORK DESCRIPTION	RESPONSIBILITY	
	EXISTING	STARBUCKS
MAIN BUILDING SERVICE AND POWER METER	X	
ELECTRICAL PANELS AND FEEDERS	X	
TEMPORARY POWER	N/A	N/A
ELECTRICAL PANEL BREAKERS		X
ABOVE FLOOR BRANCH CIRCUIT DISTRIBUTION		X
UNDER-FLOOR / SLAB POWER CONDUITS IN BUILDING (WIRING BY STARBUCKS)		X
UNDERGROUND SITE CONDUITS FOR DT, SIGNS, MENU BOARD, DETECTOR LOOP & DCB (WIRING / CABLING BY STARBUCKS)		X
SITE LIGHTING	X	
EXTERIOR BUILDING & PATIO LIGHTING	X	
DATA & PHONE SERVICE, DEMARC & (2) 2" CONDUITS TO STARBUCKS SPACE	X	
DT WINDOW POWER	X	
DT WINDOW EXTERIOR LIGHTS (2 EACH)	X	
FIRE ALARM SYSTEM	X	

ELECTRICAL SYMBOL LEGEND

ⓐ	JUNCTION BOX	⌚	RECEPTACLE: DUPLEX
Ⓢ	SWITCH	⌚	RECEPTACLE: QUAD
Ⓢ₃	THREE-WAY SWITCH	⌚	RECEPTACLE: HIGH VOLTAGE
Ⓢₘ	MOTION (OCCUPANCY) SENSOR SWITCH	⌚	RECEPTACLE: FLOOR DUPLEX
Ⓢ	SWITCHBACK	⌚	GROUNDING ELECTRODE CONNECTION
▼	TELEPHONE	NL	NIGHTLIGHTING 24HR/DAY
ⓐ	THERMOSTAT	Ⓢ	PHOTOELECTRIC CELL
Ⓢ	THERMOSTAT SENSOR	Ⓢ	SPEAKER
Ⓢ	DIMMER SWITCH	Ⓢ	WIFI ACCESS POINT
▽	RECEPTACLE: DATA	Ⓢ	360 CAMERA
Ⓢ	RACEWAY CONCEALED IN CEILING OR WALL. HASH MARKS INDICATE NUMBER OF WIRES. #12 AWG WIRE UNLESS OTHERWISE NOTED. TWO WIRES PLUS GROUND IF NO HASH MARKS SHOWN. LONG HASH MARK DENOTES NEUTRAL. GROUND WIRE NOT SHOWN.	Ⓢ	CARBON DIOXIDE SENSOR
		Ⓢ	CARBON MONOXIDE SENSOR

FIRE ALARM SYSTEM NOTES

IF STARBUCKS IS REQUIRED TO PROVIDE A FIRE ALARM AND/OR FIRE ALARM MONITORING AND/OR PHONE LINES FOR A FIRE ALARM, AS SPECIFIED IN THE LEASE AGREEMENT, THE CONTRACTOR IS TO NOTIFY GNOIC IMMEDIATELY THAT FIRE ALARM LINES ARE NEEDED. STARBUCKS PREFERRED FIRE ALARM SERVICE PROVIDER, STANLEY, IS TO BE CONTACTED BY THE CONSTRUCTION MANAGER TO INSTALL FIRE ALARM PANEL AND/OR MONITORING SERVICE AS REQUIRED.

CARBON MONOXIDE (CO) DETECTOR NOTES

COORDINATE INSTALLATION OF CARBON MONOXIDE (CO) DETECTOR DEVICE(S) AND LOW VOLTAGE WIRING WITH STARBUCKS SECURITY VENDOR FOR NEW STORES, RELOCATIONS AND MAJOR RENOVATIONS. VENDOR TO FURNISH AND INSTALL DEVICE(S) IN BOH AND FOH (AS APPLICABLE PER STARBUCKS STANDARDS). GC TO PROVIDE ROUGH-IN FOR SENSORS.

ENERGY MANAGEMENT SYSTEM (EMS)

THE GENERAL CONTRACTOR SHALL INSTALL SURVEYOR EMS. PRIOR TO LAST WEEK OF CONSTRUCTION, IF NEEDED, FURNISH AND INSTALL TEMPORARY THERMOSTATS AND SENSORS, AND ROUTE ALL LOW VOLTAGE WIRING THROUGH EC PROVIDED CONDUITS (COORDINATE WITH ELECTRICAL).

FURNISH AND INSTALL RACEWAYS WITH PULL STRINGS AND JUNCTION BOXES FOR THERMOSTAT(S) AND SENSOR(S).

SET RESTROOM OCCUPANCY SENSOR TO 5 MINUTE 'ON' DURATION IN SINGLE OCCUPANT RESTROOM AND TO 5 MINUTE 'ON' DURATION IN MULTI-OCCUPANT RESTROOM UNLESS JURISDICTION REQUIREMENTS STATE OTHERWISE.

COORDINATE WITH DRAWINGS AND LCP VENDOR FOR DEVICE LOCATIONS. VENDOR SHALL COMMISSION CONTROLS.

THE GENERAL CONTRACTOR IS TO COMPLETE FINAL CONNECTION AFTER DATA RACK AND NETWORK INSTALLATION. THE GENERAL CONTRACTOR IS TO CONTACT LCP VENDOR TO VERIFY SYSTEM OPERATION AND TROUBLESHOOT IF REQUIRED.

CLOSE-OUT NOTES

- A. WITHIN 30 DAYS OF DATE OF SYSTEM ACCEPTANCE, RECORD DRAWINGS OF THE ACTUAL INSTALLATION SHALL BE PROVIDED TO THE BUILDING OWNER. RECORD DRAWINGS SHALL INCLUDE, AT A MINIMUM, THE FOLLOWING:

1. A SINGLE-LINE DIAGRAM OF THE BUILDING ELECTRICAL DISTRIBUTION SYSTEM.

2. FLOOR PLANS INDICATING LOCATION AND AREA SERVED FOR ALL DISTRIBUTION.
- B. UPON COMPLETION OF PROJECT, PROVIDE OPERATION AND MAINTENANCE MANUALS TO OWNER. THE MANUALS SHALL CONTAIN, AT A MINIMUM, THE FOLLOWING INFORMATION:

1. SUBMITTAL DATA STATING EQUIPMENT RATING AND SELECTED OPTIONS FOR EACH PIECE OF EQUIPMENT REQUIRING MAINTENANCE.

2. OPERATION MANUALS AND MAINTENANCE MANUALS FOR EACH PIECE OF EQUIPMENT REQUIRING MAINTENANCE. ROUTINE MAINTENANCE ACTIONS SHALL BE CLEARLY IDENTIFIED.

3. NAMES AND ADDRESSES OF AT LEAST ONE QUALIFIED SERVICE AGENCY.
- C. PRIOR TO PASSING FINAL INSPECTION, THE CONTRACTOR SHALL PROVIDE EVIDENCE THAT THE LIGHTING CONTROL SYSTEMS HAVE BEEN TESTED TO ENSURE THAT CONTROL HARDWARE AND SOFTWARE ARE CALIBRATED, ADJUSTED, PROGRAMMED AND IN PROPER WORKING CONDITION IN ACCORDANCE TO THE CONSTRUCTION DOCUMENTS AND MANUFACTURER'S INSTRUCTIONS.

SYSTEM COMMISSIONING

CONTRACTOR RESPONSIBILITIES FOR BUILDING COMMISSIONING

CONTRACTOR SHALL PROVIDE SUPPORT AND WORK AS SPECIFIED, NEEDED AND REQUIRED TO CONDUCT AND FACILITATE STARBUCKS STAFF BUILDING COMMISSIONING EFFORTS. THIS WORK WILL BE COMPRISED OF THREE DISTINCT EFFORTS:

- 1) SUPPORT STARBUCKS COMMISSIONING AGENT (CXA) DURING INSTALLATION VERIFICATION AND CORRECT DISCLOSED DEFICIENCIES;

2) PERFORM TESTING, ADJUSTING, BALANCING AND SYSTEM STARTUP AND SUPPORT FUNCTIONAL PERFORMANCE TESTING BY STARBUCKS CXA;

3) CORRECT DEFICIENCIES DISCLOSED BY FUNCTIONAL PERFORMANCE TESTING AND SUBMIT REPORTS. CONTRACTOR SHALL PERFORM AND PROVIDE THE FOLLOWING:

A. SYSTEMS SUBJECT TO COMMISSIONING MAY INCLUDE, BUT ARE NOT LIMITED TO DOMESTIC HOT WATER GENERATION, HVAC SYSTEMS, ROOFTOP UNITS, EXHAUST FANS, HVAC CONTROLS, LIGHTING CONTROLS AND AIR CURTAINS.

B. CONTRACTOR SHALL INCLUDE COMMISSIONING ACTIVITIES IN PROJECT SCHEDULE AND SHOW INTERVALS FOR PERFORMANCE OF WORK FOR WHICH CONTRACTOR IS RESPONSIBLE AND INTERVALS FOR WORK PERFORMED BY STARBUCKS CXA. CONTRACTOR SHALL SHOW RESOURCES FOR PERFORMING ALL WORK RELATED TO COMMISSIONING ACTIVITIES ON A LINE ITEM IN THE SCHEDULE OF VALUES.

C. CONTRACTOR SHALL INSTALL EQUIPMENT IN ACCORDANCE WITH THE MANUFACTURER'S REQUIREMENTS AND ALL CONTRACT DOCUMENTS. ENSURE THAT ALL EQUIPMENT IS INSTALLED TOTALLY COMPLETE, AND ACCESSIBLE TO STARBUCKS CXA FOR INSTALLATION VERIFICATION AND FUNCTIONAL PERFORMANCE TESTING PRIOR TO THE SCHEDULED START OF INSTALLATION VERIFICATION.

D. INSTALLATION VERIFICATION SHALL BE PERFORMED BY STARBUCKS CXA. CONTRACTOR SHALL SUPPORT STARBUCKS CXA INSTALLATION VERIFICATION EFFORTS AS NECESSARY, PROVIDE ALL ACCESS AND EQUIPMENT NECESSARY FOR STARBUCKS STAFF TO VERIFY THAT THE EQUIPMENT IS INSTALLED CORRECTLY.

E. CONTRACTOR SHALL BE READILY AVAILABLE DURING INSTALLATION VERIFICATION TO CORRECT ANY DEFICIENCIES OR DEFECTS DISCLOSED BY THE INSTALLATION VERIFICATION PROCESS. CORRECTIONS SHALL BE MADE IN A TIMELY MANNER WITHOUT DISRUPTION OF THE CONSTRUCTION SCHEDULE.

F. ALL HVAC, EXHAUST FAN, AND AIR CURTAIN EQUIPMENT SHALL BE TESTED, ADJUSTED AND BALANCED BY THE CONTRACTOR'S TESTING, ADJUSTING AND BALANCE AGENT (SEE TESTING, ADJUSTING AND BALANCING) AFTER THE SYSTEM IS VERIFIED TO BE COMPLETE AND CORRECT BY STARBUCKS CXA. IN ACCORDANCE WITH THE REQUIREMENTS OF THESE DOCUMENTS. ALL HVAC CONTROL SYSTEMS SHALL BE TESTED TO ENSURE THAT CONTROL DEVICES, COMPONENTS, EQUIPMENT AND SYSTEMS ARE CALIBRATED, ADJUSTED AND OPERATE IN ACCORDANCE WITH THESE PLANS AND PROJECT MANUAL. SEQUENCES OF OPERATION SHALL BE TESTED TO ENSURE THAT THEY OPERATE IN ACCORDANCE WITH THE CONTRACT REQUIREMENTS. DELIVERABLES: PRELIMINARY, WRITTEN TESTING AND AIR BALANCE REPORT CONFORMING TO THE REQUIREMENTS SPECIFIED HEREIN, DOCUMENTING THE INFORMATION SPECIFIED, ETC. TO THE STARBUCKS CXA IMMEDIATELY UPON COMPLETION OF THE WORK.

G. CONTRACTOR SHALL INFORM STARBUCKS CXA WHEN EQUIPMENT IS READY FOR FUNCTIONAL PERFORMANCE TESTING. ALL EQUIPMENT SHALL BE READY FOR FUNCTIONAL PERFORMANCE TESTING PRIOR TO STARTING TESTING. CONTRACTOR SHALL OPERATE EQUIPMENT FOR STARBUCKS CXA AND VERIFY BY DEMONSTRATION THE CORRECT OPERATION OF EQUIPMENT, RESPONSE OF SENSORS, AND PROPER EXECUTION OF HVAC CONTROL AND LIGHTING SEQUENCES, INCLUDING BUT NOT LIMITED TO, AIR MOVEMENT, TEMPERATURE, SOUND, AND CONTROL RESPONSE. PROVIDE ANY SECURITY ACCESS, HARDWARE, SOFTWARE, OR OTHER SUPPORT AS NEEDED FOR THE STARBUCKS CXA TO EFFICIENTLY WITNESS AND DOCUMENT ALL EQUIPMENT TESTING. STARBUCKS CXA WILL RECORD THE EQUIPMENT OPERATION AND RESPONSE TO TESTING SEQUENCES AND PREPARE A LIST OF ANY DEFICIENCIES DISCLOSED BY THE FUNCTIONAL PERFORMANCE TESTS FOR CORRECTION BY THE CONTRACTOR. EQUIPMENT INCLUDES, BUT IS NOT LIMITED TO, AIR HANDLING UNITS, ROOFTOP AND SPLIT TYPE, CONDENSING UNITS, EXHAUST FANS, LIGHTING CONTROLS, ETC. DELIVERABLES: PROVIDE COMPLETED COPIES OF ALL START UP REPORTS, FILLED OUT ON THE MANUFACTURER'S FORMS, TO THE STARBUCKS CXA.
- H. CONTRACTOR IS RESPONSIBLE FOR CORRECTING ANY ISSUES OR DEFICIENCIES DISCLOSED DURING THE FUNCTIONAL PERFORMANCE TESTING PROCESS. CORRECTIONS SHOULD BE MADE IN A TIMELY MANNER WITHOUT DISRUPTION TO THE SYSTEM AND CONSTRUCTION SCHEDULE.
- I. CONTRACTOR SHALL BE READILY AVAILABLE FOR ANY RE-TESTING OF EQUIPMENT DEEMED NECESSARY BY STARBUCKS CXA DURING INSTALLATION VERIFICATION AND FUNCTIONAL PERFORMANCE TESTING. CONTRACTOR IS RESPONSIBLE FOR CORRECTING ANY ISSUES OR DEFICIENCIES FOUND IN THE SYSTEM DURING ANY AND ALL RE-TESTING. CORRECTIONS SHOULD BE MADE IN A TIMELY MANNER WITHOUT DISRUPTION TO THE SYSTEM AND CONSTRUCTION SCHEDULE. DELIVERABLES: FINAL BALANCE REPORT, DEFICIENCIES LIST NOTING CORRECTIVE ACTIONS PERFORMED BY CONTRACTOR IN RESPONSE TO INSTALLATION VERIFICATION AND FUNCTIONAL PERFORMANCE TEST RESULTS.
- J. CONSTRUCTION AND POST CONSTRUCTION TESTING: ADDITIONAL TESTING MAY BE REQUIRED AND OTHER PROCESSES THAT MAY OCCUR OUT OF SEQUENCE WITH COMMISSIONING SERVICE. CONTRACTOR SHALL CONDUCT, DOCUMENT, SUPPORT AND SCHEDULE THIS TESTING AS DIRECTED BY STARBUCKS CXA.

SECURITY SYSTEM NOTES

STARBUCKS CONTRACTS DIRECTLY WITH SECURITY VENDOR TO SUPPLY AND INSTALL THE SECURITY SYSTEM. CONTRACTOR TO SCHEDULE INSTALLATION OF SECURITY SYSTEM FOR FOUR (4) TIMES:

1. MEET TO PLAN SECURITY CABLE PULL WITH SECURITY CABLE INSTALLER PRIOR TO DRYWALL INSTALLATION.

2. SECURITY CABLE INSTALLER PULLS SECURITY CABLES, MOUNTS PANEL, KEYPAD AND SENSORS.

3. SECURITY EQUIPMENT INSTALL OF CAMERA, NVR AND MONITOR.

4. SECURITY MONITORING COMPANY TO BRING SYSTEM ONLINE AND TRAIN PARTNERS AFTER POS INSTALL.

SECURITY VENDOR REQUIRES A MINIMUM TWO (2) WEEKS LEAD TIME FOR EACH INSTALLATION. SECURITY VENDOR WILL COORDINATE REGIONAL INSTALLERS. ALL ADDITIONAL EXPENSES INCURRED DUE TO THE CONTRACTOR'S FAILURE TO SCHEDULE ACCORDINGLY WILL BE THE RESPONSIBILITY OF THE CONTRACTOR.

TELEPHONE SYSTEM NOTES

IF ADDITIONAL TELEPHONE LINES ARE REQUIRED BEYOND THE STANDARD SINGLE LINE (SUCH AS FOR A FIRE ALARM) THE GENERAL CONTRACTOR SHALL CONTACT THE STARBUCKS CONSTRUCTION MANAGER PRIOR TO BEGINNING CONSTRUCTION TO ORDER THE ADDITIONAL TELEPHONE LINE(S). REPORT ANY TELEPHONE INSTALLATION ISSUES IMMEDIATELY TO THE STARBUCKS CONSTRUCTION MANAGER.

CONFIRM PRIOR TO BEGINNING CONSTRUCTION THAT THERE ARE EXISTING, WORKING TELCO FACILITIES TO THE BUILDING OR THAT LANDLORD HAS FURNISHED AND INSTALLED ONE (1) 2" (51MM) MIN. (ENTRANCE) CONDUIT INCLUDING PULL STRING FROM TELCO STREET FEED LINE TO THE BUILDING AS IDENTIFIED BY THE PHONE COMPANY. NOTIFY STARBUCKS CONSTRUCTION MANAGER IMMEDIATELY IF FACILITIES OR CONDUIT AND PULL STRING ARE NOT INSTALLED.

GENERAL CONTRACTOR IS TO ENSURE THAT THERE IS A 2" (51MM) MIN. CONDUIT WITH PULL STRING FROM THE DATA RACK TO THE DEMARC (TELCO TO CUSTOMER HAND OFF EQUIPMENT) WHEN THE DEMARC IS MORE THAN 10' FROM THE DATA RACK. DISTANCES LESS THAN 10' WILL NOT REQUIRE CONDUIT.

PROVIDE A 3-POSITION GROUND LUG, GROUNDED WITH #6 AWG GROUND WIRE, IF REQUIRED BY TELEPHONE COMPANY.

ALL TELEPHONE/NETWORK CABLING IS THE SCOPE OF WORK OF THE TELEPHONE/NETWORK CABLING VENDOR.

POS \ DATA LINE NOTES

STARBUCKS CONTRACTS DIRECTLY WITH THE DATA CABLING VENDOR TO SUPPLY AND INSTALL CATEGORY 5e (Cat5e) LAN CABLE AND CONNECTORS FOR THE POINT OF SALE (POS) SYSTEMS. CONTRACTOR TO SCHEDULE INSTALLATION OF DATA CABLING WITH DATA CABLING VENDOR. DATA CABLING VENDOR REQUIRES A LEAD TIME FOR INSTALLATION. DATA CABLING VENDOR WILL COORDINATE REGIONAL INSTALLERS.

AT THE START OF CONSTRUCTION, STARBUCKS CONSTRUCTION MANAGER SCHEDULES DELIVERY OF CASH REGISTER/MANAGER'S WORKSTATION EQUIPMENT AND INSTALLATION BY A POS INSTALL TECHNICIAN FOR ONE (1) MONTH PRIOR TO STORE OPEN. CONTRACTOR TO VERIFY DELIVERY SCHEDULE TWO (2) WEEKS PRIOR TO DELIVERY AND INSTALLATION DATE. EQUIPMENT IS SHIPPED DIRECTLY TO THE STORE. CONTRACTOR TO ACCEPT POS EQUIPMENT DELIVERY. DO NOT REFUSE DELIVERY.

DATA CABLING TECHNICIAN TO PROVIDE ALL Cat5e LAN CABLING AND CONNECTORS FROM ALL DESIGNED AND FUTURE CASH REGISTER LOCATIONS, MANAGER'S WORKSTATION, ALL OTHER NETWORKED EQUIPMENT (CUP LABELERS, GLOVER, BUMP BAR, ETC.) AND WIRELESS ACCESS POINT TO THE DATA RACK AREA. CONTRACTOR IS TO HAVE CONDUIT WITH PULL STRING IN PLACE FOR ALL CABLE RUNS PRIOR TO CABLE INSTALL DATE.

STARBUCKS NEW STORE GROUP IS RESPONSIBLE FOR COORDINATING STARBUCKS POS SYSTEMS DELIVERY AND INSTALLATION WITH THE POS VENDOR. THIS GROUP MAY BE CONTACTED AT: NEWSTORES@STARBUCKS.COM.

COMMUNICATION SYSTEM NOTES

CONFIRM PRIOR TO BEGINNING CONSTRUCTION THAT THE LANDLORD HAS FURNISHED AND INSTALLED ONE (1) ADDITIONAL 2" (51MM) (ENTRANCE) CONDUIT INCLUDING PULL STRING (FOR A TOTAL OF TWO (2)) FROM THE STREET FEED TO THE BUILDING AS IDENTIFIED BY THE INTERNET SERVICE PROVIDER.

WIRELESS NETWORK NOTES

CABLING FOR INTERNET SERVICE SHALL BE FURNISHED AND INSTALLED BY THE VENDOR FOR FIBER OR BROADBAND CONNECTIONS. T1 AND ETHERNET EXTENSION CABLING IS PROVIDED BY THE STARBUCKS (TELEPHONE/ NETWORK) CABLING VENDOR. COORDINATE WITH STARBUCKS.

MUSIC SYSTEM NOTES

MOUNT OWNER FURNISHED SPEAKERS WHERE SHOWN ON INTERIOR REFLECTED CEILING PLANS AND IN COORDINATION WITH ALL PLANS, DETAILS AND MANUFACTURER'S INSTALLATION REQUIREMENTS. INSTALL AND CONNECT OWNER FURNISHED WIRING SYSTEM BETWEEN ALL SPEAKERS AND THE OWNER PROVIDED MUSIC SYSTEM. SET WATTAGE TAP ON EACH SPEAKER'S ROTARY SWITCH PER TAP SETTINGS NOTED ON PLANS.

GENERAL ELECTRICAL NOTES

1. THE ELECTRICAL CONTRACTOR SHALL COORDINATE ELECTRICAL WORK WITH OTHER TRADES. THE ARCHITECTURAL DRAWINGS SHALL TAKE PRECEDENCE OVER ALL OTHER DRAWINGS. DO NOT SCALE DISTANCES OFF THE ELECTRICAL DRAWINGS; USE ACTUAL BUILDING DIMENSIONS. OVERALL CASEWORK COMPONENT DIMENSIONING ON ELECTRICAL DETAILS ARE SHOWN FOR REFERENCE AND COORDINATION ONLY. SEE PROJECT MANUAL.

2. ALL ELECTRICAL SYSTEMS SHALL BE TESTED FOR PROPER OPERATION. BALANCE ALL BRANCH CIRCUIT LOADS BETWEEN THE PHASES OF THE SYSTEM WITHIN 10% OF THE HIGHEST PHASE LOAD IN EACH PANEL BOARD.

3. THE ELECTRICAL CONTRACTOR SHALL BE RESPONSIBLE FOR DE-ENERGIZING CIRCUITS IN DEMOLITION AREAS TO INSURE A SAFE CONDITION. ELECTRICAL DEVICES AND ASSOCIATED WIRING LOCATED WITHIN THE DEMOLITION AREA THAT WILL NO LONGER BE USED SHALL BE REMOVED AND PROPERLY DISPOSED OF AT CONTRACTORS EXPENSE UNLESS OTHERWISE NOTED.

4. THE ELECTRICAL CONTRACTOR SHALL SCHEDULE ALL ELECTRICAL SYSTEM OUTAGES WITH THE GENERAL CONTRACTOR AND LANDLORD AT LEAST 24 HOURS IN ADVANCE. UNLESS APPROVED OTHERWISE ALL OUTAGES SHALL OCCUR BETWEEN 11:00PM AND 5:00AM.

5. ELECTRICAL CONTRACTOR SHALL FURNISH AND INSTALL ALL NECESSARY CONDUIT AND J-BOXES TO SUPPORT A COMPLETE SECURITY, PHONE, POS AND DATA SYSTEMS. SEE MANAGER WORKSTATION AND BAR POINT OF SALE (POS) POWER/TELECOM/SECURITY DIAGRAM. COORDINATE ALL DEVICE LOCATIONS AND MOUNTING HEIGHTS WITH SECURITY VENDOR PRIOR TO ROUGH-IN. PROVIDE END-TO-END PULL STRINGS IN ALL CONDUITS. LABEL EACH END OF THE PULL STRING WITH CONDUIT SYSTEM (ELECTRICAL) AND DESTINATION ("CAFE", "FRONT BAR", ETC.). PROVIDE INSULATED BUSHINGS ON ALL STUBBED-UP AND EXPOSED CONDUIT ENDS.

6. ELECTRICAL CONTRACTOR SHALL COORDINATE WITH THE GENERAL CONTRACTOR TO PATCH AND REPAIR ALL EXISTING WALLS, FLOORS, CEILINGS OR OTHER SURFACES IDENTIFIED TO REMAIN THAT MAY BECOME DAMAGED DURING THE COURSE OF WORK.

7. EXPOSED/SURFACE MOUNTED CONDUITS SHALL ONLY BE ALLOWED WHERE NECESSARY IN EXPOSED CEILING AREAS. IF CONDUITS NEED TO BE SURFACE MOUNTED TO WALLS, COORDINATE WITH STARBUCKS CONSTRUCTION MANAGER FOR APPROVAL.

8. VERIFY LOCATION OF ALL OUTLETS AND SWITCHES WITH ARCHITECTURAL DRAWINGS, INTERIOR DETAILS, FINISH SCHEDULES, GENERAL CONTRACTOR, EQUIPMENT VENDORS, STARBUCKS AND EXISTING SITE CONDITIONS. VERIFY FINAL DOOR HINGE LOCATION PRIOR TO SWITCH INSTALLATION AND ADJUST SWITCH LOCATION IF NEEDED. DO NOT MOUNT RECEPTACLES/SWITCHES IN LOCATIONS THAT WOULD CONFLICT WITH MIRRORS, SEAMS OF WALLS, WAINSCOTS, TILE TRANSITIONS, ETC...

GENERAL NOTES

SCOPE
THE INTENT OF THE DRAWINGS AND PROJECT MANUAL IS TO PROVIDE A COMPLETE AND FULLY OPERATIONAL ELECTRICAL SYSTEM. THE ELECTRICAL CONTRACTOR SHALL FURNISH AND INSTALL ALL LABOR, MATERIAL, AND EQUIPMENT NECESSARY TO COMPLETE THE ELECTRICAL WORK.

SITE EXAMINATION
THE ELECTRICAL CONTRACTOR SHALL THOROUGHLY EXAMINE ALL AREAS WHERE EQUIPMENT, CONDUIT, AND WIRING WILL BE INSTALLED AND WILL REPORT ANY CONDITION THAT, IN HIS OPINION, PREVENTS THE PROPER INSTALLATION OF THE ELECTRICAL WORK.

STANDARDS
EQUIPMENT AND MATERIALS SHALL CONFORM WITH APPROPRIATE PROVISIONS OF CSA, UL, NEC, ASTM, UL, ETL, NEMA, ANSI, AS APPLICABLE TO EACH INDIVIDUAL UNIT OR ASSEMBLY.

CODES
ALL WORK SHALL BE PERFORMED IN STRICT ACCORDANCE WITH ALL APPLICABLE PROVINCIAL AND LOCAL CODES AND ORDINANCES. IN CASE OF CONFLICT BETWEEN THE DRAWINGS AND SPECIFICATIONS AND THE CODES, THE HIGHEST STANDARD SHALL APPLY. ELECTRICAL CONTRACTOR SHALL SATISFY CODE REQUIREMENTS AS A MINIMUM STANDARD WITHOUT ANY EXTRA COST TO STARBUCKS.

PERMITS AND FEES
THE ELECTRICAL CONTRACTOR SHALL PROCURE AND PAY FOR ALL PERMITS, FEES, AND INSPECTIONS NECESSARY TO COMPLETE THE ELECTRICAL WORK.

WARRANTY
THE ELECTRICAL CONTRACTOR SHALL UNCONDITIONALLY WARRANT ALL WORK TO BE FREE OF DEFECTS IN MATERIAL AND WORKMANSHIP FOR A PERIOD OF ONE (1) YEAR FROM THE DATE OF FINAL ACCEPTANCE BY STARBUCKS AND WILL REPAIR OR REPLACE ANY DEFECTIVE WORK PROMPTLY AND WITHOUT CHARGE AND RESTORE ANY OTHER EXISTING WORK DAMAGED IN THE COURSE OF REPAIRING DEFECTIVE MATERIALS AND WORKMANSHIP.

LANDLORD REQUIREMENTS

PRIOR TO BID: THE CONTRACTOR SHALL COORDINATE WITH LANDLORD / BUILDING OWNER FOR ANY CONSTRUCTION REQUIREMENTS. IF LANDLORD / BUILDING OWNER DOES HAVE REQUIREMENTS, CONTRACTOR SHALL BECOME COMPLETELY FAMILIAR WITH REQUIREMENTS AND ADHERE TO THEM. WHERE LANDLORD / BUILDING OWNER REQUIREMENTS ARE MORE STRINGENT THAN SHOWN IN THESE PLANS (IN THE OPINION OF THE ENGINEER), LANDLORD / BUILDING OWNER REQUIREMENTS SHALL GOVERN.



STARBUCKS®
2401 UTAH AVENUE SOUTH
SEATTLE, WASHINGTON 98134
(206) 318-1575

THESE DRAWINGS AND THE PROJECT MANUAL ARE CONFIDENTIAL AND SHALL REMAIN THE SOLE PROPERTY OF STARBUCKS CORPORATION, WHICH IS THE OWNER OF THE COPYRIGHT IN THIS WORK. THEY SHALL NOT BE REPRODUCED IN WHOLE OR IN PART, SHARED WITH THIRD PARTIES OR USED IN ANY MANNER ON OTHER PROJECTS OR EXTENSIONS TO THIS PROJECT WITHOUT THE PRIOR WRITTEN CONSENT OF STARBUCKS CORPORATION. THESE DRAWINGS AND SPECIFICATIONS ARE INTENDED TO EXPRESS DESIGN INTENT FOR A PROTOTYPICAL STARBUCKS STORE (WHICH IS SUBJECT TO CHANGE AT ANYTIME) AND DO NOT REFLECT ACTUAL SITE CONDITIONS. NEITHER PARTY SHALL HAVE ANY OBLIGATION OR LIABILITY TO THE OTHER (EXCEPT STATED ABOVE) UNTIL A WRITTEN AGREEMENT IS FULLY EXECUTED BY BOTH PARTIES.

STARBUCKS TEMPLATE VERSION: i2023-05-01

Design Forum Architects Inc.

2056 Byers Rd
Miami Springs, OH 45342
Tel: (844) 804-7700

Donald J. Bethman
Architect in Charge



4850 SMITH RD., STE. 101
CINCINNATI, OH 45212
513.901.0040
WWW.MARQUEENG.COM

FOR CONSTRUCTION

PROJECT NAME:
S SEMORAN BLVD &
LEE VISTA BLVD

PROJECT ADDRESS:
6605 S SEMORAN BLVD,
ORLANDO, FL 32822

STORE #:	9875
PROJECT #:	25630-101
ISSUE DATE:	03/04/2024
DESIGN MANAGER:	MARTIN PEREZ
PRODUCTION DESIGNER:	ANDY MCLOUD
CHECKED BY:	EVAN DUFFY

Revision Schedule			
Rev	Date	By	Description

SHEET TITLE:
ELECTRICAL NOTES

SCALE: 1/4" = 1'-0"

SHEET NUMBER:

E001

KITCHEN EQUIPMENT SCHEDULE				
DESIGN ID	DESCRIPTION	ELECTRICAL DATA	CIRCUIT	NEMA CONFIGURATION
10075	CUP LABELLER	120 V/1-180 VA	A-17	5-15R
10075	CUP LABELLER	120 V/1-180 VA	A-17	5-15R
10075	CUP LABELLER	120 V/1-180 VA	A-17	5-15R
10075	CUP LABELLER	120 V/1-180 VA	A-17	5-15R
10267	FRIDGE UNDERCOUNTER 1 DOOR - 27IN 685MM	120 V/1-480 VA	A-2	5-15R
10267	FRIDGE UNDERCOUNTER 1 DOOR - 27IN 685MM	120 V/1-480 VA	A-8	5-15R
10267	FRIDGE UNDERCOUNTER 1 DOOR - 27IN 685MM	120 V/1-480 VA	A-34	5-15R
10267	FRIDGE UNDERCOUNTER 1 DOOR - 27IN 685MM	120 V/1-480 VA	A-12	5-15R
10267	FRIDGE UNDERCOUNTER 1 DOOR - 27IN 685MM	120 V/1-480 VA	A-36	5-15R
10808	GRINDER DITTING KR1203	120 V/1-1560 VA	A-19	5-20R
10970	FRIDGE REACH IN 1 DOOR LH - 29IN 735MM	120 V/1-300 VA	C-4	5-15R
10970	FRIDGE REACH IN 1 DOOR LH - 29IN 735MM	120 V/1-300 VA	B-17	5-15R
10970	FRIDGE REACH IN 1 DOOR LH - 29IN 735MM	120 V/1-300 VA	B-23	5-15R
10970	FRIDGE REACH IN 1 DOOR LH - 29IN 735MM	120 V/1-300 VA	B-42	5-15R
12508	BLENDER QUIET MODEL ON COUNTER	120 V/1-1800 VA	A-13	5-20R
12508	BLENDER QUIET MODEL ON COUNTER	120 V/1-1800 VA	A-4	5-20R
12618	FRIDGE UNDERCOUNTER 1 DOOR WITH SHELF - 27IN 685MM	120 V/1-480 VA	A-35	5-15R
12618	FRIDGE UNDERCOUNTER 1 DOOR WITH SHELF - 27IN 685MM	120 V/1-480 VA	A-10	5-15R
12618	FRIDGE UNDERCOUNTER 1 DOOR WITH SHELF - 27IN 685MM	120 V/1-480 VA	B-1	5-15R
13676	FREEZER REACH IN 1 DOOR RH - 27IN 685MM	120 V/1-864 VA	C-25	5-15R
13676	FREEZER REACH IN 1 DOOR RH - 27IN 685MM	120 V/1-864 VA	C-27	5-15R
13676	FREEZER REACH IN 1 DOOR RH - 27IN 685MM	120 V/1-864 VA	C-18	5-15R
13676	FREEZER REACH IN 1 DOOR RH - 27IN 685MM	120 V/1-864 VA	B-27	5-15R
15186	DISHWASHER HOT LOW STEAM	208 V/2-6344 VA	A-29,31	14-40R
17564	VITAMIX BLENDER PITCHER RINSER WITH SENSOR	120 V/1-1200 VA	C-23	5-20R
19742	ESPRESSO MACHINE MASTRENA 2.0	208 V/2-5800 VA	A-39,41	6-50R
19742	ESPRESSO MACHINE MASTRENA 2.0	208 V/2-5800 VA	A-16,18	6-50R
20011	FRIDGE NITRO 2 TAP	120 V/1-300 VA	B-13	5-15R
21679	NITROGEN GENERATOR ELEMENT COMPACT	120 V/1-336 VA	B-15	5-15R
22642	MARCO II INSTA HOT	120 V/1-1500 VA	A-15	5-15R
22642	MARCO II INSTA HOT	120 V/1-1500 VA	A-11	5-15R
22885	BREWER CLOVER VERTICA DOUBLE	208 V/2-8320 VA	A-7,9	14-50R
23183	ICE - MACHINE HMC1410ABT AIR COOLED	208 V/2-3100 VA	A-25,27	6-20R
23423	ICE DIVERTER	120 V/1-180 VA	A-32	5-15R
23424	ICE DIVERTER CONTROL PANEL	120 V/1-180 VA	C-21	5-15R
23440	FOOD CASE - WARMING WALL - 1000 SQUARE	208 V/2-6000 VA	B-3,5	6-30R
23443	COMBI OVEN	208 V/3-8500 VA	A-1,3,5	15-50R

GROUND FAULT PROTECTION NOTES

- PROVIDE GFCI PROTECTION AS REQUIRED BY NEC 210.8.
- CIRCUITS REQUIRING GFCI PROTECTION IDENTIFIED WITH * ON PANEL SCHEDULES (SEE E-601).
- ABOVE-COUNTER RECEPTACLES THAT ARE READILY ACCESSIBLE AND WITHIN REACH OF PARTNERS SHALL BE GFCI TYPE.
- BELOW-COUNTER RECEPTACLES, OR RECEPTACLES THAT ARE DIFFICULT TO REACH OR REQUIRE MOVING EQUIPMENT TO RESET, AND ARE NOT READILY ACCESSIBLE SHALL BE PROTECTED BY GFI CIRCUIT BREAKERS.
- WHERE THE AVAILABLE SHORT CIRCUIT CURRENT EXCEEDS 22,000 AMPS AT THE PANELBOARD, CONTACT CIRCUIT BREAKER MANUFACTURER AND PROVIDE GFCI TYPE CIRCUIT BREAKER THAT SERIES RATES WITH PANEL OVER CURRENT PROTECTION IF AVAILABLE.
- WHERE THE AVAILABLE SHORT CIRCUIT CURRENT EXCEEDS 22,000 AMPS AT THE PANELBOARD, AND GFCI BREAKERS ARE NOT AVAILABLE, PROVIDE DEAD-FRONT GFCIS (IN A READILY ACCESSIBLE LOCATION) TO SERVE RECEPTACLES THAT ARE NOT READILY ACCESSIBLE.

GENERAL NOTES


- REFER TO ELECTRICAL DETAIL SHEETS FOR EXACT LOCATIONS AND MOUNTING HEIGHTS OF ELECTRICAL DEVICES.
- THE ELECTRICAL CONTRACTOR IS RESPONSIBLE FOR CONFIRMING ALL VOLTAGE REQUIREMENTS ON ALL EQUIPMENT AND PROVIDING BUCK-BOOST TRANSFORMERS AS MAY BE NEEDED FOR CODE. ALL ARE NOT NECESSARILY INDICATED.
- ELECTRICAL CONTRACTOR SHALL COORDINATE WITH PLUMBING AND HEATING, VENTILATING, AND AIR CONDITIONING (HVAC) CONTRACTORS FOR ANY ADDITIONAL EQUIPMENT NEEDING POWER.
- ANY EQUIPMENT NOTED AS 'FUTURE' SHALL BE PROVIDED WITH APPROPRIATE RECEPTACLES AND WIRING TO ENABLE FUTURE OPERATION.
- GROUND FAULT CIRCUIT INTERRUPTER (GFCI) BREAKERS (NOT RECEPTACLES) SHALL BE UTILIZED WHERE REQUIRED BY CODE AND AT ANY FLOOR BOXES. PROVIDE DEDICATED NEUTRAL WIRE FOR ALL THESE CIRCUITS.
- EQUIPMENT REQUIRES CONNECTION TO THE BUILDING ELECTRICAL SYSTEM. FURNISH AND INSTALL ALL NECESSARY CONDUIT, WIRE, CONNECTIONS, RECEPTACLES AND OVERCURRENT PROTECTION NECESSARY TO ENSURE THE EQUIPMENT FUNCTIONS PROPERLY AND COMPLIES WITH ALL APPLICABLE LOCAL AND NATIONAL CODES. COORDINATE EQUIPMENT REQUIREMENTS WITH MANUFACTURER CUT SHEET PRIOR TO ROUGH-IN.
- ALL FRONT BAR J-BOXES AND OUTLETS SHALL BE SURFACE MOUNTED. PROVIDE CONDUITS AS NEEDED AND ONE (1) ADDITIONAL SPARE CONDUIT BETWEEN ALL J-BOXES FOR FUTURE ELECTRICAL REQUIREMENTS. ALL J-BOXES SHALL BE POSITIONED TO AVOID OBSTRUCTION OF ANY EQUIPMENT SUCH AS REFRIGERATORS AND DISHWASHERS.
- REFERENCE LANDLORD WORK LETTER FOR DIVISION OF ELECTRICAL SCOPE OF WORK AND COORDINATE WITH STARBUCKS CONSTRUCTION MANAGER.

KEYED NOTES

- DUAL BREWER: PROVIDE NEMA 14-50R RECEPTACLE, HUBBELL HBL9450A SERIES OR EQUAL MOUNTED AT 48" AFF AND INSTALL NECESSARY CONDUIT, WIRE AND CONNECTIONS BACK TO SERVING PANEL. PROVIDE NEMA 14-50P ANGLED PLUG AND CORD, HUBBELL HBL9452C SERIES OR EQUAL.
- RELOCATED ESPRESSO MACHINE: PROVIDE NEMA 6-40R RECEPTACLE, HUBBELL9367 SERIES OR EQUAL MOUNTED AT 30" AFF AND INSTALL NECESSARY CONDUIT, WIRE AND CONNECTIONS BACK TO SERVING PANEL. PROVIDE NEMA 6-40P ANGLED PLUG, HUBBELL HBL9368 SERIES OR EQUAL.
- RELOCATED WARMING OVEN: PROVIDE NEMA 6-30R RECEPTACLE MOUNTED AT 26" AFF AND INSTALL NECESSARY CONDUIT, WIRE AND CONNECTIONS BACK TO SERVING PANEL.
- RELOCATED CUP LABELER OR MOBILE ORDER PRINTER: PROVIDE RECEPTACLE AND BACKBOX FOR DATA OUTLET MOUNTED AT 26" AFF. ROUTE 3/4" CONDUIT FROM BACKBOX TO DATA RACK NEAR MANAGER'S WORK STATION. LABEL CONDUIT FOR DATA CABLING AND PROVIDE PULL STRING FROM END TO END.
- FLOOR POWER/DATA: SEE PENETRATION PLAN FOR EXACT DIMENSIONING OR LOCATION.
- RELOCATED POS: FURNISH AND INSTALL DOUBLE-DUPLEX MOUNTED AT 18" AFF PROVIDE DEDICATED GROUND WIRE BACK TO SERVING PANEL. INSTALL (1) J-BOX FOR DATA OUTLET AND (1) J-BOX FOR PHONE OUTLET MOUNTED AT 18" AFF. SEE DETAILS ON E-501.
- LOCATION OF RELOCATED ALARM KEYPAD AND EMERGENCY CALL PHONE.
- ALL BACK BAR AND FRONT BAR J-BOXES AND OUTLETS SHALL BE SURFACE MOUNTED. PROVIDE CONDUITS AS NEEDED AND (1) ADDITIONAL SPARE CONDUIT BETWEEN ALL J-BOXES FOR FUTURE ELECTRICAL REQUIREMENTS. ALL J-BOXES SHALL BE POSITIONED TO AVOID OBSTRUCTION OF ANY EQUIPMENT SUCH AS REFRIGERATORS AND DISHWASHERS.
- EXISTING "SHOW WINDOW" RECEPTACLE FLUSH MOUNTED IN WALL OR CEILING WITHIN 18" OF TOP OF WINDOW, 1 PER 12 LF OF WINDOW OR MAJOR FRACTION THEREOF (NEC 210.62) TO REMAIN.
- EXISTNG WATER FILTER SYSTEM TO REMAIN. MAINTAIN EXISTING BRANCH CIRCUIT. VERIFY EXACT CIRCUIT IN FIELD.
- FOOD CASE: PROVIDE NEMA 6-20R RECEPTACLE, HUBBELL HBL5462 SERIES OR EQUAL MOUNTED AT 18" AFF AND INSTALL NECESSARY CONDUIT, WIRE, AND CONNECTIONS BACK TO SERVING PANEL. PROVIDE NEMA 6-20P ANGLED PLUG, HUBBELL HBL5466C SERIES OR EQUAL.
- DATA OUTLET FOR FUTURE USE: PROVIDE BACKBOX FOR DATA OUTLET MOUNTED AT 26" AFF. ROUTE 3/4" CONDUIT FROM BACKBOX TO DATA RACK NEAR MANAGER'S WORK STATION. LABEL CONDUIT FOR DATA CABLING AND PROVIDE PULL STRING FROM END TO END.
- PROVIDE RECEPTACLE FOR RINSE SINK MOUNTED AT 26" AFF. COORDINATE EXACT LOCATION WITH OWNERS' REPRESENTATIVE.
- EXHAUST FAN SHALL BE CONTACTOR CONTROLLED; FAN TO RUN CONTINUOUSLY DURING OCCUPIED MODE (SEE CONTROL DIAGRAM ON E-601). CONFIRM EXACT LOCATION WITH THE MECHANICAL CONTRACTOR.

KEYED NOTES CONTINUED

- MAINTAIN EXISTING ELECTRICAL CONNECTION TO EXISTING ROOF TOP AC UNIT.
- EXISTING DRIVE THRU WINDOW CONTROL TO REMAIN. MAINTAIN EXISTING CIRCUIT. VERIFY EXACT CIRCUIT IN FIELD.
- EXISTING DRIVE THRU AIR CURTAIN TO REMAIN. MAINTAIN EXISTING CIRCUIT.
- PROVIDE 4-SQUARE J-BOX FOR FRONT OF HOUSE STROBE LOCATION; SEE DETAIL ON E-501.
- PROVIDE 4-SQUARE J-BOX FOR BACK OF HOUSE STROBE LOCATION; FIELD VERIFY EXACT LOCATION.
- EXISTING RECEPTACLE TO REMAIN. MAINTAIN EXISTING CIRCUIT.
- COMBINATION OVEN: PROVIDE NEMA 15-50R RECEPTACLE, HUBBELL HBL8450A SERIES OR EQUAL MOUNTED AT 18" AFF AND INSTALL NECESSARY CONDUIT, WIRE, AND CONNECTIONS BACK TO SERVING PANEL. PROVIDE NEMA 15-50P ANGLED PLUG, HUBBELL HBL8451C SERIES OR EQUAL.
- WARMING WALL: PROVIDE NEMA 6-30R RECEPTACLE, HUBBELL HBL9330 SERIES OR EQUAL MOUNTED AT 18" AFF AND INSTALL NECESSARY CONDUIT, WIRE, AND CONNECTIONS BACK TO SERVING PANEL. PROVIDE NEMA 6-30P ANGLED PLUG, HUBBELL HBL9331 SERIES OR EQUAL.
- PROVIDE 20A, 120V, GFCI TYPE RECEPTACLE FOR HOT WATER RECIRCULATION PUMP, AQUASTAT AND TIMER. COORDINATE EXACT LOCATION WITH OWNER'S REPRESENTATIVE.
- IF NOT EXISTING, PROVIDE WP/WR GFI SERVICE RECEPTACLE AT ROOFTOP UNIT.

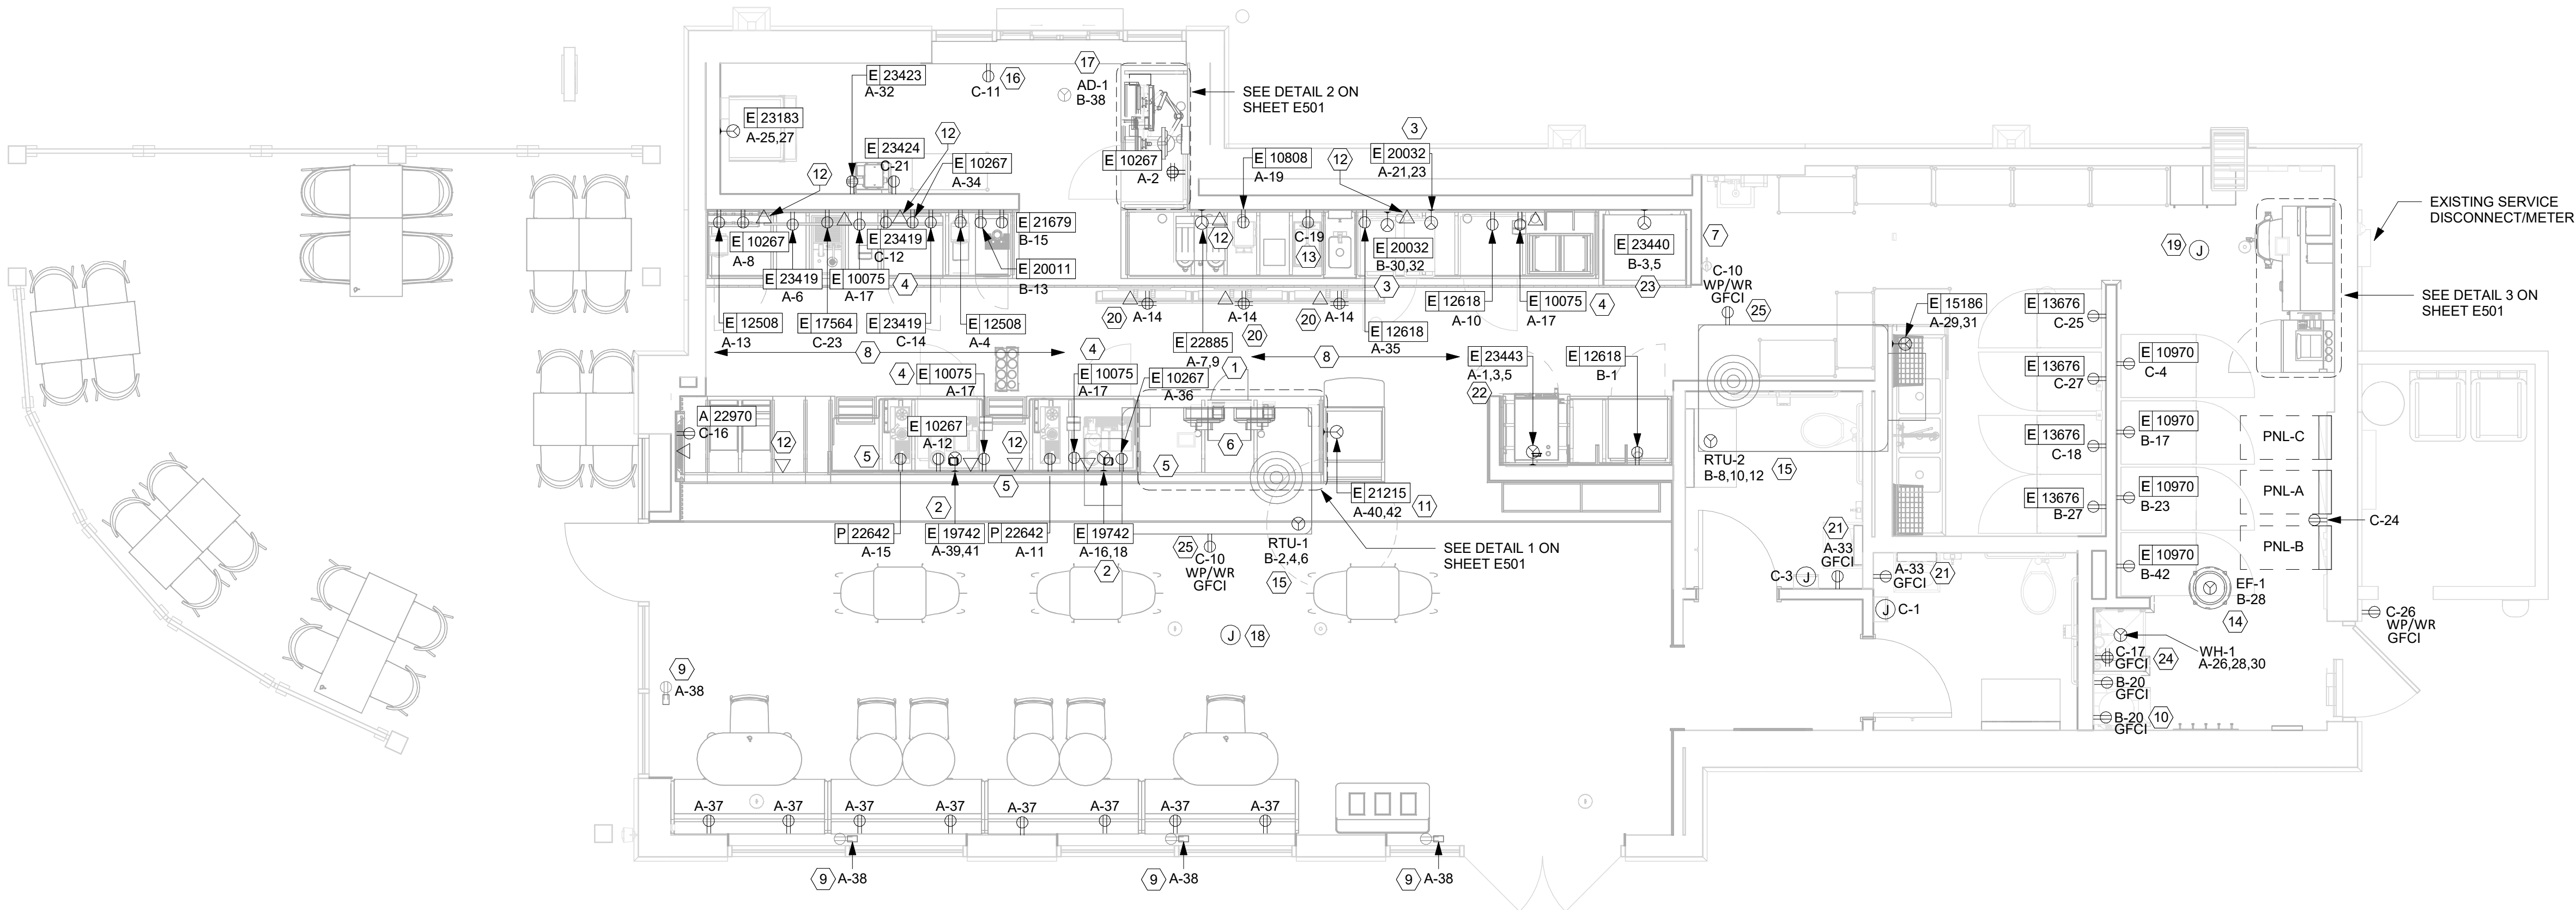

1 POWER PLAN
Scale: 1/4" = 1'-0"

FOR CONSTRUCTION



© 2019 STARBUCKS COFFEE COMPANY

STARBUCKS®
2401 UTAH AVENUE SOUTH
SEATTLE, WASHINGTON 98134
(206) 318-1575


THESE DRAWINGS AND THE PROJECT MANUAL ARE CONFIDENTIAL AND SHALL REMAIN THE SOLE PROPERTY OF STARBUCKS CORPORATION, WHICH IS THE OWNER OF THE COPYRIGHT IN THIS WORK. THEY SHALL NOT BE REPRODUCED IN WHOLE OR IN PART, SHARED WITH THIRD PARTIES OR USED IN ANY MANNER ON OTHER PROJECTS OR EXTENSIONS TO THIS PROJECT WITHOUT THE PRIOR WRITTEN CONSENT OF STARBUCKS CORPORATION. THESE DRAWINGS AND SPECIFICATIONS ARE INTENDED TO EXPRESS DESIGN INTENT FOR A PROTOTYPICAL STARBUCKS STORE (WHICH IS SUBJECT TO CHANGE AT ANYTIME) AND DO NOT REFLECT ACTUAL SITE CONDITIONS. NEITHER PARTY SHALL HAVE ANY OBLIGATION NOR LIABILITY TO THE OTHER (EXCEPT STATED ABOVE) UNTIL A WRITTEN AGREEMENT IS FULLY EXECUTED BY BOTH PARTIES.

STARBUCKS TEMPLATE VERSION: i2023-05-01

Design Forum Architects Inc.

2956 Byers Rd
Miami, OH 45342
Tel: (644) 804-7700

Donald J. Bethman
Architect in Charge

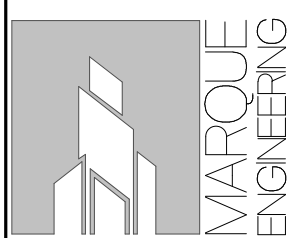

4850 SMITH RD., STE. 101
CINCINNATI, OH 45212
513.901.0040
WWW.MARQUEENG.COM

PROJECT NAME:
S SEMORAN BLVD & LEE VISTA BLVD

PROJECT ADDRESS:
**6605 S SEMORAN BLVD,
ORLANDO, FL 32822**

STORE #: 9875
PROJECT #: 25630-101
ISSUE DATE: 03/04/2024
DESIGN MANAGER: MARTIN PEREZ
PRODUCTION DESIGNER: ANDY MCLOUD
CHECKED BY: EVAN DUFFY

Revision Schedule			
Rev	Date	By	Description

SHEET TITLE:
ELECTRICAL DESIGN PLAN

SCALE: 1/4" = 1'-0"

SHEET NUMBER:

E101









DATA DEVICE SCHEDULE - "A"						
DESIGN ID	COUNT	DESCRIPTION	FURN. BY	INST. BY	COMMENTS	
AUDIO VISUAL						
10005	1	MUSIC SYSTEM	SB	GC		
19339	1	AMPLIFIER - 40W	SB	GC		
DATA						
10002	1	COMPUTER MANAGER WORKSTATION	SB	GC		
10007	1	PRINTER MANAGER WORKSTATION	SB	GC		
18744	1	EQUIPMENT RACK WITH LOCK - 24IN 610MM	SB	GC		
20294	3	IOT MODULE				
GRAPHICS - INTERIOR MENU						
22970	1	MENU BOARD - DIGITAL DISPLAY - 44X25.25IN 1121X644MM - BLACK	SB	GC		
23021	1	MENU BOARD - ORDER STATUS BOARD MOUNTING BRACKET - BLACK	SB	GC	SEE DETAIL: 1/1-514	
POINT OF SALE						
10022	1	MONEY COUNTER	SB	GC		
10029	1	POS BANK	SB	GC		
10075	4	CUP LABELER	SB	GC		


RESPONSIBILITY LEGEND

SB-GC	FURNISHED BY STARBUCKS - INSTALLED BY GENERAL CONTRACTOR
SB-SB	FURNISHED BY STARBUCKS - INSTALLED BY STARBUCKS
GC-GC	FURNISHED BY GENERAL CONTRACTOR - INSTALLED BY GENERAL CONTRACTOR
LL-LL	FURNISHED BY LANDLORD - INSTALLED BY LANDLORD

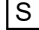NOTE: ALL RESPONSIBILITIES TO BE CONFIRMED WITH STARBUCKS DESIGN MANAGER PRIOR TO ORDERING/CONSTRUCTION.

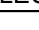LOW VOLTAGE ELECTRICAL SYMBOLS LEGEND

-  CARBON MONOXIDE DETECTOR
-  WIRELESS DOOR POSITION SWITCH
-  SECURITY KEY PAD
-  WIRELESS PIR MOTION SENSOR
-  LOCAL EXCHANGE CARRIER
(DEMARCATIION POINT)
-  WI-FI ACCESS POINT
-  SECURITY CAMERA
-  SPEAKER

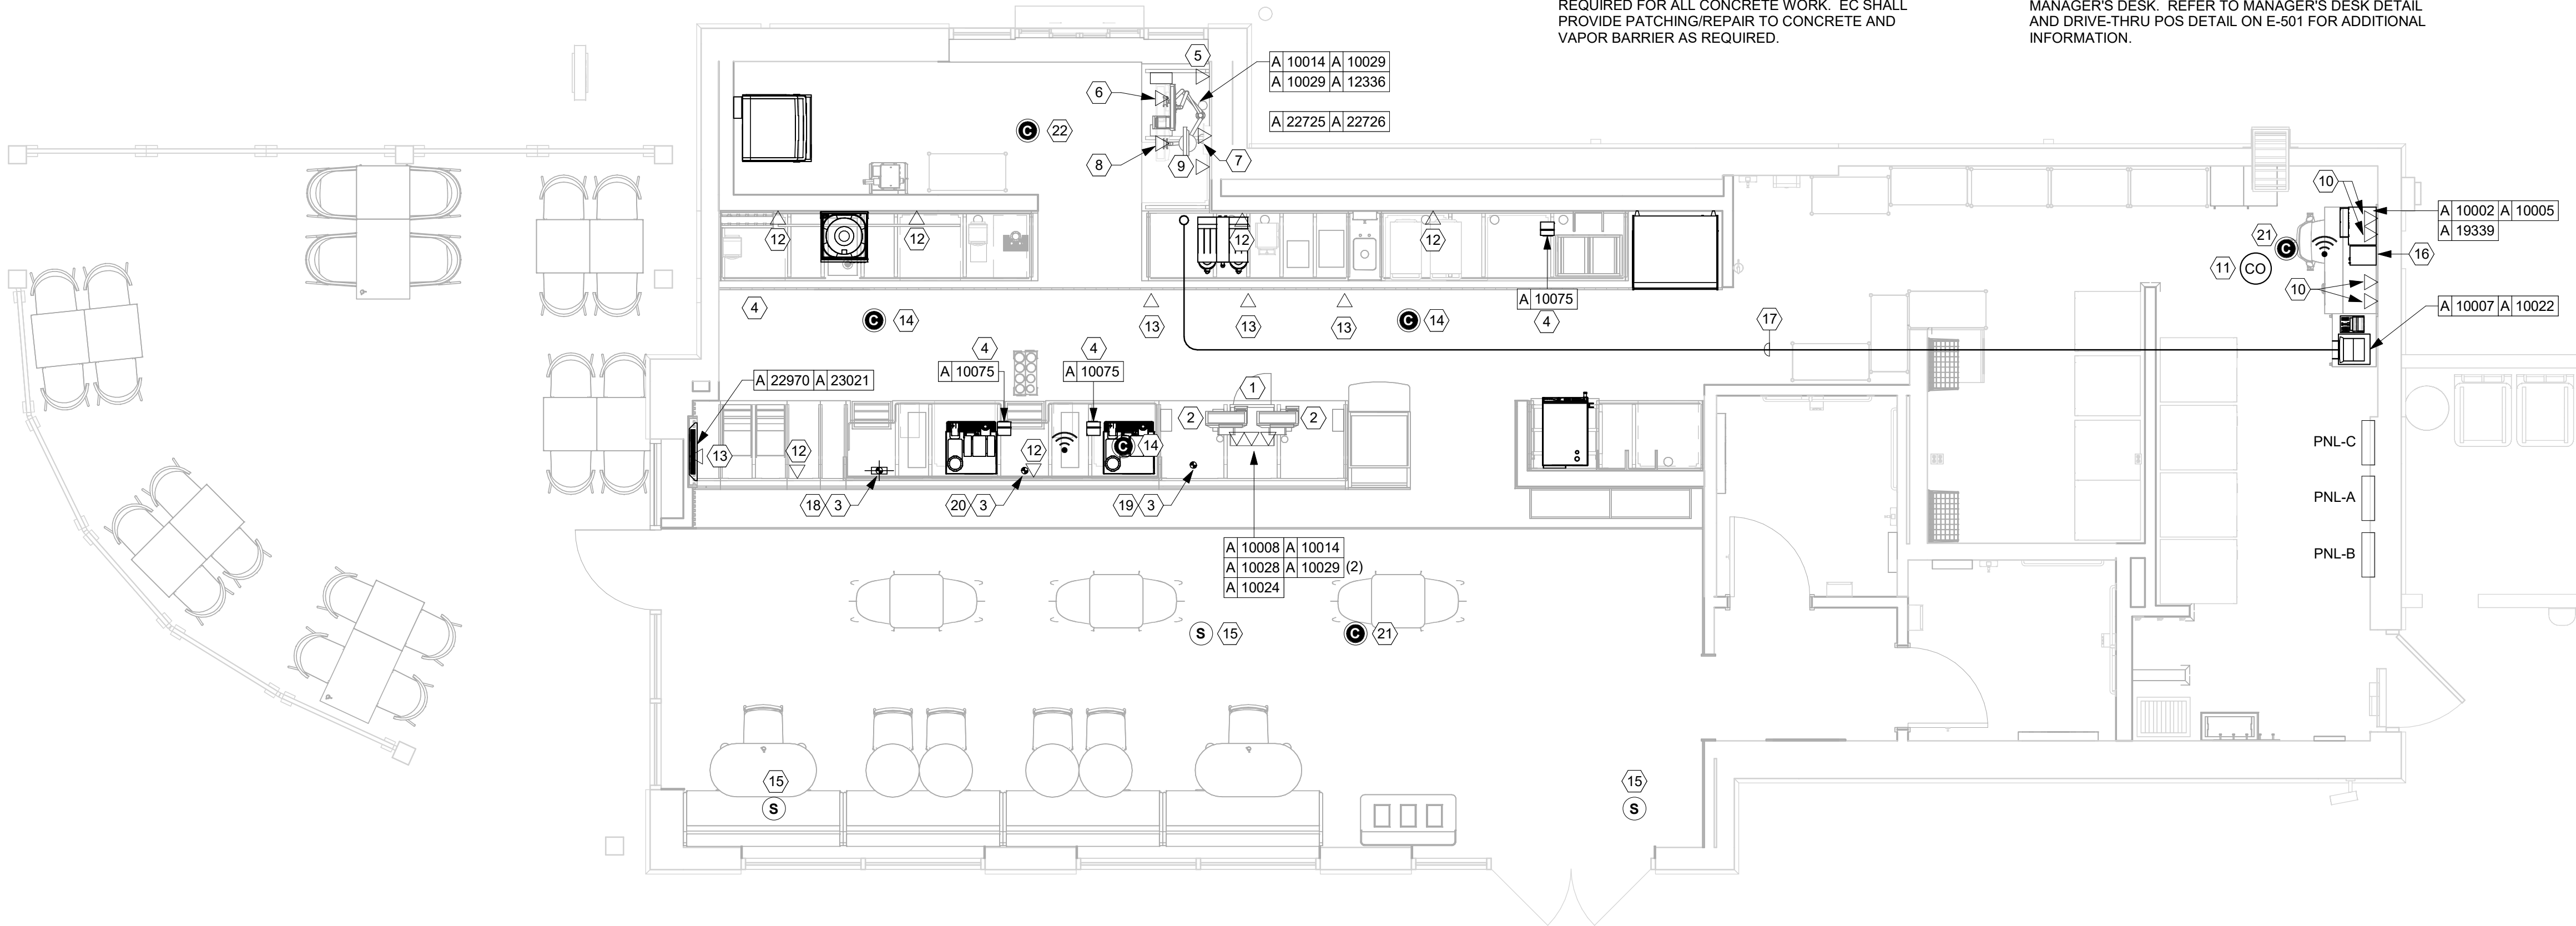

1 LOW VOLTAGE PLAN

Scale: 1/4" = 1'-0"

SECURITY NOTES

1. ENTRY CAMERA: CAPTURE ENTRY DOORWAY AND CUSTOMER TOP OF HEAD TO KNEES. PROVIDE (1) CAMERA AT EACH ENTRY.
2. POS CAMERA: PRIMARY OBJECTIVE IS CUSTOMER; SECONDARY IS TRANSACTION PLANE. CAPTURE MULTIPLE POS LOCATIONS.
3. SAFE CAMERA: POSITION TO VIEW FROM HANDLE SIDE OF DOOR. POS CAMERA CAN BE USED WHEN SAFE IS LOCATED BELOW TERMINALS.
4. DRIVE THRU CAMERA: PRIMARY OBJECTIVE IS CUSTOMER; SECONDARY IS POS. IDEAL PLACEMENT WOULD CAPTURE BOTH.
5. BOH CAMERA: CAPTURES CASH HANDLING.
6. CARBON MONOXIDE: AT LEAST ONE CARBON MONOXIDE (CO) DETECTOR TO BE LOCATED IN THE BACK OF HOUSE. PROVIDE SECOND DETECTOR IN CAFE IF SPACE INCLUDES A FIREPLACE.

MUSIC NOTES

1. GC SHALL INSTALL SPEAKERS AND WIRING PER DRAWING.
2. SPEAKER PLACEMENT: LOCATE (1) PER 250 SF OF CAFE SPACE @ 14'-0" MIN TO 18'-0" MAC [4267-5486MM O.C.
3. SPEAKER PAINTING: SPEAKER GRILLS CAN BE PAINTED. NOTE: GRILL HOLES SHALL REMAIN OPEN.
4. G.C. SHALL INSTALL MUSIC SYSTEM, CONNECT WIRING, AND TEST.

DATA PORT RECEPTACLE KEY

+ [HEIGHT A.F.F.] ▽ PORT NAME

GENERAL NOTES

- FURNISH AND INSTALL A COMPLETE AND OPERATING SYSTEM. ALL ITEMS ARE NOT NECESSARILY SHOWN.
- B. ELECTRICAL CONTRACTOR RESPONSIBLE FOR SITE INVESTIGATION PRIOR TO START OF WORK TO REVEAL FULL SCOPE OF WORK.
- C. DIMENSIONS ARE TO FINISH FACE UNLESS OTHERWISE NOTED.
- D. REFER TO DETAIL SHEETS FOR EXACT LOCATIONS AND MOUNTING HEIGHTS OF ELECTRICAL DEVICES.
- E. THE ELECTRICAL CONTRACTOR IS RESPONSIBLE FOR CONFIRMING ALL REQUIREMENTS ON ALL EQUIPMENT AND PROVIDING BUCK-BOOST TRANSFORMERS AS MAY BE NEEDED FOR CODE. ALL ARE NOT NECESSARILY INDICATED.
- F. ELECTRICAL CONTRACTOR SHALL COORDINATE WITH PLUMBING AND HEATING, VENTILATING, AND AIR CONDITIONING (HVAC) CONTRACTORS FOR ANY ADDITIONAL EQUIPMENT NEEDED POWER.
- G. ALL FUTURE EQUIPMENT NEEDED HEREIN SHALL BE PROVIDED WITH AN APPROPRIATE RECEPTACLE AND FULLY WIRED, EVEN IF NOT SPECIFICALLY INDICATED.
- H. GROUND FAULT CIRCUIT INTERRUPTER (GFCI) BREAKERS (NOT RECEPTACLES) SHALL BE UTILIZED WHERE REQUIRED BY CODES AND ANY FLOOR BOXES. PROVIDE DEDICATED NEUTRAL WIRE FOR ALL THESE CIRCUITS.
- I. EQUIPMENT REQUIRES CONNECTION TO THE BUILDING ELECTRICAL SYSTEM. FURNISH AND INSTALL ALL NECESSARY CONDUIT, WIRE, CONNECTIONS, AND OVERCURRENT PROTECTION NECESSARY TO ENSURE THE EQUIPMENT FUNCTIONED PROPERLY AND COMPLIES WITH ALL APPLICABLE LOCAL AND NATIONAL CODES. COORDINATE EQUIPMENT REQUIREMENTS WITH MANUFACTURER CUT SHEET PRIOR TO ROUGH-IN.
- J. ALL BACK RACK AND FRONT RACK J-BOXES AND OUTLETS SHALL BE PROVIDED AND LOCATED. PROVIDE CONDUITS AS NEEDED AND (1) ADDITIONAL FLARE CONDUIT BETWEEN ALL J-BOXES FOR FUTURE ELECTRICAL REQUIREMENTS. ALL J-BOXES SHALL BE POSITIONED TO AVOID OBSTRUCTION OF ANY EQUIPMENT SUCH AS REFRIGERATORS AND DISHWASHERS.
- K. STUB-UP POWER, DATA, AND PHONE CONDUITS 6" AFF IN THIS LOCATION. ROUTE POWER CONDUCTORS IN FLEXIBLE METAL CONDUIT TIGHT TO WALL FROM RECEPTACLES TO NEARBY RIGID STUB-UP AND BACK TO SERVING POWER PANEL. ROUTE DATA AND PHONE CONDUITS UNDER FLOOR BACK TO DATA RACK NEAR MANAGER'S WORKSTATION. LABEL DATA AND PHONE CONDUITS FOR DATA CABLING. PROVIDE INSULATED BUSHINGS, AND PROVIDE PULL STRING FROM END TO END.
- L. COORDINATE ALL CONCRETE TRENCHING/CORE DRILLING TO ENSURE THAT ANY UNDER SLAB UTILITIES, ETC., ARE NOT DAMAGED DURING FLOOR CUT AND OR CORE DRILLING. PRIOR APPROVAL AND COORDINATION WITH PROPERTY MANAGEMENT IS REQUIRED FOR ALL CONCRETE WORK. EC SHALL PROVIDE PATCHING/REPAIR TO CONCRETE AND VAPOR BARRIER AS REQUIRED.
1. RELOCATED SAFE: PROVIDE RECEPTACLE ON DEDICATED CIRCUIT. ADJACENT TO RECEPTACLE, PROVIDE J-BOX FOR SECURITY ALARM JACK AND ROUTE CONDUIT BACK TO SECURITY PANEL J-BOX. REFER TO MANAGER'S DESK DETAIL AND POS DETAIL ON E-501 FOR ADDITIONAL INFORMATION.
2. RELOCATED POS: PROVIDE RECEPTACLE ON DEDICATED CIRCUIT. ADJACENT TO RECEPTACLE, PROVIDE J-BOXES FOR TELEPHONE AND DATA. ROUTE CONDUIT(S) BACK TO MANAGER'S DESK. REFER TO MANAGER'S DESK DETAIL AND POS DETAIL ON E-501 FOR ADDITIONAL INFORMATION.
3. STUB UP POWER, DATA PHONE AND/OR SECURITY CONDUITS 6" AFF TO SERVE NEARBY DEVICES IN THIS LOCATION. ROUTE POWER CONDUCTORS IN FLEXIBLE METAL CONDUIT CONCEALED OR TIGHT-TO-WALL FROM RECEPTACLES TO NEARBY RIGID STUB UP AND BACK TO SERVING POWER PANEL. ROUTE DATA, PHONE AND SAFE CONDUITS UNDER FLOOR BACK TO DATA RACK NEAR MANAGER WORKSTATION. PROVIDE AN END-TO-END PULL STRING IN ALL DATA PHONE AND SAFE CONDUITS. LABEL EACH END OF PULL STRING WITH CONDUIT SYSTEM ("POS", "SECURITY", ETC.) AND DESTINATION ("DRIVE-THRU", "FRONT RACK", ETC.). PROVIDE INSULATED BUSHINGS ON ALL STUBBED-UP AND EXPOSED CONDUIT ENDS. REFER TO ARCHITECTURAL PENETRATION PLAN FOR ADDITIONAL INFORMATION.
4. RELOCATED CUP LABELER AND/OR MOBILE ORDER PRINTER: PROVIDE RECEPTACLE AND ADJACENT DATA BACKBOX AT SAME MOUNTING HEIGHT -COORDINATE LOCATION AND MOUNTING HEIGHT WITH OWNER'S REPRESENTATIVE PRIOR TO ROUGH IN. ROUTE 3/4" CONDUIT FROM BACKBOX TO DATA RACK NEAR MANAGER'S WORKSTATION.
5. RELOCATED DT POS AND EXPEDITER TILL MONITOR: PROVIDE DOUBLE DUPLEX RECEPTACLE ON DEDICATED CIRCUIT. ADJACENT TO RECEPTACLE, PROVIDE J-BOX FOR DATA. ROUTE CONDUIT BACK TO MANAGER'S DESK. REFER TO MANAGER'S DESK DETAIL AND DRIVE-THRU POS DETAIL ON E-501 FOR ADDITIONAL INFORMATION.
6. RELOCATED DT EXPEDITER MONITOR: PROVIDE DOUBLE DUPLEX RECEPTACLE. ADJACENT TO RECEPTACLE, PROVIDE J-BOX FOR DATA. ROUTE CONDUIT BACK TO MANAGER'S DESK. REFER TO MANAGER'S DESK DETAIL AND DRIVE-THRU POS DETAIL ON E-501 FOR ADDITIONAL INFORMATION.
7. RELOCATED DT TIMER CONTROL UNIT AND MONITOR: PROVIDE DOUBLE DUPLEX RECEPTACLE. ADJACENT TO RECEPTACLE, PROVIDE J-BOX FOR DATA. ROUTE CONDUIT BACK TO MANAGER'S DESK. REFER TO MANAGER'S DESK DETAIL AND DRIVE-THRU POS DETAIL ON E-501 FOR ADDITIONAL INFORMATION.
8. RELOCATED DT TIMER SIGNAL PROCESSOR: PROVIDE DUPLEX RECEPTACLE. ADJACENT TO RECEPTACLE, PROVIDE J-BOX FOR DATA. ROUTE CONDUIT BACK TO MANAGER'S DESK. REFER TO MANAGER'S DESK DETAIL AND DRIVE-THRU POS DETAIL ON E-501 FOR ADDITIONAL INFORMATION.
9. RELOCATED WIRELESS HEADSET BASE STATION: PROVIDE DUPLEX RECEPTACLE. ADJACENT TO RECEPTACLE, PROVIDE J-BOX FOR DATA. ROUTE CONDUIT BACK TO MANAGER'S DESK. REFER TO MANAGER'S DESK DETAIL AND DRIVE-THRU POS DETAIL ON E-501 FOR ADDITIONAL INFORMATION.

KEYED NOTES

1. RELOCATED SAFE: PROVIDE RECEPTACLE ON DEDICATED CIRCUIT. ADJACENT TO RECEPTACLE. PROVIDE J-BOX FOR SECURITY ALARM JACK AND ROUTE CONDUIT BACK TO MANAGER'S DESK. REFER TO MANAGER'S DESK DETAIL AND POS DETAIL ON E-501 FOR ADDITIONAL INFORMATION.
2. RELOCATED POS: PROVIDE RECEPTACLE ON DEDICATED CIRCUIT. ADJACENT TO RECEPTACLE. PROVIDE J-BOXES FOR TELEPHONE AND DATA. ROUTE CONDUIT(S) BACK TO MANAGER'S DESK. REFER TO MANAGER'S DESK DETAIL AND POS DETAIL ON E-501 FOR ADDITIONAL INFORMATION.
3. STUB UP POWER, DATA PHONE AND/OR SECURITY CONDUITS 6" AFF. TO SERVE NEARBY DEVICES IN THIS LOCATION. ROUTE POWER CONDUCTORS IN FLEXIBLE METAL CONDUIT CONCEALED OR TIGHT-TO-WALL FROM RECEPTABLES TO NEARBY RIGID STUB UP AND BACK TO SERVING POWER PANEL. ROUTE DATA, PHONE AND SAFE CONDUITS UNDER FLOOR BACK TO DATA RACK NEAR MANAGER WORKSTATION. PROVIDE AN END-TO-END PULL STRING IN ALL DATA PHONE AND SAFE CONDUITS. LABEL EACH END OF PULL STRING WITH CONDUIT SYSTEM ("POS," "SECURITY," ETC.) AND DESTINATION ("DRIVE-THRU," "FRONT BAR," ETC.). PROVIDE INSULATED BUSHINGS ON ALL STUBBED-UP AND EXPOSED CONDUIT ENDS. REFER TO ARCHITECTURAL PENETRATION PLAN FOR ADDITIONAL INFORMATION.
4. RELOCATED CUP LABELER AND/OR MOBILE ORDER PRINTER: PROVIDE RECEPTACLE AND ADJACENT DATA BOX AX AT SAME MOUNTING HEIGHT. COORDINATE LOCATION AND MOUNTING HEIGHT WITH OWNER'S REPRESENTATIVE PRIOR TO ROUGH IN. ROUTE 3/4" CONDUIT FROM BACKBOX TO DATA RACK NEAR MANAGER'S WORKSTATION.
5. RELOCATED DT POS AND EXPEDITER TILL MONITOR: PROVIDE DOUBLE DUPLEX RECEPTACLE ON DEDICATED CIRCUIT. ADJACENT TO RECEPTACLE, PROVIDE J-BOX FOR DATA. ROUTE CONDUIT BACK TO MANAGER'S DESK. REFER TO MANAGER'S DESK DETAIL AND DRIVE-THRU POS DETAIL ON E-501 FOR ADDITIONAL INFORMATION.
6. RELOCATED DT EXPEDITER MONITOR: PROVIDE DOUBLE DUPLEX RECEPTACLE. ADJACENT TO RECEPTACLE, PROVIDE J-BOX FOR DATA. ROUTE CONDUIT BACK TO MANAGER'S DESK. REFER TO MANAGER'S DESK DETAIL AND DRIVE-THRU POS DETAIL ON E-501 FOR ADDITIONAL INFORMATION.
7. RELOCATED DT TIMER CONTROL UNIT AND MONITOR: PROVIDE DOUBLE DUPLEX RECEPTACLE. ADJACENT TO RECEPTACLE, PROVIDE J-BOX FOR DATA. ROUTE CONDUIT BACK TO MANAGER'S DESK. REFER TO MANAGER'S DESK DETAIL AND DRIVE-THRU POS DETAIL ON E-501 FOR ADDITIONAL INFORMATION.
8. RELOCATED DT TIMER SIGNAL PROCESSOR: PROVIDE DOUBLE DUPLEX RECEPTACLE. ADJACENT TO RECEPTACLE, PROVIDE J-BOX FOR DATA. ROUTE CONDUIT BACK TO MANAGER'S DESK. REFER TO MANAGER'S DESK DETAIL AND DRIVE-THRU POS DETAIL ON E-501 FOR ADDITIONAL INFORMATION.
9. RELOCATED WIRELESS HEADSET BASE STATION: PROVIDE DUPLEX RECEPTACLE. ADJACENT TO RECEPTACLE, PROVIDE J-BOX FOR DATA. ROUTE CONDUIT BACK TO MANAGER'S DESK. REFER TO MANAGER'S DESK DETAIL AND DRIVE-THRU POS DETAIL ON E-501 FOR ADDITIONAL INFORMATION.

KEYED NOTES CONTINUED

- TELEPHONE AND DATA OUTLETS FOR MANAGER'S DESK: REFER TO MANAGER'S DESK DETAIL ON E-501 FOR ADDITIONAL INFORMATION.
11. CARBON MONOXIDE DETECTOR AND THERMOSTATS FOR REPTILE HVAC: COORDINATE DETECTOR STATION AND CONNECTION WITH MECHANICAL CONTRACTOR. COORDINATE LOCATION(S) WITH OWNER'S REPRESENTATIVE. VERIFY LOCATIONS/ CONNECTIONS PRIOR TO INSTALLATION.
12. DATA OUTLET FOR FUTURE USE: PROVIDE BACKBOX MOUNTED 6" AFF ROUTE 3/4" CONDUIT FROM BACKBOX TO DATA RACK NEAR MANAGER'S WORK STATION. LABEL CONDUIT FOR DATA CABLEING AND PROVIDE PULL STRING FROM END TO END.
13. PROVIDE RECEPTACLE AND DATA OUTLET CENTERED HORIZONTALLY BEHIND MENU BOARD FOR FUTURE DIGITAL MENU BOARD. PROVIDE BACKBOX FOR DATA OUTLET. ROUTE 3/4" CONDUIT FROM BACKBOX TO DATA RACK NEAR MANAGER'S WORK STATION. LABEL CONDUIT FOR DATA CABLEING AND PROVIDE PULL STRING FROM END TO END. SEE INTERIOR ELEVATIONS FOR MENU BOARD LOCATIONS.
14. RELOCATED SECURITY CAMERA: CEILING MOUNT TYPICAL IN OPEN CEILING CONDITION, LOCATE B.O. CAMERA AT SAME HEIGHT AS STORE LIGHTING.
15. RECESSED SPEAKER COLOR: WHITE
16. AMPLIFIER: LOCATE ON SHELVING ABOVE MANAGER'S WORKSTATION (SEE DETAIL ON E-501).
17. CONDUIT PATHWAY ABOVE CEILING FOR FUTURE ANTENNA COAXIAL CABLE. MINIMUM 1-1/4" CONDUIT WITH THICK END-TO-END PULL STRING. MINIMUM 8-1/2" RADIUS BENDS. MAXIMUM 100'-0" RUN. NO CONSECUTIVE 90-DEGREE BENDS. TERMINATE AT J-BOX WITH COVER PLATE AT CEILING/WALL WITHIN 4'-0" OF BUMP BASE STATION AND ABOVE BOH CEILING ADJACENT FUTURE PENETRATION ZONE.
18. REFER TO DETAIL 3 ON SHEET E503 FOR ADDITIONAL INFORMATION.
19. REFER TO DETAIL 4 ON SHEET E503 FOR ADDITIONAL INFORMATION.
20. REFER TO DETAIL 5 ON SHEET E503 FOR ADDITIONAL INFORMATION.
21. SECURITY CAMERA: CEILING MOUNT TYPICAL; IN OPEN CEILING CONDITION, LOCATE B.O. CAMERA AT SAME HEIGHT AS STORE LIGHTING.
22. RELOCATED DRIVE THRU CAMERA: LOCATE 6'-0" TO 8'-0" [1825-2440MM] FROM WINDOW WITH CLEAR VIEW OF CUSTOMER AND DT POS.



© 2019 STARBUCKS COFFEE COMPANY

STARBUCKS®
2401 UTAH AVENUE SOUTH
SEATTLE, WASHINGTON 98134
(206) 318-1575


THESE DRAWINGS AND THE PROJECT MANUAL ARE CONFIDENTIAL, AND SHALL REMAIN THE SOLE PROPERTY OF STARBUCKS CORPORATION, WHICH IS THE OWNER OF THE COPYRIGHT IN THIS WORK. THEY SHALL NOT BE REPRODUCED (IN WHOLE OR IN PART), SHARED WITH THIRD PARTIES OR USED IN ANY MANNER ON OTHER PROJECTS OR EXTENSIONS TO THIS PROJECT WITHOUT THE PRIOR WRITTEN CONSENT OF STARBUCKS CORPORATION. THESE DRAWINGS AND THE PROJECT MANUAL ARE FOR EXCLUSIVE DESIGN INTENT FOR A PROTOTYPICAL STARBUCKS STORE (WHICH IS SUBJECT TO CHANGE AT ANYTIME) AND DO NOT REFLECT ACTUAL SITE CONDITIONS. NEITHER PARTY SHALL HAVE ANY OBLIGATION OR LIABILITY TO THE OTHER (EXCEPT STATED ABOVE) UNTIL A WRITTEN AGREEMENT IS FULLY EXECUTED BY BOTH PARTIES.

STARBUCKS TEMPLATE VERSION: i2023-05-01

**Design Forum
Architects Inc.**

2056 Byers Rd
Miamisburg, OH 45342
Tel: (844) 804-7700

Donald J. Rethman
Architect In Charge

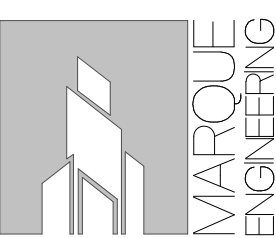

4850 SMITH RD., STE. 101
CINCINNATI, OH 45212
513.901.0040
WWW.MARQUEENG.COM

FOR CONSTRUCTION

PROJECT NAME:
S SEMORAN BLVD &
LEE VISTA BLVD

PROJECT NAME:

PROJECT ADDRESS:
6605 S SEMORAN BLVD,

PROJECT ADDRESS:


STORE #: 9875
PROJECT #: 25630-101
ISSUE DATE: 03/04/2024
DESIGN MANAGER: MARTIN PER
PRODUCTION DESIGNER: ANDY MCLOU
CHECKED BY: EVAN DUFFY

Revision Schedule			
Rev	Date	By	Description



SHEET TITLE:
LOW VOLTAGE DESIGN
PLAN

SCALE: 1/4" = 1'-0'


E103

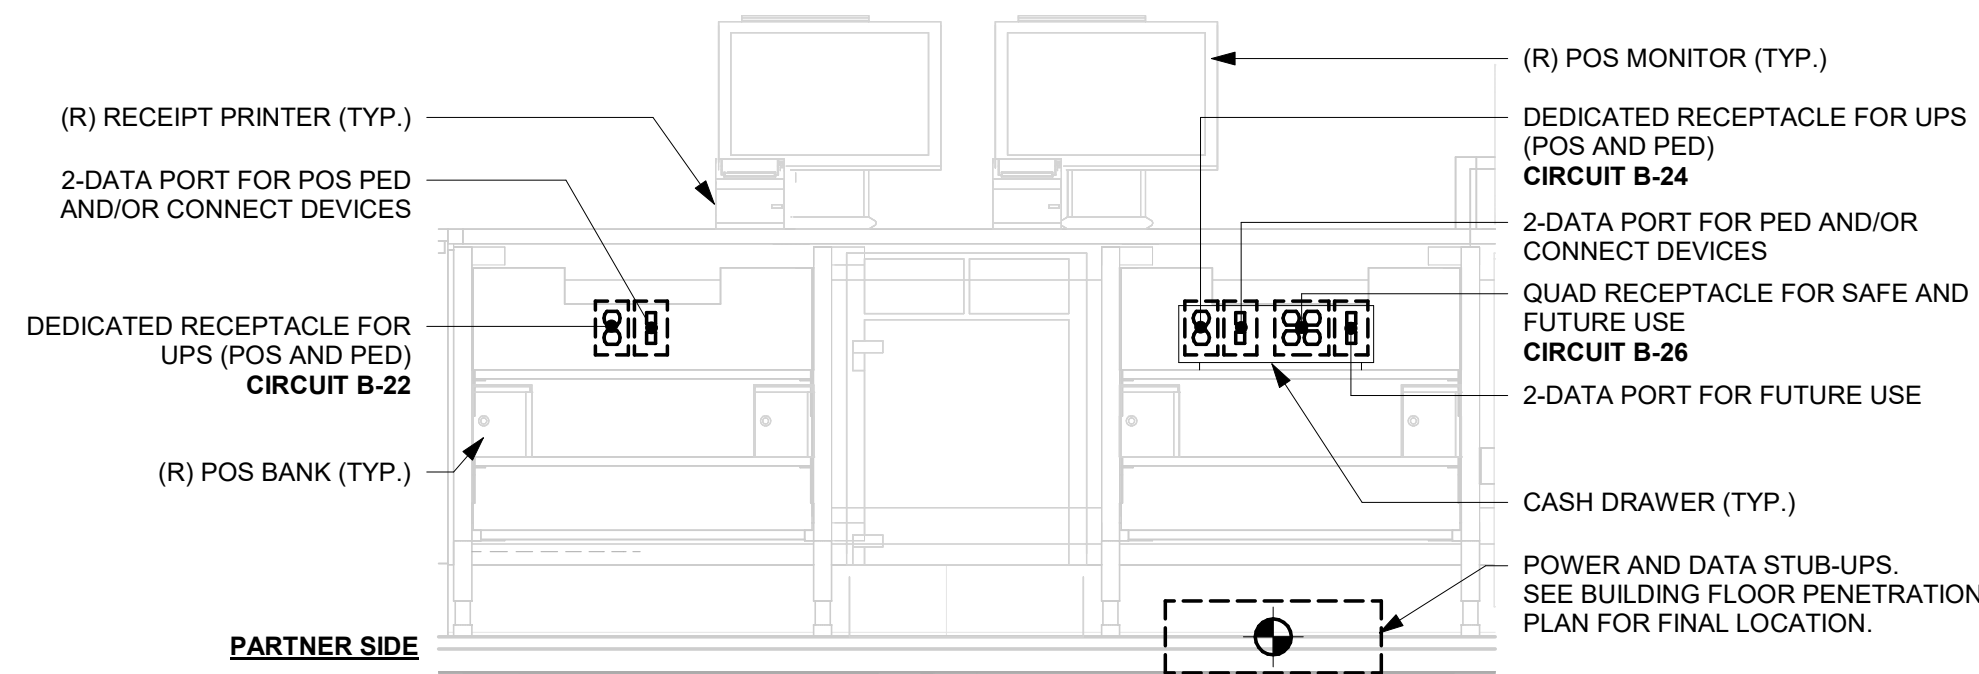


1 DOUBLE POS DETAIL
Scale: 3/4" = 1'-0"

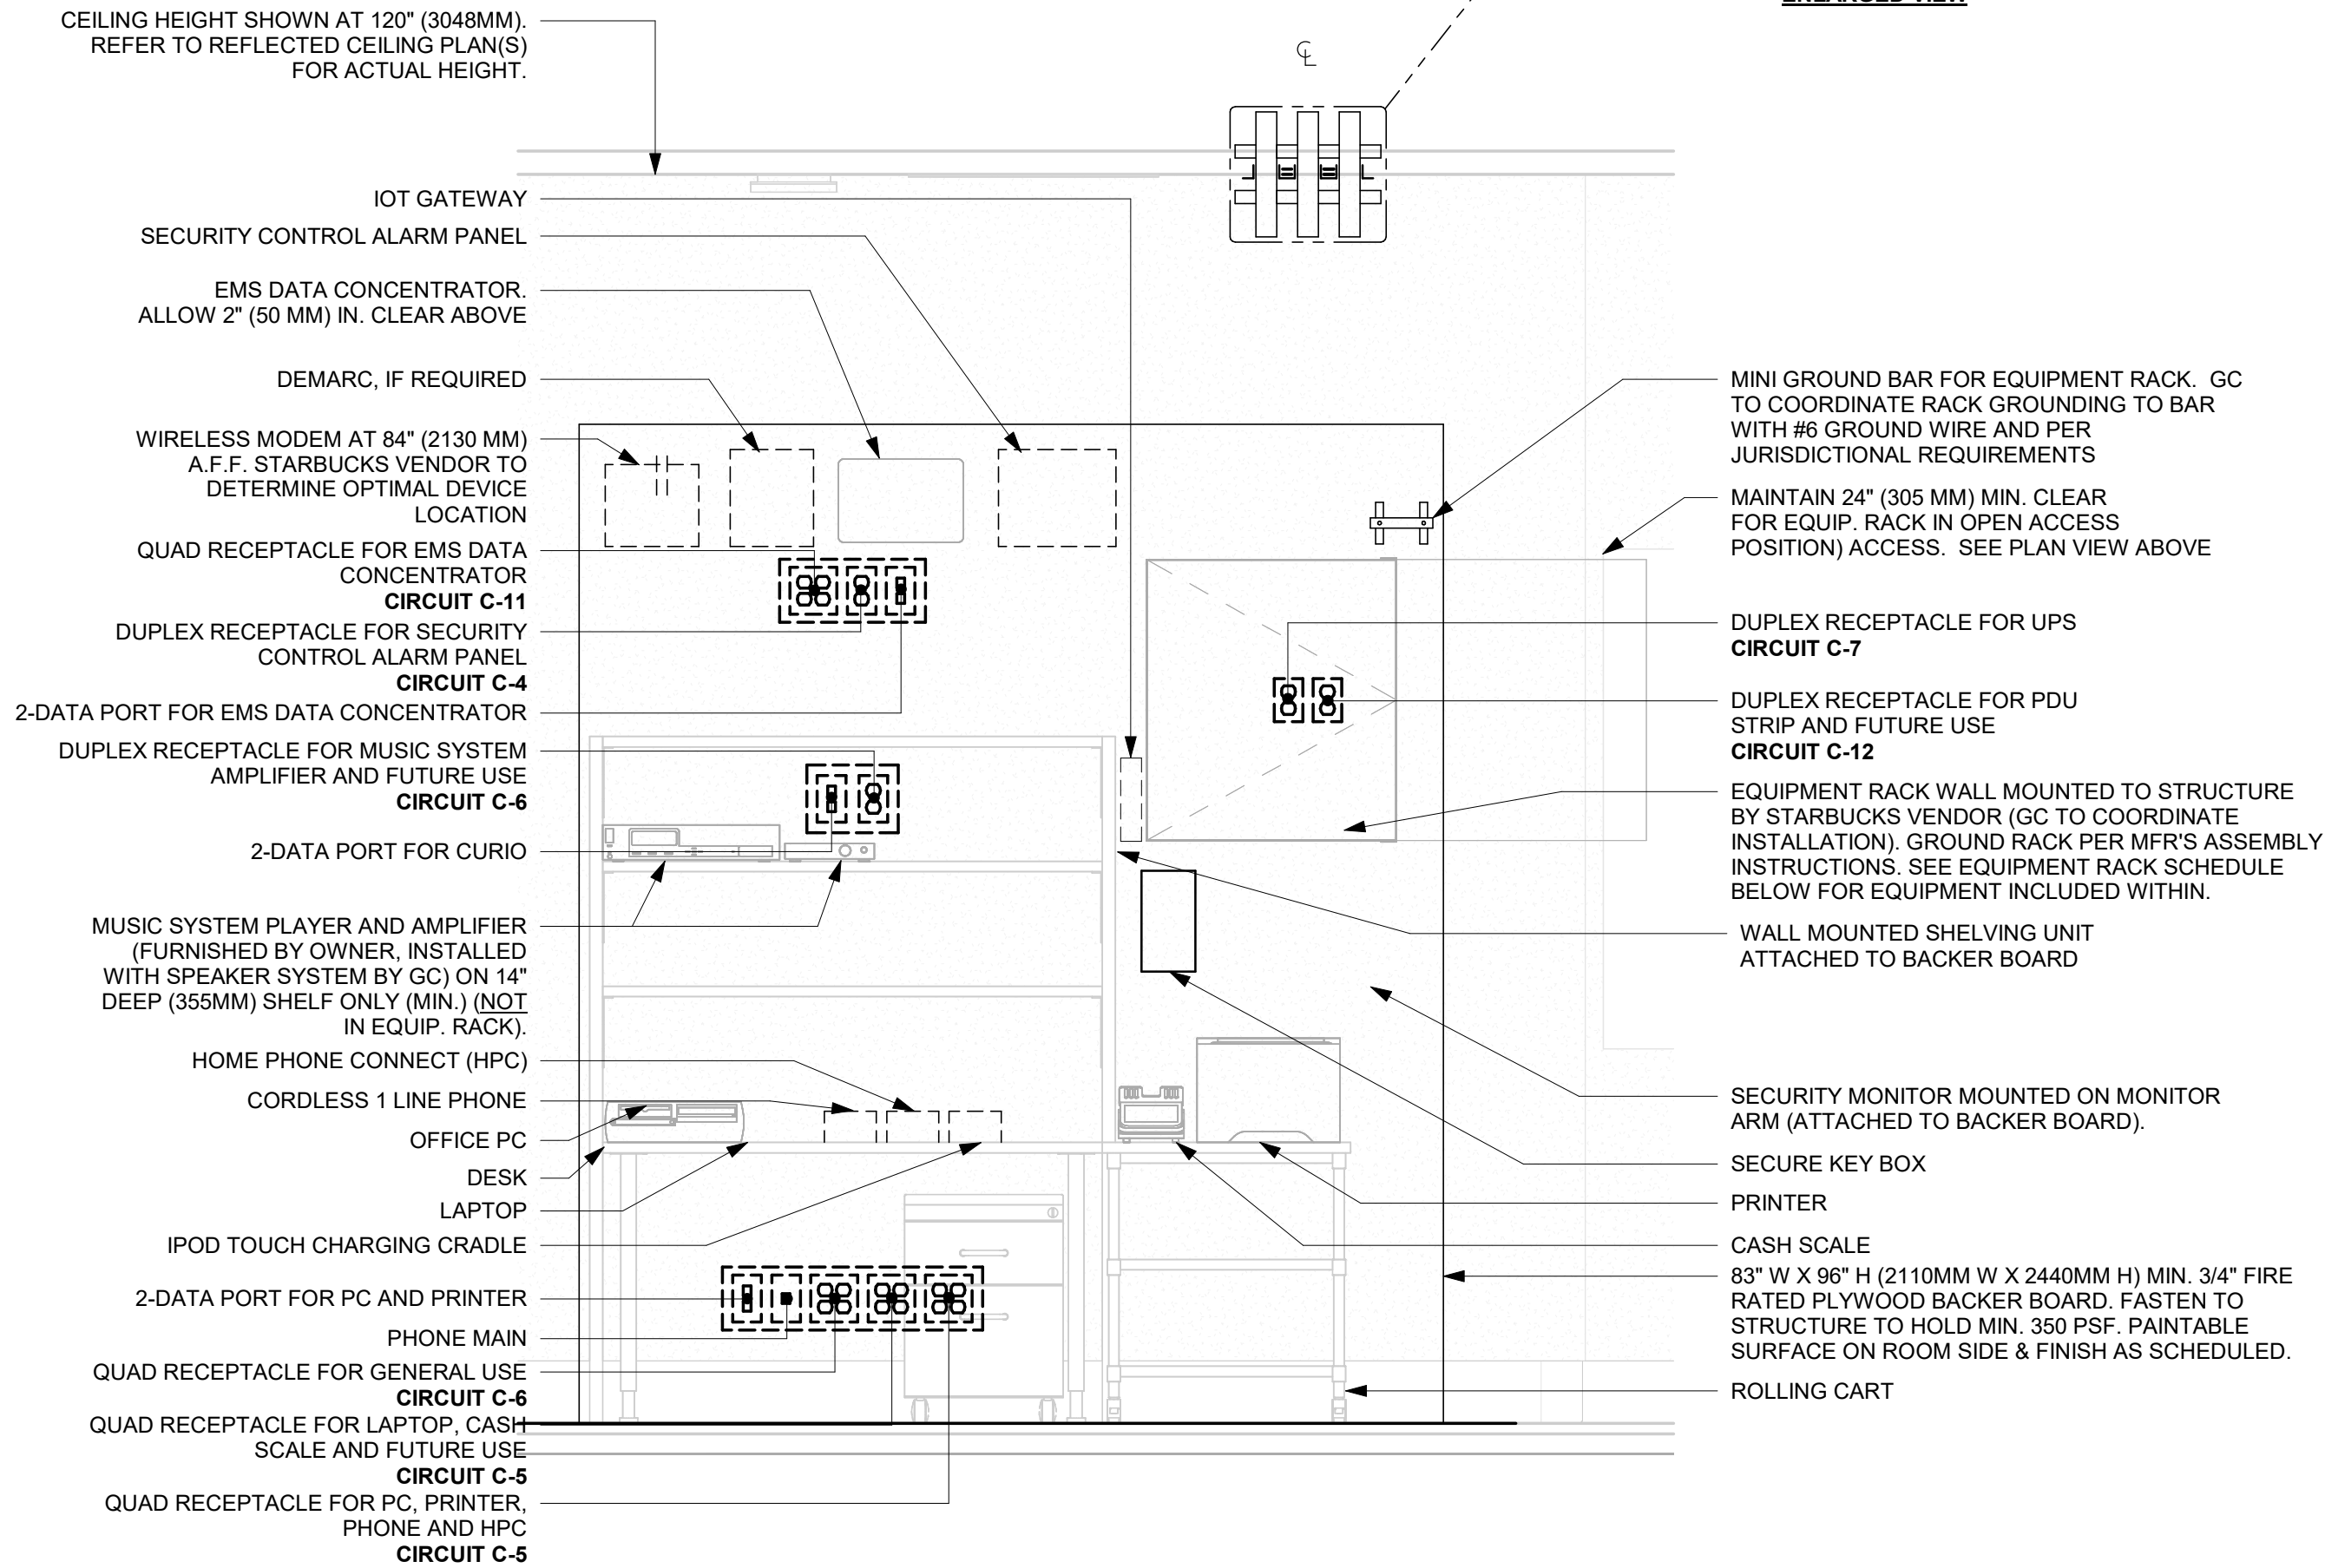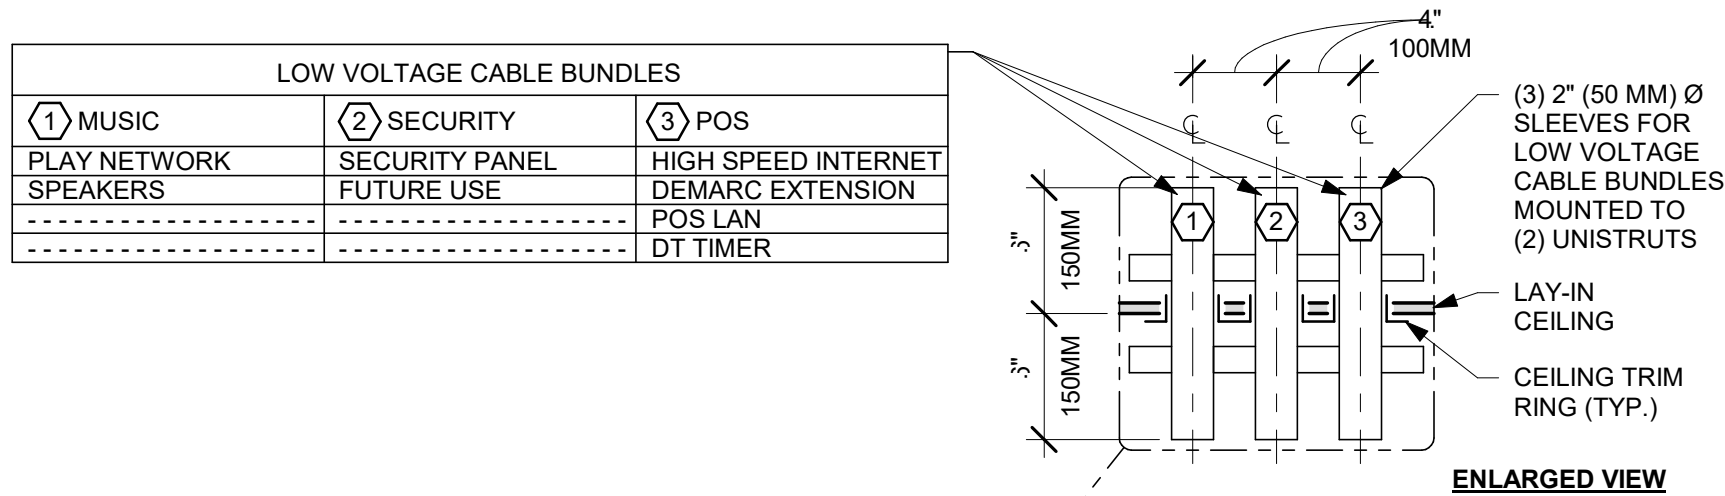

3 MANAGERS DESK DETAIL
Scale: 3/4" = 1'-0"

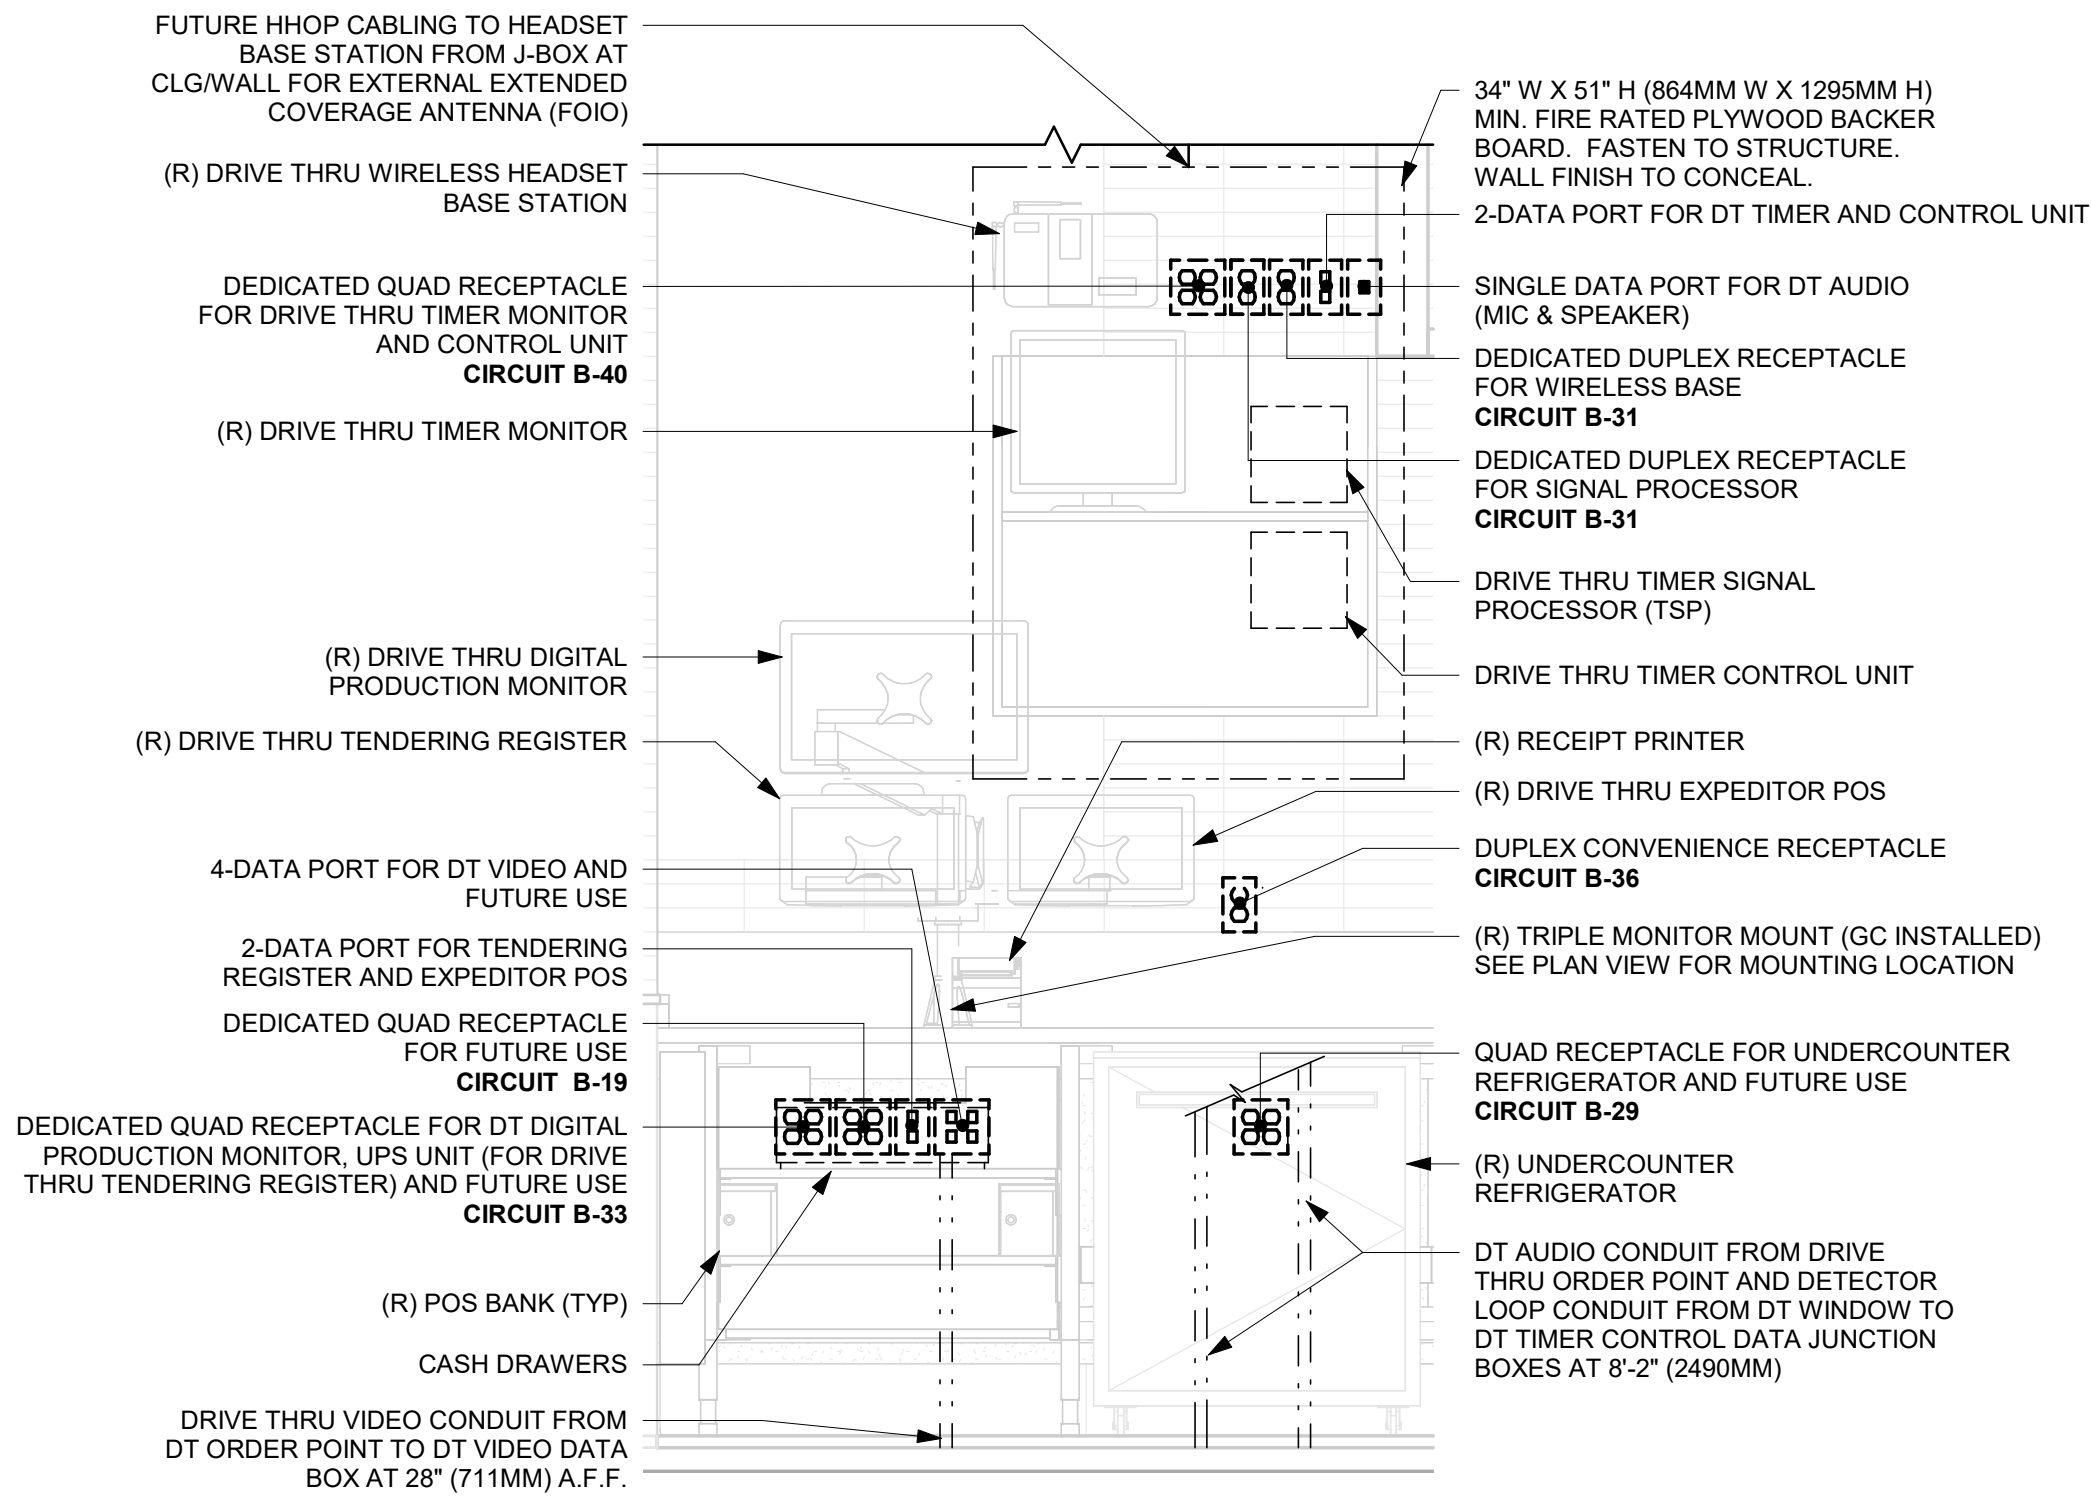

2 DRIVE THRU POS DETAIL
Scale: 3/4" = 1'-0"

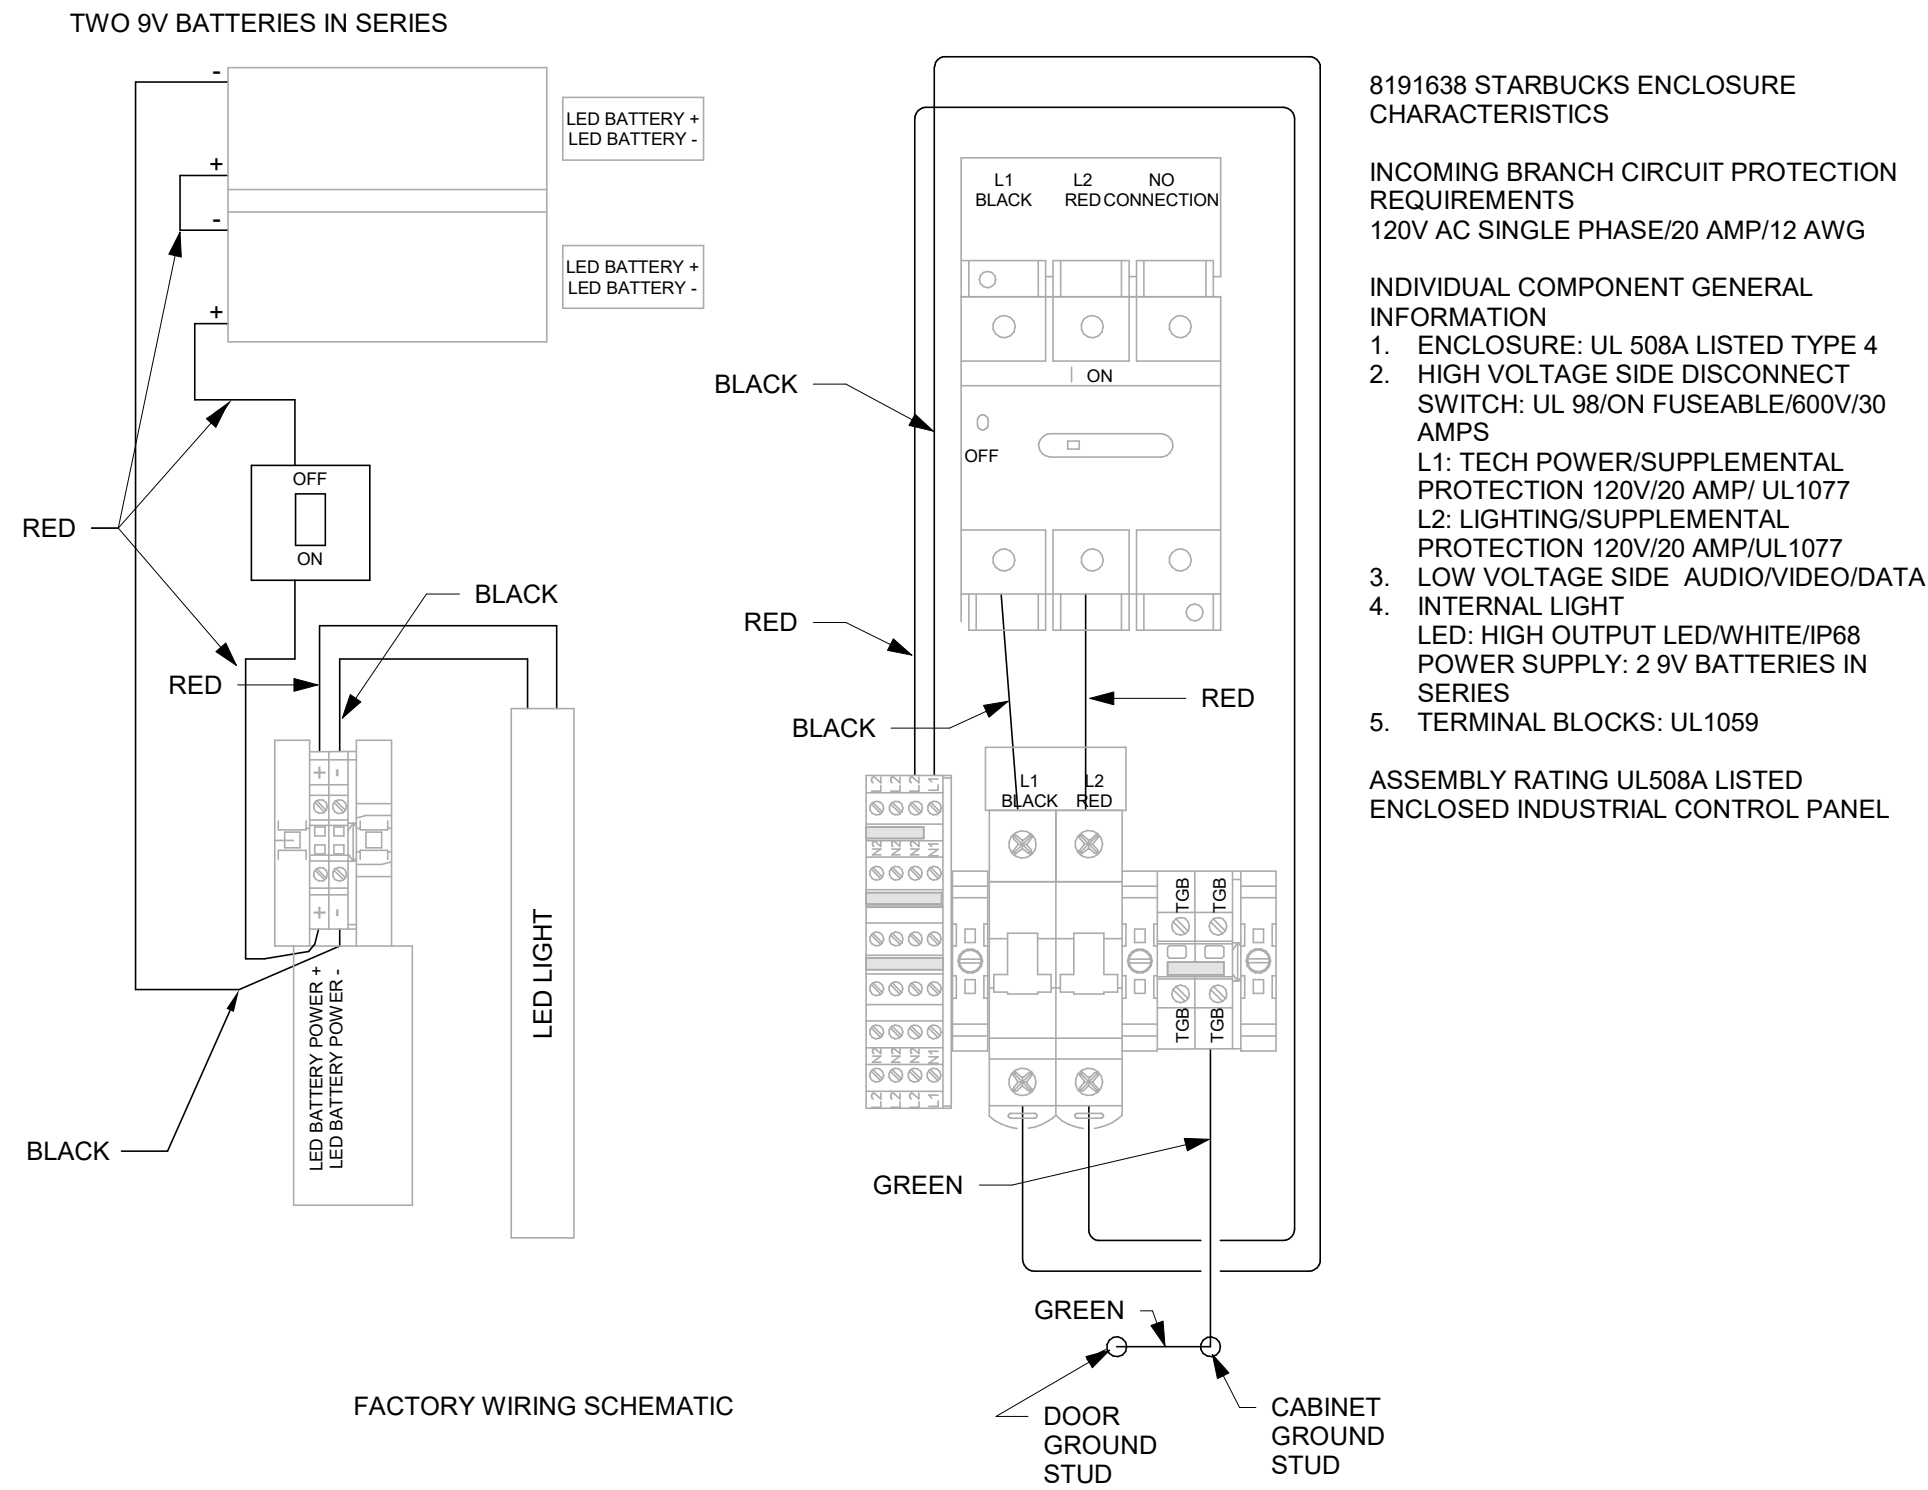

4 DRIVE-THRU DCB SCHEMATIC
Scale: 1/4" = 1'-0"



© 2019 STARBUCKS COFFEE COMPANY

STARBUCKS®
2401 UTAH AVENUE SOUTH
SEATTLE, WASHINGTON 98134
(206) 318-1575


THESE DRAWINGS AND THE PROJECT MANUAL ARE CONFIDENTIAL AND SHALL REMAIN THE SOLE PROPERTY OF STARBUCKS CORPORATION, WHICH IS THE OWNER OF THE COPYRIGHT IN THIS WORK. THEY SHALL NOT BE REPRODUCED IN WHOLE OR IN PART, SHARED WITH THIRD PARTIES OR USED IN ANY MANNER ON OTHER PROJECTS OR EXTENSIONS TO THIS PROJECT WITHOUT THE PRIOR WRITTEN CONSENT OF STARBUCKS CORPORATION. THESE DRAWINGS AND SPECIFICATIONS ARE INTENDED TO EXPRESS DESIGN INTENT FOR A PROTOTYPICAL STARBUCKS STORE (WHICH IS SUBJECT TO CHANGE AT ANYTIME) AND DO NOT REFLECT ACTUAL SITE CONDITIONS. NEITHER PARTY SHALL HAVE ANY OBLIGATION NOR LIABILITY TO THE OTHER (EXCEPT STATED ABOVE) UNTIL A WRITTEN AGREEMENT IS FULLY EXECUTED BY BOTH PARTIES.

STARBUCKS TEMPLATE VERSION: i2023-05-01

Design Forum Architects Inc.

2956 Byers Rd
Miamisburg, OH 45342
Tel: (644) 804-7700

Donald J. Bethman
Architect in Charge

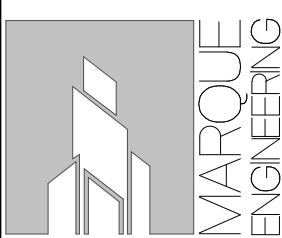

4850 SMITH RD., STE. 101
CINCINNATI, OH 45212
513.901.0040
WWW.MARQUEENG.COM

FOR CONSTRUCTION

PROJECT NAME:
S SEMORAN BLVD & LEE VISTA BLVD

PROJECT ADDRESS:
**6605 S SEMORAN BLVD,
ORLANDO, FL 32822**

STORE #: 9875
PROJECT #: 25630-101
ISSUE DATE: 03/04/2024
DESIGN MANAGER: MARTIN PEREZ
PRODUCTION DESIGNER: ANDY MCLOUD
CHECKED BY: EVAN DUFFY


Revision Schedule			
Rev	Date	By	Description

SHEET TITLE:
ELECTRICAL DETAILS


SCALE: As indicated

SHEET NUMBER:

E501

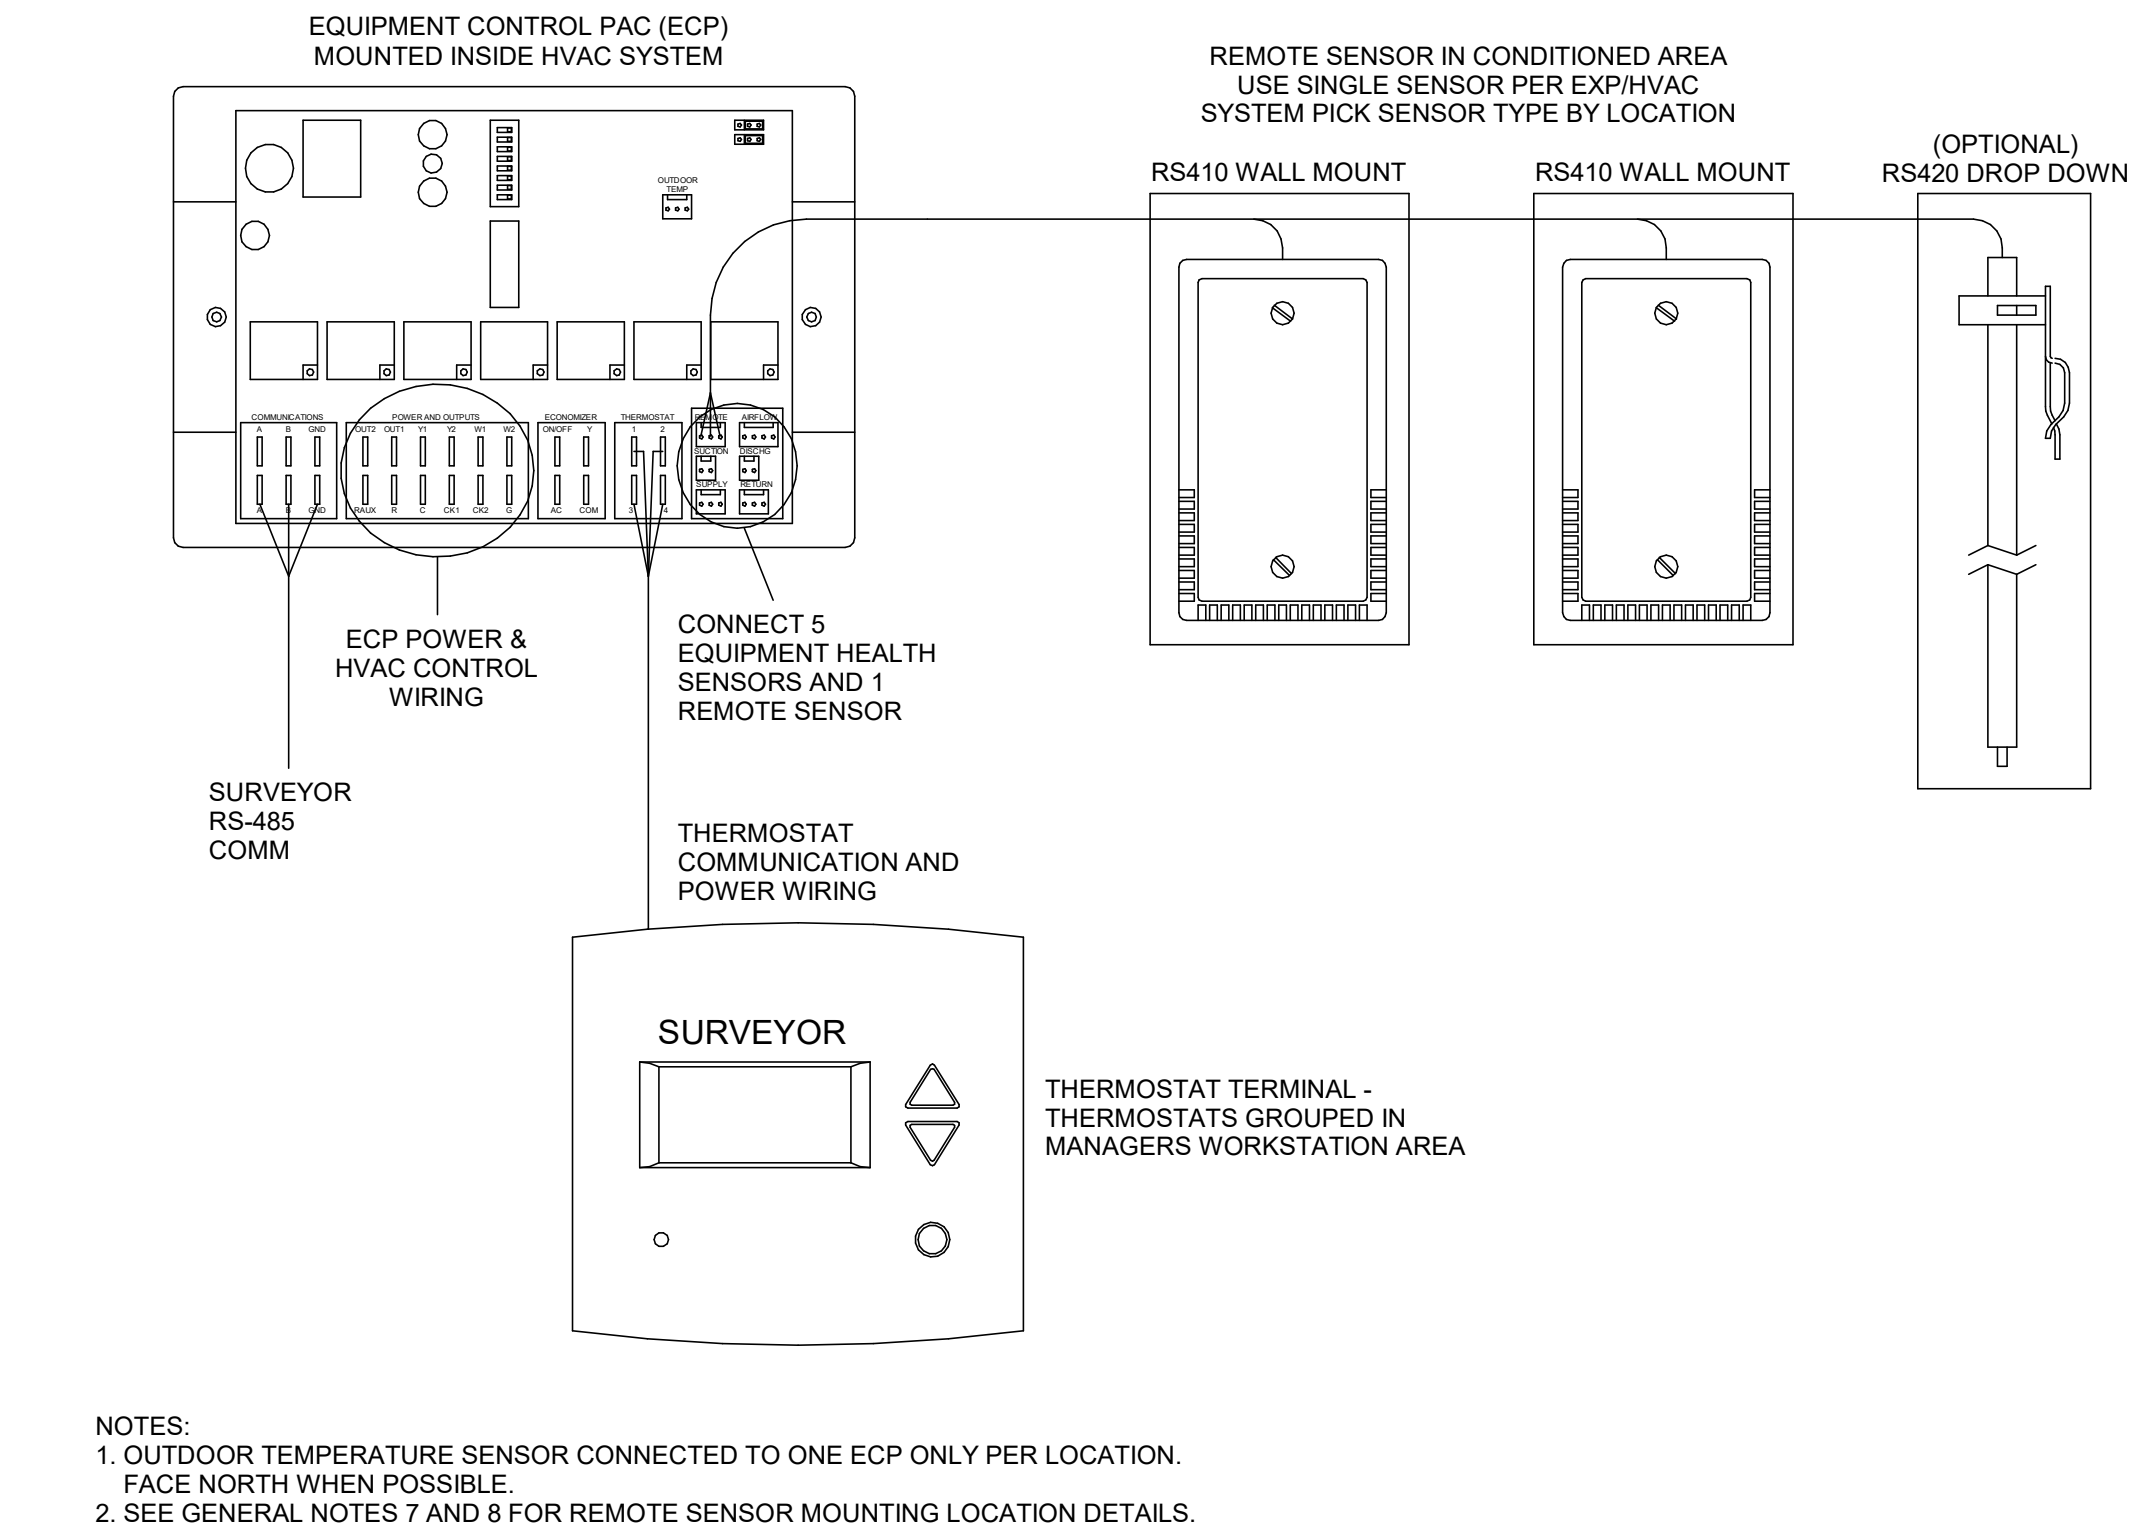


1 Venstar EMS - No Lighting Control - HVAC Controls
Scale: 6" = 1'-0"

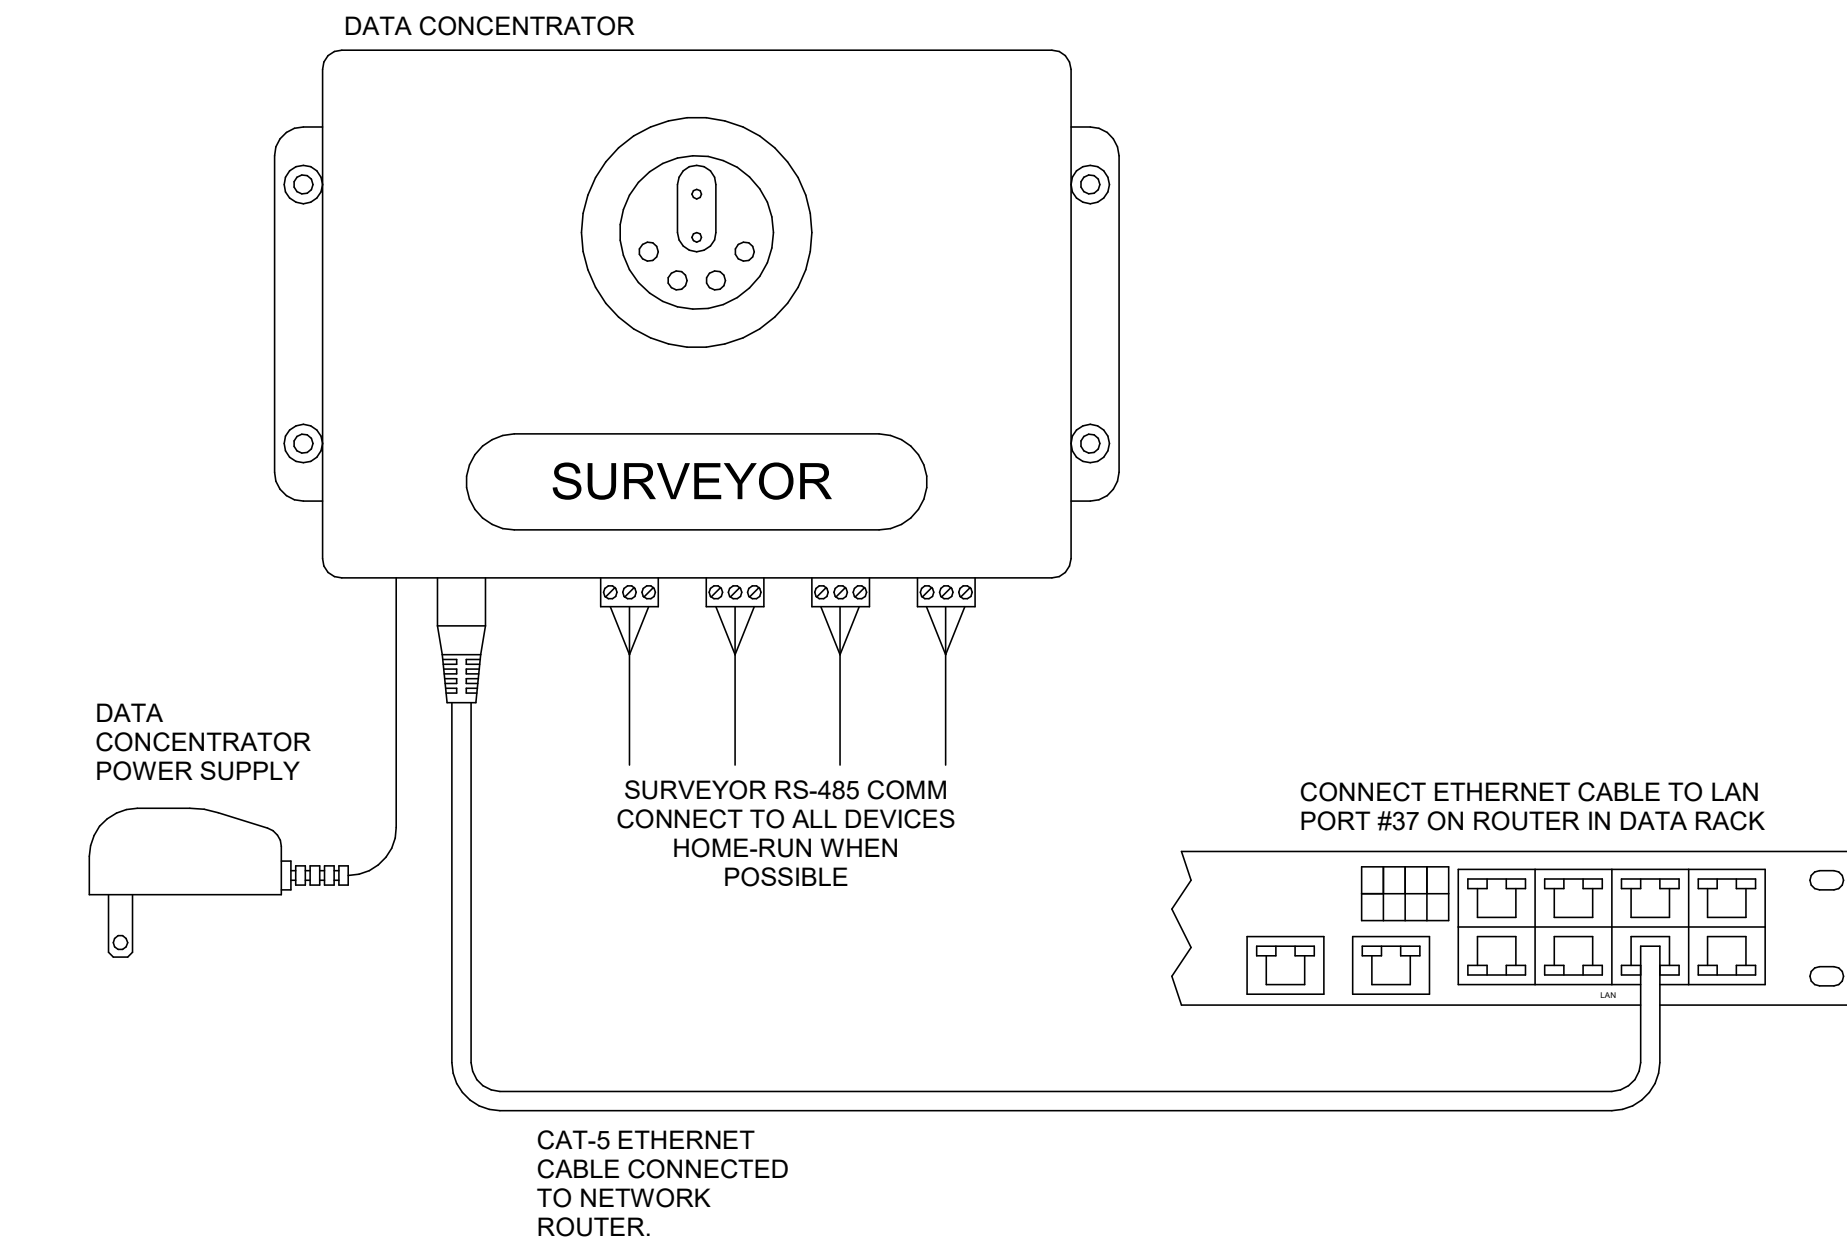

2 Venstar EMS - No Lighting Control - Data Concentrator
Scale: 6" = 1'-0"

- ### VENSTAR GENERAL NOTES
1. SURVEYOR ENERGY MANAGEMENT SYSTEM HARDWARE IS SUPPLIED BY STARBUCKS.
 2. DRAWING FOR GENERAL INFORMATION, DESIGN INTENT, AND COORDINATION ONLY.
 3. LOCAL BUILDING CODES TAKE PRECEDENCE OVER THIS DOCUMENT.
 4. NOT ALL WIRING IS SHOWN ON THIS DRAWING. FOR CLARITY, ONLY ONE EXAMPLE OF EACH TYPE OF DEVICE IS SHOWN.
 5. REFER TO THE SURVEYOR INSTALLATION INSTRUCTIONS FOR EACH COMPONENT FOR DETAILED WIRING AND ADDITIONAL CRITICAL INFORMATION.
 6. CAUTION! INSTALLATION REQUIRES THE REMOVAL OF SAFETY COVERS AND EXPOSE THE INSTALLER TO HIGH VOLTAGE AND ELECTRICAL HAZARDS. USE OF A LICENSED ELECTRICIAN IS REQUIRED. FOLLOW ALL APPROPRIATE SAFETY PRECAUTIONS. ADDITIONAL SAFETY INFORMATION IS IN THE SURVEYOR INSTALLATION MANUALS.
 7. WALL MOUNTED REMOTE SENSOR IS MOUNTED ON WALL 4 TO 5 FT AFF. AVOID AREAS WITH DIRECT AIRFLOW FROM SUPPLY REGISTERS.
 8. USE A DROP DOWN SENSOR IF A WALL MOUNT SENSOR CANNOT BE INSTALLED DUE TO SPACE CONSTRAINTS (SEE NOTE 7 FOR REQUIREMENTS). THE SENSOR CLIPS TO THE T-BAR GRID AND ADJUSTED SO THE BOTTOM OF THE SENSOR IS 8 TO 9 FT AFF. ALLOW 2 FT OF CLEARANCE FROM METRO SHELVEING AND AVOID AREAS WITH DIRECT AIRFLOW FROM SUPPLY REGISTERS.
 9. FOR SURVEYOR EMS TECHNICAL SUPPORT AND SYSTEM COMMISSIONING, CONTACT SURVEYOR TECHNICAL SUPPORT, (855) 647-7860, OPTION 1 OR EMAIL INSTALLSUPPORT@VENSTAR.COM. HOURS 6:00 AM TO 8:00 PM PACIFIC, MON-FRI.

SURVEYOR EMS COMPONENTS			
VENSTAR PART	SBUX ITEM #	DESCRIPTION	QUANTITY
DC400	011029485	DATA CONCENTRATOR	1
OTS400	011029487	OUTDOOR TEMPERATURE SENSOR	1
ECP400	011029489	EQUIPMENT CONTROL PAC	1 PER HVAC
CT414	011029490	COMMUNICATING THERMOSTAT	1 PER HVAC
SP400	011029491	SENSOR PAC	1 PER HVAC
RS410	011029492	WALL MOUNT REMOTE SENSOR	1 PER FOH HVAC
RS240	011050767	NARROW DROP DOWN SENSOR	1 PER BOH HVAC

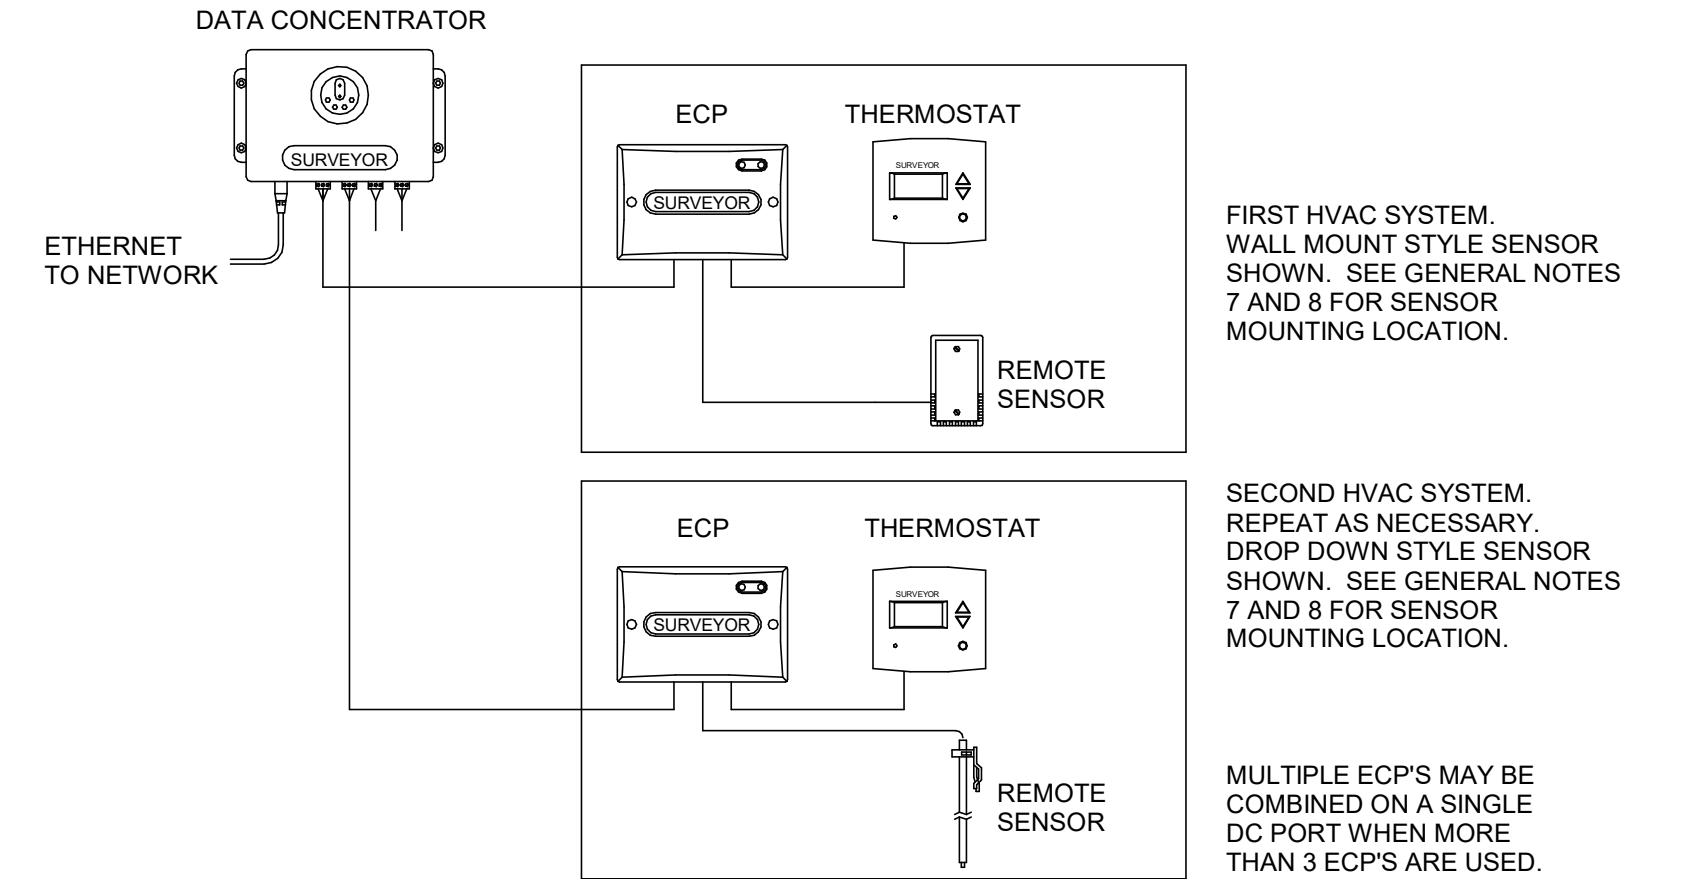

3 Venstar EMS - No Lighting Control - Basic Low Voltage Wire Runs
Scale: 6" = 1'-0"



STARBUCKS®
2401 UTAH AVENUE SOUTH
SEATTLE, WASHINGTON 98134
(206) 318-1575


THESE DRAWINGS AND THE PROJECT MANUAL ARE CONFIDENTIAL AND SHALL REMAIN THE SOLE PROPERTY OF STARBUCKS CORPORATION, WHICH IS THE OWNER OF THE COPYRIGHT IN THIS WORK. THEY SHALL NOT BE REPRODUCED IN WHOLE OR IN PART, SHARED WITH THIRD PARTIES OR USED IN ANY MANNER ON OTHER PROJECTS OR EXTENSIONS TO THIS PROJECT WITHOUT THE PRIOR WRITTEN CONSENT OF STARBUCKS CORPORATION. THESE DRAWINGS AND SPECIFICATIONS ARE INTENDED TO EXPRESS DESIGN INTENT FOR A PROTOTYPICAL STARBUCKS STORE (WHICH IS SUBJECT TO CHANGE AT ANYTIME) AND DO NOT REFLECT ACTUAL SITE CONDITIONS. NEITHER PARTY SHALL HAVE ANY OBLIGATION NOR LIABILITY TO THE OTHER (EXCEPT STATED ABOVE) UNTIL A WRITTEN AGREEMENT IS FULLY EXECUTED BY BOTH PARTIES.

STARBUCKS TEMPLATE VERSION: i2023-05-01

Design Forum Architects Inc.

2956 Byers Rd
Miamisburg, OH 45342
Tel: (844) 804-7700

Donald J. Bethman
Architect in Charge

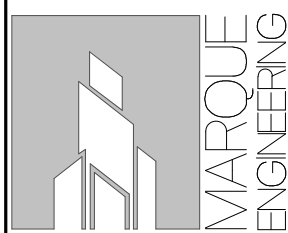

4850 SMITH RD., STE. 101
CINCINNATI, OH 45212
513.901.0040
WWW.MARQUEENG.COM

FOR CONSTRUCTION

PROJECT NAME:
S SEMORAN BLVD & LEE VISTA BLVD

PROJECT ADDRESS:
**6605 S SEMORAN BLVD,
ORLANDO, FL 32822**

STORE #: 9875
PROJECT #: 25630-101
ISSUE DATE: 03/04/2024
DESIGN MANAGER: MARTIN PEREZ
PRODUCTION DESIGNER: ANDY MCLOUD
CHECKED BY: EVAN DUFFY


Revision Schedule			
Rev	Date	By	Description

SHEET TITLE:
ELECTRICAL DETAILS


SCALE: As indicated

SHEET NUMBER:

E502

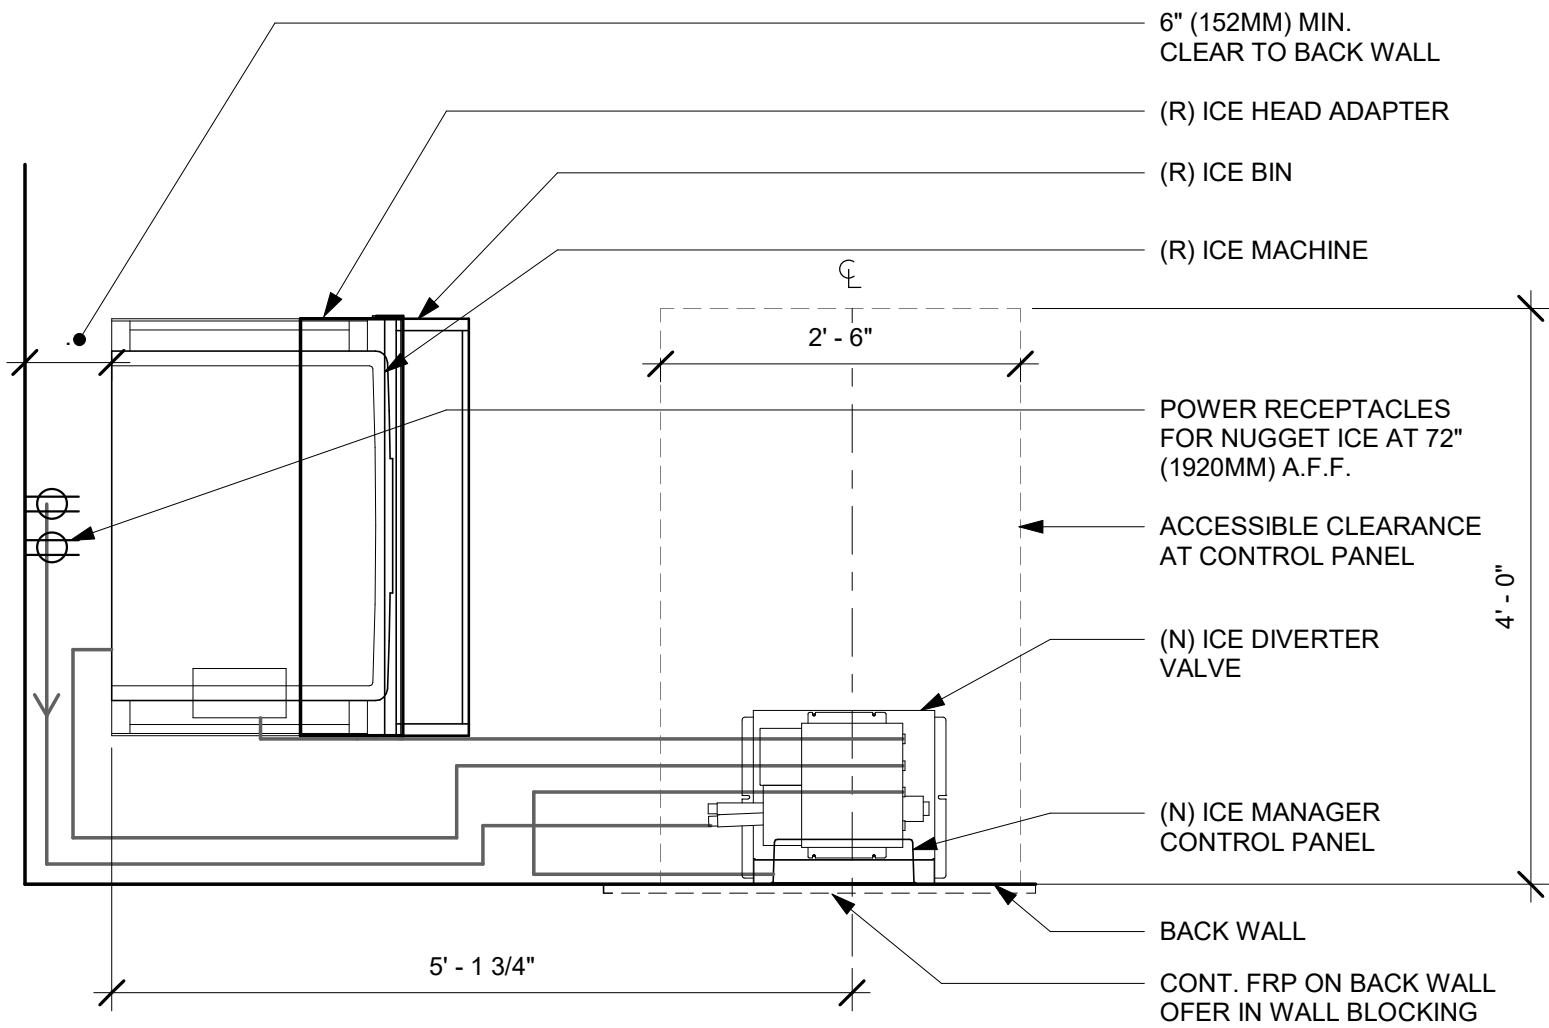


PLAN - ELECTRICAL DIAGRAM

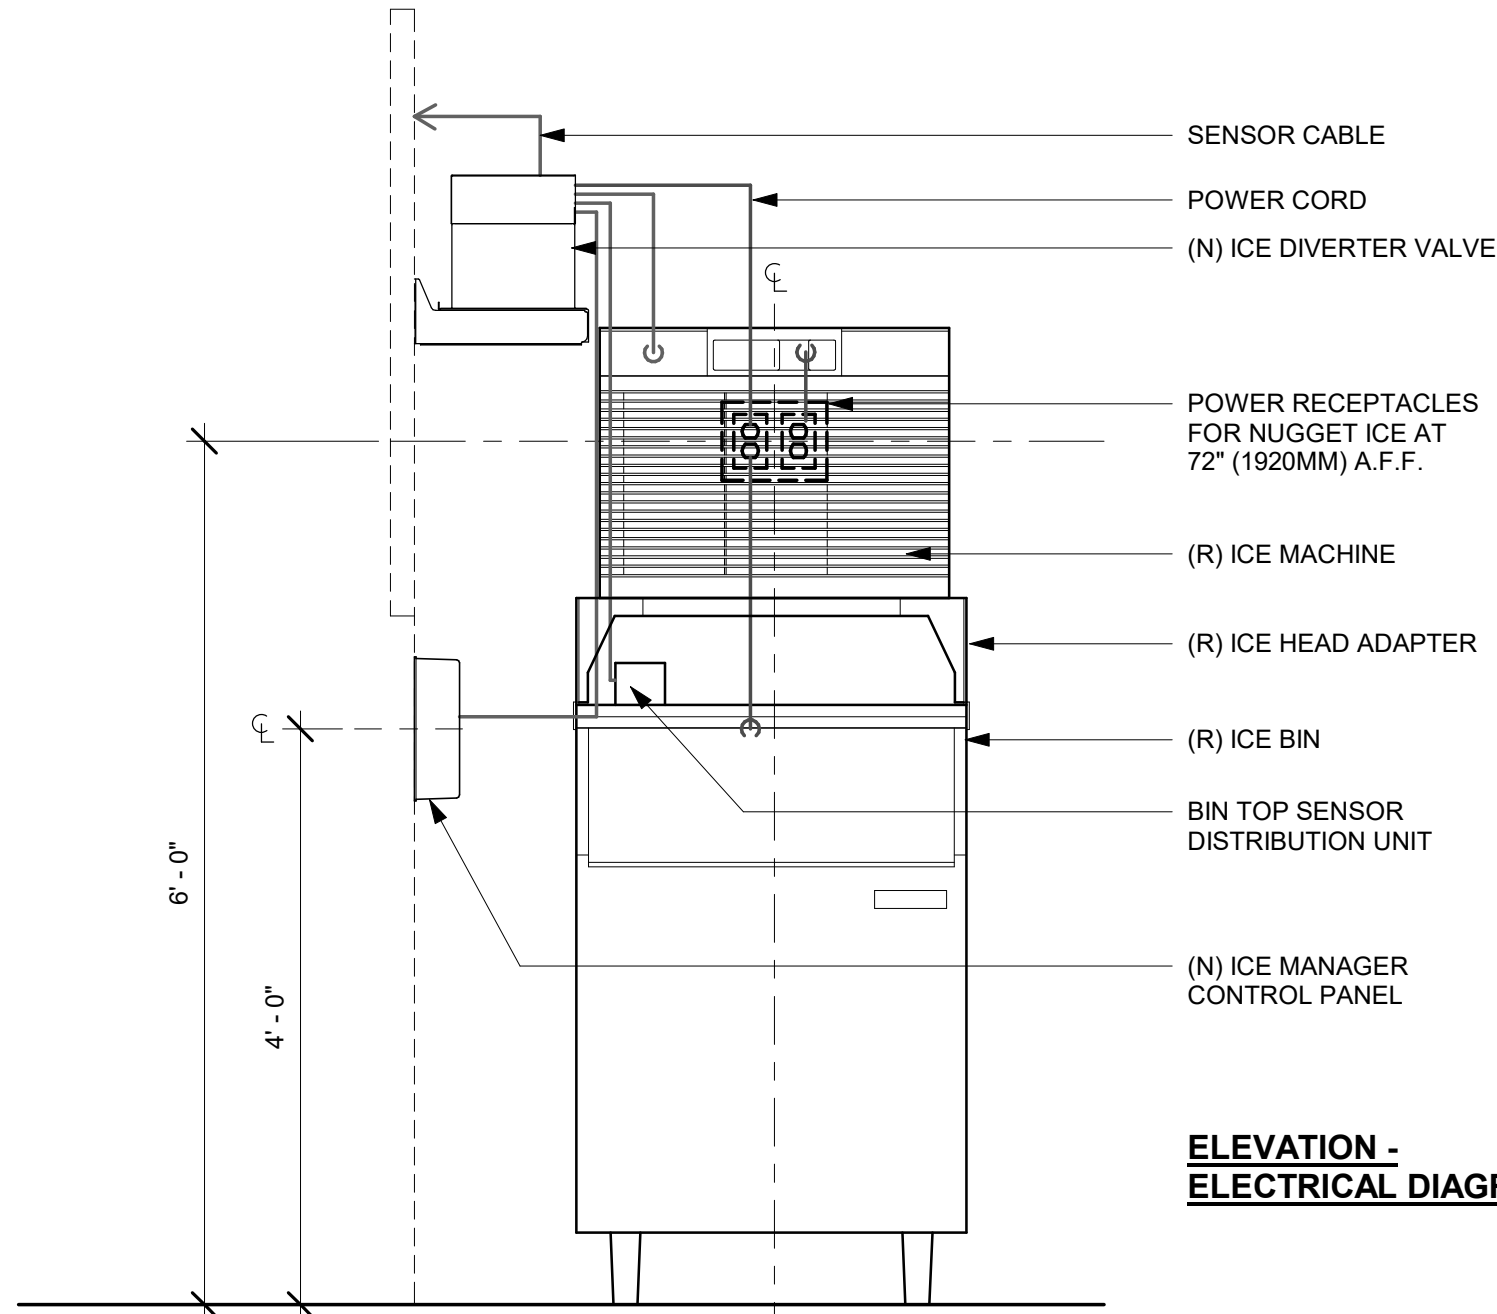

ELEVATION - ELECTRICAL DIAGRAM

2 NUGGET ICE - ELECTRICAL FOR REFERENCE ONLY

Scale: 3/4" = 1'-0"

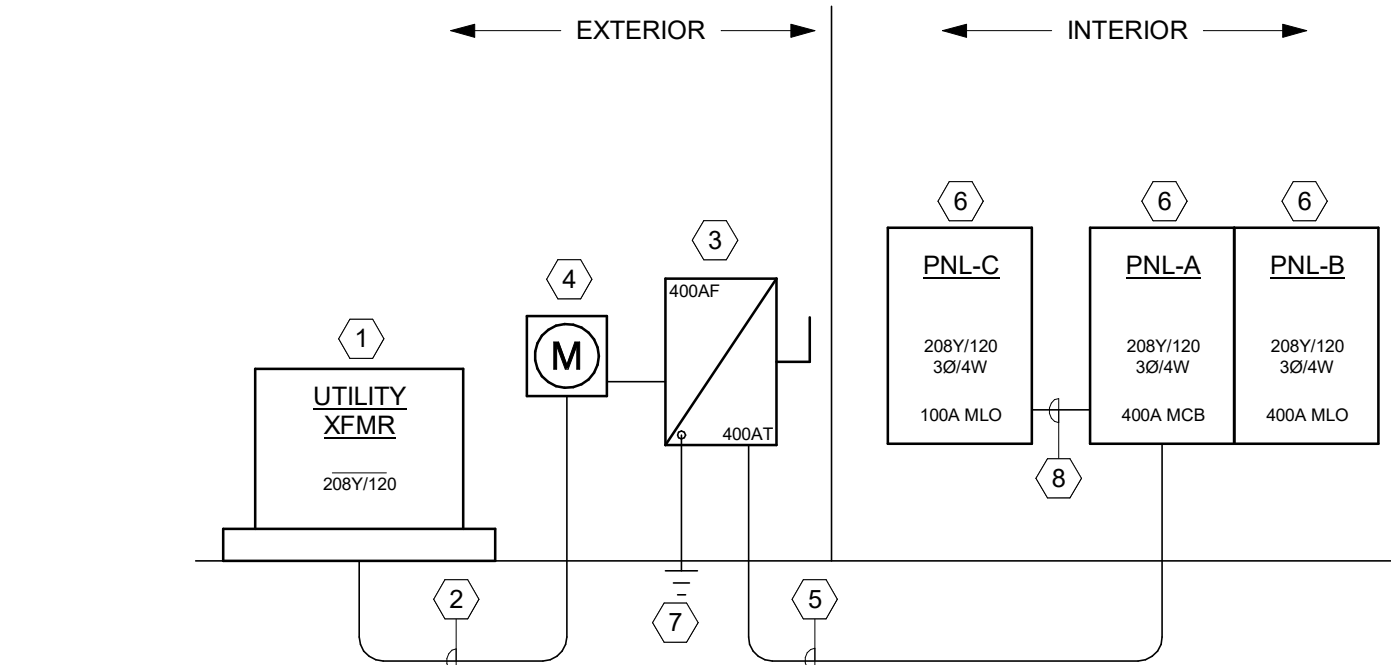

1 SINGLE LINE DIAGRAM

Scale: 1/4" = 1'-0"

AMPS	FEEDER SIZE	GROUND	CONDUIT
------	-------------	--------	---------


15	#12	#12	3/4"
20	#12	#12	3/4"
25	#10	#10	3/4"
30	#10	#10	3/4"
35	#8	#10	3/4"
40	#8	#10	3/4"
45	#8	#10	3/4"
50	#8	#10	3/4"
60	#6	#10	3/4"
70	#4	#8	1"
80	#4	#8	1"
90	#3	#8	1-1/4"
100	#3	#8	1-1/4"

PROVIDE THE FOLLOWING QUANTITIES:

1 POLE CIRCUIT - 1 HOT, 1 NEUTRAL, 1 GROUND	3 POLE CIRCUIT - 3 HOT, 1 GROUND
2 POLE CIRCUIT - 2 HOT, 1 GROUND	1 POLE IG CIRCUIT - 1 HOT, 1 NEUTRAL, 1 GROUND, 1 ISOLATED GROUND.

NOTES:

- ALL CONDUCTORS SHALL BE COPPER.
- ALL CONDUIT SHALL HAVE EQUIPMENT GROUNDING CONDUCTOR INSTALLED.
- CONDUIT BELOW GRADE OUTSIDE OF BUILDING SHALL BE 1" MINIMUM.
- SIZING OF CONDUCTORS SHALL BE ALTERED FOR DERATING PER N.E.C. OR VOLTAGE DROP CONSIDERATIONS.
- SEE RISER DIAGRAM FOR SIZING OF CIRCUITS GREATER THAN 100A.
- USE #10 AWG. COPPER CONDUCTORS FOR 20 AMPERE, 120 VOLT BRANCH CIRCUITS LONGER THAN 75 FEET. USE #10 AWG. COPPER CONDUCTORS FOR 20 AMPERE, 277 VOLT BRANCH CIRCUITS LONGER THAN 200 FEET. WHERE WIRE SIZE IS INCREASED IN SIZE FOR VOLTAGE DROP, EQUIPMENT GROUND SHALL BE INCREASED PROPORTIONATELY PER NEC 250.122 (B).
- WHERE MC CABLE IS ALLOWED BY AUTHORITY HAVING JURISDICTION THE CONDUCTORS FOR MC CABLE SHALL BE THHN. JACKET SHALL BE THE MANUFACTURER'S STANDARD SIZE FOR CONDUCTORS UTILIZED.

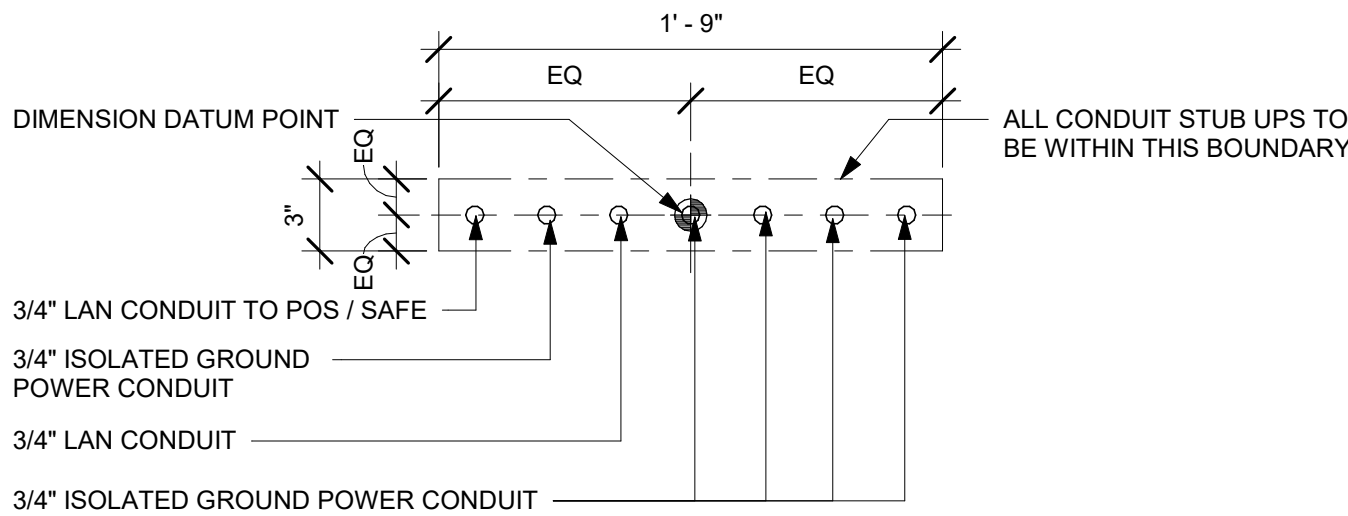

3 STUB UPS - FRONTBAR


Scale: 1 1/2" = 1'-0"

SINGLE LINE KEYED NOTES

- EXISTING UTILITY TRANSFORMER TO REMAIN.
- EXISTING (2) SETS OF (4)#3/0 CU AWG IN 3" CONDUIT EACH FROM UTILITY TRANSFORMER TO REMAIN.
- EXISTING 400AF/3P/400AT NEMA 3R DISCONNECT SWITCH TO REMAIN.
- EXISTING ELECTRIC METER, AND ELECTRIC METER SOCKET TO REMAIN.
- EXISTING (2) SETS OF (4)#3/0 CU AWG & (1)#3 CU AWG GND. IN 3" CONDUIT EACH TO REMAIN.
- EXISTING ELECTRIC PANELBOARD IN LOCATION SHOWN ON POWER PLAN TO REMAIN. REFER TO PANEL SCHEDULES ON SHEET E601.
- EXISTING #3 CU AWG SERVICE ENTRANCE GROUND AT DISCONNECT SWITCH TO REMAIN.
- EXISTING (4)#2 CU AWG & (1)#6 CU AWG GND. IN 1-1/4" CONDUIT TO REMAIN.


SINGLE LINE GENERAL NOTES

- PARALLEL FEEDER CONDUCTORS SHALL BE CUT TO EXACTLY THE SAME LENGTHS AND SHALL BE FROM THE SAME FACTORY RUN. ALL CONNECTIONS FOR SAME SHALL BE TORQUED TO IDENTICAL VALUES.
- EXTERIOR ELECTRICAL WORK SHALL NOT ONLY BE WEATHERPROOF AND WATER-TIGHT, BUT SHALL ALSO BE RUST-RESISTANT.
- CONDUCTORS BELOW GRADE OR SUBJECT TO MOISTURE SHALL BE "XHHW-2".
- EQUIPMENT GROUNDING CONDUCTORS SHALL BE PROVIDED IN STRICT COMPLIANCE WITH N.E.C., INCLUDING N.E.C. ARTICLE 250 AND TABLE 250.122. THESE CONDUCTORS MAY NOT BE INDICATED ON RISERS OR SINGLE-LINES, BUT SHALL BE PROVIDED UNDER BASE BID NEVERTHELESS.
- WORKING CLEARANCES SHALL BE PROVIDED FOR ALL ELECTRICAL EQUIPMENT (SWITCHBOARDS, PANELBOARDS, TRANSFORMERS, STARTERS, DISCONNECTS, ETC. AS APPLICABLE) IN STRICT COMPLIANCE WITH N.E.C. CHAPTER 1, PART 8, SECTION 110.26(a). LOCATIONS SHOWN ON FLOOR PLANS ARE SCHEMATIC AND DIAGRAMMATIC IN NATURE. THE ELECTRICAL CONTRACTOR SHALL BE RESPONSIBLE FOR ENSURING COMPLIANCE WITH THE ABOVE N.E.C. REFERENCE. THIS REQUIREMENT APPLIES TO EQUIPMENT ON FLOOR PLANS AS WELL AS TO EQUIPMENT SHOWN ON RISER.
- HOLD ALL NEW OVERHEAD ELECTRICAL WORK AS TIGHT AS POSSIBLE TO THE BOTTOM OF THE OVERHEAD STRUCTURE. LOCATE ANY RELATED PULLBOXES SO THAT THEY WILL BE FULLY ACCESSIBLE AFTER ALL CONSTRUCTION WORK IS COMPLETE. AS WITH ALL WORK, COORDINATE IN ADVANCE WITH ALL OTHER TRADES.
- ALL PANELS HAVE NEMA 1 ENCLOSURES UNLESS NOTED OTHERWISE.
- BALANCE ALL PANEL LOADS SO PHASES ARE WITHIN 10% OF EACH OTHERS.
- PROVIDE HACR CIRCUIT BREAKER FOR ALL MOTOR LOADS.

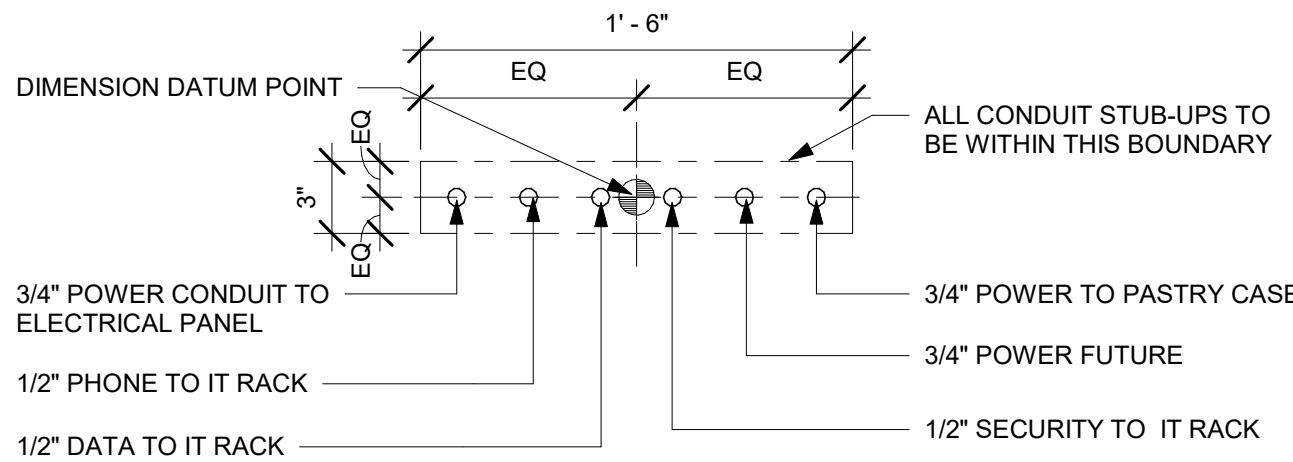

4 STUB UPS - SINGLE POS/ SAFE

Scale: 1 1/2" = 1'-0"

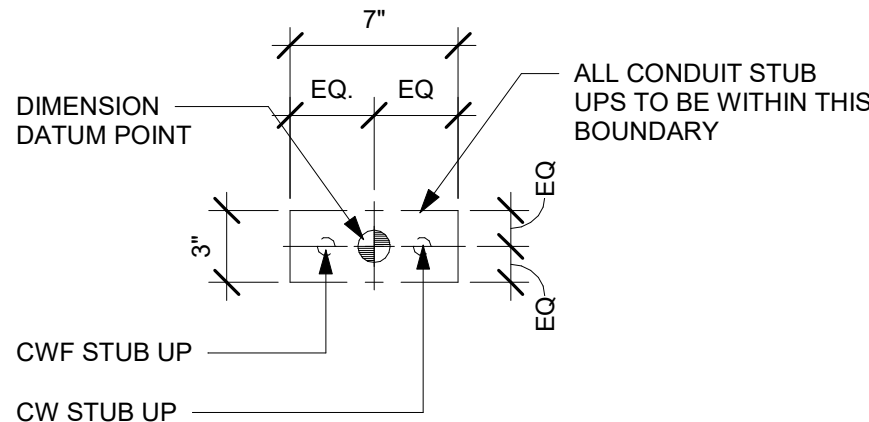

5 STUB UPS - ESPRESSO

Scale: 1 1/2" = 1'-0"

FOR CONSTRUCTION



© 2019 STARBUCKS COFFEE COMPANY

STARBUCKS®
2401 UTAH AVENUE SOUTH
SEATTLE, WASHINGTON 98134
(206) 318-1575


THESE DRAWINGS AND THE PROJECT MANUAL ARE CONFIDENTIAL AND SHALL REMAIN THE SOLE PROPERTY OF STARBUCKS CORPORATION, WHICH IS THE OWNER OF THE COPYRIGHT IN THIS WORK. THEY SHALL NOT BE REPRODUCED (IN WHOLE OR IN PART), SHARED WITH THIRD PARTIES OR USED IN ANY MANNER ON OTHER PROJECTS OR EXTENSIONS TO THIS PROJECT WITHOUT THE PRIOR WRITTEN CONSENT OF STARBUCKS CORPORATION. THESE DRAWINGS AND SPECIFICATIONS ARE INTENDED TO EXPRESS DESIGN INTENT FOR A PROTOTYPICAL STARBUCKS STORE (WHICH IS SUBJECT TO CHANGE AT ANYTIME) AND DO NOT REFLECT ACTUAL SITE CONDITIONS. NEITHER PARTY SHALL HAVE ANY OBLIGATION NOR LIABILITY TO THE OTHER (EXCEPT STATED ABOVE) UNTIL A WRITTEN AGREEMENT IS FULLY EXECUTED BY BOTH PARTIES.

STARBUCKS TEMPLATE VERSION: i2023-05-01

Design Forum Architects Inc.

2056 Byers Rd
Miamisburg, OH 45342
Tel: (844) 804-7700

Donald J. Bethman
Architect in Charge

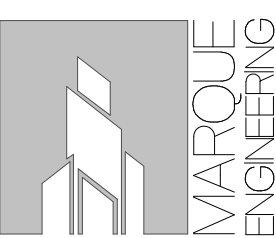

4850 SMITH RD., STE. 101
CINCINNATI, OH 45212
513.901.0040
WWW.MARQUEENG.COM

PROJECT NAME:
S SEMORAN BLVD & LEE VISTA BLVD

PROJECT ADDRESS:
**6605 S SEMORAN BLVD,
ORLANDO, FL 32822**

STORE #: 9875
PROJECT #: 25630-101
ISSUE DATE: 03/04/2024
DESIGN MANAGER: MARTIN PEREZ
PRODUCTION DESIGNER: ANDY MCLLOUD
CHECKED BY: EVAN DUFFY

Revision Schedule

Rev	Date	By	Description

SHEET TITLE:

ELECTRICAL DETAILS

SCALE: As indicated

SHEET NUMBER:

E503

PANEL SCHEDULE LEGEND

- (EX) = EXISTING CIRCUIT /BREAKER TO REMAIN.
(IG) = ISOLATED GROUND CIRCUIT.
(L) = PROVIDE LOCK-ON DEVICE
(T) = TIME CLOCK CONTROLLED CIRCUIT.
* = PROVIDE GROUND-FAULT CIRCUIT INTERRUPTER (GFCI) CIRCUIT BREAKER.

PANEL SCHEDULE
GENERAL NOTES

1. PROVIDE HACR RATED BREAKERS FOR ALL MOTOR LOADS.
2. PROVIDE LOCKING TYPE BREAKER (LOCK-ON) FOR ALL LIFE SAFETY AND NIGHT LIGHTING BRANCH CIRCUITS, EVEN IF NOT SPECIFICALLY CALLED OUT CASE-BY-CASE. UNLESS INDICATED OTHERWISE ON PLANS OR SCHEDULES, PROVIDE NEW BRANCH OVERCURRENT PROTECTIVE DEVICE (OPD) BREAKER OR FUSED SWITCH, WITH FUSE, AS APPLICABLE) IN CASES WHERE NEW CIRCUITS OR FEEDERS ARE SHOWN CONNECTED TO EXISTING POWER DISTRIBUTION EQUIPMENT. PROVIDE OPD MANUFACTURED BY THE SAME MANUFACTURER AS THE EXISTING EQUIPMENT IN WHICH IT WILL BE INSTALLED. PROVIDE A.I.C. RATINGS THAT MEET OR EXCEED THE RATINGS OF THE EXISTING EQUIPMENT AND OPD's.

BRANCH PANEL: A


LOCATION: WORKROOM 21 SUPPLY FROM: 400A DISCONNECT SWITCH MOUNTING: Recessed ENCLOSURE: Type 1				VOLTS: 120/208 Wye PHASES: 3 WIRES: 4				A.I.C. RATING EXISTING MAINS TYPE: MCB MAINS RATING: 400 A MCB RATING: 400 A PANEL TYPE: SQUARE D NQOD					
CKT	CIRCUIT DESCRIPTION	TRIP	POLES	A		B		C		POLES	TRIP	CIRCUIT DESCRIPTION	CKT
1				2833 VA	480 VA					1	15 A	(RELO) (*) UC FRIDGE	2
3	(*) COMBI OVEN	30 A	3			2833 VA	1800 VA			1	20 A	(RELO) (*) BLENDER	4
5								2833 VA	180 VA	1	20 A	(*) MILK DISPENSER	6
7	(*) COFFEE BREWER	50 A	2	4160 VA	480 VA					1	15 A	(*) UC FRIDGE	8
9						4160 VA	480 VA			1	15 A	(RELO) (*) UC FRIDGE	10
11	(*) INSTA HOT	20 A	1					1500 VA	480 VA	1	15 A	(RELO) (*) UC FRIDGE	12
13	(RELO) (*) BLENDER	20 A	1	1800 VA	1080 VA					1	20 A	(*) MENU BOARDS	14
15	(*) INSTA HOT	20 A	1			1500 VA	2900 VA						16
17	(*) CUP LABELERS	20 A	1					720 VA	2900 VA	2	40 A	(RELO) (*) ESPRESSO MACHINE	18
19	(*) (RELO) GRINDER	20 A	1	1560 VA	4141 VA								20
21	(RELO) (*) OVEN	30 A	2			3000 VA	4428 VA			3	100 A	(EX) PANEL C	22
23								3000 VA	3864 VA				24
25	(*) ICE MACHINE	20 A	2	1550 VA	4500 VA								26
27						1550 VA	4500 VA			3	45 A	WATER HEATER	28
29								3172 VA	4500 VA				30
31	(RELO) (*) DISHWASHER	50 A	2	3172 VA	180 VA					1	20 A	(*) ICE DIVERTER	32
33	(EX) BATHROOM GFCI	20 A	1			360 VA	480 VA			1	15 A	(RELO) (*) UC FRIDGE	34
35	(*) UC FRIDGE	20 A	1					480 VA	480 VA	1	15 A	(RELO) (*) UC FRIDGE	36
37	BANQUET RECEP	20 A	1	1440 VA	720 VA					1	20 A	STOREFRONT RECEP	38
39						2900 VA	371 VA						40
41	(RELO) (*) ESPRESSO MACHINE	20 A	2					2900 VA	371 VA	2	20 A	(*) PASTRY CASE	42
Total Load:				46520 VA		50559 VA		46526 VA					
Total Amps:				388 A		421 A		388 A					
LOAD CLASSIFICATION		CONNECTED LOAD		DEMAND FACTOR		ESTIMATED DEMAND		PANEL TOTALS					
HEATING AND COOLING (NEC 440.41 & 424.3)		27454 VA		100.00%		27454 VA							
KITCHEN EQUIPMENT (NEC 220.56)		76717 VA		65.00%		49866 VA		TOTAL CONN. LOAD 143605 VA					
LIGHTING (NEC 220.42)		11610 VA		125.00%		14513 VA		NONCOINCIDENT LOAD 0 VA					
NONCONTINUOUS/OUTLET DEVICES (NEC 210.21 & ...		2928 VA		100.00%		2928 VA		TOTAL CALC. DEMAND 123051 VA					
RECEPTACLE (NEC 220.44)		10440 VA		97.89%		10220 VA		TOTAL CONN. LOAD 399 A					
CONTINUOUS (NEC 210.19)		14456 VA		125.00%		18070 VA							
								TOTAL CALC. DEMAND 342 A					

BRANCH PANEL: B

LOCATION: WORKROOM 21 SUPPLY FROM: A (FEEDTHRU LUGS) MOUNTING: Surface ENCLOSURE: Type 1					VOLTS: 120/208 Wye PHASES: 3 WIRES: 4					A.I.C. RATING EXISTING MAINS TYPE: MLO MAINS RATING: 400 A				
PANEL TYPE: SQUARE D NQOD														
CKT	CIRCUIT DESCRIPTION	TRIP	POLES	A		B		C		POLES	TRIP	CIRCUIT DESCRIPTION		CKT
1	(*) UC FRIDGE	15 A	1	480 VA	4576 VA					3	60 A	(EX) RTU-1	2	
3	(*) WARMING WALL	50 A	2			3000 VA	4576 VA						4	
5								3000 VA	4576 VA				6	
7	(EX) SIGNAGE	20 A	1	1200 VA	4576 VA					3	60 A	(EX) RTU-2	8	
9	(EX) SIGNAGE	20 A	1			1200 VA	4576 VA						10	
11	(EX) DT MENUBOARD	20 A	1					240 VA	4576 VA				12	
13	(*) NITRO FRIDGE	20 A	1	300 VA	1200 VA					1	20 A	(EX) MONUMENT SIGN	14	
15	(*) NITRO GEN	20 A	1			336 VA	1200 VA			1	20 A	(EX) SIGNAGE	16	
17	(*) (RELO) FRIDGE	15 A	1					300 VA	635 VA	1	20 A	(EX) BUILDING LIGHTING	18	
19	DT RECEPTACLE	20 A	1	360 VA	360 VA					1	20 A	WATER FILTER	20	
21	(EX) DT SIGNAGE	20 A	1			306 VA	180 VA			1	20 A	POS RECEPTACLE	22	
23	(*) (RELO) FRIDGE	15 A	1					300 VA	180 VA	1	20 A	POS RECEPTACLE	24	
25	(EX)(T) WORKROOM LIGHTING	20 A	1	193 VA	360 VA					1	20 A	POS RECEPTACLE	26	
27	(*) (RELO) FREEZER	15 A	1			864 VA	696 VA			1	20 A	EF-1	28	
29	DT RECEPTACLE	20 A	1					360 VA	3000 VA	2	30 A	(RELO) (*) WARMING OVEN	30	
31	DT RECEPTACLE	20 A	1	360 VA	3000 VA								32	
33	DT RECEPTACLE	20 A	1			360 VA	624 VA						34	
35	(EX) RESTROOM LIGHTING	20 A	1					120 VA	360 VA	1	20 A	(EX) EXTERIOR LIGHTING	36	
37	(EX) SIGNAGE	20 A	1	1200 VA	260 VA					1	20 A	(EX) AIR CURTAIN	38	
39	(EX) SIGNAGE	20 A	1			1200 VA	180 VA			1	20 A	DT RECEPTACLE	40	
41	(EX) SIGNAGE	20 A	1					1200 VA	300 VA	1	15 A	(*) (RELO) FRIDGE	42	
Total Load:				18424 VA		19297 VA		19146 VA						
Total Amps:				154 A		162 A		160 A						
LOAD CLASSIFICATION				CONNECTED LOAD		DEMAND FACTOR		ESTIMATED DEMAND		PANEL TOTALS				
HEATING AND COOLING (NEC 440.41 & 424.3)				27454 VA		100.00%		27454 VA						
KITCHEN EQUIPMENT (NEC 220.56)				14880 VA		65.00%		9672 VA		TOTAL CONN. LOAD 56868 VA				
LIGHTING (NEC 220.42)				10518 VA		125.00%		13147 VA		NONCOINCIDENT LOAD 0 VA				
RECEPTACLE (NEC 220.44)				3060 VA		100.00%		3060 VA		TOTAL CALC. DEMAND 54528 VA				
CONTINUOUS (NEC 210.19)				956 VA		125.00%		1195 VA		TOTAL CONN. LOAD 158 A				
										TOTAL CALC. DEMAND 151 A				

BRANCH PANEL: C

LOCATION: WORKROOM 21				VOLTS: 120/208 Wye				A.I.C. RATING EXISTING					
SUPPLY FROM: A				PHASES: 3				MAINS TYPE: MLO					
MOUNTING: Surface				WIRES: 4				MAINS RATING: 225 A					
ENCLOSURE: Type 1				PANEL TYPE: SQUARE D NQ									
CKT	CIRCUIT DESCRIPTION	TRIP	POLES	A		B		C		POLES	TRIP	CIRCUIT DESCRIPTION	CKT
1	(EX) HAND DRYER	20 A	1	1464 VA	200 VA					1	20 A	TIME CLOCK	2
3	(EX) HAND DRYER	20 A	1			1464 VA	300 VA			1	15 A	(*) (RELO) FRIDGE	4
5	MANAGER'S DESK RECEPTACLE	20 A	1					720 VA	180 VA	1	20 A	MANAGER'S DESK RECEPTACLE	6
7	(T) BEVERAGE PREP LIGHTING	20 A	1	258 VA	275 VA					1	20 A	(T) TAPE LIGHTING	8
9	MANAGER'S DESK RECEPTACLE	20 A	1			540 VA	360 VA			1	20 A	RTU SERVICE RECPETACLE	10
11	DT WINDOW CONTROL	20 A	1					180 VA	180 VA	1	20 A	(*) MILK DISPENSER	12
13	MANAGER'S DESK RECEPTACLE	20 A	1	180 VA	180 VA					1	20 A	(*) MILK DISPENSER	14
15	MANAGER'S DESK RECEPTACLE	20 A	1			180 VA	180 VA			1	20 A	(*) ORDER STATUS BOARD	16
17	RECIRCULATION PUMP	20 A	1					360 VA	864 VA	1	15 A	(*) (RELO) FREEZER	18
19	(*) HAND SINK RECEPTACLE	20 A	1	180 VA	360 VA					1	20 A	(T) DINING TRACK LIGHTING	20
21	(*) ICE CONTROL PANEL	20 A	1			180 VA	360 VA			1	20 A	MANAGER'S DESK RECEPTACLE	22
23	(*) PITCHER RINSER	15 A	1					1200 VA	180 VA	1	20 A	PANEL RECEPTACLE	24
25	(*) (RELO) FREEZER	15 A	1	864 VA	180 VA					1	20 A	EXTERIOR RECEPTACLE	26
27	(*) (RELO) FREEZER	15 A	1			864 VA	--			1	--	SPACE	28
29	SPACE	--	1					--	--	1	--	SPACE	30
31	SPACE	--	1	--	--					1	--	SPACE	32
33	SPACE	--	1			--	--			1	--	SPACE	34
35	SPACE	--	1					--	--	1	--	SPACE	36
37	SPACE	--	1	--	--					1	--	SPACE	38
39	SPACE	--	1			--	--			1	--	SPACE	40
41	SPACE	--	1					--	--	1	--	SPACE	42
Total Load:				4141 VA		4428 VA		3864 VA					
Total Amps:				35 A		37 A		32 A					
LOAD CLASSIFICATION				CONNECTED LOAD	DEMAND FACTOR	ESTIMATED DEMAND		PANEL TOTALS					
KITCHEN EQUIPMENT (NEC 220.56)				4632 VA	65.00%	3011 VA		TOTAL CONN. LOAD 12433 VA					
LIGHTING (NEC 220.42)				1093 VA	125.00%	1366 VA		NONCOINCIDENT LOAD 0 VA					
NONCONTINUOUS/OUTLET DEVICES (NEC 210.21 &...				2928 VA	100.00%	2928 VA		TOTAL CALC. DEMAND 11085 VA					
RECEPTACLE (NEC 220.44)				3780 VA	100.00%	3780 VA		TOTAL CONN. LOAD 35 A					
								TOTAL CALC. DEMAND 31 A					

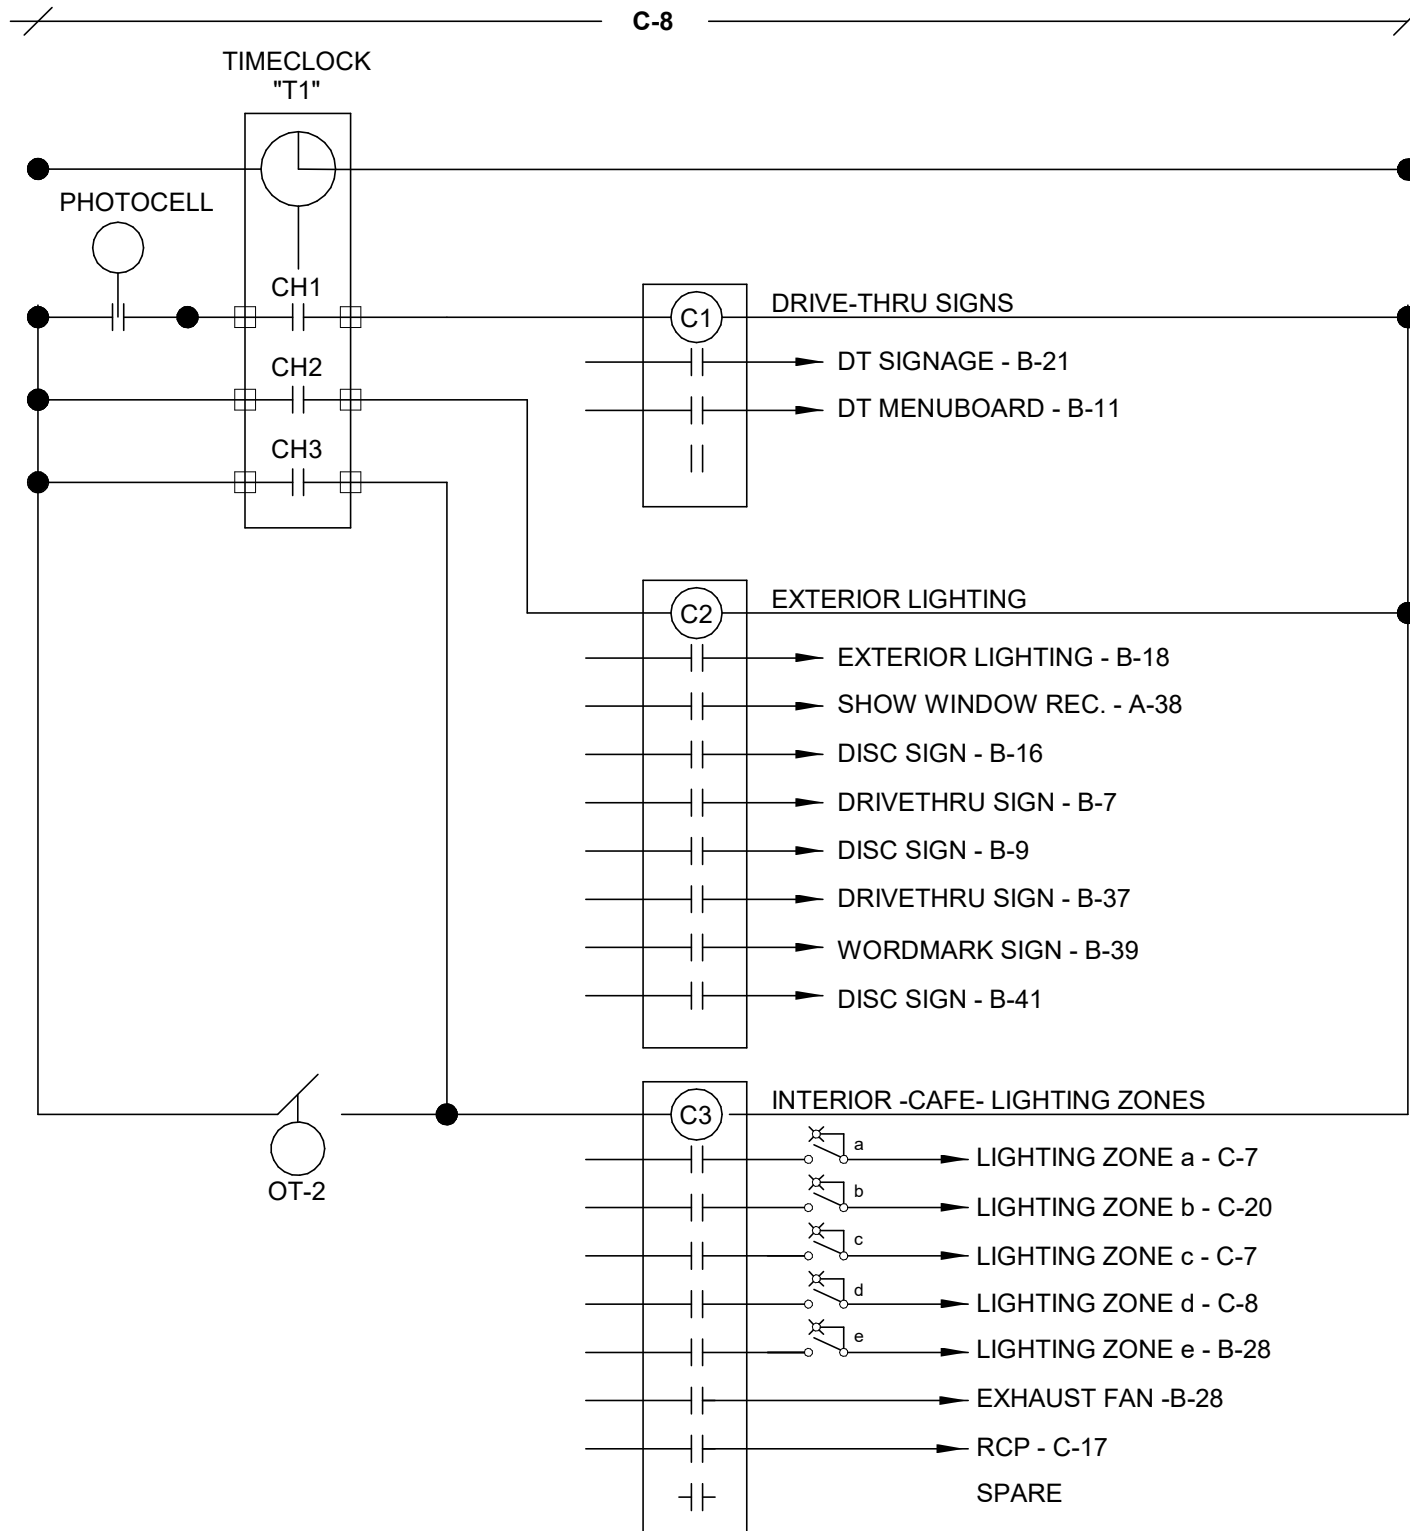

CONTROL NOTES:
ON AT STORE OPEN, OFF AT DAWN.
ON AT DUSK, OFF AT STORE CLOSE.

CONTROL NOTES:
ON 1 HOUR BEFORE STORE OPEN.
OFF 1 HOUR AFTER STORE CLOSE.

- LIGHTING CONTROL NOTES:
- EXISTING TIME SWITCH "T1" - TORK MODEL 7300.
 - EXISTING LIGHTING CONTACTORS "C1" AND "C2".
 - FURNISH AND INSTALL NEW PHOTOCELL(S) (INTERMATIC EK4736S OR EQUAL) FOR CONTROL OF EXTERIOR LIGHTS AND BUILDING MOUNTED SIGNAGE.
 - COORDINATE TIME SWITCH SETTINGS AND OPERATION WITH STORE MANAGER PRIOR TO CLOSEOUT.
 - FOR PHOTOCELL CONTROLLED CONTACTORS FUNCTION SHALL BE PHOTOCELL ON TIMED OFF.
 - OT-2 HOUR TIMED OVERRIDE SWITCH FOR SALES FLOOR. TORK MODEL A502HW.
 - DIGITAL ORDER SCREEN IS **NEVER** CONTROLLED THRU THIS TIME SWITCH.

1 LIGHTING CONTROL DIAGRAM
Scale: 1/4" = 1'-0"

FOR CONSTRUCTION



STARBUCKS®
2401 UTAH AVENUE SOUTH
SEATTLE, WASHINGTON 98134
(206) 318-1575


THESE DRAWINGS AND THE PROJECT MANUAL ARE CONFIDENTIAL AND SHALL REMAIN THE SOLE PROPERTY OF STARBUCKS CORPORATION, WHICH IS THE OWNER OF THE COPYRIGHT IN THIS WORK. THEY SHALL NOT BE REPRODUCED IN WHOLE OR IN PART, SHARED WITH THIRD PARTIES OR USED IN ANY MANNER ON OTHER PROJECTS OR EXTENSIONS TO THIS PROJECT WITHOUT THE PRIOR WRITTEN CONSENT OF STARBUCKS CORPORATION. THESE DRAWINGS AND SPECIFICATIONS ARE INTENDED TO EXPRESS DESIGN INTENT FOR A PROTOTYPICAL STARBUCKS STORE (WHICH IS SUBJECT TO CHANGE AT ANYTIME) AND DO NOT REFLECT ACTUAL SITE CONDITIONS. NEITHER PARTY SHALL HAVE ANY OBLIGATION NOR LIABILITY TO THE OTHER (EXCEPT STATED ABOVE) UNTIL A WRITTEN AGREEMENT IS FULLY EXECUTED BY BOTH PARTIES.

STARBUCKS TEMPLATE VERSION: i2023-05-01

Design Forum Architects Inc.

2956 Byers Rd
Miamisburg, OH 45342
Tel: (844) 804-7700

Donald J. Rethman
Architect in Charge

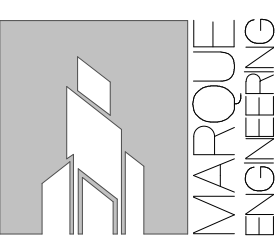

4850 SMITH RD., STE. 101
CINCINNATI, OH 45212
513.901.0040
WWW.MARQUEENG.COM

PROJECT NAME:
S SEMORAN BLVD & LEE VISTA BLVD

PROJECT ADDRESS:
**6605 S SEMORAN BLVD,
ORLANDO, FL 32822**

Area Type 2020 Edition	Area Type 2023 Edition	2023 Allowed Watts / ft2	Area	2023 Allowed Wattage	Allowance Per C405.3.2.2.1	Allowance Area Square Feet	Allowance Wattage	2023 Total Allowed Watts	Proposed Wattage
Dining Area - Cafeteria/Fast Food	Dining Area - Cafeteria/Fast Food	0.40	465	186.00	N/A		0		374
Corridor/Transition <8ft wide	Corridor - Otherwise	0.41	36	14.76	N/A		0		9
Food Preparation	Food Preparation	1.09	837	912.33	N/A		0		683
Restroom	Restrooms - Otherwise	0.63	105	66.15	N/A		0		110
Totals				1179			0	1179	1176



COMcheck Software Version COMcheckWeb
Interior Lighting Compliance Certificate

Project Information

Energy Code: 2020 Florida - 7th Edition
Project Title: 12671 - Starbucks - S. Semoran Blvd and Lee Vista Blvd - Orlando, FL
Project Type: Alteration

Construction Site: Owner/Agent: Designer/Contractor:

Allowed Interior Lighting Power

A Area Category	B Floor Area (ft2)	C Allowed Watts / ft2	D Allowed Watts
1-Beverage Prep (Common Space Types:Food Preparation)	481	1.06	510
2-Bedroom Vestibule (Common Space Types:Corridor/Transition <8 ft wide)	36	0.66	24
3-Cafe/Seating (Common Space Types:Dining Area - Cafeteria/Fast Food)	465	0.63	293
4-Work Room (Common Space Types:Food Preparation)	356	1.06	377
5-Restrooms (Common Space Types:Restrooms)	105	0.85	89
Total Allowed Watts = 1293			

Proposed Interior Lighting Power

A Fixture ID : Description / Lamp / Wattage Per Lamp / Ballast	B Lamps/ Fixture	C # of Fixture Watt.	D Fixture (C X D)	E
Beverage Prep (Common Space Types: Food Preparation, 481 sq.ft.)				
LED: 21774: RECESSED CAN: Other:	1	19	9	171
LED: 22215 & 22217: STRIP: Other:	1	1	275	275
LED: 47002: PENDANT - MATTEO ASTRO: Other:	1	1	25	25
LED: 23055: TROFFER: Other:	1	1	29	29
Restroom Vestibule (Common Space Types: Corridor/Transition <8 ft wide, 36 sq.ft.)				
LED: 21774: RECESSED CAN: Other:	1	1	9	9
Cafe/Seating (Common Space Types: Dining Area - Cafeteria/Fast Food, 465 sq.ft.)				
Track Lighting: 21779: 3A CURRENT LIMITER: Wattage based on current limiting device capacity	0	0	360	360
LED: 20719: SCONCE - JUPITER THIN: Other:	1	2	7	14
Work Room (Common Space Types: Food Preparation, 356 sq.ft.)				
LED: 23055: TROFFER: Other:	1	6	29	174
LED: 20778: SCONCE - RAW CRISP: Other:	1	1	9	9
Restrooms (Common Space Types: Restrooms, 105 sq.ft.)				
LED: 20748: SCONCE - KUZZO PLUTO TRIPLE: Other:	1	2	17	34
LED: 12561: RECESSED CAN: Other:	1	4	19	76
Total Proposed Watts = 1176				

Project Title: 12671 - Starbucks - S. Semoran Blvd and Lee Vista Blvd - Orlando, FL
Data filename: Report date: 02/13/24
Page 1 of 6

Interior Lighting PASSES

Interior Lighting Compliance Statement

Compliance Statement: The proposed interior lighting alteration project represented in this document is consistent with the building plans, specifications, and other calculations submitted with this permit application. The proposed interior lighting systems have been designed to meet the 2020 Florida - 7th Edition requirements in COMcheck Version COMcheckWeb and to comply with any applicable mandatory requirements listed in the Inspection Checklist.

Evan Duffy, PE

Name - Title Signature Date 03/04/2024

Project Title: 12671 - Starbucks - S. Semoran Blvd and Lee Vista Blvd - Orlando, FL
Data filename: Report date: 02/13/24
Page 2 of 6



COMcheck Software Version COMcheckWeb
Inspection Checklist

Energy Code: 2020 Florida - 7th Edition

Requirements: 100.0% were addressed directly in the COMcheck software

Text in the 'Comments/Assumptions' column is provided by the user in the COMcheck Requirements screen. For each requirement, the user certifies that a code requirement will be met and how that is documented, or that an exception is being claimed. Where compliance is itemized in a separate table, a reference to that table is provided.

Section # & Req. ID	Plan Review	Complies?	Comments/Assumptions
C103.2 (PR4)1	Plans, specifications, and/or calculations provide all information with which compliance can be determined for the interior lighting and electrical systems and equipment and document where exceptions to the standard are claimed. Information provided should include interior lighting power calculations, wattage of bulbs and ballasts, transformers and control devices.	<input type="checkbox"/> Complies <input type="checkbox"/> Does Not <input type="checkbox"/> Not Observable <input type="checkbox"/> Not Applicable	Requirement will be met.

Additional Comments/Assumptions:

1 High Impact (Tier 1) 2 Medium Impact (Tier 2) 3 Low Impact (Tier 3)
Project Title: 12671 - Starbucks - S. Semoran Blvd and Lee Vista Blvd - Orlando, FL
Data filename: Report date: 02/13/24
Page 3 of 6

Section # & Req. ID	Rough-In Electrical Inspection	Complies?	Comments/Assumptions
C405.2.2 (EL22)1	Spaces required to have light-reduction controls have a manual control that allows the occupant to reduce the connected lighting load in a reasonably uniform illumination pattern >= 50 percent.	<input type="checkbox"/> Complies <input type="checkbox"/> Does Not <input type="checkbox"/> Not Observable <input type="checkbox"/> Not Applicable	Requirement will be met.
C405.2.1 (EL18)1	Occupancy sensors installed in classrooms/lecture/training rooms, conference/meeting/multipurpose rooms, copy/print rooms, lounges/breakrooms, enclosed offices, open plan office areas, restrooms, storage rooms, locker rooms, warehouse storage areas, and other spaces <= 300 sq ft that are enclosed by floor-to-ceiling height partitions. Reference section language C405.2.1.2 for control function in warehouses and section C405.2.1.3 for open plan office spaces.	<input type="checkbox"/> Complies <input type="checkbox"/> Does Not <input type="checkbox"/> Not Observable <input type="checkbox"/> Not Applicable	Requirement will be met.
C405.2.1 (EL19)1	Occupancy sensors control function in 2) warehouses: In warehouses, the lighting in aislesways and open areas is controlled with occupant sensors that automatically reduce lighting power by 50% or more when the areas are unoccupied. The occupant sensors control lighting in each aisleway independently and do not control lighting beyond the aisleway being controlled by the sensor.	<input type="checkbox"/> Complies <input type="checkbox"/> Does Not <input type="checkbox"/> Not Observable <input type="checkbox"/> Not Applicable	Exception: Requirement does not apply.
C405.2.1 (EL20)3	Occupant sensor control function in open plan office areas: Occupant sensor controls in open office spaces >= 300 sq ft. have controls 1) configured so that general lighting can be controlled separately in control zones with floor areas <= 600 sq ft. within the space, 2) automatically turn off general lighting in all control zones within 20 minutes after all occupants have left the space, 3) are configured so that general lighting power in each control zone is reduced by >= 80% of the full zone general lighting power within 20 minutes of all occupants leaving that control zone, and 4) are configured such that any daylight responsive control will activate space general lighting or control zone general lighting only when occupancy for the same area is detected.	<input type="checkbox"/> Complies <input type="checkbox"/> Does Not <input type="checkbox"/> Not Observable <input type="checkbox"/> Not Applicable	Exception: Requirement does not apply.
C405.2.2 (EL21)1	Each area not served by occupancy sensors (per C405.2.1) have time-switch controls and functions detailed in sections C405.2.2.1 and C405.2.2.2.	<input type="checkbox"/> Complies <input type="checkbox"/> Does Not <input type="checkbox"/> Not Observable <input type="checkbox"/> Not Applicable	Requirement will be met.

Project Title: 12671 - Starbucks - S. Semoran Blvd and Lee Vista Blvd - Orlando, FL
Data filename: Report date: 02/13/24
Page 4 of 6

Section # & Req. ID	Rough-In Electrical Inspection	Complies?	Comments/Assumptions
C405.2.3 (EL23)1	Daylight zones provided with individual controls that control the lights independent of general area lighting. See code section C405.2.3 Daylight-responsive controls for applicable spaces, C405.2.3.1 Daylight responsive control function and section C405.2.3.2 Sidelit zone.	<input type="checkbox"/> Complies <input type="checkbox"/> Does Not <input type="checkbox"/> Not Observable <input type="checkbox"/> Not Applicable	Exception: Sidelit zones on first floor in Group A-2 and M occupancies.
C405.2.4 (EL24)1	Separate lighting control devices for specific uses installed per approved lighting plans. 1) Display and accent lighting, lighting in display cases, supplemental task lighting and lighting equipment for sale shall have occupancy sensor control. 2) Sleeping units shall have auto off controls.	<input type="checkbox"/> Complies <input type="checkbox"/> Does Not <input type="checkbox"/> Not Observable <input type="checkbox"/> Not Applicable	Requirement will be met.
C405.6 (EL26)1	Low-voltage dry-type distribution electric transformers meet the minimum efficiency requirements of Table C405.6.	<input type="checkbox"/> Complies <input type="checkbox"/> Does Not <input type="checkbox"/> Not Observable <input type="checkbox"/> Not Applicable	Requirement will be met.
C405.7 (EL27)1	Electric motors meet the minimum efficiency requirements of Tables C405.7(1) through C405.7(4). Efficiency verified through certification under an approved certification program or the equipment efficiency ratings shall be provided by motor manufacturer (where certification programs do not exist).	<input type="checkbox"/> Complies <input type="checkbox"/> Does Not <input type="checkbox"/> Not Observable <input type="checkbox"/> Not Applicable	Requirement will be met.
C405.8.2 (EL28)1	Escalators and moving walks comply with ASME A17.1/CSA B44 and have automatic controls configured to reduce speed to the minimum permitted speed in accordance with ASME A17.1/CSA B44 or applicable local code when not conveying passengers.	<input type="checkbox"/> Complies <input type="checkbox"/> Does Not <input type="checkbox"/> Not Observable <input type="checkbox"/> Not Applicable	Exception: Requirement does not apply.
C405.5.3 (EL29)1	Total voltage drop across the combination of feeders and branch circuits <= 5%.	<input type="checkbox"/> Complies <input type="checkbox"/> Does Not <input type="checkbox"/> Not Observable <input type="checkbox"/> Not Applicable	Requirement will be met.

Additional Comments/Assumptions:

Project Title: 12671 - Starbucks - S. Semoran Blvd and Lee Vista Blvd - Orlando, FL
Data filename: Report date: 02/13/24
Page 5 of 6

Section # & Req. ID	Final Inspection	Complies?	Comments/Assumptions
C408.2.5 (F117)1	Furnished O&M instructions for systems and equipment to the building owner or designated representative.	<input type="checkbox"/> Complies <input type="checkbox"/> Does Not <input type="checkbox"/> Not Observable <input type="checkbox"/> Not Applicable	Requirement will be met.
C405.3.2 (F118)1	Interior installed lamp and fixture lighting power is consistent with what is shown on the approved lighting plans, demonstrating proposed watts are less than or equal to allowed watts.	<input type="checkbox"/> Complies <input type="checkbox"/> Does Not <input type="checkbox"/> Not Observable <input type="checkbox"/> Not Applicable	See the Interior Lighting fixture schedule for values.
C408.1.1 (F115)1	Building operations and maintenance documents will be provided to the owner. Documents will cover manufacturers' information, specifications, recommendations, programming procedures and means of illustrating to owner how building, equipment and systems are intended to be installed, maintained, and operated. Regular maintenance actions shall be clearly stated on accessible label.	<input type="checkbox"/> Complies <input type="checkbox"/> Does Not <input type="checkbox"/> Not Observable <input type="checkbox"/> Not Applicable	Requirement will be met.
C408.3 (F133)1	Lighting systems have been tested to ensure proper calibration, adjustment, programming, and operation.	<input type="checkbox"/> Complies <input type="checkbox"/> Does Not <input type="checkbox"/> Not Observable <input type="checkbox"/> Not Applicable	Requirement will be met.

Additional Comments/Assumptions:

Project Title: 12671 - Starbucks - S. Semoran Blvd and Lee Vista Blvd - Orlando, FL
Data filename: Report date: 02/13/24
Page 6 of 6



© 2019 STARBUCKS COFFEE COMPANY

STARBUCKS®
2401 UTAH AVENUE SOUTH
SEATTLE, WASHINGTON 98134
(206) 318-1575


THESE DRAWINGS AND THE PROJECT MANUAL ARE CONFIDENTIAL AND SHALL REMAIN THE SOLE PROPERTY OF STARBUCKS CORPORATION, WHICH IS THE OWNER OF THE COPYRIGHT IN THIS WORK. THEY SHALL NOT BE REPRODUCED IN WHOLE OR IN PART, SHARED WITH THIRD PARTIES OR USED IN ANY MANNER ON OTHER PROJECTS OR EXTENSIONS TO THIS PROJECT WITHOUT THE PRIOR WRITTEN CONSENT OF STARBUCKS CORPORATION. THESE DRAWINGS AND SPECIFICATIONS ARE INTENDED TO EXPRESS DESIGN INTENT FOR A PROTOTYPICAL STARBUCKS STORE (WHICH IS SUBJECT TO CHANGE AT ANYTIME) AND DO NOT REFLECT ACTUAL SITE CONDITIONS. NEITHER PARTY SHALL HAVE ANY OBLIGATION NOR LIABILITY TO THE OTHER (EXCEPT STATED ABOVE) UNTIL A WRITTEN AGREEMENT IS FULLY EXECUTED BY BOTH PARTIES.

STARBUCKS TEMPLATE VERSION: i2023-05-01

Design Forum
Architects Inc.

2056 Byers Rd
Miamisburg, OH 45342
Tel: (844) 804-7700

Donald J. Bethman
Architect in Charge

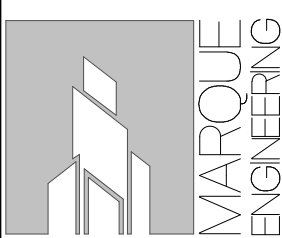

4850 SMITH RD., STE. 101
CINCINNATI, OH 45212
513.901.0040
WWW.MARQUEENG.COM

FOR CONSTRUCTION

PROJECT NAME:
S SEMORAN BLVD &
LEE VISTA BLVD

PROJECT ADDRESS:
6605 S SEMORAN BLVD,
ORLANDO, FL 32822

STORE #: 9875
PROJECT #: 25630-101
ISSUE DATE: 03/04/2024
DESIGN MANAGER: MARTIN PEREZ
PRODUCTION DESIGNER: ANDY MCLOUD
CHECKED BY: EVAN DUFFY

Revision Schedule			
Rev	Date	By	Description

SHEET TITLE:
ENERGY CALCULATIONS

SCALE:

SHEET NUMBER:

EN001